									OBC N	IATRIX				
ITEM	DATA						CODE REFERENCE							
								D PART 3	D PART S					
1	PROJECT DESCRIPTION: PROJECT NAME: RAINY RIVER LI PROJECT NUMBER: 23-113				r Libr/	ARY R	ENOVA	TION			 □ NEW CONS □ ADDITION □ ALTERATIO □ CHANGE O □ OTHER 	N	1.1.2.2.	1.1.2.4.
2	MAJOR OCCUPANCY(S):				E	EXISTING: D - OFFICES PROPOSED: A - LIBRARY						3.1.2.1.	9.10.2.1.	
3	FLOOR AREA (m ²):			E	EXISTING: 91.98 m ² PROPOSED: 91.98 m ²						1.1.3.2.	1.3.3.3.		
4	TOTAL GR	OSS FLOOF	R AREA (m	²):	Т	TOTAL: 91.98 m ²							1.1.3.2.	1.3.3.3.
5	NUMBER C	F STOREY	S:		A	BOVE	GRADE: 1		B	ELOW GRADE: ()		3.2.1.1.	1.3.3.3.
6	NUMBER C	OF STREET	S/ FIRE AC	CESS:	1								3.2.2.10., 3.2.5.	9.10.20.
7	BUILDING	SIZE DETER	RMINATION	N:	3	.2.2.28.	group a,	DIVISIO	ON 2, 1 STOREY				3.2.2.20 3.2.2.83.	9.10.4.
8	OCCUPAN	T LOAD:			1) PERS	ONS		C] m ² / PERSON	⊠ DES	BIGN	3.1.17.	9.9.1.3.
9	MAXIMUM	TRAVEL DI	STANCE (n	n):	4	0m							3.4.2.1.A	9.9.8.2
10	PLUMBING FIXTURES REQ'D:					REQUIRED 1 REQUIR		1 UNIVER	SAL WASHROOI	M PROVIDED	3.7.4.2.(9)	3.7.4.3.(1) & 3.7.4.3.(13)	3.7.4., 9.31.4.	
11	REQUIRED	EXITS:			2								3.4.2.1.(2), 3.4.2.1.A	9.9.7.4
12			:			00mm							3.4.3., 3.4.3.2.(7)(g)	9.9.3.
13	SPRINKLER SYSTEM REQ'D:					□ YES IF YES: □ ENTIRE BUILDING ☑ NO □ BASEMENT ONLY □ IN LIEU OF ROOF RATING					3.2.2.20 3.2.2.83. 3.2.1.5. 3.2.2.17. 3.2.2.18.	9.10.8.		
14	STANDPIPE REQ'D: VES NO						3.2.9.	N/A						
15	FIRE ALAR	FIRE ALARM REQ'D:					3.2.4.1.(2)(f)	9.10.18.						
16	WATER SERVICE/ ADEQUATE WATER: X YES NO					3.2.5.7.	9.31.3.1.							
17	HIGH BUILDING: 🗆 YES 🖾 NO				3.2.6.	N/A								
18	PERMITTED CONSTRUCTION: ACTUAL CONSTRUCTION:					COMBUSTIBLE AND NON-COMBUSTIBLE ALLOWED COMBUSTIBLE					3.2.2.20 3.2.2.83.	9.10.6. 9.10.14.5.		
19	MEZZANIN	E:			C	\Box YES \boxtimes NO IF YES, AREA = m ²					3.2.1.1.(3)-(8)	9.10.4.1., 9.10.4.2.		
20	BARRIER F	REE DESIG	SN:		Σ	YES		C					3.8.	9.5.2.
21	HAZARDO	JS SUBSTA	NCES:] YES	⊠ N	C					3.3.1.2., 3.3.1.19.	9.10.1.3.(4)
22	REQUIRED HORIZONTAL AS FIRE RATINGS: EXISTING FLOORS: EXISTING TO REMAIN ROOF: EXISTING TO REMAIN MEZZANINE: NA			rs: Emain	MBLIES	F	IRE RA	SUPPORTING MEM		ADDITIONAL I	RATINGS REQ'D	3.22.20 3.2.2.83. 3.3.6.8.	9.10.8., 9.10.9.	
23	SPATIAL S	EPARATION	I - CONSTI	RUCTIO	OF EX	FERIOF	RWALLS						3.2.3.	9.10.14.
	WALL	AREA OF EXPOSIN BUILDINO FACE (m ²	G DISTA	ITING NCE (m)	L/H OR	H/L	MAX PERMIT % OF OPENIN	FED	PROPOSED % OF OPENINGS	FIRE RESISTANCE RATING (HOURS)	COMB. OR NON-COMB. CONST. REQ'D	COMB. OR NON-COMB. CLADDING REQ'D		
	SOUTH	-		-	LESS TH	AN 3:1	UNLIMIT	ED	N/A	0	BOTH	BOTH		
	NORTH	-		- LESS TH		AN 3:1	UNLIMIT	ED	N/A	0	BOTH	BOTH		
	EAST	-		- LESS THAN 3:1		AN 3:1	UNLIMIT	ED	N/A	0	BOTH	BOTH		
24		-	REOLIDE	- MENITO	LESS TH	AN 3:1	UNLIMIT	ED	N/A	0	BOTH	BOTH	SP 10	CP 10
24	ENERGY EFFICIENCY REQUIREMENTS			ITIAL	SEMIHEATED I PART 9				SB-10	SB-12 COMPLIANCE				
			-VALUE	UE U-VALUE		ASSEMBL			R-VALUE	U-VALUE	NC	DTES		ALTERNATIVE C199
	ROOF N/A		N/A	۰ -		SLAB ON GRADE			N/A					
	WALLS (ABOVE GRADE)		N/A	/A -			FLOORS OPAQUE		N/A					
	WALLS (BELOW N// GRADE)		N/A -				IESTRATIO		N/A	-				

ITEM	DATA					CODE REFERENCE			
		DATA							
11.1	EXISTING BUILDING	DESCRIBE EXISTING USE:	BUSINESS	AND PER	SONAL SERVIC	ES (OFFICES - 'D')	11.2.1		
	CLASSIFICATION:	CONSTRUCTION INDEX: C.I.: 1				11.2.1.1A 11.	2.1.1B TO N		
		HAZARDOUS INDEX:	H.I.: 3				11.2.1.1.J		
		NOT APPLICAB	LE (NO CHAN	GE OF MA	JOR OCCUPAN	CY)			
11.2	ALTERATION TO	BASIC RENOVATION:					11.3.3.1		
E	EXISTING BUILDING IS:	EXTENSIVE RENOVATION:	\boxtimes				11.3.3.2		
11.3	REDUCTION IN PERFORMANCE LEVEL:	STRUCTURAL	🛛 NO		YES		11.4.2.1		
		BY INCREASE IN OCCUPANT LOAD	🛛 NO		YES		11.4.2.2		
		BY CHANGE OF MAJOR OCCUPANCY	🛛 NO		YES	AS PER 11.4.2.3.(1)(a)	11.4.2.3		
		PLUMBING	🛛 NO		YES	H.I. 3 FOR NEW MAJOR OCCUPANCY	11.4.2.4		
		SEWAGE SYSTEM	🖾 NO		YES		11.4.2.5		
11.4	COMPENSATING	STRUCTURAL	NO NO		YES (EXPLAIN)	11.4.3	11.4.3.2	
	CONSTRUCTION:	INCREASE IN OCCUPANT LOAD	🛛 NO		YES (EXPLAIN)	11.4.3.3		
		CHANGE OF MAJOR OCCUPANCY	🛛 NO		YES (EXPLAIN	I)	11.4.3.4		
		PLUMBING	🛛 NO		YES (EXPLAIN)	11.4.3.5		
		SEWAGE SYSTEM	🛛 NO		YES (EXPLAIN)	11.4.3.6		
11.5	COMPLIANCE ALTERNATIVES:	□ NO ☑ YES (EXPLAIN) DE124, DE126 AND [DE134				11.5.1		
11.5	ALTERNATIVE MEASURES PROPOSED:	NO VES (EXPLAIN)					11.5.2		

GENE	RAL NOTES		
1. <u>G</u> E	NERAL:	3.	ENVIRONMENTAL
1.1.	CONSTRUCTION SHALL BE IN ACCORDANCE WITH THE 2012 ONTARIO BUILDING CODE (AS AMENDED).	3.1	. EVERY VAPOUR E AND SHALL BE SE
1.2.	CONTRACTOR TO VERIFY ALL DIMENSIONS IN FIELD PRIOR TO COMMENCEMENT OF WORK. DO NOT SCALE THESE DRAWINGS.	3.2	2. DRIP FLASHING S OPENINGS
1.3.	DRAWINGS OF A LARGER SCALE SHALL TAKE PRECEDENCE OVER DRAWINGS OF A SMALLER SCALE.	4.	
1.4.	THESE DRAWINGS ARE THE PROPERTY OF SAULTEAUX CONSULTING & ENGINEERING (SCE). UNAUTHORIZED REPRODUCTIONS OF THESE DRAWINGS IS PROHIBITED WITHOUT THE CONSENT OF SCE.	4.1	I. COMBINATION SM THE REQUIREMENT THE OBC (AS AME SIGNALING COMP REQUIREMENTS (AND SIGNALING C
1.5.	MECHANICAL, PLUMBING AND ELECTRICAL DESIGNS DONE BY OTHERS.	5.	DOORS AND WIND
2. <u>W(</u> 2.1.	DOD, FRAMING AND FASTENERS: ALL STRUCTURAL FRAMING MEMBERS SHALL BE #1 OR #2 GRADE SPRUCE/PINE/FIR.	5.1	ALL EXTERIOR DO OF SECTION 9.7.5 DOORS".
2.2.	ALL WOOD IN CONTACT WITH CONCRETE SHALL EITHER BE PRESSURE TREATED OR PROTECTED BY 6 MIL CGSB VAPOUR BARRIER.		
2.3.	ALL WINDOW AND DOOR LINTELS TO BE MIN. 2 PLY 2x10, C/W SINGLE 2x6 CRIPPLE STUD ON EITHER SIDE OF OPENING, UNLESS OTHERWISE NOTED		RAIN TO

L SEPARATION:

R BARRIER JOINT SHALL LAP NO LESS THAN 4" SEALED OR SUPPORTED BY FRAMING.

SHALL BE APPLIED OVER EXTERIOR WALL

DN:

SMOKE ALARMS ARE TO BE INSTALLED BASED ON MENTS OF SECTIONS 9.10.19, RESPECTIVELY, OF MENDED). SMOKE ALARMS SHALL HAVE A VISUAL MPONENT THAT CONFORMS TO THE S OF 18.5.3. OF NFPA 72, "NATIONAL FIRE ALARM G CODE".


DOWS:

DOORS SHALL CONFORM TO THE REQUIREMENTS 7.5.2. "RESISTANCE TO FORCED ENTRY FOR

NY RIVER LIBRARY

312 4TH STREET FOWN OF RAINY RIVER, ON

Architecture LP MOCKII ARCHITECTURE 656 CITY ROAD, BOX 4, UNIT 12 FORT VILLIAM FIRST NATION, ONTARIO 771 IN3 1-807-633-2389 SUITE 203-23389 SAULTEAUX CONSULTING & ENGINEERING SITE 206-207 R#2 FORT FRANCES, ONTARIO PA 31M3 1-807-274-7114
1-807-274-7114 ARCHITECTS Z VULU PULUU VIKKI LEE PULATTI LICENCE 9059 2024-03-15
2 PERMIT/CONSTRUCTION 24/03/14 1 CLIENT REVIEW 24/02/28
NO. DESCRIPTION YR/MM/DD
REVISIONS
LIBRARY RENOVATION
312 4TH ST RAINY RIVER, ON SHEET TITLE: OBC MATRIX AND GENERAL NOTES
SCALE: AS SHOWN DRAWN BY: MD CHECKED BY: VP PROJECT NO.: 23-113 REVISION NO: - PROJECT 51ART DATE: START DATE: 2024-02-20
SHEET NO. 1.1

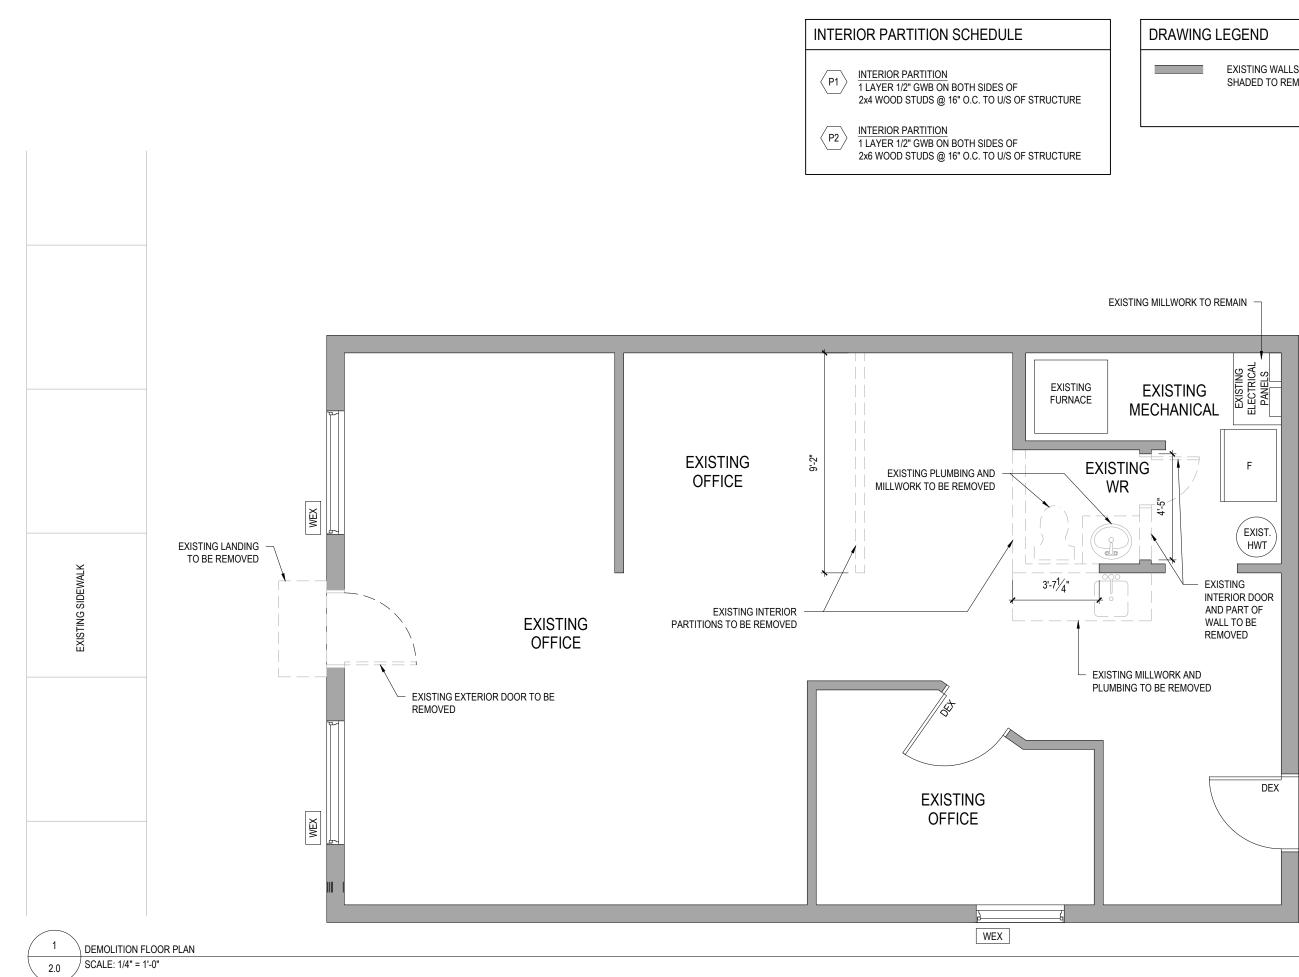


DRAW	ING L	EGEND



EXISTING WALLS SHOWN SHADED TO REMAIN

1 1 44
MOOKII ARCHITECTURE 656 CITY ROAD, BOX 4, UNIT 12 FORT WILLAM FIRST NATION, ONTARIO P7.1 1K3 1-807-633-2389
SCE
SAULTEAUX CONSULTING & ENGINEERING SITE 206-207 RR#2 FORT FRANCES, ONTARIO P9A 3M3 1-807-274-7114
ARCHITECTS Z VWM PMMUU VIKKI LEE PUIATTI UICENCE 9059 2024-03-15
2 PERMIT/CONSTRUCTION 24/03/14
1 CLIENT REVIEW 24/02/28
NO. DESCRIPTION YR/MM/DE
LIBRARY RENOVATION
312 4TH ST RAINY RIVER, ON SHEET TITLE: DEMOLITION FLOOR PLAN
SCALE: AS SHOWN
DRAWN BY: MD
CHECKED BY: VP PROJECT NO.: 23-113
REVISION NO.: -
START DATE: 2024-02-20
SHEET NO. 2.0

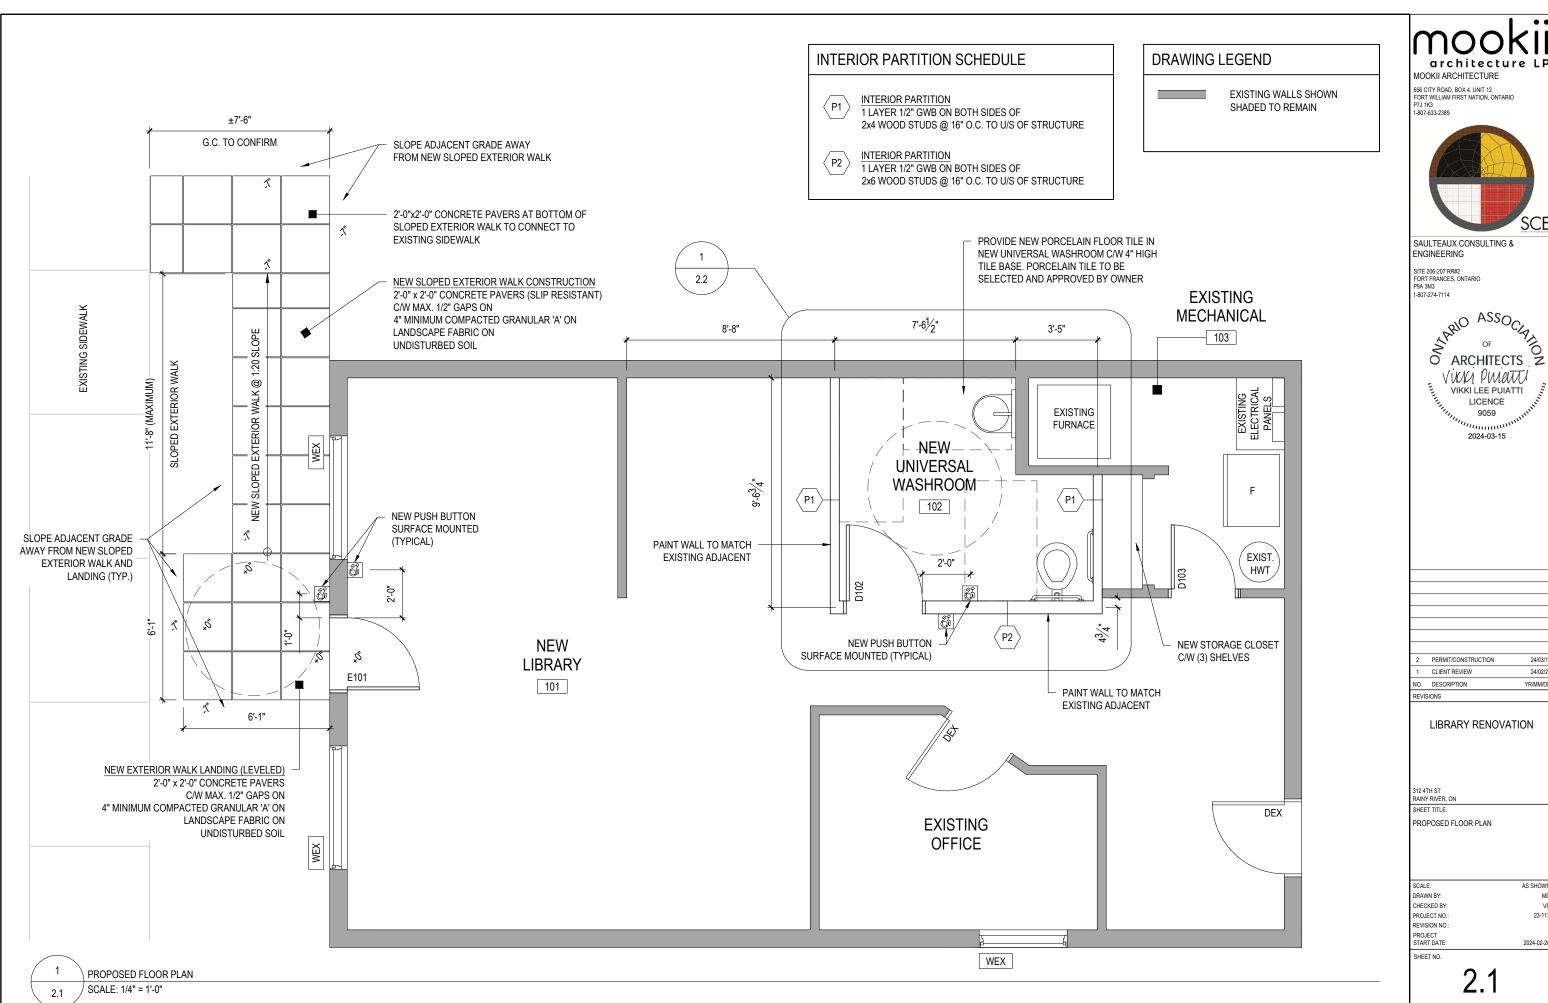

SCF

24/03/14

24/02/28


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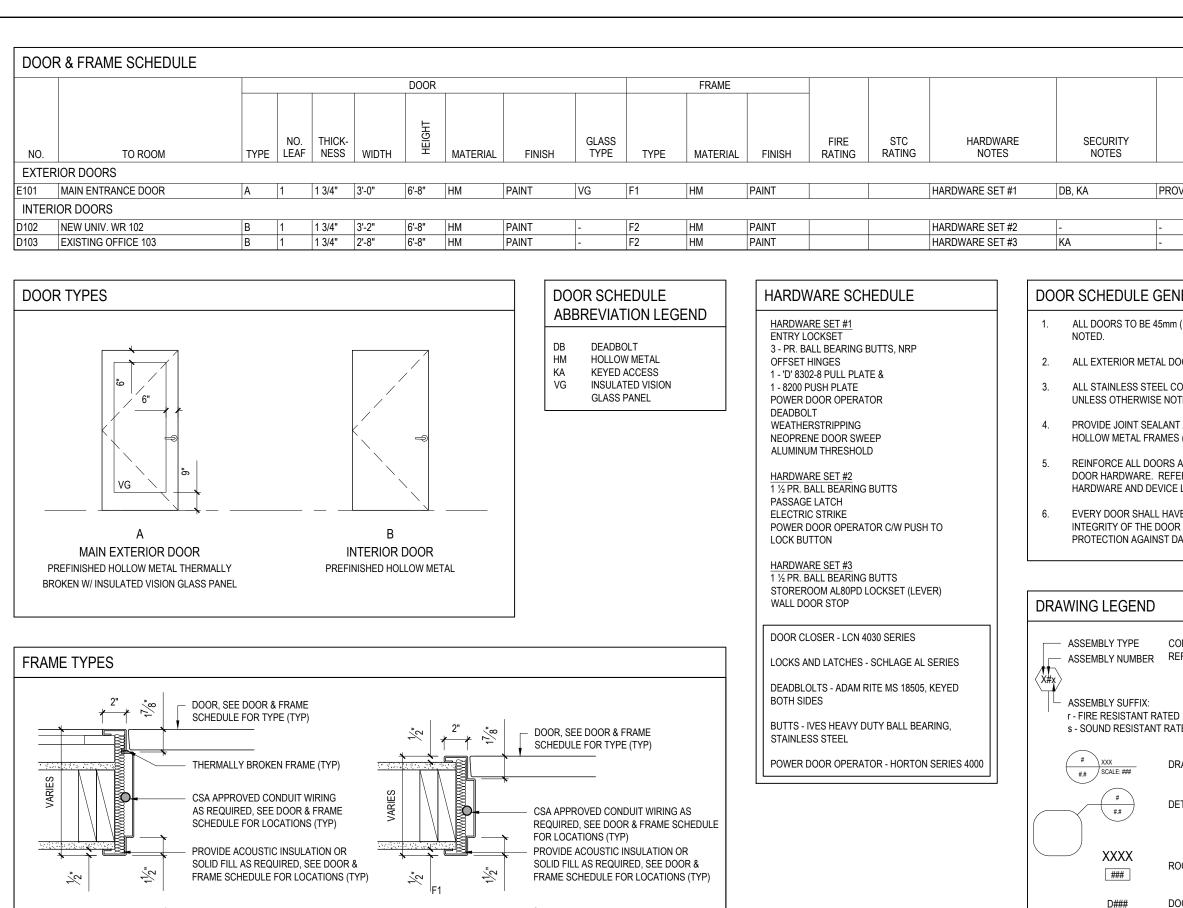
AS SHOWN

MD

VP 23-113

2024-02-20



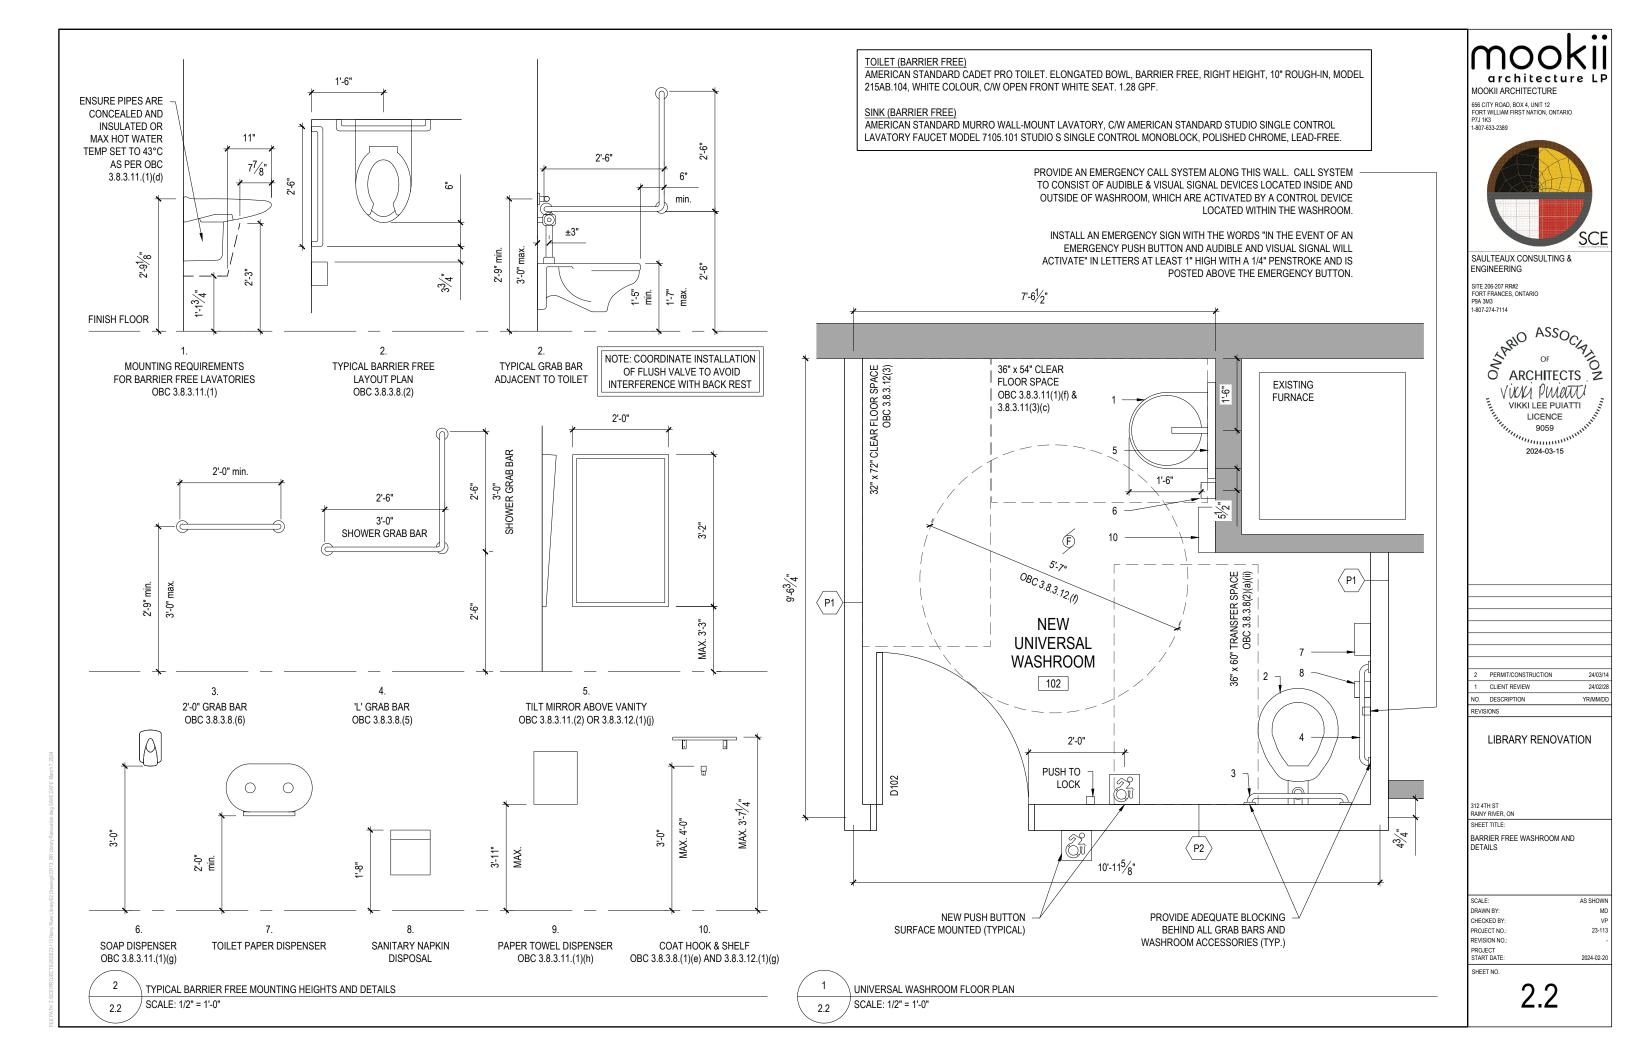

F2

INTERIOR DOOR

HOLLOW METAL

F1

EXTERIOR DOOR

HOLLOW METAL

THERMALLY-BROKEN FRAME

W##

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	NOTES
	PROVIDE OFFSET HINGES
	-
	-

DOOR SCHEDULE GENERAL NOTES

ALL DOORS TO BE 45mm (1 3/4") THICK, UNLESS OTHERWISE

ALL EXTERIOR METAL DOORS AND FRAMES TO BE INSULATED.

ALL STAINLESS STEEL COMPONENTS TO HAVE BRUSHED FINISH, UNLESS OTHERWISE NOTED.

PROVIDE JOINT SEALANT AROUND ALL EXTERIOR AND INTERIOR HOLLOW METAL FRAMES (BOTH SIDES).

REINFORCE ALL DOORS AND FRAMES TO ACCEPT SPECIFIED DOOR HARDWARE. REFER TO DOOR & FRAME SCHEDULE FOR HARDWARE AND DEVICE LOCATIONS.

EVERY DOOR SHALL HAVE A DOOR STOP TO PROTECT THE INTEGRITY OF THE DOOR AND PROVIDE ADDITIONAL PROTECTION AGAINST DAMAGE OF THE WALL FINISH.

CONSTRUCTION ASSEMBLY TAG ASSEMBLY NUMBER REFER TO ASSEMBLIES LEGEND

s - SOUND RESISTANT RATED

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/	

DETAIL TAG/CALL OUT

DRAWING DETAIL TAG

X	ROOM TAG AND NUMBER
:	

DOOR TAG REFER TO DOOR SCHEDULE

> WINDOW TAG REFER TO WINDOW SCHEDULE

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MOOKII ARCHITECTURE 656 CITY ROAD, BOX 4, UNIT 12 FORT WILLIAM FIRST NATION, ONTARIO P7J 1K3 1-807-633-2389
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REVISIONS
LIBRARY RENOVATION
312 4TH ST RAINY RIVER, ON
SHEET TITLE: DOOR SCHEDULE AND DRAWING LEGEND
SCALE: AS SHOWN DRAWN BY: MD
CHECKED BY: VP PROJECT NO.: 23-113
REVISION NO.: - PROJECT START DATE: 2024-02-20
SHEET NO.
3.1