
NEW LAWRENCE GROCERY


SAN LEON, TX

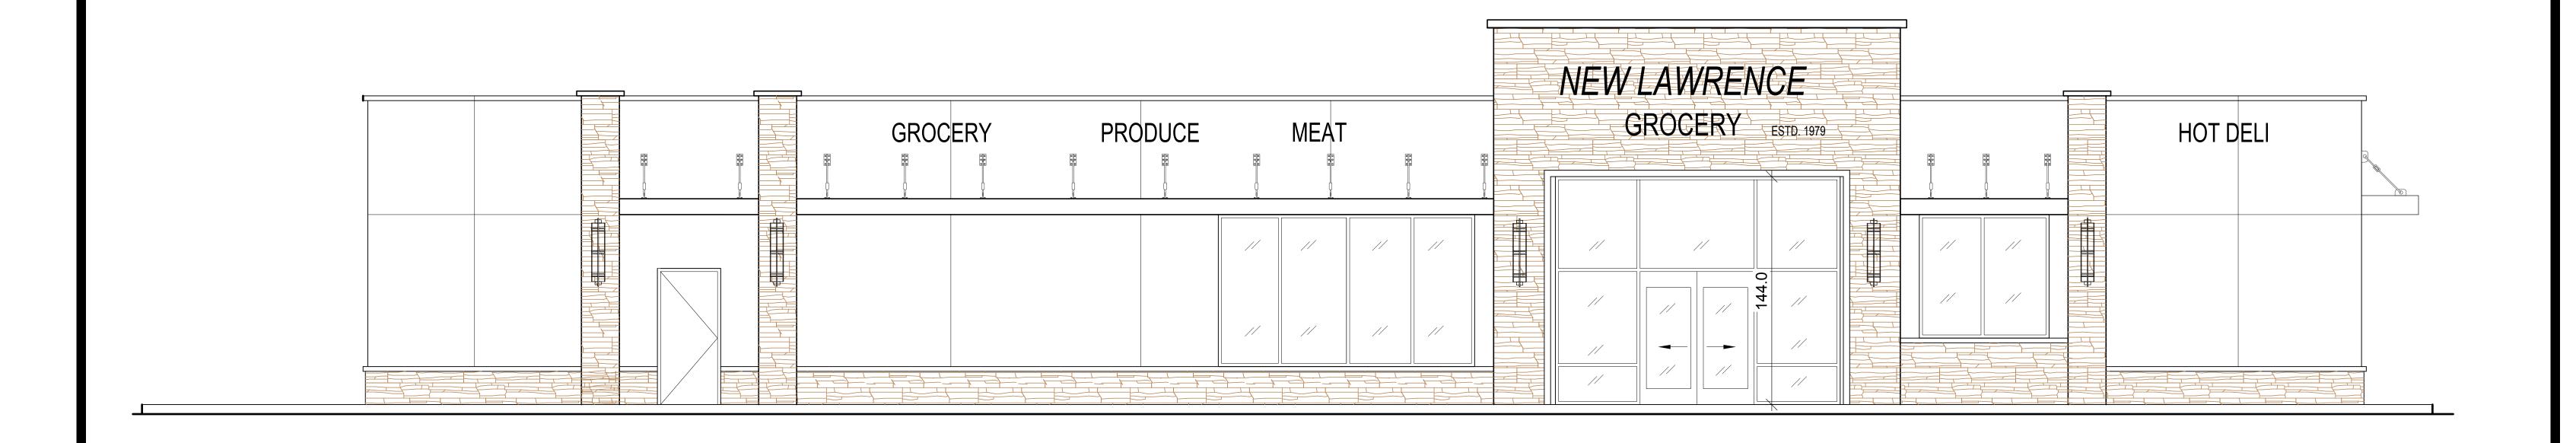

OWNER'S INFORMATION:


Mr. Barket Ali
Lawrence Grocery

Lawrence Grocery@gmail.com

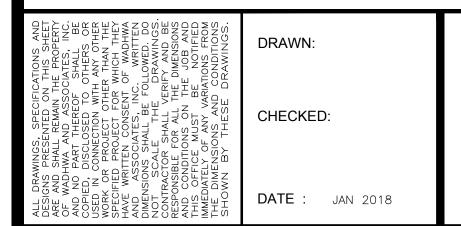


NEW LAWRENCE GROCERY


902 E. BAYSHORE, SAN LEON, TEXAS 77539

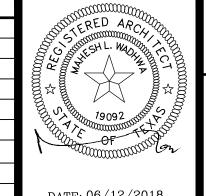






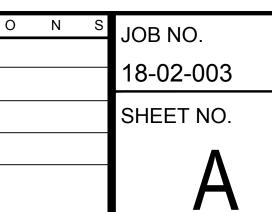

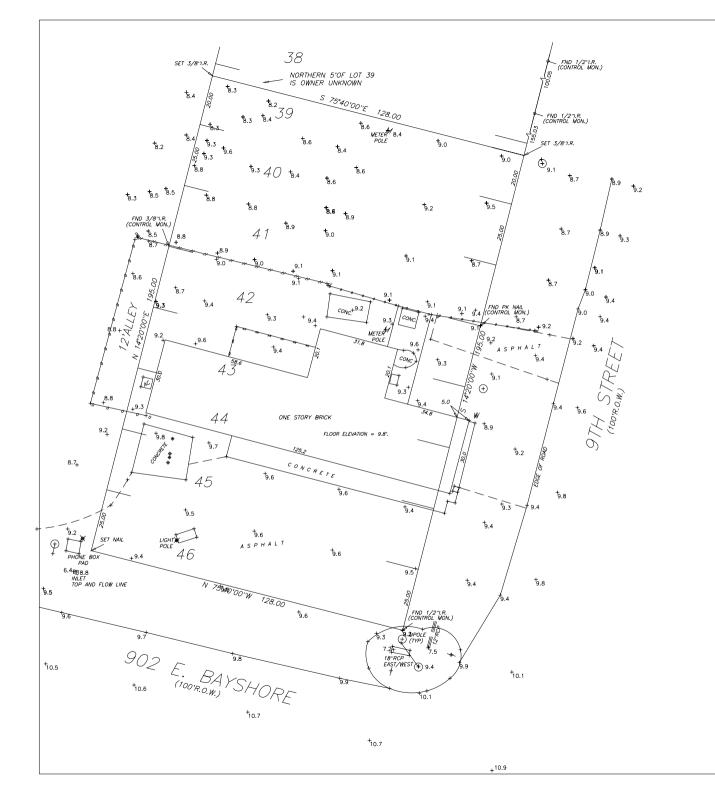

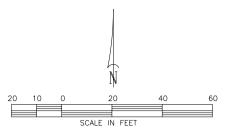

BOUNDARY AND TOPOGRAPHIC SURVEY LOTS 40 THROUGH 46. AND THE SOUTH 20 FEET OF LOT 39 IN BLOCK 13, SAN LEON TOWNSITE, GALVESTON COUNTY, TEXAS

According to the map or plat thereof recorded in Vol. 238, Page 27 in the Office of the County Clerk of Galveston County, Texas.

I, Christopher Trusky, Registered Professional Land Surveyor in the State of Texas, hereby certify that this plat represents a survey mode on the ground under my direction and super-vision on November 17, 2017. At the time of this survey there were no encroachments, conflicts or protrusions apparent on the ground, EXCEPT AS SHOWN.

THIS SURVEY IS CERTIFIED FOR THIS TRANSACTION ONLY.

Christopher Trusky RPLS No. 5247 The Land Survey Co. LLC Firm Reg. No. 10045700 281-338-4008



According to FIRM Community Panel No. 4854700105C, dated 05/02/1983, this property lies in Flood Zone "A12", which is considered to be WITHIN the Special Flood Hazard Area. Surveyor makes no representation as to whether or not this property may flood.

Basis of bearings is the right of way of 9th Street, as platted and

Other matters or encumbrances affecting the subject property, if any, are not shown.

Elevations shown hereon are referenced to the publiched elevation of USCGS Benchmark Z-1186. (NGVD 29 DATUM)

Base Flood Elevation is 11'.

SAN LEON, TX

VICINITY MAP GENERAL NOTES **ABBREVIATIONS** LIST OF DRAWINGS ALL WORK SHOULD BE DONE AS PER I.B.C.. REQUIREMENTS AND ANY OTHER APPLICABLE COVER HVAC DETAILS REGULATIONS AND ORDINANCES. JANITOR 37. KEEP ALL PIPING AS CLOSE TO WALL AND AS HIGH TO UNDERSIDE OF ROOF FRAMING ANCHOR BOLTS SLAB AS POSSIBLE. JOINT SURVEY HVAC DETAILS ASPHALTIC CONCRETE GENERAL CONTRACTOR TO PROVIDE APPROVED FIRE EXTINGUISHER AS REQUIRED BY FIRE MARSHALL. LOCATION SHALL BE AS DETERMINED IN FIELD BY FIRE MARSHALL. FIRE 38. ALL SOIL POISONING BY GENERAL CONTRACTOR. AIR CONDITIONING GEN. NOTES/ABBREVIATIONS/VICINITY MAP LAMINATED EXTINGUISHER TO BE RECESSED. ACOUS. ACOUSTIC 39. ALL VENTILATION AND FRESH AIR LOUVERS BY GENERAL CONTRACTOR. SITE PLAN AND FIRE LANE PLAN ELECTRICAL NOTES AND SCHEDULE LAV. LAVATORY REFER TO STRUCTURAL DRAWINGS FOR ROOF ELEVATIONS. ADJ. ADJUSTABLE SITE UTILITY AND LIGHTING PLAN LIGHTING PLAN 40. TESTING OF MATERIAL AND COMPACTION DURING CONSTRUCTION BY GENERAL CONTRACTO ALUM. ALUMINUM ALL INTERIOR WALL DIMENSIONS ARE TO EDGE OF STUD, UNLESS OTHERWISE NOTED. MAXIMUM PAVING AND SITE DETAILS ROOF LEVEL LIGHTING PLAN 41. ALL ROOF DRAINS SHALL BE LOCATED AT THE LOWEST POINT ON THE ROOF, TAKING INT ALL EXTERIOR WALL DIMENSIONS ARE TO END OF STEEL MEMBERS OR STUDS UNLESS CONSIDERATION THE CAMBER OF BEAMS AND DEFLECTION OF CANTILEVERS. CONTRACTOR BUILDING MECHANICAL POWER PLAN OTHERWISE NOTED. SHALL VERIFY THAT POSITIVE DRAINAGE EXISTS FROM ALL POINTS OF ROOF PRIOR TO BLK. BLOCK MET. METAL ROOF LEVEL POWER PLAN GRADING & DRAINAGE PLAN INSTALLING ROOFING MATERIAL. INTERIOR PARTITIONS ARE METAL STUDS AT 16" O.C. UNLESS OTHERWISE NOTED. BLKG. BLOCKING MANUFACTURED STANDARD DETAILS LOAD ANALYSIS AND ONE LINE DIAGRAM 42. ALL EXTERIOR DOORS SHALL BE PROVIDED W/ DRIP FLASHING AT HEAD. BEAM UNLESS SPECIFICALLY LOCATED, DOORS SHALL BE CENTERED IN WALL OR LOCATE DOOR STORM WATER POLLUTION PREVENTION PLAN E5 PANEL SCHEDULE MASONRY BTWN. BETWEEN JAMB 8" FROM NEAREST WALL CENTERLINE OR 4" FROM NEAREST OBSTRUCTION. 43. DO NOT SCALE DRAWINGS, WRITTEN DIMENSIONS TO BE FOLLOWED. OPENING THE GENERAL CONTRACTOR SHALL VERIFY ALL EXIST. CONDITIONS AND DIMENSIONS ON THE CABINET MULL. MULLION ACCESSIBILITY STANDARDS PLUMBING FLOOR PLAN JOB SITE AND REPORT ANY AND ALL DISCREPANCIES AND/OR UNUSUAL CONDITIONS TO C.C. CENTER WADHWA & ASSOCIATES, INC. PRIOR TO FINALIZING BIDS AND COMMENCEMENT OF ANY MFGR. MANUFACTURER ACCESSIBILITY ROUTES AND SITE DETAILS PLUMBING NOTES AND SCHEDULES TO CENTER PLUMBING RISERS GENERAL ACCESSIBILITY DETAILS CEM. CEMENT NATURAL NAT. CONTRACTOR SHALL OBTAIN ALL PERMITS, PAY ALL FEES FOR PERMITS, AND CHECK ALL CER. CERAMIC ACCESSIBILITY PLUMBING DETAILS PLUMBING DETAILS GOVERNING AUTHORITIES SPECIFICATIONS FOR CONSTRUCTION INCLUDING REMOVAL OR NATURAL GRADE CLG. RELOCATION OF EXISTING UTILITIES OR OTHER PHYSICAL OBJECTS SHOWN ON PLANS OR CEILING **ACCESSIBILITY NOTES:** A0.4 MISC. ACCESSIBILITY DETAILS PLUMBING DETAILS N.I.C. NOT IN CONTRACT CLOS. CLOSET A1 FLOOR PLAN NOT IN SCALE CONTRACTOR SHALL PROVIDE PUBLIC PROTECTION AS NECESSARY AND REQUIRED BY THE COLUMN A1.1 ROOF PLAN SHEET 1 CAPTIVEAIRE GOVERNING AUTHORITIES. CONC CONCRETE HAND ACTIVATED DOOR OPENING HARDWARE TO BE MOUNTED 30" TO 44" ABOVE THE FLOOR AND BE OPERABLE WITH A SINGLE EFFORT BY LEVER TYPE HARDWARE. CORR. A1.2 WALL TYPES AND GENERAL NOTES SHEET 2 CAPTIVEAIRE CORRIDOR Ο.Α. OVER ALL 1. UNLESS OTHERWISE INDICATED ON THESE DRAWINGS OR IN THE SPECIFICATIONS AS BEING N.I.C. OR EXISTING, ALL ITEMS, MATERIALS, ETC. AND INSTALLATION OF SAME ARE A PART MAXIMUM EFFORT TO OPERATE DOORS SHALL NOT EXCEED 8.5 POUNDS FOR EXTERIOR DOORS AND CONT. CONTINUOUS O.C. ON CENTER A1.3 EQUIPMENT PLAN OF THE CONTRACT DEFINED BY THESE DRAWINGS AND SPECIFICATIONS. CONTRACTOR O.D. OUTSIDE DIAMETER A1.4 REFLECTED CEILING PLAN 3. ALL REQUIRED EXIT DOORWAYS, INCLUDING OFFICE AREA, SHALL HAVE A MINIMUM 32" CLEAR OPENING WITH THE DOOR AT 90" TO THE CLOSED POSITION. . THE BUILDING AND FACILITIES MUST BE ACCESSIBLE TO AND FUNCTIONAL FOR THE CTSK. COUNTERSUNK O.F.D. OVER FLOW DRAIN EXTERIOR ELEVATIONS PHYSICALLY HANDICAPPED. OPG. OPENING A2.1 EXTERIOR ELEVATIONS 4. MAXIMUM HEIGHT OF THRESHOLD TO BE 1/2" MAXIMUM VERTICAL CHANGE AT EDGE IS 1/4" WITH 1.3. GENERAL CONTRACTOR IS RESPONSIBLE TO COORDINATE WORK OF ALL OWNERS. DET. A MAXIMUM BEVEL OF 45. O.T.O. OUT TO OUT SUBCONTRACTORS AND FIXTURE CONTRACTORS INCLUDING THE PERFORMANCE OF SUCH ENLARGED RESTROOM DETAILS DRINKING FOUNTAIN MISCELLANEOUS WORK AS MAY BE NECESSARY FOR THEM TO COMPLETE THEIR WORK. PROJECT 5. WIDTH AND HEIGHT OF REQUIRED EXIT DOORWAYS TO COMPLY WITH IBC. BUILDING SECTION DIAMETER LOCATION PART PARTITION 4. UNLESS OTHERWISE NOTED, THE CONTRACTOR SHALL PROVIDE SOLID BLOCKING AS 6. EXITS SHALL BE ILLUMINATED AT ANY TIME THE BUILDING IS OCCUPIED, WITH LIGHT HAVING AN DETAIL SECTIONS REQUIRED FOR NAILING OF ALL INTERIOR AND EXTERIOR TRIM, FINISHES, AND SHALL DIMENSION INTENSITY OF NOT LESS THAN ONE FOOT-CANDLE AT FLOOR LEVEL PER IBC PANIC DEVICE P.D. COORDINATE AND PROVIDE ALL FRAMING AND BRACING AS NECESSARY FOR INSTALLATION OF D.S. DOWN SPOUT INTERIOR ELEVATIONS **VICINITY MAP** N.I.C. EQUIPMENT INDICATED. PROPERTY LINE DWGS. DRAWINGS DOORS AND WINDOWS SCHEDULES 8. PROVIDE APPROVED EXITING ILLUMINATION AND ILLUMINATED EXIT SIGNS PER IBC. PLATE 5. PROVIDE EXIT SIGN ON ALL EXITS AS REQUIRED BY CODE. SCALE: NTS KEY MAP A7.1 ROOM FINISH SCHEDULE PLAS. PLASTER 9. PROVIDE APPROVED PANIC HARDWARE ON EXIT DOORS PER IBC. 16. ALL REQUIRED EXIT DOORS SHALL BE OPENABLE FROM THE INSIDE WITHOUT THE USE OF A ELECTRIC DRINKING PLYWD. KEY OR SPECIAL KNOWLEDGE OR EFFORT EXCEPT EXTERIOR DOORS WHICH ARE IDENTIFIED PLYWOOD WITH A VISIBLE SIGN HAVING NOT LESS THAN 1" HIGH LETTERS STATING "THIS DOOR TO FOUNTAIN BLDG. CODES PLBG. PLUMBING FOUNDATION PLAN CITY OF SAN LEON REMAIN UNLOCKED DURING BUSINESS HOURS." EACH FOUNDATION DETAILS EXPANSION JOINT 1. WHERE EXIT DOORS SWING OUT OVER A LANDING, THE LANDING SHALL BE NOT MORE THAN STRUCTURAL NOTES RAD. RADIUS ELEV. ELEVATION ALL WORK PROCEDURES AND CRAFTSMANSHIP **GENERAL CONDITIONS:** FRAMING PLAN REINFORCEMENT 18. SIZES OF MECHANICAL EQUIPMENT PADS, BASES, ROOF EQUIPMENT PADS, AND OPENINGS ARE A BASIS FOR DESIGN ONLY. CONTRACTOR SHALL VERIFY DIMENSIONS OF AL STRUCTURAL DETAILS <u> 10 MEET OR EXCEED THE FOLLOWING CODES:</u> REQUIRED EQUAL EQUIPMENT PADS AND BASES WITH EQUIPMENT MANUFACTURERS. MECHANICAL CONTRACTOR SHALL VERIFY ALL SIZES AND LOCATIONS OF DUCT OPENINGS ON ROOF. ROOF DRAIN INTERNATIONAL BUILDING CODE <u>BLIGATIONS WHICH THE GENERAL CONTRACTOR MUST MEET:</u> EQUIP. EQUIPMENT MECHANICAL NOTES AND SCHEDULES). WHERE LARGER STUDS OR FURRING IS REQUIRED TO COVER DUCTS, PIPING CONDUITS, ETC., ROOM FEMA. FLOOD CONTROL CONSTRUCT AND COMPLETE SPECIFIED CONSTRUCTION UPON DESCRIBED PROPERTY IN EXIST. EXISTING THE LARGER STUD OR FURRING SHALL EXTEND THE FULL LENGTH OF THE SURFACE WHERE MECHANICAL PLAN ROUGH OPENING GOOD AND WORKMANLIKE MANNER. NFPA. LIFE SAFETY CODE EXPANSION R.W. REDWOOD MECHANICAL ROOF PLAN EXTER. USE ONLY NEW MATERIALS FOR CONSTRUCTION. EXTERIOR INTERNATIONAL MECHANICAL CODE IMC 2012 O. TOILET ROOMS SHALL BE PROVIDED WITH A MECHANICAL VENTILATING SYSTEM TO PROVIDE ONE (1) COMPLETE CHANGE OF AIR EVERY 15 MINUTES AND CONNECTED TO THE LIGHT SINK NATIONAL ELECTRICAL CODE NEC 2017 CONFORM TO PLANS AND SPECIFICATIONS SIGNED AND TO BE ALTERED DATED BY SWITCH. ALSO MECHANICAL EQUIPMENT ROOMS. PARTIES (NOT WITHOUT WRITTEN CONSENT OF ALL PARTIES, INCLUDING ISSUER OF SECTION SECT. FLOOR DRAIN INTERNATIONAL PLUMBING CODE IPC 2012 . TWO HOUR SEPARATION WALLS SHALL CONSIST OF 2-LAYERS OF 5/8" TYPE "X" DRY WALL FIRE EXTINGUISHER SHEET - Doors at 0.2 per Load or min. of 32" INTERNATIONAL FIRE CODE IFC 2012 BOTH SIDES OVER METAL STUDS FLOOR TO BOTTOM OF ROOF DECK. UNLESS OTHERWISE COMPLY WITH RULES, REGULATIONS, LAWS, CODES AND ORDINANCES PERTINENT TO FINISH GRADE MEANS OF EGRESS: (Reference 1005.1) SIM. SIMILAR INTERNATIONAL FUEL & GAS CODE IFGC 2012 SPEC. SPECIFICATION CABINET 2. PROVIDE METAL TRIM OR CASING AT ALL EDGES OF PLASTER AND DRYWALL SURFACES INTERNATIONAL ENERGY IECC 2012 <u>Requirements</u> COMMENCE WORK WITHIN A SPECIFIED NUMBER OF DAYS AFTER RECEIPT OF NOTICE <u>Provided</u> WHERE IT TERMINATES OR MEETS ANY OTHER MATERIAL, UNLESS OTHERWISE NOTED. S.S. SERVICE SINK FIRE HOSE CABINET FROM OWNER, AND COMPLETE WORK WITHIN A SPECIFIED TIME. – 1 (minimum) # of Exits CONSERVATION CODE ST.& V. STAIN & VARNISH — Dead End Corr. — 20' max. No Dead End Corri. 23. ALL EXTERIOR WALL OPENINGS, FLASHINGS, COUNTER FLASHINGS, COPINGS, AND EXPANSION FLAT HEAD WOOD PAY ALL VALID BILLS, FURNISH RECEIPT FOR BILLS UPON REQUEST, AND KEEP STL. STEEL JOINTS SHALL BE WEATHERPROOF. Corridor Width - 44" min – N/A PROPERTY FREE FROM LIENS. 90.1 - 2013STAINLESS STEEL 24. ALL RAMPS SHALL HAVE A MEDIUM BROOM FINISH. SEE RAMP DET. IN SHT. X1 CARRY PUBLIC LIABILITY INSURANCE AND WORKMAN'S COMPENSATION INSURANCE FINISH STD. STANDARD AMERICAN DISABILITIES ACT ADAAG 2010 25. ALL BUILDING INSULATION SHALL HAVE A FLAME SPREAD RATING LESS THAN 25 AND SMOKE F.O.S. FACE OF STUD STRUCT. STRUCTURAL (with all the addendums) DEVELOPED VALUE OF MAXIMUM 450. OBTAIN APPLICABLE BONDS, IF NECESSARY AND/OR REQUIRED. F.S. FLOOR SINK SUSPENDED 26. FIRE STOPPING SHALL BE PROVIDED TO CUT OFF ALL CONCEALED DRAFT OPENINGS (BOTH MAKE NO ASSIGNMENT OF CONTRACT WITHOUT BANK OR SURETY APPROVAL. FOOT HORIZONTAL AND VERTICAL) AS SHOWN ON DRAWINGS AND AS REQUIRED BY CODE. THREAD FTG. FOOTING REMOVE ALL DEBRIS FROM PREMISES AND UNDER AREA OF STRUCTURE, AND LEAVE 27. CONTRACTOR TO NOTIFY OWNER OF ANTICIPATED FINAL INSPECTION DATE TWO WEEKS IN STRUCTURE BROOM-CLEAN AND READY FOR OCCUPANCY. FURN. TOP OF BEAM ADVANCE, IN WRITING. CODE ANALYSIS TOP OF CURB . COOPERATE WITH LENDER AND LENDER'S AGENT IN THE DISBURSEMENT 28. ALL REQUIRED PERMITS MUST BE OBTAINED FROM ALL GOVERNING AUTHORITIES PRIOR TO BUILDING SINGLE STORY NON-COMBUSTIBLE GAUGE TELEPHONE START OF CONSTRUCTION. GALV. GALVANIZED FLOOR AREA 7,875 SQFT. TOOLED JOINT 29. PROVIDE METAL CORNER BEAD AT ALL OUTSIDE CORNERS OF PLASTERED OR DRYWALL GLASS TRANSF. TRANSFORMER BUILDING HEIGHT 20'-3" SURFACES, UNLESS OTHERWISE NOTED. GR. GRADE OCCUPANCY GROUP -TOP OF SLAB 30. UNLESS OTHERWISE NOTED, ALL EXTERIOR AND INTERIOR EXPOSED METAL TRIM, MOLDING, GYP. GYPSUM FRAMES, CASING, COPING AND FLASHINGS SHALL BE PAINTED TO MATCH ADJACENT T.W. TOP OF WALL GYP. GYPSUM BOARD CONSTRUCTION TYPE -II B (NON SPRINKLED) MATERIALS, COLOR TO BE TO BE APPROVED BY OWNER / DESIGNER. TYPICAL FLOOR AREA (GROUP M) -7,875 SQFT. 1. IN ALL CASES, PROVIDE ISOLATION OF ALUMINUM FROM ADJACENT STEEL OR COAT SURFACES IN CONTACT WITH BITUMINOUS PAINT. HGT. HEIGHT VERTICAL 7,875/30 = 262 > 50OCCUPANT LOAD (GROUP M)-32. ALL GLAZING ALUMINUM SECTIONS SHALL CONFORM TO I.B.C. REQUIREMENTS OF 1/175 H.M. HOLLOW METAL VESTIBULE NO. OF EXITS REQD. HORIZ. HORIZONTAL 33. GENERAL CONTRACTOR TO PROVIDE SHORING FOR ALL UNDERGROUND OPEN TRENCHING AS EXIT ACCESS TRAVEL DISTANCE - 200 FEET MAX. HTG. WAINSCOT REQUIRED FOR SAFETY. TDLR NO.: B8819325 HWD. HARDWOOD WATER CLOSET W.C. NON RATED EXTERIOR WALLS 34. IT SHALL BE THE GENERAL CONTRACTOR'S RESPONSIBILITY TO PROVIDE ADEQUATE TRENCH WOOD SIZE ALLOWING FOR REQUIRED CLEARANCE BETWEEN LINES, WHEN MORE THAN ONE ISSUED FOR BIDS NON RATED INTERIOR WALLS SUBCONTRACTOR WILL UTILIZE THE SAME TRENCH. WATER HEATER ISSUED FOR CONSTRUCTION W.H. WATER CLOSET W.C. 5. THE CONTRACTOR IS TO NOTIFY WADHWA & ASSOCIATES, INC. WHEN THE PLUMBING AND ISSUED FOR FRANCHISE'S ELECTRICAL HAS BEEN "ROUGHED IN" SO THAT LOCATION CAN BE VERIFIED BEFORE SLAB IS final review WIND WINDOW CONTRACTOR SHALL INFORM CITY INSPECTION DEPARTMENT AND ALL ISSUED FOR CUSTOMER'S FINAL REVIEW OTHER GOVERNING AGENCIES PRIOR TO START OF CONSTRUCTION 6. THE CONTRACTOR SHALL PROVIDE THE OWNER WITH A LETTER OF CERTIFICATION PREPARED AND AT ALL STAGES AS REQUIRED BY ALL GOVERNING AGENCIES. IMMEDIATELY AFTER FOOTINGS ARE PLACED TO CONFIRM THAT LOCATION OF FOOTINGS I.F.P. ISSUED FOR PERMIT COMPLY WITH THE APPROVED SITE DRAWINGS. THIS SHALL BE DONE BY THE SITE CIVIL INSIDE DIAMETER ENGINEERS AT THE CONTRACTOR'S EXPENSE. ANY DISCREPANCIES FROM THE APPROVED BUILDING LOCATION SHALL BE CORRECTED AT THE CONTRACTOR'S EXPENSE. INTERIOR DO NOT SCALE DRAWINGS, WRITTEN DIMENSIONS TO BE FOLLOWED. INCHES SCALE: NO SCALE V I S I O N


DRAWN:

CHECKED:

DATE: JAN 2018

NEW LAWRENCE GROCERY


902 E. BAYSHORE SAN LEON, TEXAS 77539

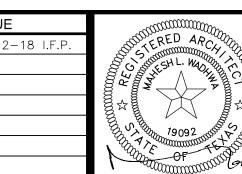




04-17-17 REVISED AS NOTED chitects, planner and construction administration 1 2 2 0 Blalock # 2 3 0 Ph: (713) 4 6 5 - 0 0 0 9 Houston, Texas 77055 Fax: (713) 465-239


18-02-003

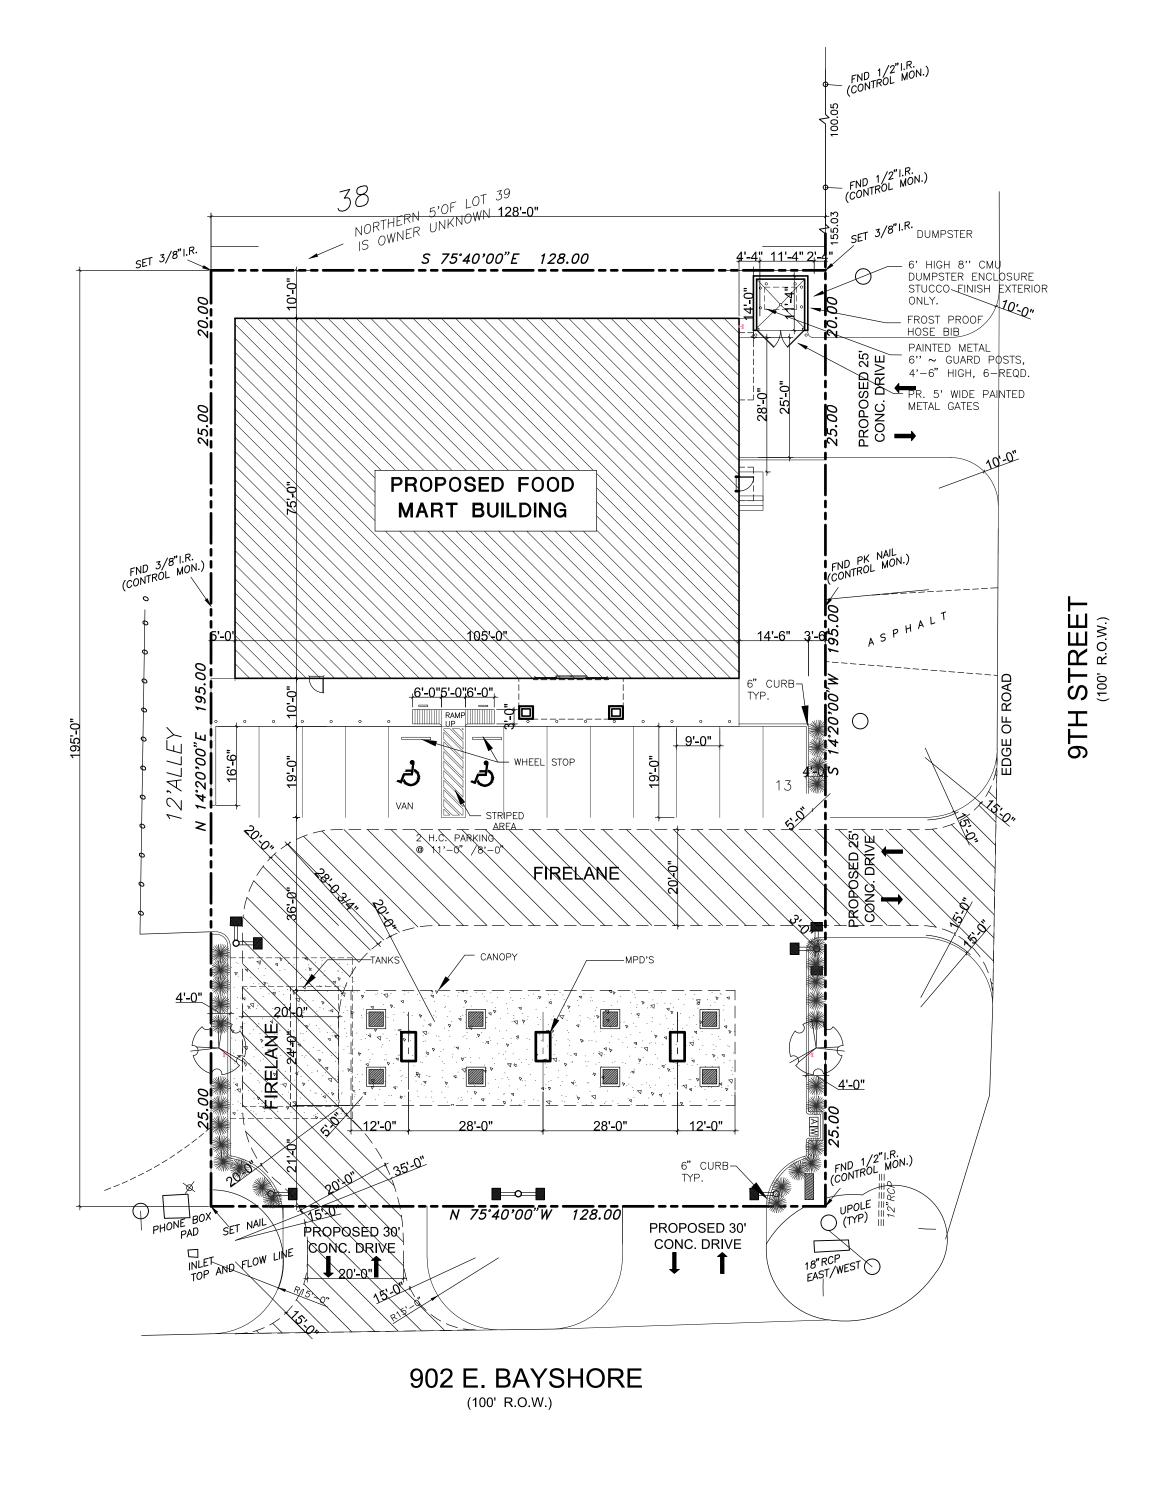

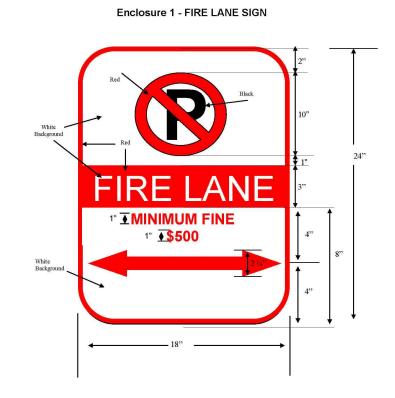

Note: Drawing NOT to scale. All graphics and lettering shall be center

Enclosure 3 - Plotting Fire Lane Signs The direction the fire lane signs are to point and the distance apart shall be shown on

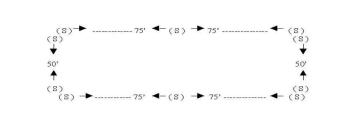

(Examples are not drawn to scale)

3.7.1 Fire Department Access Road (Fire Lane) Signs.

- 3" MULCH IN PLANTING BED.

3 GUY WIRES PER
PLANT REQUIRED.
SPACE EQUALLY AT
120' AROUND TREE.
5 GUY WIRES USED
FOR 5" CAL. OR LARGER

--- FINISHED GRADE

SPECIFICATIONS:

1. Size of sign: Standard - 18 inches in width, 24 inches in height

2. Colors: White - Outer border, background and FIRE LANE letters

Red - Inner border, Prohibitive Symbol, and Arrow

Enclosure 2 – TOW-AWAY SIGNS

TOW-AWA

ZONE

Colors: White - Outer border and background
 Black - Inner border and TOW-AWAY ZONE

SPECIFICATIONS:

Black - Letter 'P'

4. Prohibitive symbol: 10-inch o.d.

5. Background for FIRE LANE: 3 inches in height 6. Arrow: Head: 2¼ inches in height Shaft: 1 inch in width, 14 inches in length

Note: Drawing NOT to scale. All graphics and lettering shall be center


Fire Lane signs shall be in accordance with Enclosure No.1 of this appendix. Tow-Away Zone signs shall be provided along with all approved Fire Lane signs, and shall in accordance with Enclosure No. 2 of this appendix. 3.7.3 Combining of signs.
Signs may be combined as one sign provided the requirements for the individual signs are

SECTION 3.7--- APPENDIX B

Fire Lane and Tow-Away Zone Sign Requirements

3.7.4 Construction of signs.Signs shall be constructed of durable, weather resistive materials and paints.

3.7.5 Positioning of signs.
Where Fire Lane signs are required, an approved Tow-Away Zone sign shall be attached to the same pole or column, immediately below and at the same angle of attachment as the Fire Lane Height of the signs shall be not less than 6 feet or more than 7 feet above the ground, as

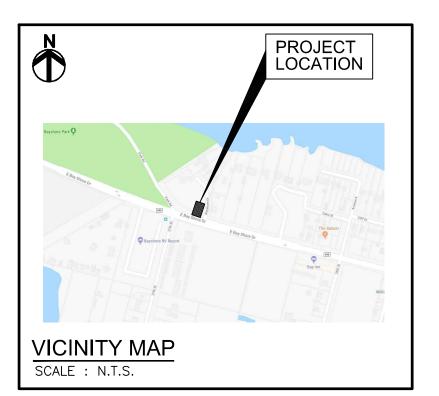

LEGAL DESCRIPTION

BOUNDARY AND TOPOGRAPHIC SURVEY LOTS 40 THROUGH 46, AND THE SOUTH 20 FEET OF LOT 39 IN BLOCK 13, SAN LEON TOWNSITE, GALVESTON COUNTY, TEXAS.

SURVEY WAS PROVIDED BY THE LAND SURVEY CO. LLC

(281) 338-4008

PARKING SCHEDULE PARKING PROVIDED CARS 9' X 19' 12 H.C. VAN 8' X 18' TOTAL PARKING:

FIRE SPRINKLER SYSTEM CONTRACTOR SHALL DESIGN AND INSTALL FIRE SPRINKLER SYSTEM AND SHALL OBTAIN SEPERATE PERMIT. IRRIGATION SPRINKLER SYSTEM CONTRACTOR SHALL DESIGN IRRIGATION SPRINKLER SYSTEM AND SHALL PROVIDE SEPARATE METER AND CONNECTION FROM EXISTING OBSTRUCTIONS TO THE PROPOSED DRIVEWAYS/SIDEWALKS (SIGNS, POLES, HYDRANTS, ETC.) SHALL BE REMOVED/RELOCATED.

GENERAL NOTES

ALL PLANTS SHALL BE FULL POT AND HEAD, SYMMETRICAL FOLIAGE AND BRANCHING STRUCTURE. CONTRACTOR SHALL LOCATE ALL UNDERGROUND UTILITIES PRIOR TO EXCAVATION OR TRENCHING, CONTRACTOR SHALL BE RESPONSIBLE FOR REPAIRING OR REPLACING ANY DAMAGE UTILITIES OR OTHER IMPROVEMENTS GRADE SURFACE TO ENSURE AREAS DRAIN AWAY FROM STRUCTURES AND PREVENT PONDING AND POCKETS OF SURFACE DRAINAGE SPREAD AND AVERAGE OF 1" SHARP SAND OVER ENTIRE AREA TO BE SOLID SODDED. HAND RAKE ENTIRE PRIOR TO SODDING, OBTAIN OWNER'S REPRESENTATIVE'S APPROVAL OF GRADE PRIOR TO SODDING. ALLOW FOR FINISHED GRADE AT EDGE OF WALKS AND CURBS TO BE A MINIMUM OF 1" TO 1 1/2" BELOW TOP OF SIDEWALK AND CURBS AREAS ALONG EDGE. LANDSCAPE CONTRACTOR TO COORDINATE AND SCHEDULE HIS WORK WITH OTHER CONTRACTORS WORKING ON THE PROJECT SITE. PROVIDE IRRIGATION SPRINKLERS AT ALL LANDSCAPING.

_									
			PLANT SCI	HEDUL	.E				
	QTY.	COMMON NAME	BOTANIC NAME	BOTANIC NAME SIZE REMARKS					
	2	SHUMARD OAK	QUERCUS SHUMARDII	3" CAL.	STRAIGHT SINGLE TRUNK FULL SYMMETRICAL HEAD 14'-16' HT. X 6'-7' SPREAD				
	30		NANDINA DOMESTICA NANA "PURPUREA"	7 GAL.	10" HT. X 15" MIN. SPREAD FULL POT, 2 YEAR PLANT 2'-0" O.C.				
	FULL		ATENDTAPHRUM SECUNDATUM		SOLID SOD GRASS				





SCALE : 1" = 20' - 0"

18-02-003

NEW LAWRENCE GROCERY


902 E. BAYSHORE, LEON, TEXAS 77539

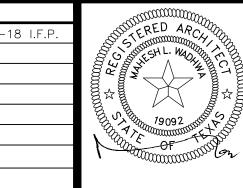

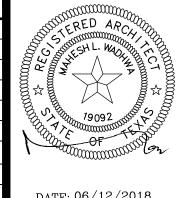




SHEET NO.

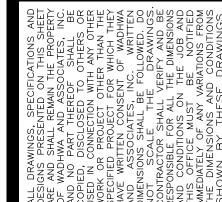


DRAWN: CHECKED:


DATE: JAN 2018

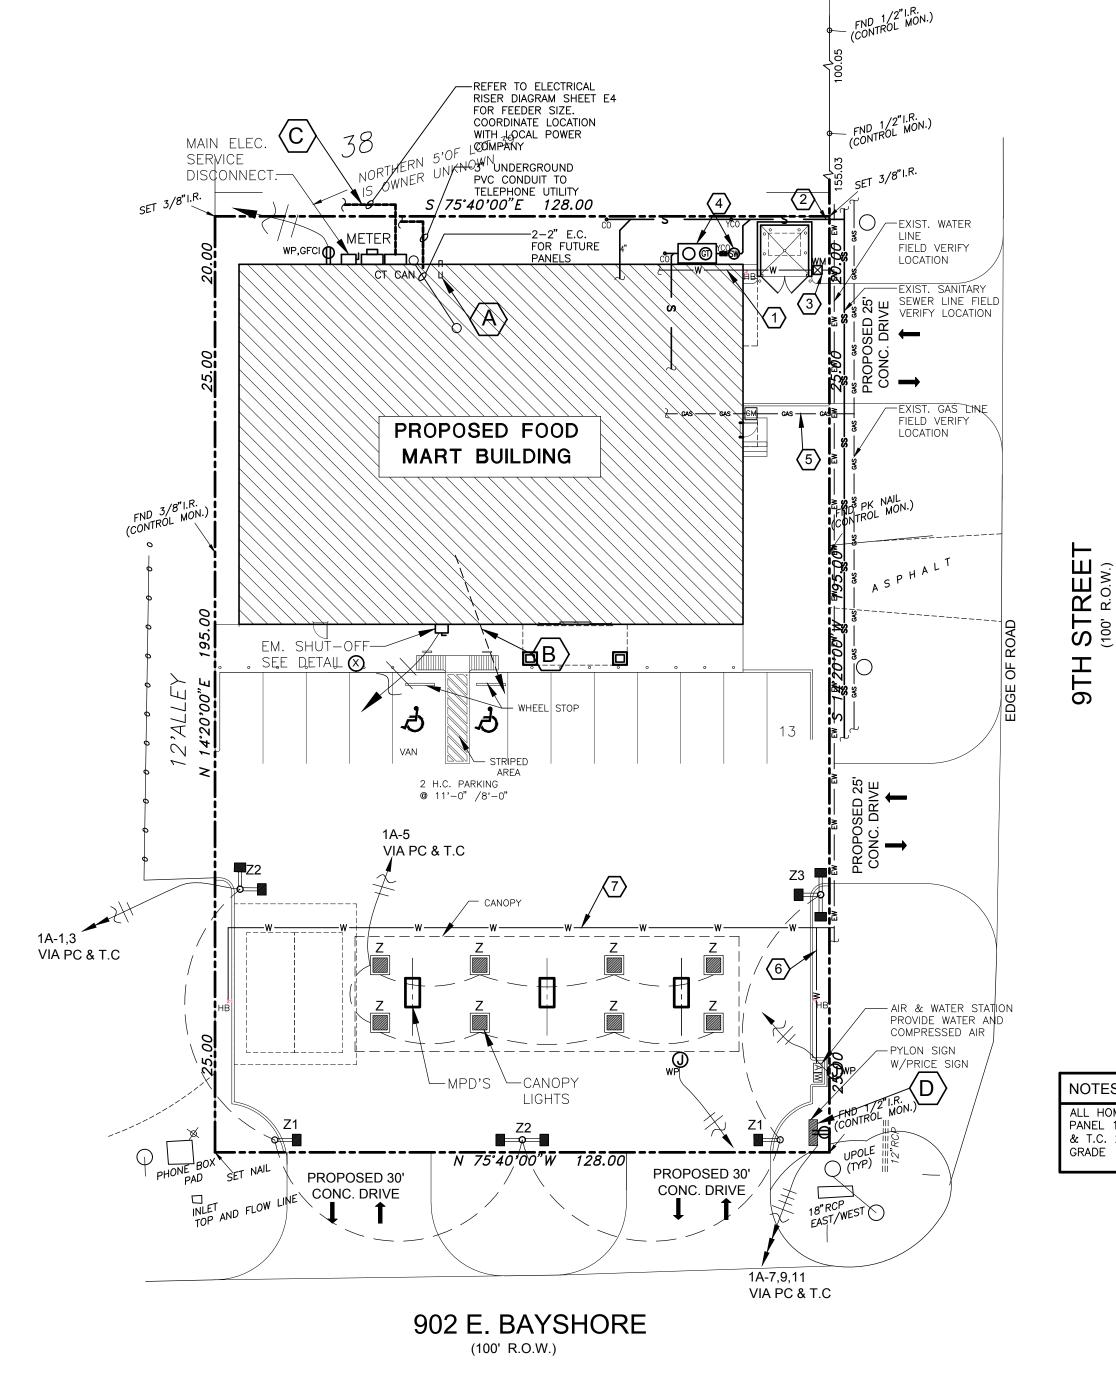

. O

NOTES ALL HOME RUNS TO PANEL 1A U.O.N. VIA PC & T.C. 2"C, 24" BELOW

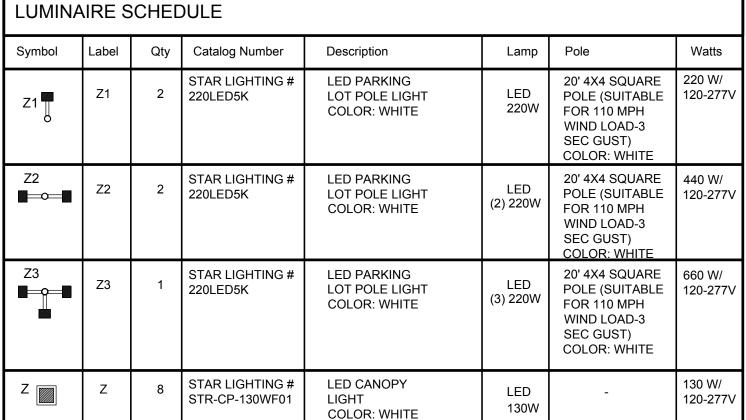

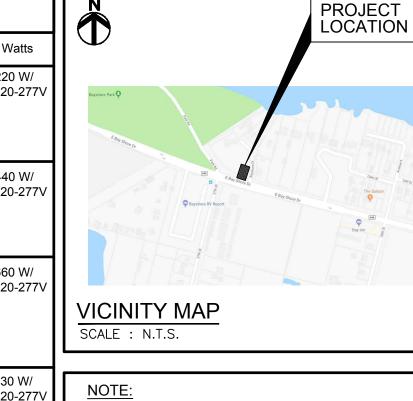

LEGEND

- SEE ELECTRICAL DRAWINGS FOR ADDITIONAL
- ELECTRICAL REQUIREMENTS. - SEE PLUMBING DRAWINGS FOR ADDITIONAL

PLUMBING REQUIREMENTS.

SEE MECHANICAL DRAWINGS FOR ADDITIONAL MECHANICAL REQUIREMENTS.

—SS——— EXISTING SANITARY SEWER LINE

GAS METER

WATER METER

ΦΦSCO SURFACE CLEAN OUT

CLEAN OUT

HOSE BIB


— EW —— EW —— EXISTING WATER LINE

KEYED NOTES

- $\langle 1 \rangle$ 2" C.W. FOR BLDG.
- 2) 4" SAN SWR CONNECT TO EXISTING SAN SEWER MAIN.
- 2" WATER METER IN APPROVED BOX W/ RPZ BACK FLOW PREVENTOR
- GREASE TRAP W/SAMPLE WELL, SEE PLUMBING DRAWINGS FOR DETAILS. 5) 3" GAS LINE. VERIFY AND COORDINATE LOCATION/DIRECTION WITH SERVICE
- $\langle 6 \rangle$ 1/2" C.W. FOR WATER STATION.

PROVIDER.

 $\langle 7 \rangle$ 3/4" C.W. FOR HOSE BIB

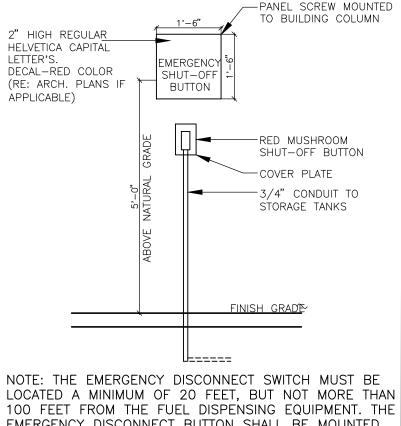

1/4"WHITE ACRYLIC

EMERGENCY DISCONNECT BUTTON SHALL BE MOUNTED ON THE NEAREST AVAILABLE SURFACE ON A FREE STANDING SUPPORT.

DETAIL-X

I. DIMENSION CONTROL PLAN (SP1) PREPARED BY WADHWA AND ASSOCIATES, INC.

. ALL UNDERGROUND UTILITIES SHOWN ARE NOT GUARANTEED TO BE COMPLETE

1. THE LOCATION OF ALL UTILITIES PRESENTED ON THESE DRAWINGS ARE SHOWN

IN AN APPROXIMATE WAY ONLY. THE CONTRACTOR SHALL DETERMINE THE EXACT

LOCATION BEFORE COMMENCING WORK. HE AGREES TO BE FULLY RESPONSIBLE

FOR ANY AND ALL DAMAGES WHICH MIGHT BE OCCASIONED BY HIS FAILURE TO

. CONTRACTOR TO OBTAIN ALL PERMITS AND APPROVALS REQUIRED PRIOR TO

OR DEFINITE. BUT WERE OBTAINED FROM THE BEST INFORMATION AVAILABLE.

3. CONTRACTOR TO VERIFY ALL UNDERGROUND UTILITIES IN THE FIELD PRIOR

EXACTLY LOCATE AND PRESERVE THESE UNDERGROUND UTILITIES.

STARTING CONSTRUCTION OF UTILITIES OR WORK IN THE CITY STREET

TO BE USED IN CONJUNCTION WITH THIS PLAN FOR LOCATING ALL IMPROVEMENTS.

GENERAL CONSTRUCTION NOTES:

GENERAL CONSTRUCTION NOTES:

FOR DIMENSIONS SEE SITE PLAN (SP1) PREPARED BY WADHWA AND ASSOCIATES, INC. AND TO BE USED IN CONJUNCTION WITH THIS PLAN FOR LOCATING ALL IMPROVEMENTS.

Фсо

BE COMPLETE OR DEFINITE. BUT WERE OBTAINED FROM THE BEST INFORMATION AVAILABLE. CONTRACTOR TO VERIFY ALL UNDERGROUND UTILITIES IN THE

ALL UNDERGROUND UTILITIES SHOWN ARE NOT GUARANTEED TO

- FIELD PRIOR TO CONSTRUCTION.
- THE LOCATION OF ALL UTILITIES PRESENTED ON THESE DRAWINGS ARE SHOWN IN AN APPROXIMATE WAY ONLY. THE CONTRACTOR SHALL DETERMINE THE EXACT LOCATION BEFORE COMMENCING WORK. HE AGREES TO BE FULLY RESPONSIBLE FOR ANY AND ALL DAMAGES WHICH MIGHT BE OCCASIONED BY HIS FAILURE TO EXACTLY LOCATE AND PRESERVE THESE UNDERGROUND UTILITIES
- CONTRACTOR TO OBTAIN ALL PERMITS AND APPROVALS REQUIRED PRIOR TO STARTING CONSTRUCTION OF UTILITIES OR WORK IN THE CITY STREET RIGHT-OF-WAY.



TO CONSTRUCTION.

₩P,GFCI OUTLET WEATHER PROOF ELEC.

JUNCTION BOX

DISCONNECT SWITCH.

(SEE ELEC. DRGS. FOR ADDITIONAL LEGEND AND FIRE ALARM SYMBOLS)

KEYED NOTES:

A 1" PVC STUB FOR IRRIGATION CONTROL ELECTRICAL.

- B ONE (1) 4" CONDUIT OUT TO PROPERTY LINE AS DIRECTED BY LOCAL TELEPHONE UTILITY.
- © U/G ELECTRICAL SERVICE FROM UTILITY COMPANY. COORDINATE WITH UTILITY COMPANY.
- PROVIDE POWER FOR PRICE SIGN.



SCALE : 1" = 20' - 0"


DRAWN:

CHECKED:

DATE: JAN 2018


NEW LAWRENCE GROCERY


902 E. BAYSHORE, LEON, TEXAS 77539

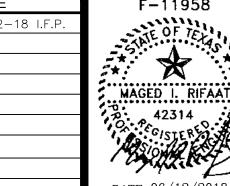






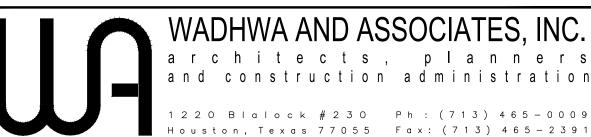


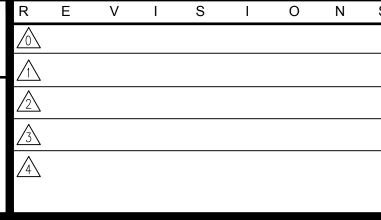



JOB NO. 18-02-003 SHEET NO.




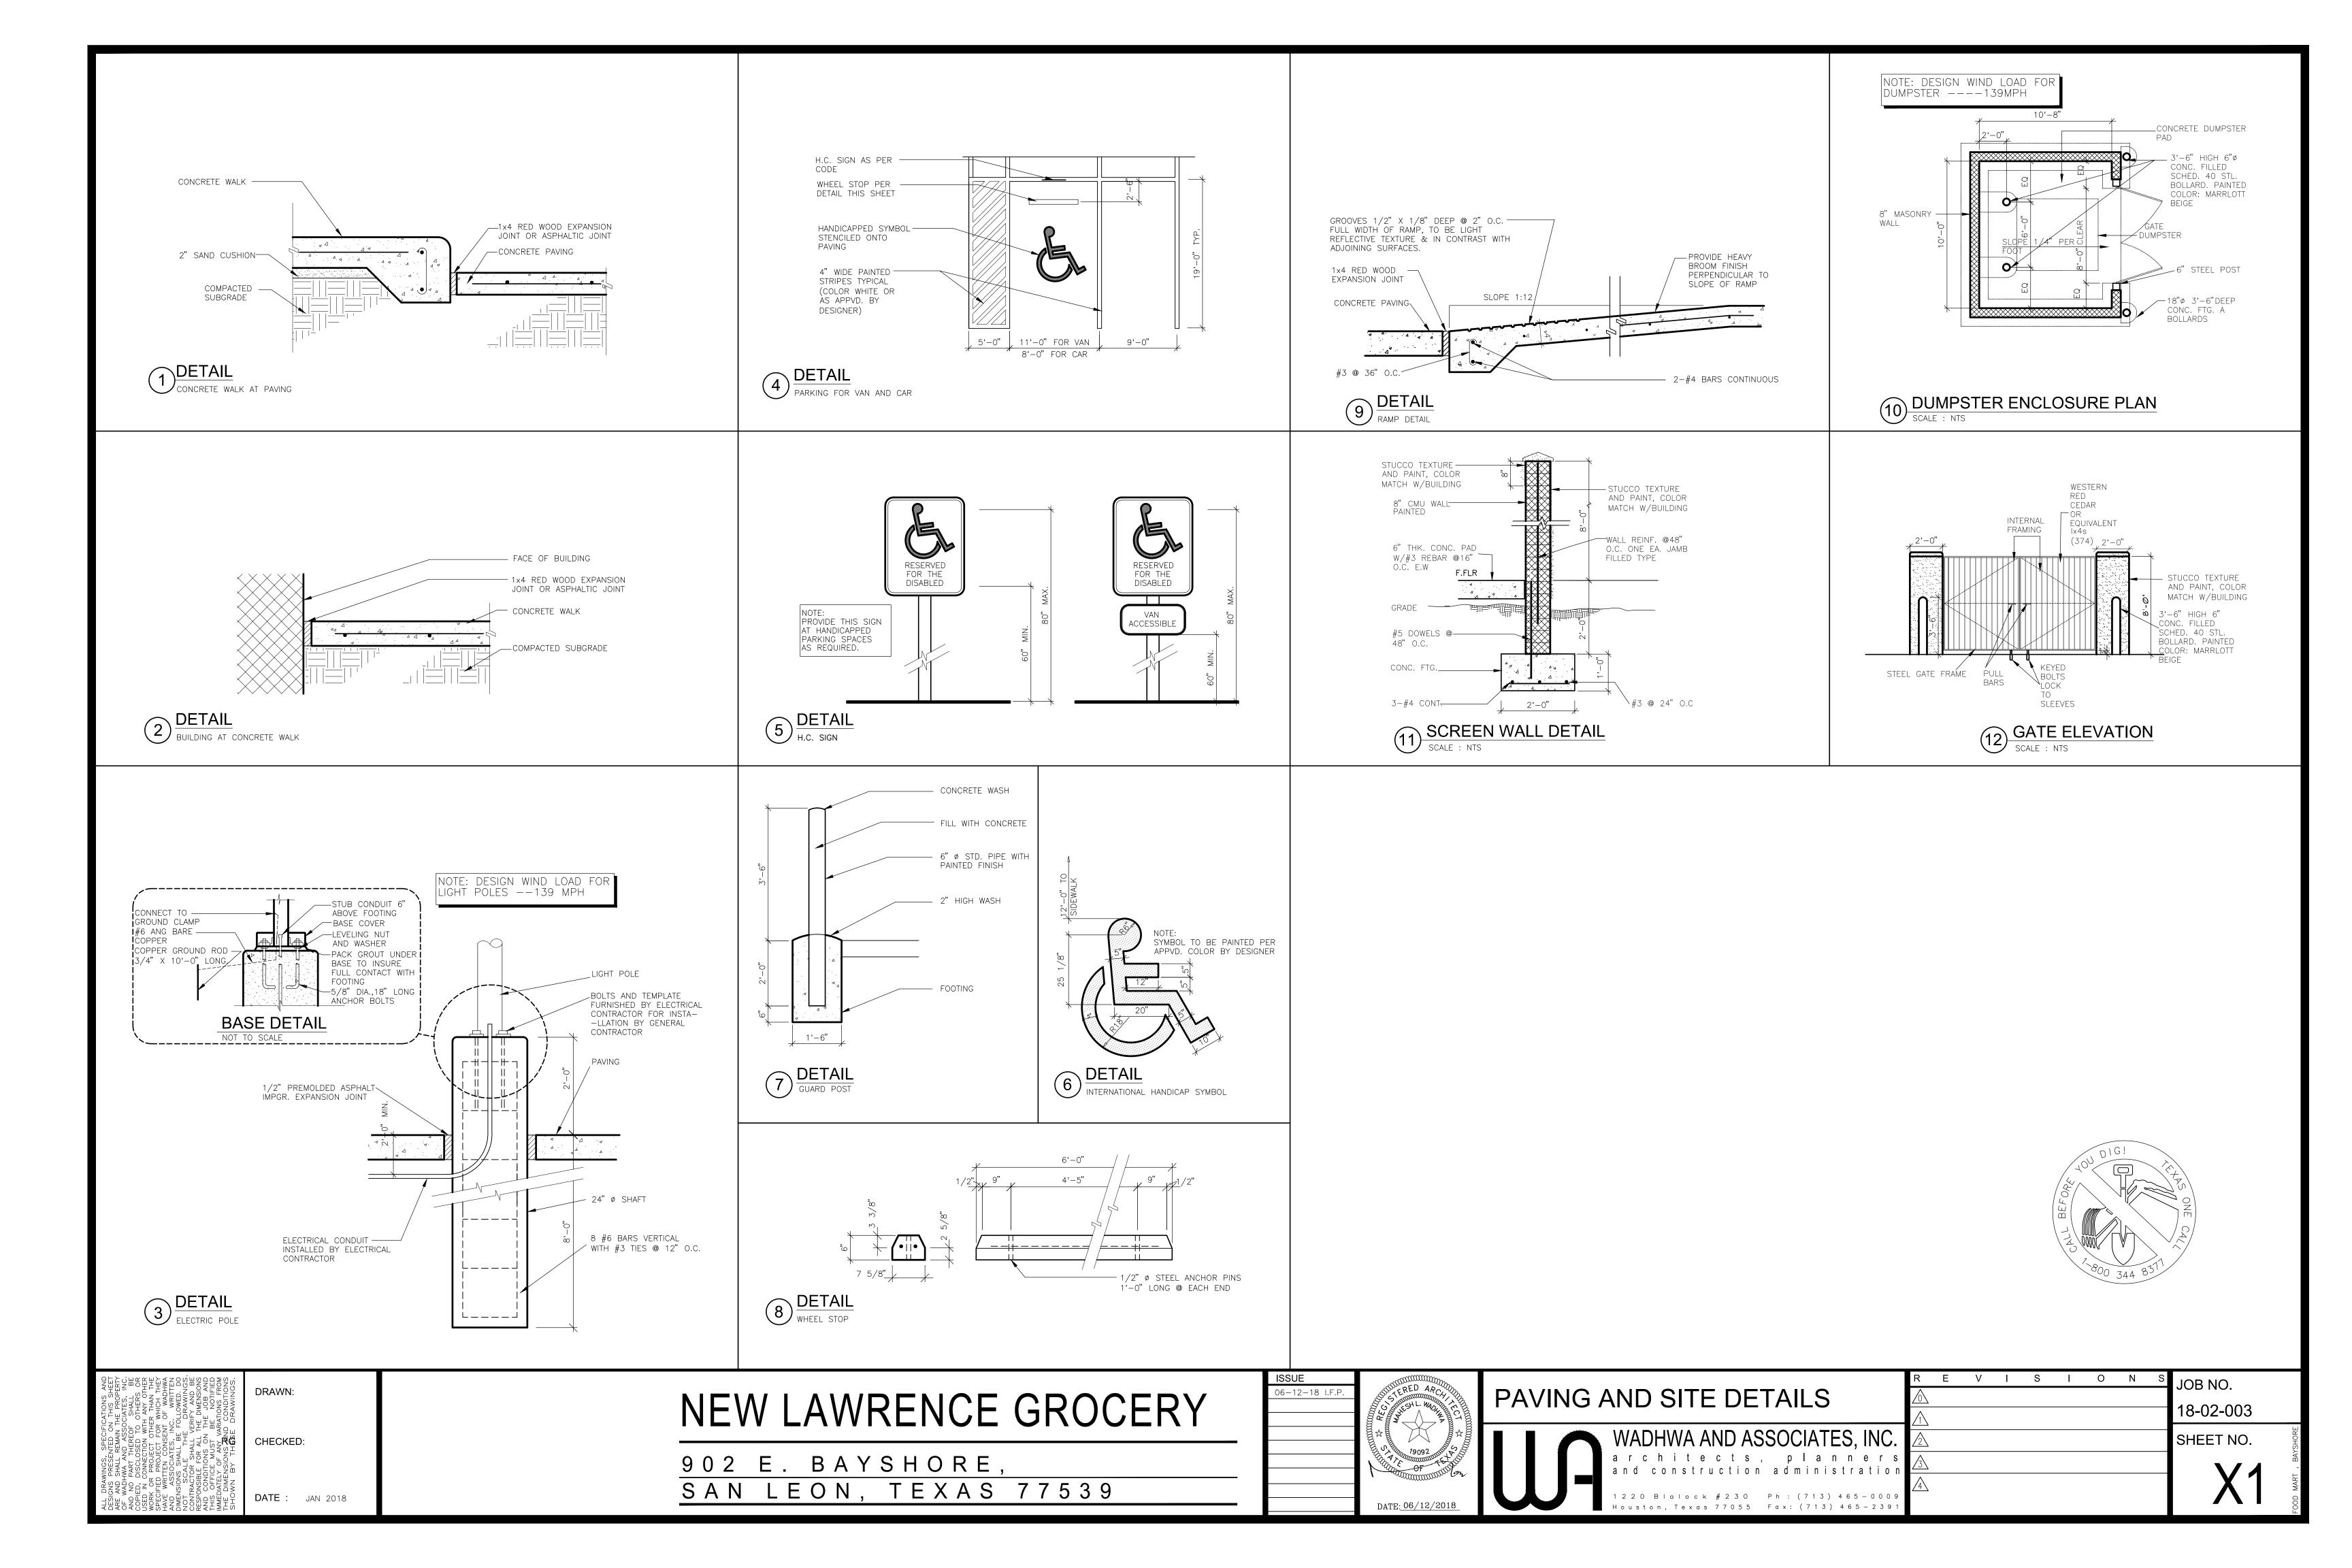


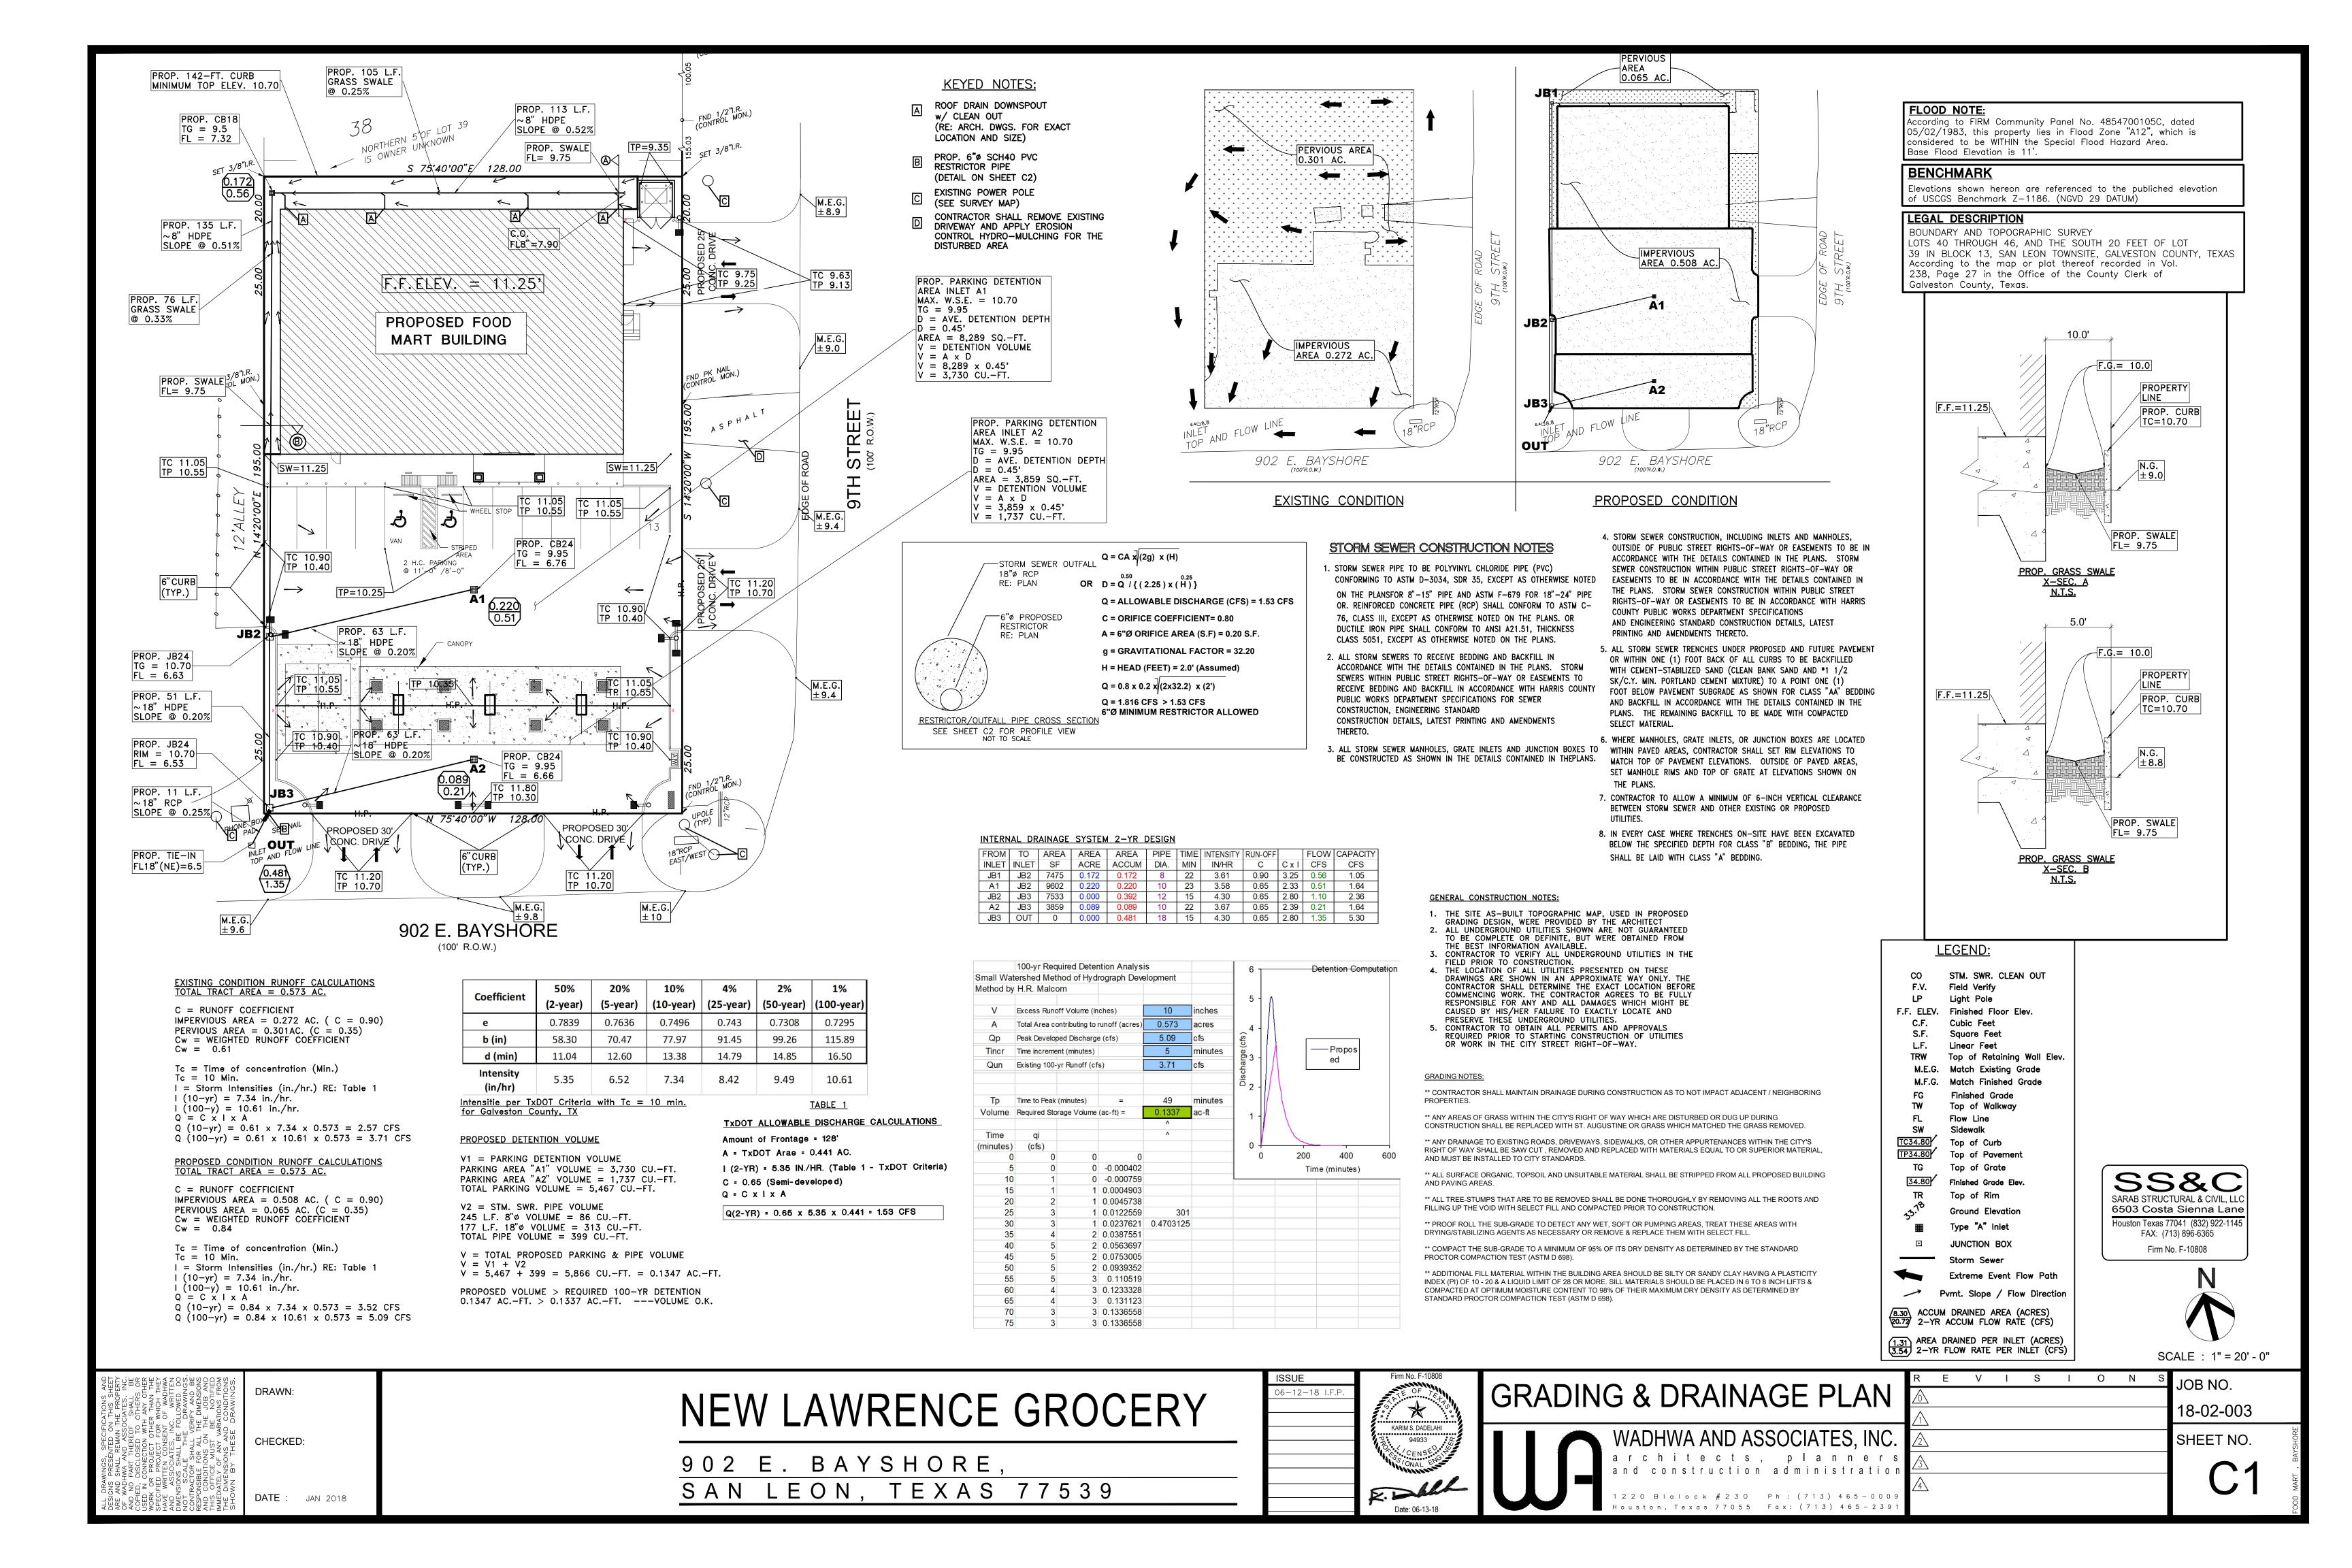

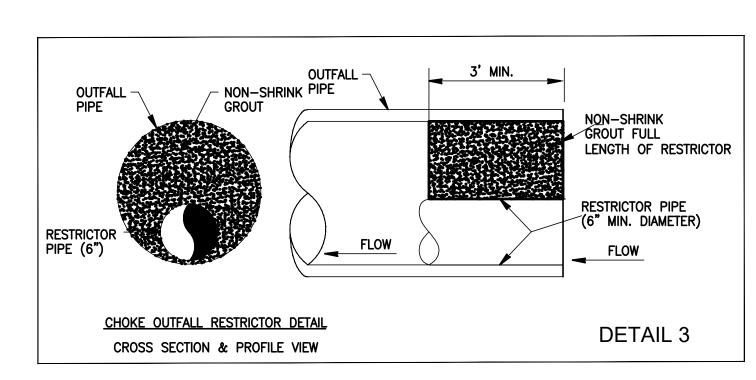


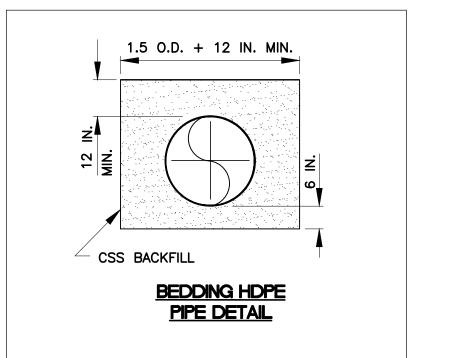


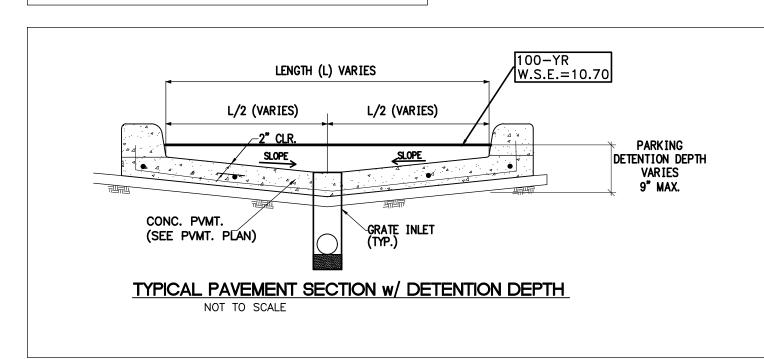


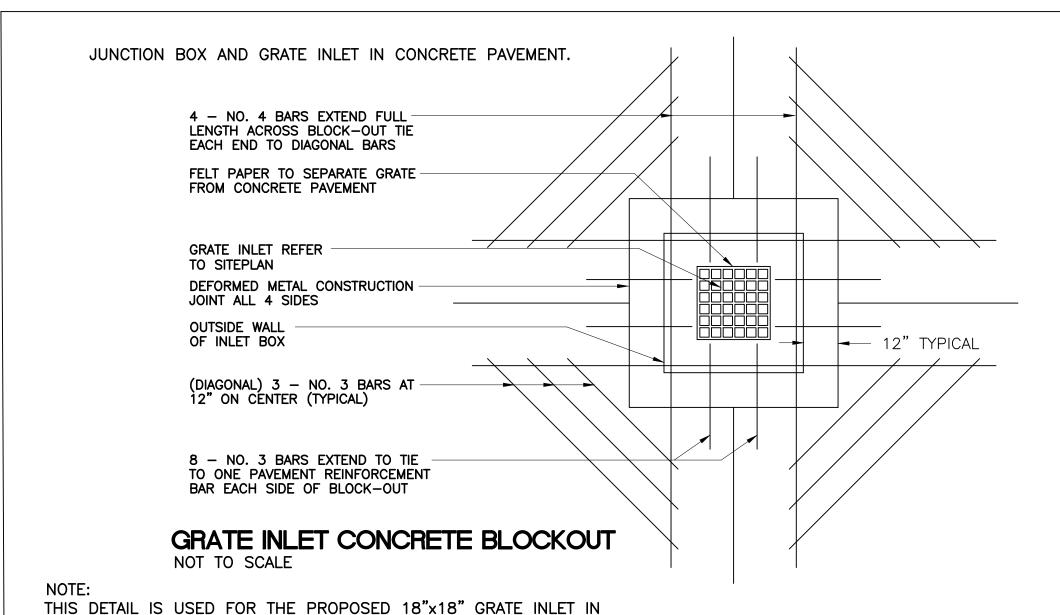

THE DUMPSTER ENCLOSURE AREA.

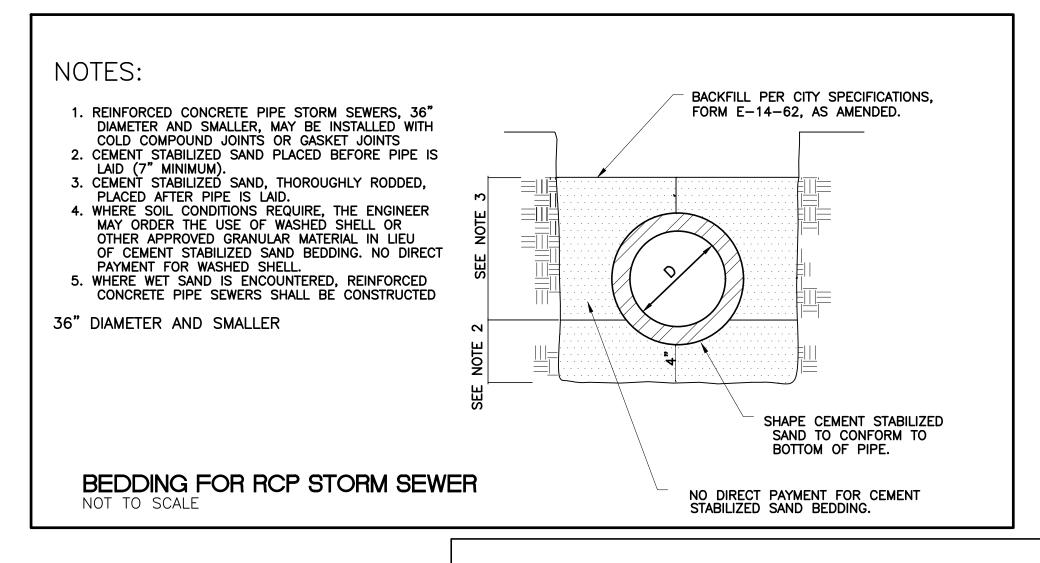

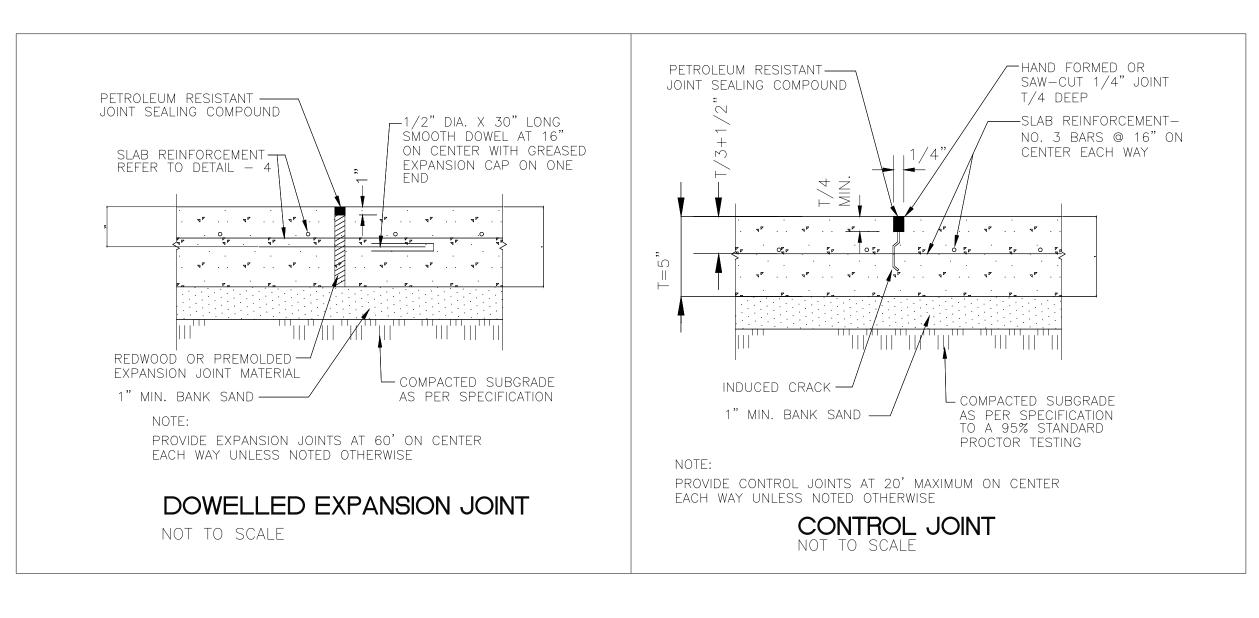


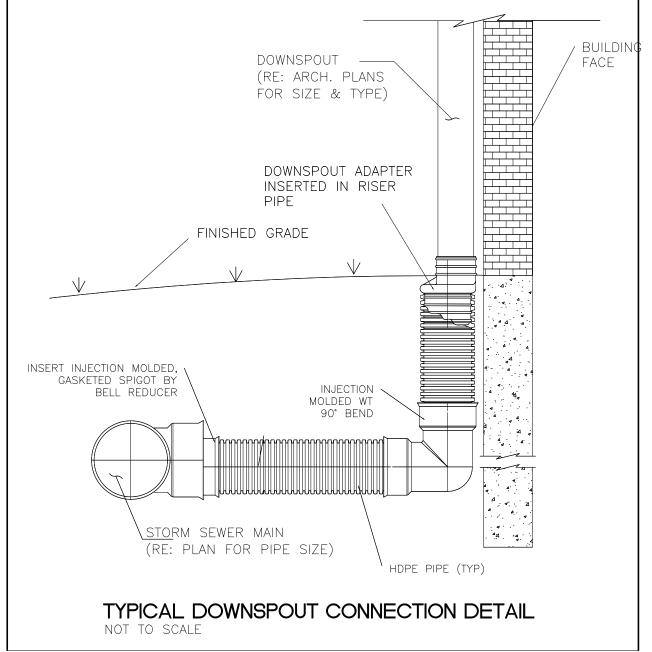

CLASS 1 CONCRETE WITH OF DESIGN STRENGTH OF 4500 PSI AT 28 DAYS. UNIT IS OF MONOLITHIC CONSTRUCTION AT FLOOR AND FIRST STAGE OF

WALL WITH SECTIONAL RISER TO REQUIRED DEPTH. REINFORCEMENT: GRADE 60 REINFORCED. STEEL REBAR CONFORMING TO ASTM A615 ON REQUIRED CENTERS OR EQUAL. C.I. CASTINGS: CAST IRON FRAMES AND GRATES ARE MANUFACTURED

OF GREY CAST IRON CONFORMING TO ASTM A48-76

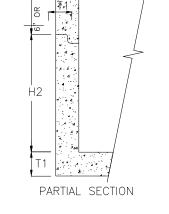


CATCHBASIN WITH DEBRI SCREEN MODEL CBS

MOD	EL #	DIMENSIONS											
CATCH BASIN	JUNCTION BOX ²	W1	W2	H1	H2	T1	KO	GRATE SIZE	WEIGHT LBS				
CB12 ¹	JB12	15"	10"	21"	18"	2"	10"	12"x12"x1"	180				
CB18	JB18	24"	16"	34"	30"	4"	15"	18"x18"x1½"	1,000				
CB20	JB20	26"	18"	34"	30"	4"	17"	20"x20"x1½"	1,335				
CB24	JB24	32"	22"	41"	36"	5"	22"	24"x24"x2"	2,245				
CB27	JB27	37"	25"	42"	36"	6"	24"	27"x27"x2"	2,875				
CB30	JB30	42"	30"	42"	36"	6"	30"	32"x32"x2"	3,675				
CB36	JB36	48"	36"	42"	36"	6"	32"	38"x38"x2"	4,585				

1. CB12 CATCHBASIN IS RATED FOR PEDESTRIAN LOADING. ALL OTHERS ARE TRAFFIC DUTY. 2. ALL JUNCTION BOXES ARE STANDARD PEDESTRIAN DUTY OR OPTIONAL TRAFFIC DUTY.

TYPE-A GRATE INLET 36" THRU 84" DWG. NO. CBTA3684


MODEL #	DIMENSIONS												
CATCH BASIN	W1	W2	H1	Н2	T1	KO	GRATE SIZE	WEIGHT LBS					
CBTA36	48"	36"	42"	36"	6"	36"	30"x30"	4,585					
CBTA48	60"	48"	54"	48"	6"	48"	30"x30"	8,900					
CBTA60	72"	60"	66"	60"	6"	60"	30"x30"	13,650					
CBTA72	84"	72"	78"	72"	6"	72"	30"x30"	19,000					
CBTA84	96"	83"	78"	72"	6"	84"	30"x30"	23,000					

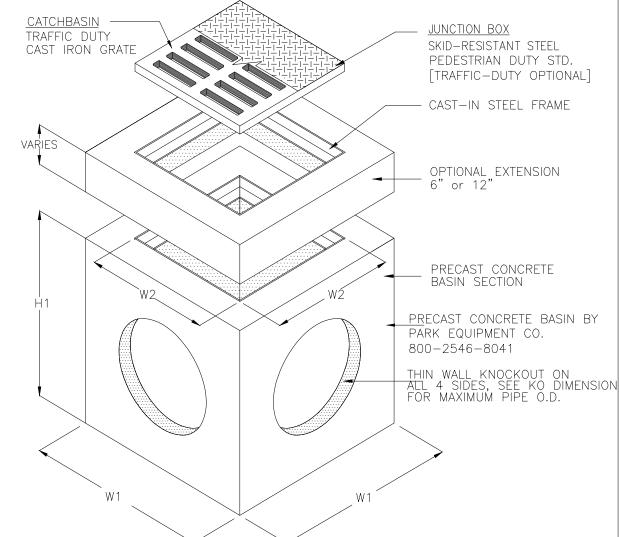


PRECAST CONCRETE CATCHBASIN/JUNCTION BOX

PARK ENVIRONMENTAL EQUIPMENT 888-611-PARK WWW.PARK-USA.COM NOT TO SCALE


GRATE INLET JUNCTION BOX

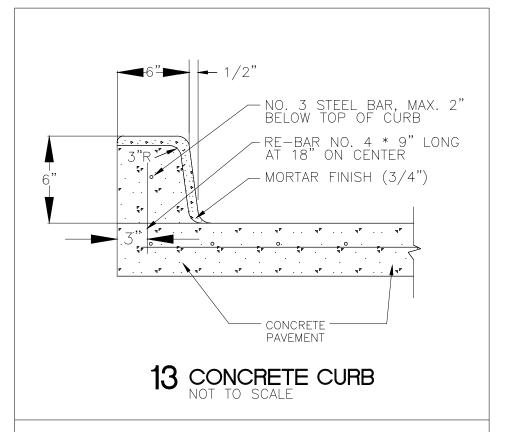

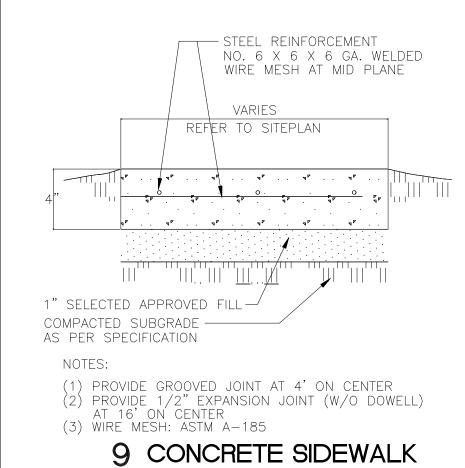

NOT TO SCALE

SS&C 6503 Costa Sienna Lane Houston Texas 77041 (832) 922-1145 FAX: (713) 896-6365 Firm No. F-10808

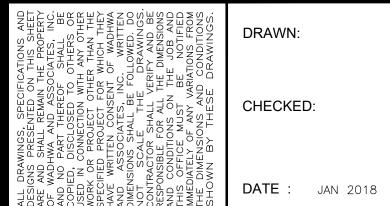

NEW LAWRENCE GROCERY

902 E. BAYSHORE, LEON, TEXAS 77539







STANDARD DETAILS


WADHWA AND ASSOCIATES, INC. and construction administratio $1\ 2\ 2\ 0\quad B\ I\ a\ I\ o\ c\ k\quad \#\ 2\ 3\ 0\qquad P\ h\ :\ (\ 7\ 1\ 3\)\ 4\ 6\ 5\ -\ 0\ 0\ 0\ 9$


Houston, Texas 77055 Fax: (713) 465-239

V I S I O N 18-02-003 SHEET NO.

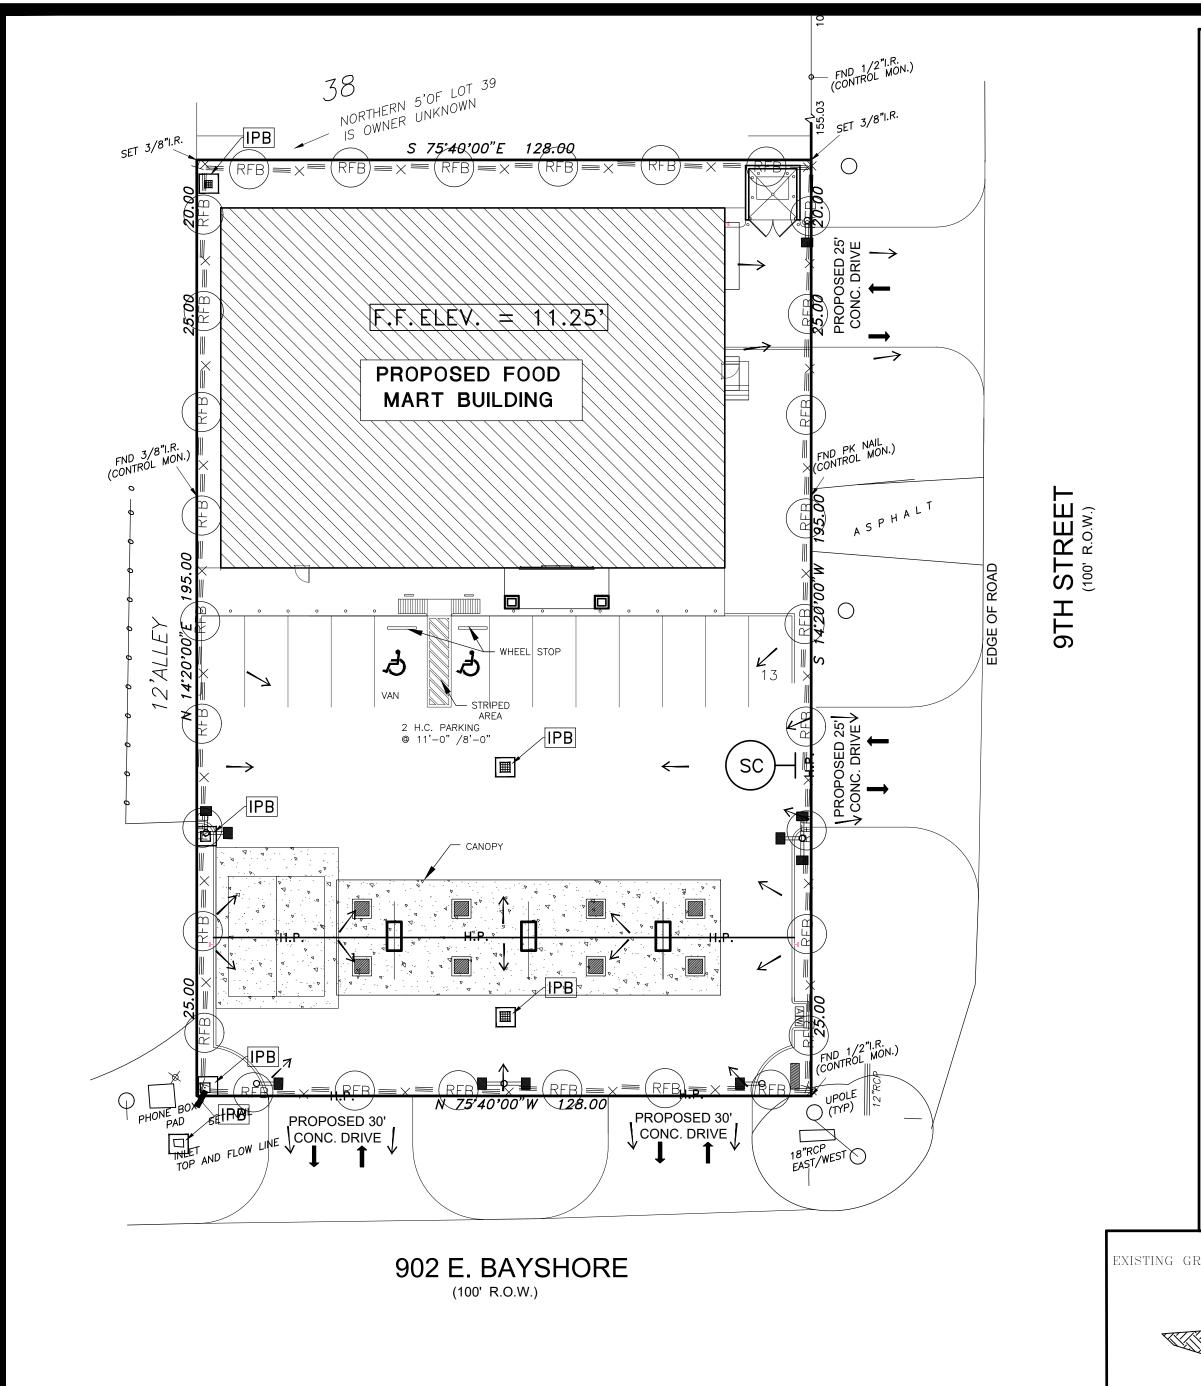


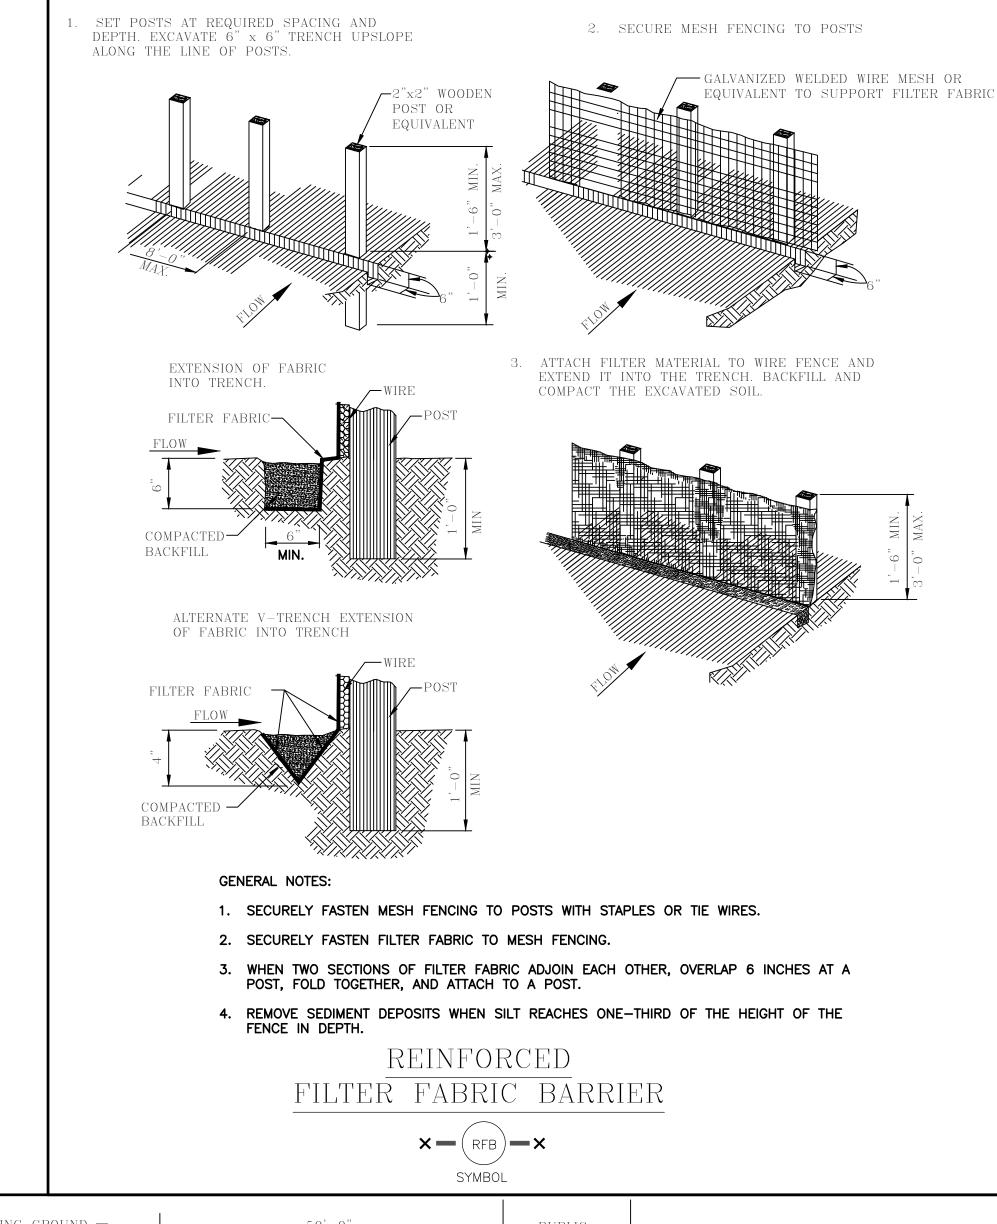

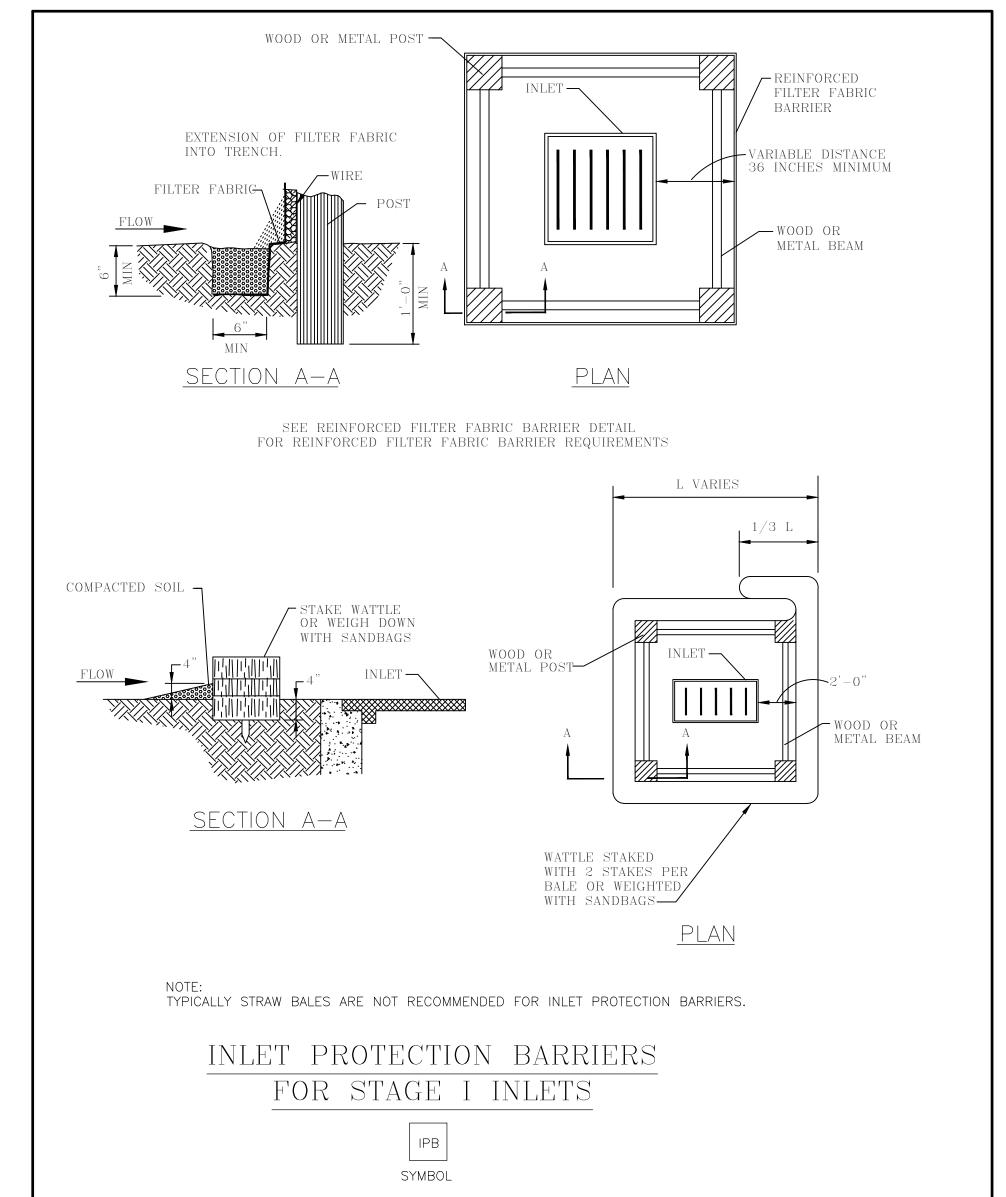


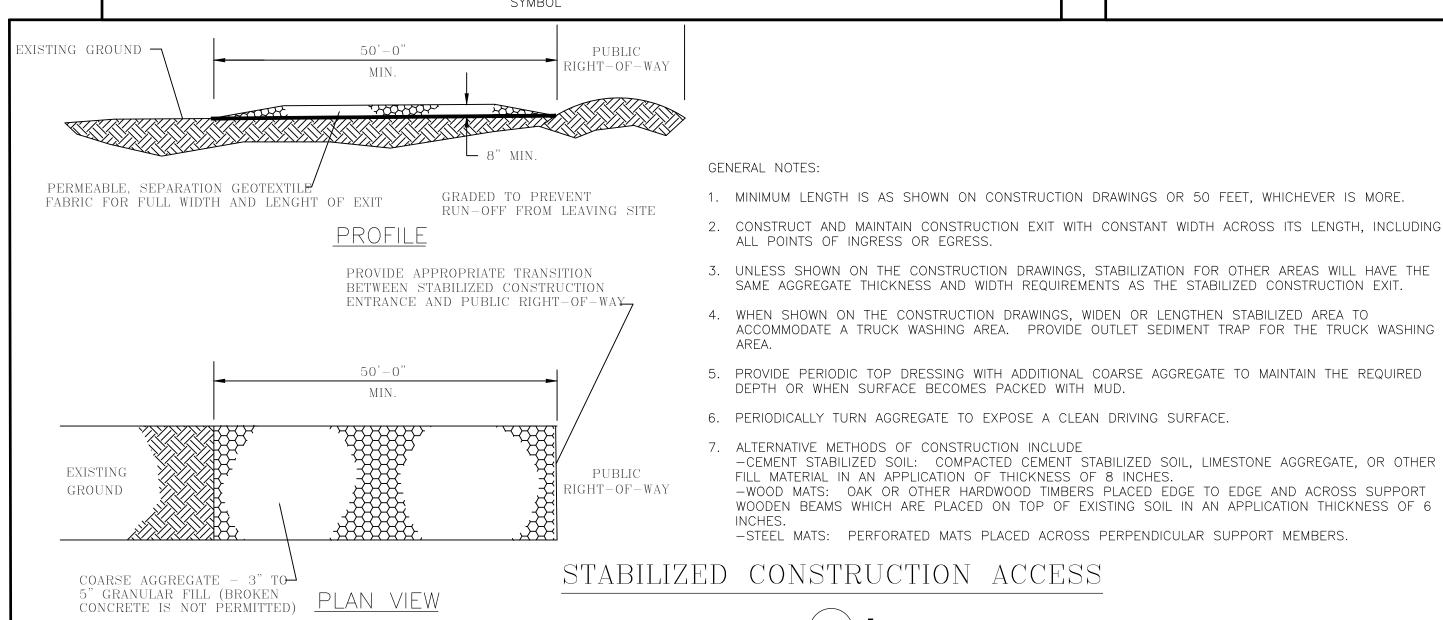



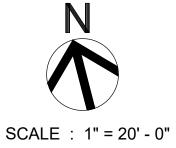



STORM WATER POLLUTION PREVENTION PLAN (SW3P)

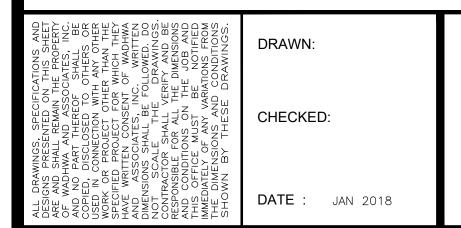



NEW LAWRENCE GROCERY


902 E. BAYSHORE, SAN LEON, TEXAS 77539

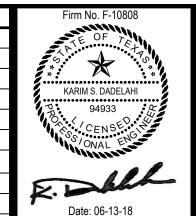


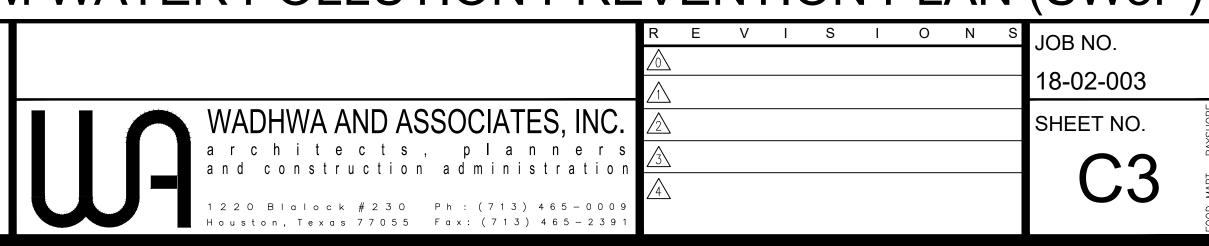


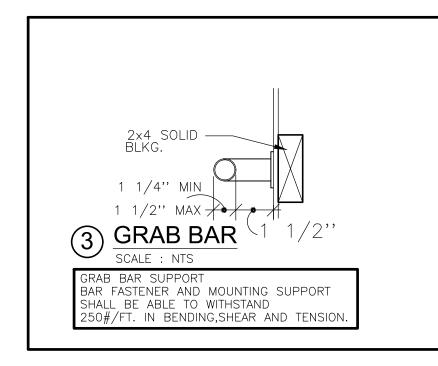

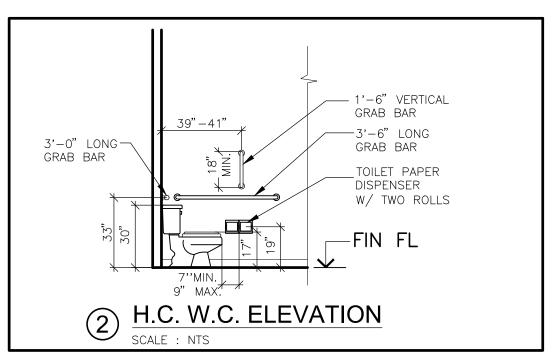

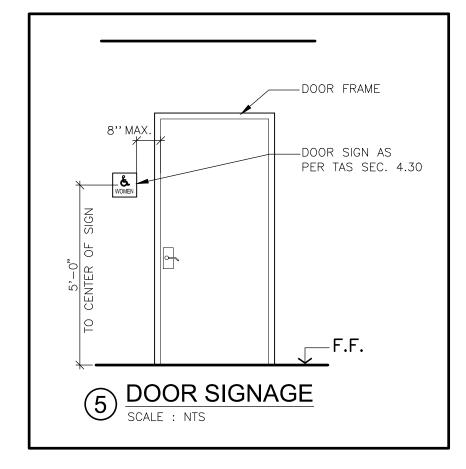

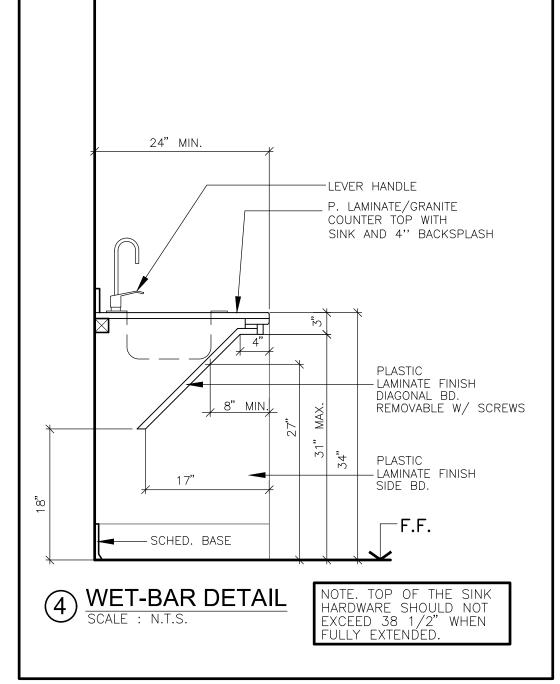


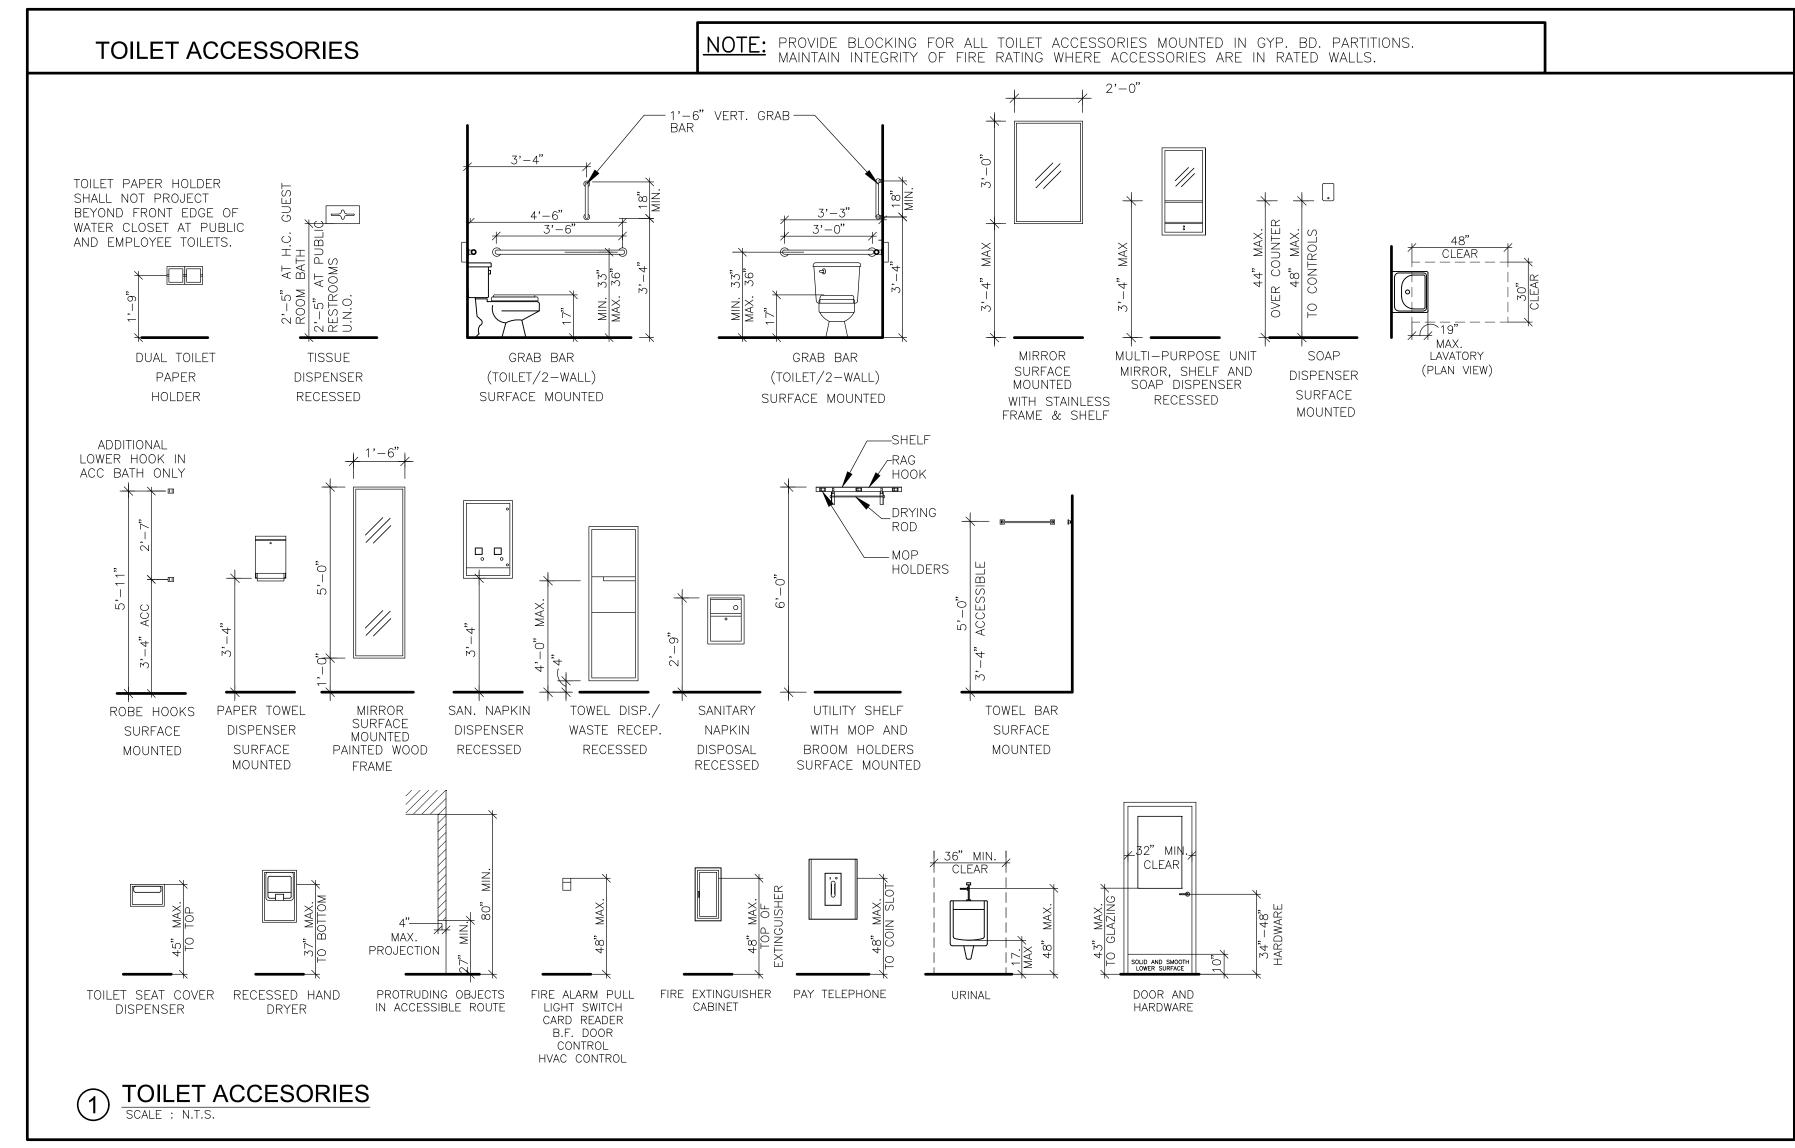

H.C. SIGNAGE NOTES:


40.30.2 CHARACTER PROPORTION LETTERS AND NUMBERS ON SIGNS SHALL HAVE A WIDTH-TO-HEIGHT RATIO
BETWEEN 3:5 AND 1:1 AND A STROKE-WIDTH-TO-HEIGHT RATIO BETWEEN 1:5 AND 1:10
USING AN UPPER-CASE "X" FOR MEASUREMENT. LOWER CASE LETTERS ARE PERMITTED. 40.30.4 RAISED AND BRAILLE CHARACTERS AND PICTORIAL SYMBOLS SIGNS (PICTOGRAMS) LETTERS AND NUMERALS SHALL BE RAISED 1/32", UPPER CASE, SANS SERIF OR SIMPLE SERIF TYPE AND SHALL BE ACCOMPANIED WITH GRADE 2 BRAILLE. RAISED CHARACTERS SHALL BE AT LEAST 5/8" (16mm) HIGH, BUT NO HIGHER THAN 2" (50mm). PICTOGRAMS SHALL BE ACCOMPANIED BY THE EQUIVALENT VERBAL DESCRIPTION PLACED DIRECTLY BELOW THE PICTOGRAM. THE BORDER DIMENSION OF THE PICTOGRAMS SHALL BE 6" (152mm) MINIMUM IN HEIGHT.


SCALE : N.T.S.

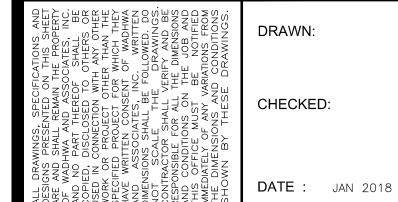

NEW LAWRENCE GROCERY


902 E. BAYSHORE, LEON, TEXAS 77539

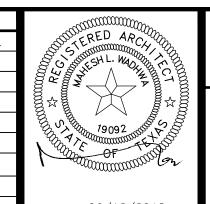


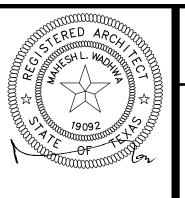




V I S I O N 18-02-003 SHEET NO.

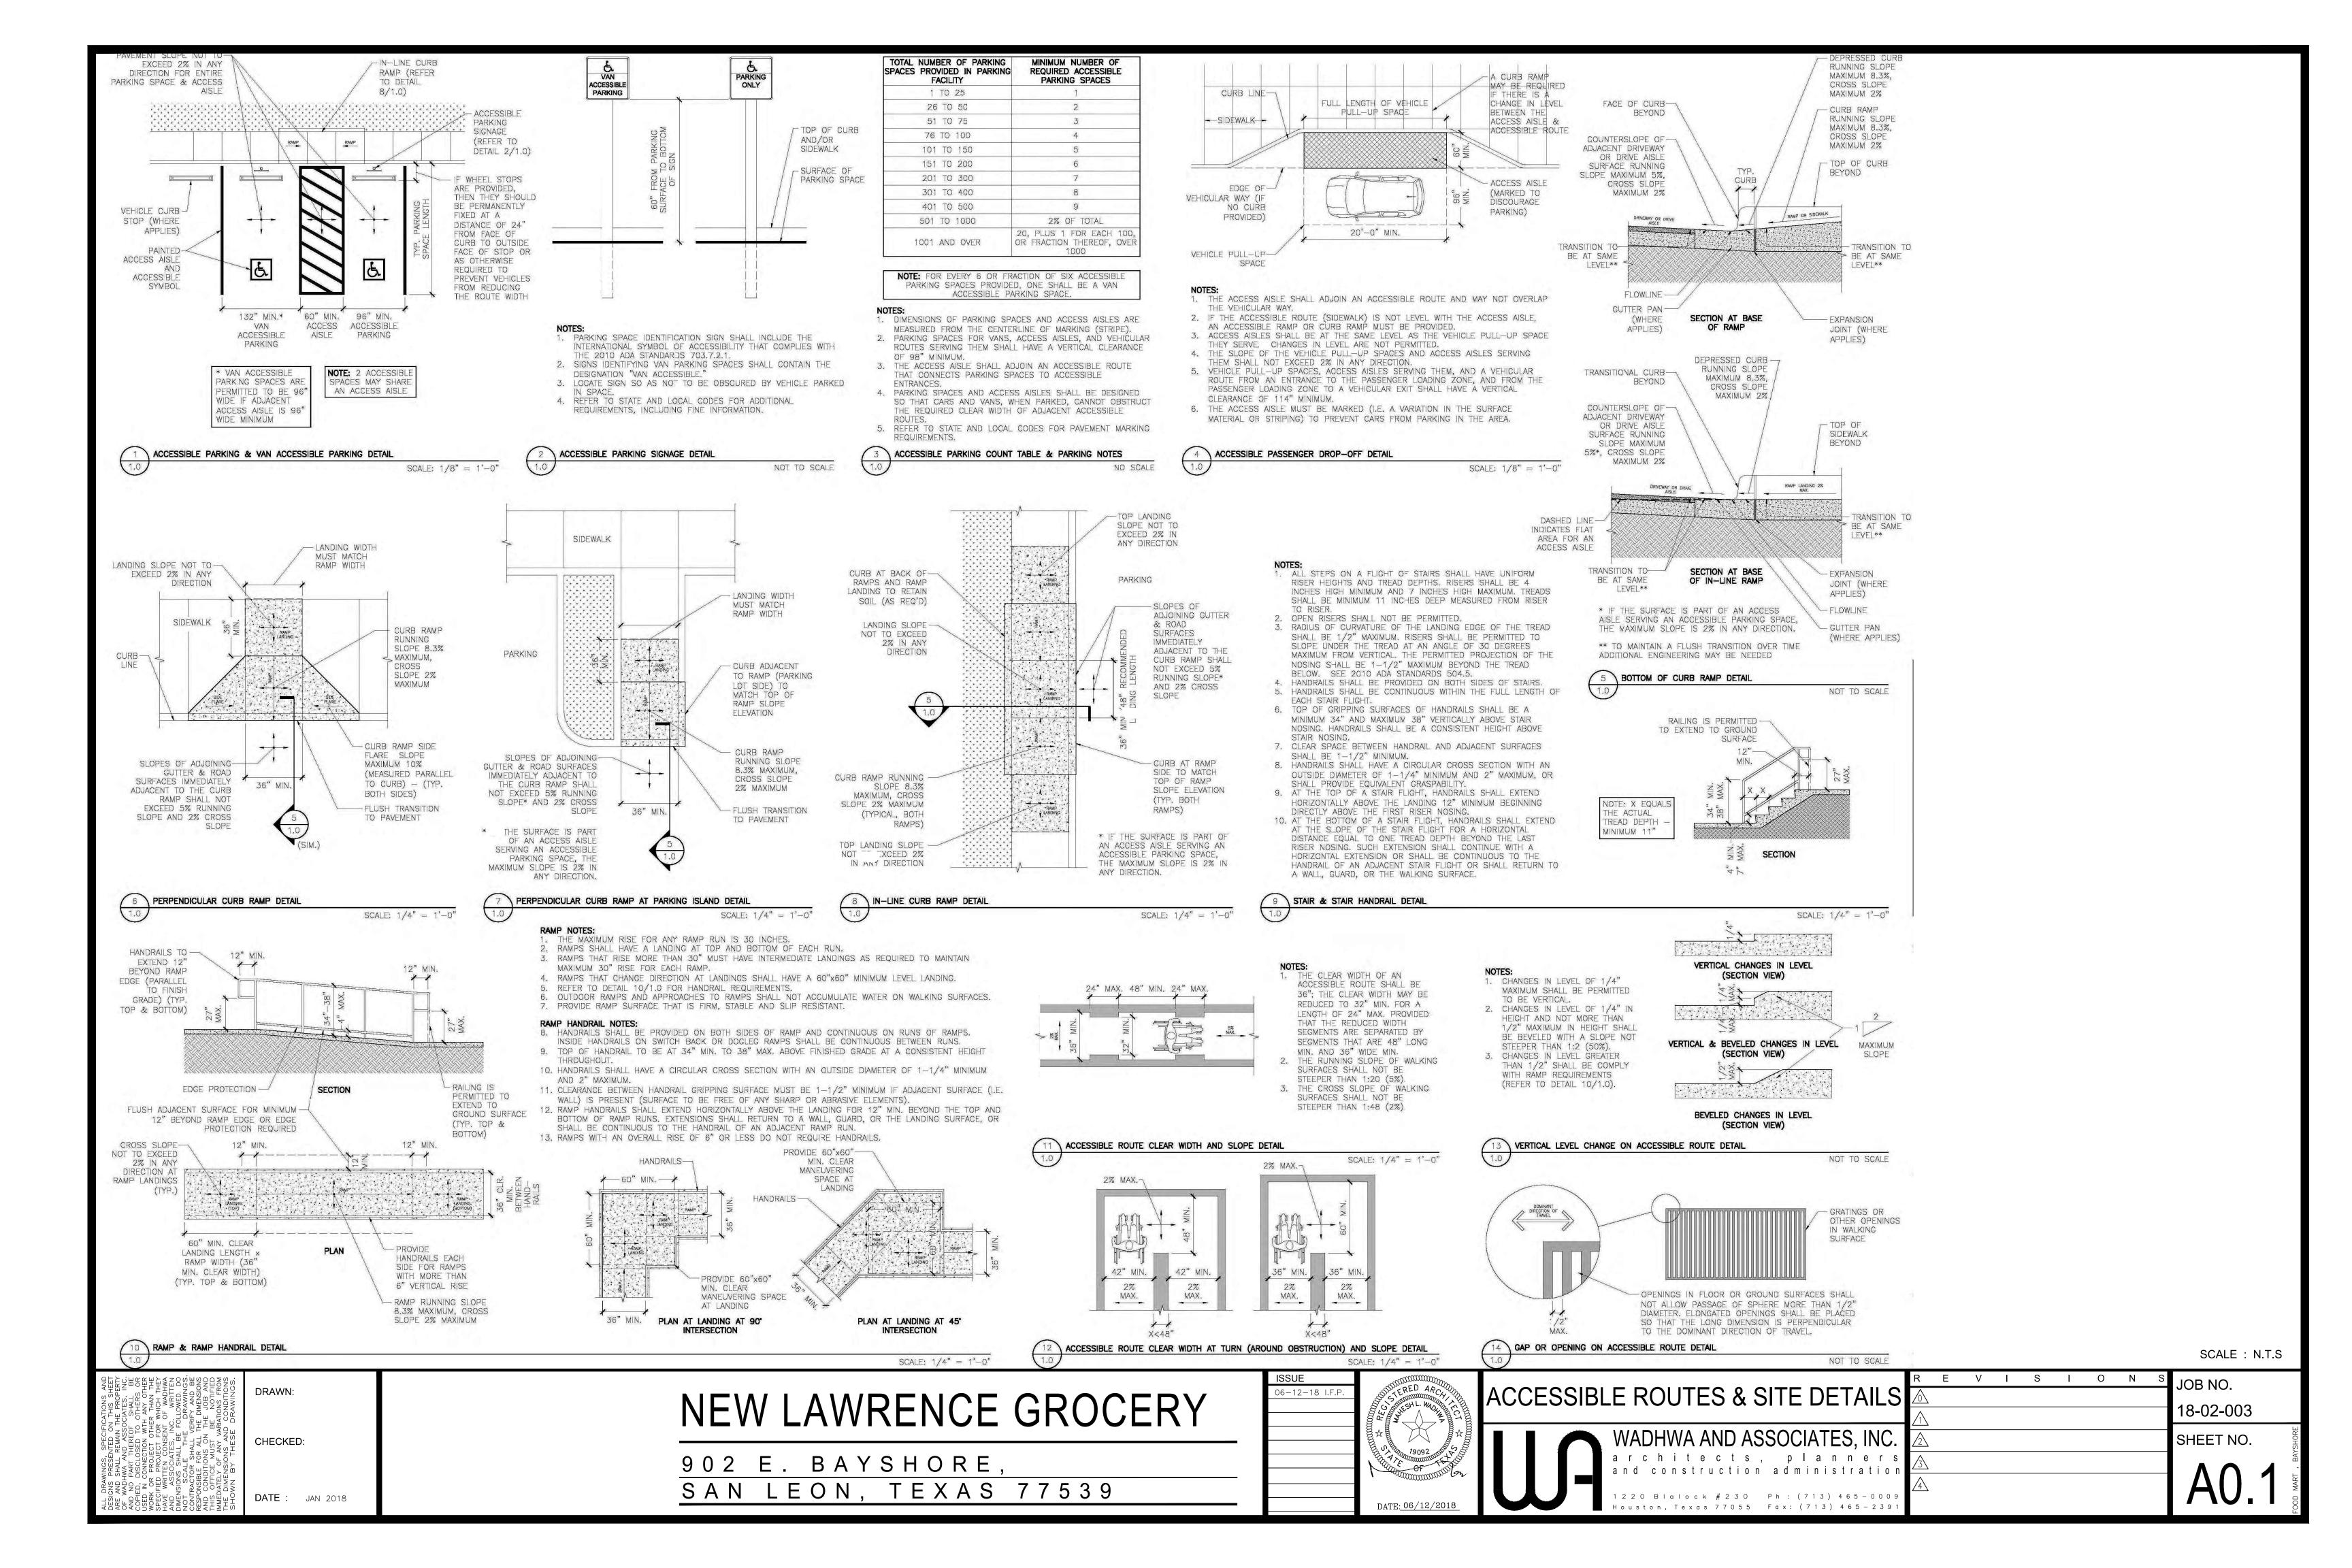

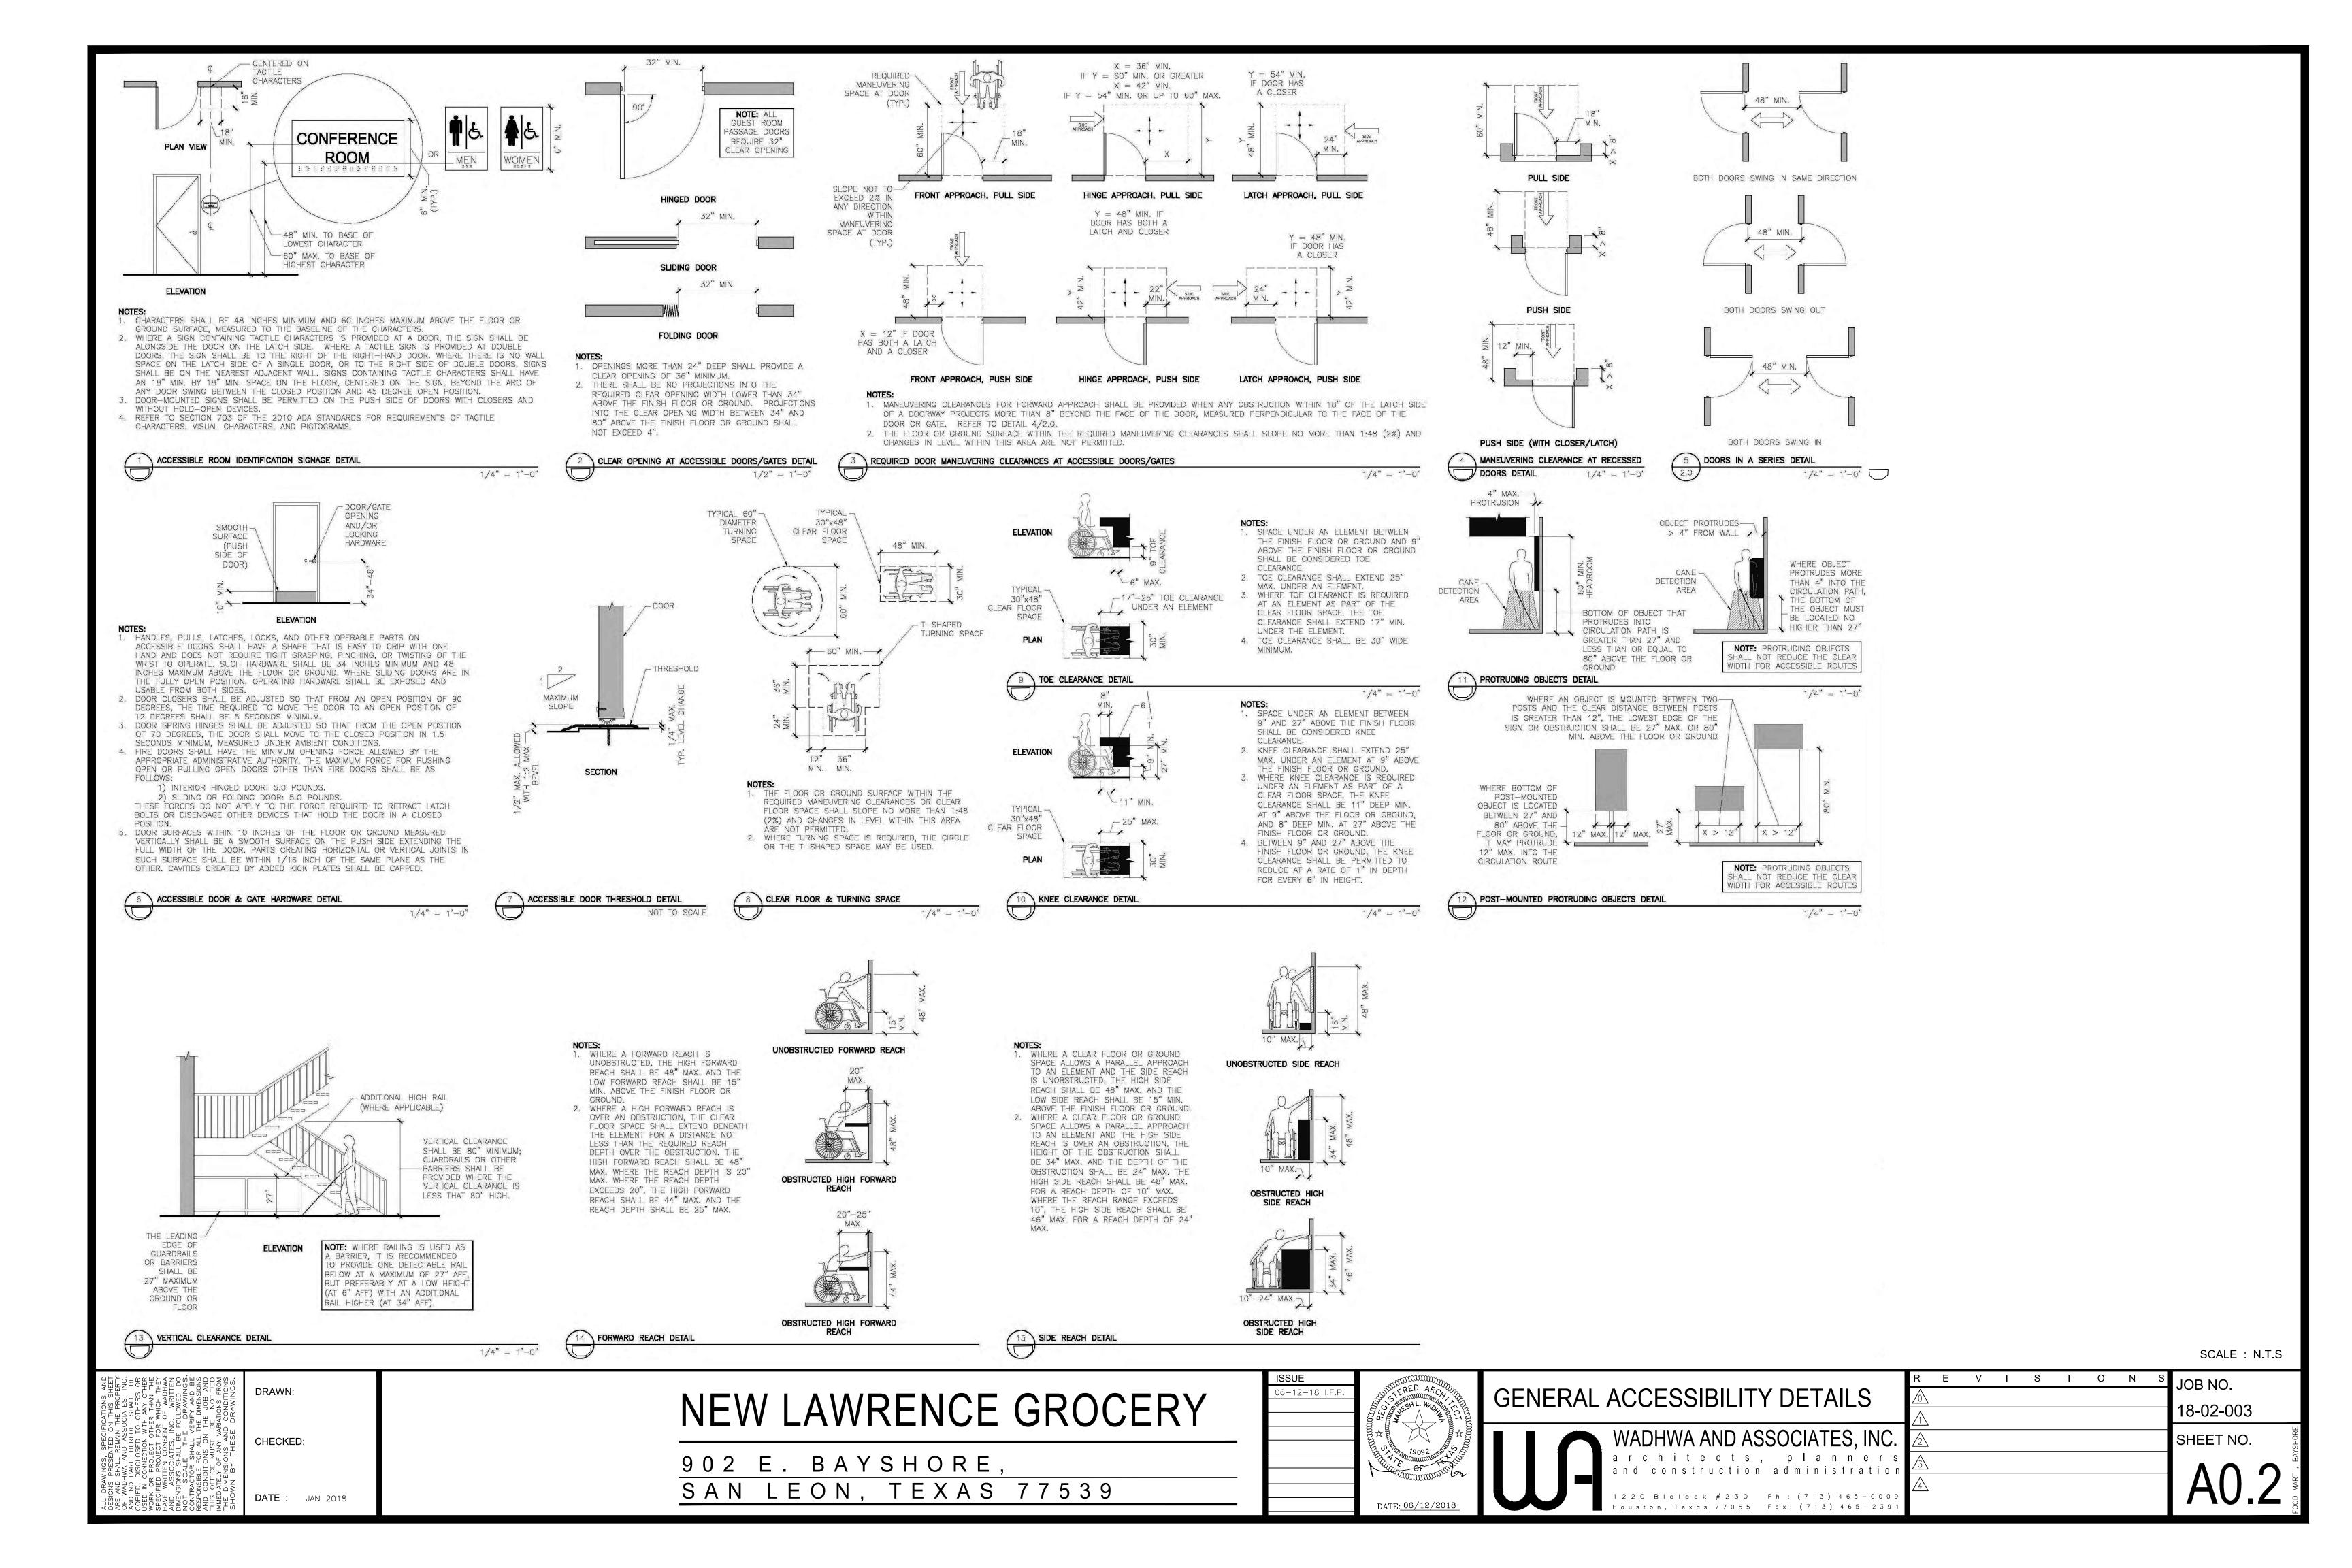

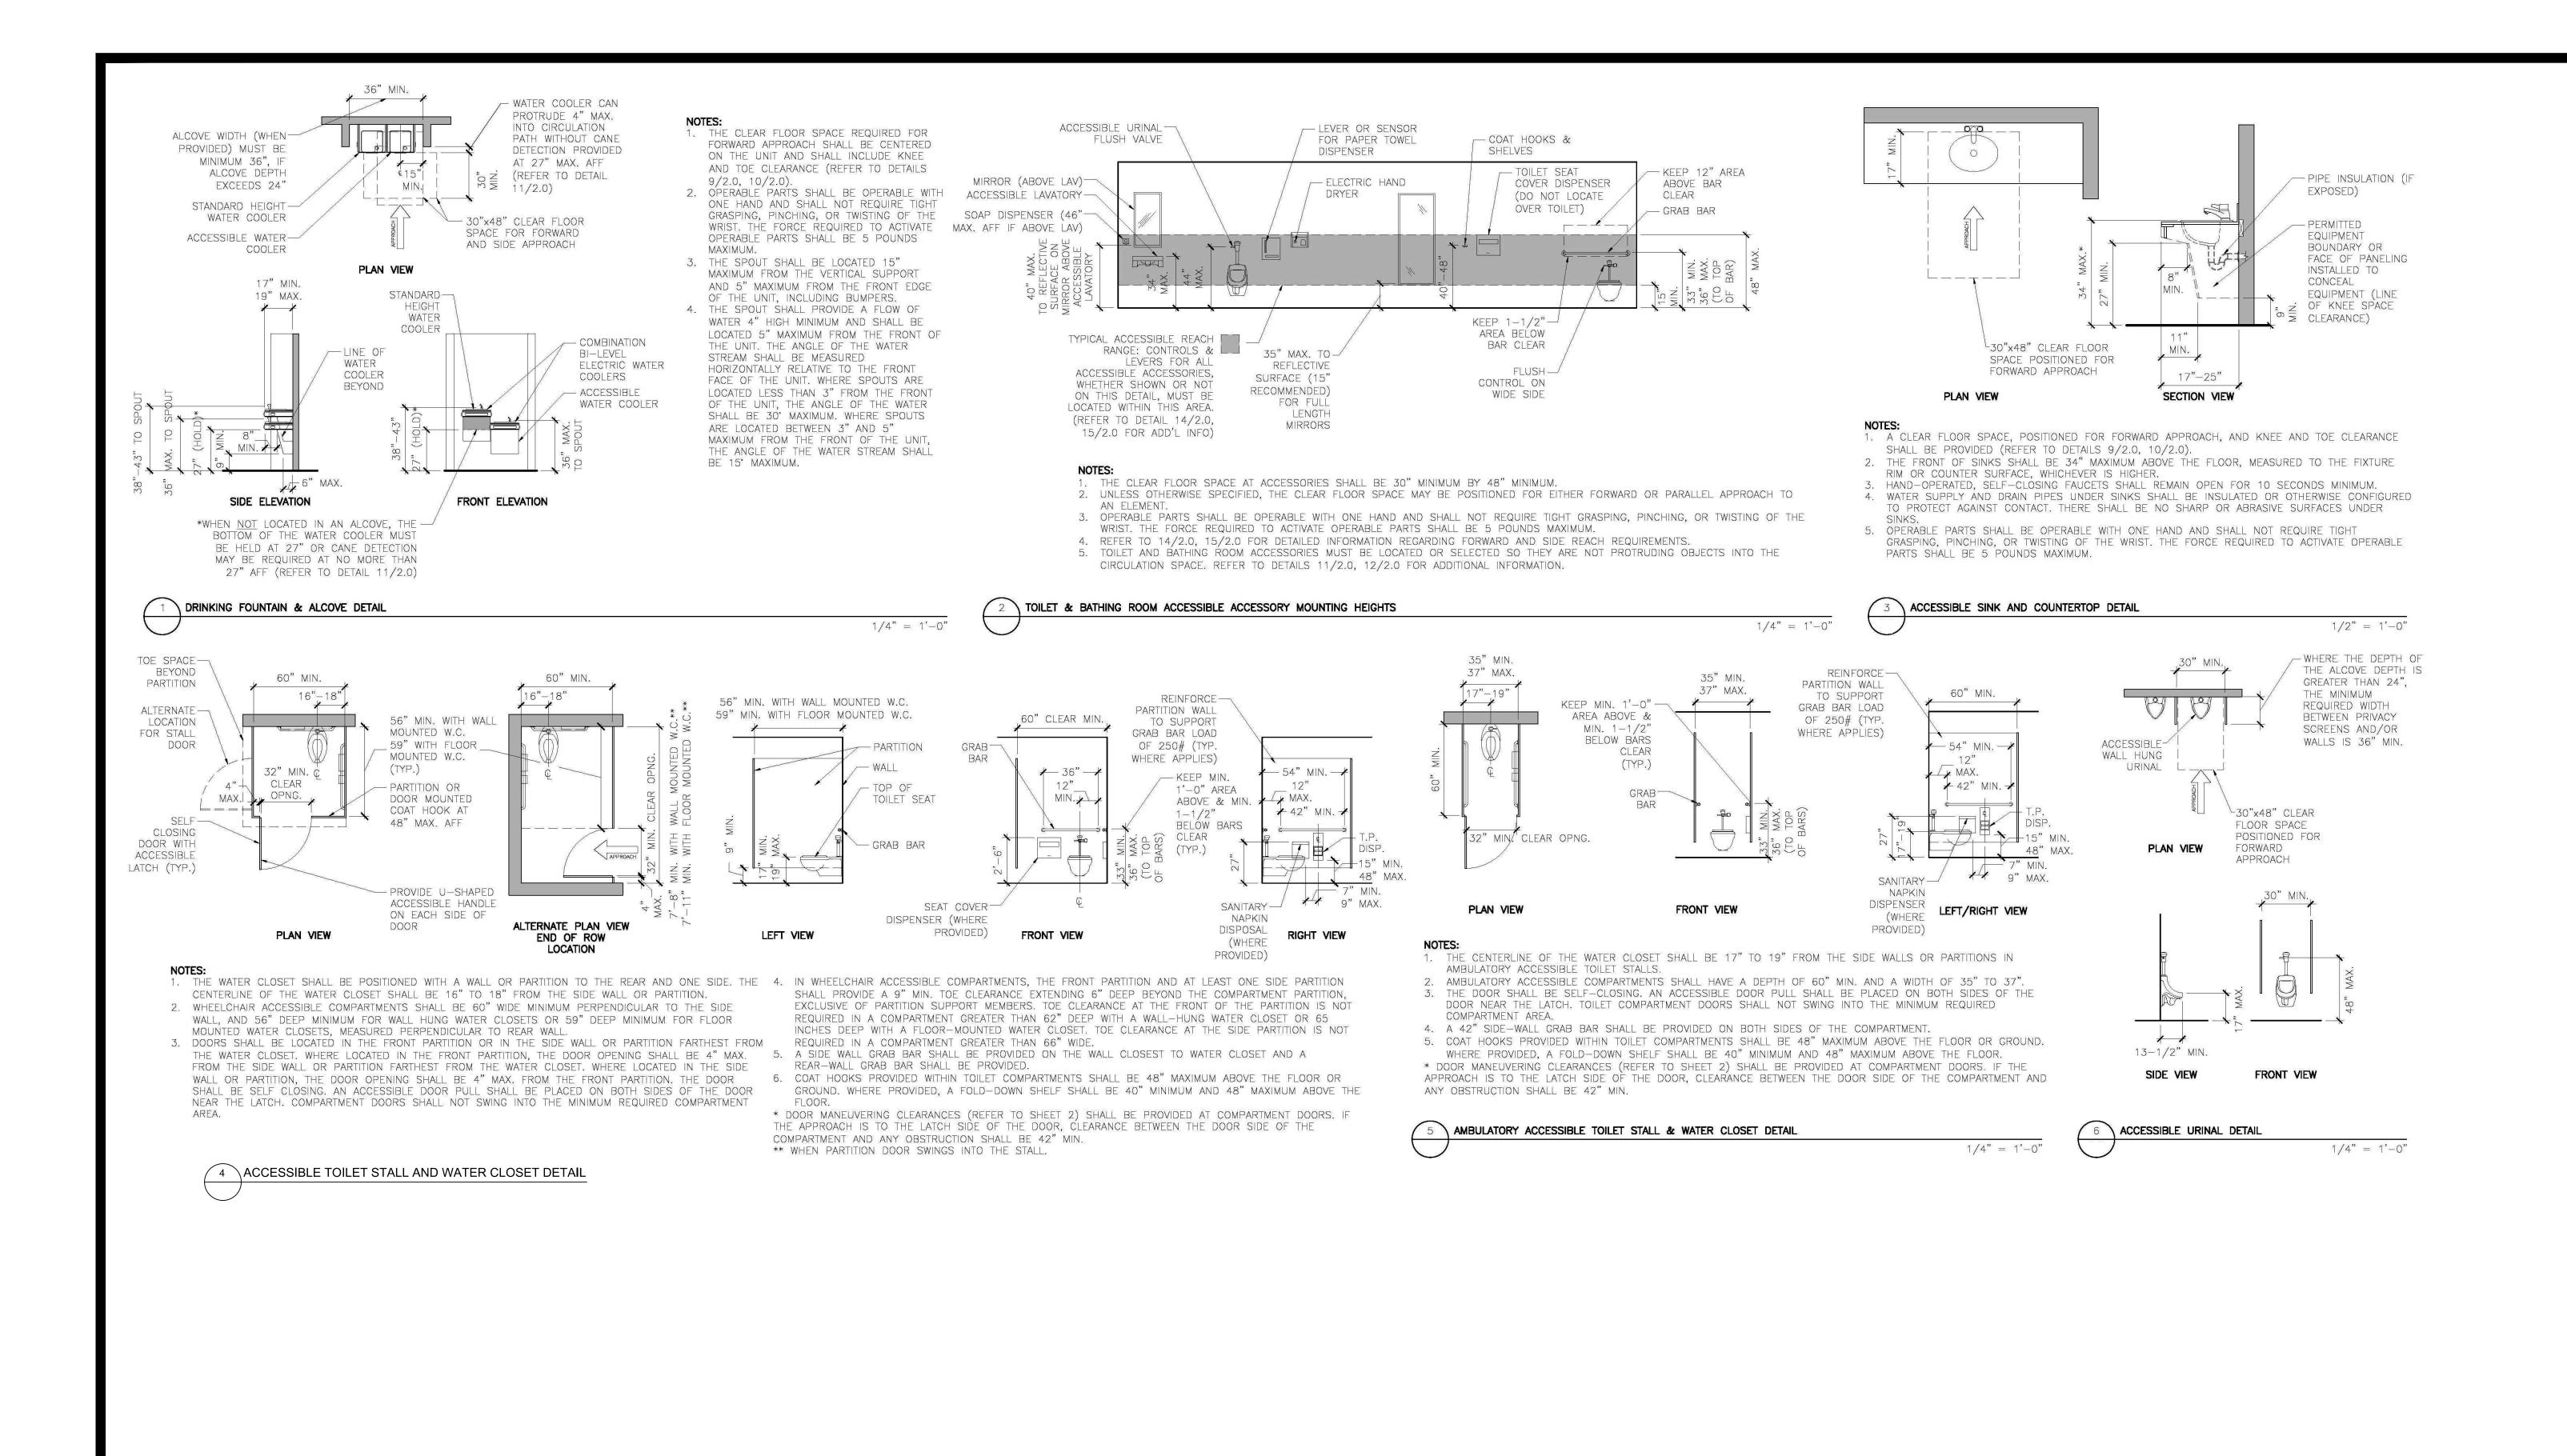

V I S I O N

18-02-003 SHEET NO.

SCALE: N.T.S


DRAWN:


CHECKED:


DATE: JAN 2018


NEW LAWRENCE GROCERY

902 E. BAYSHORE, LEON, TEXAS 77539

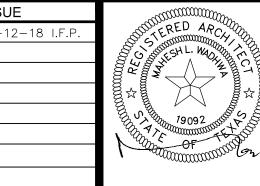

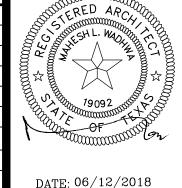

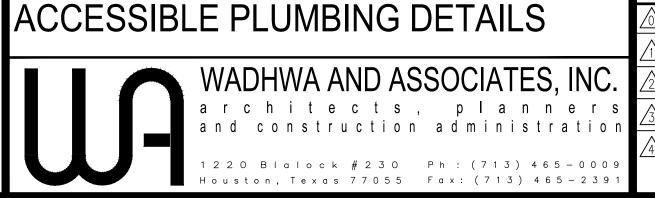

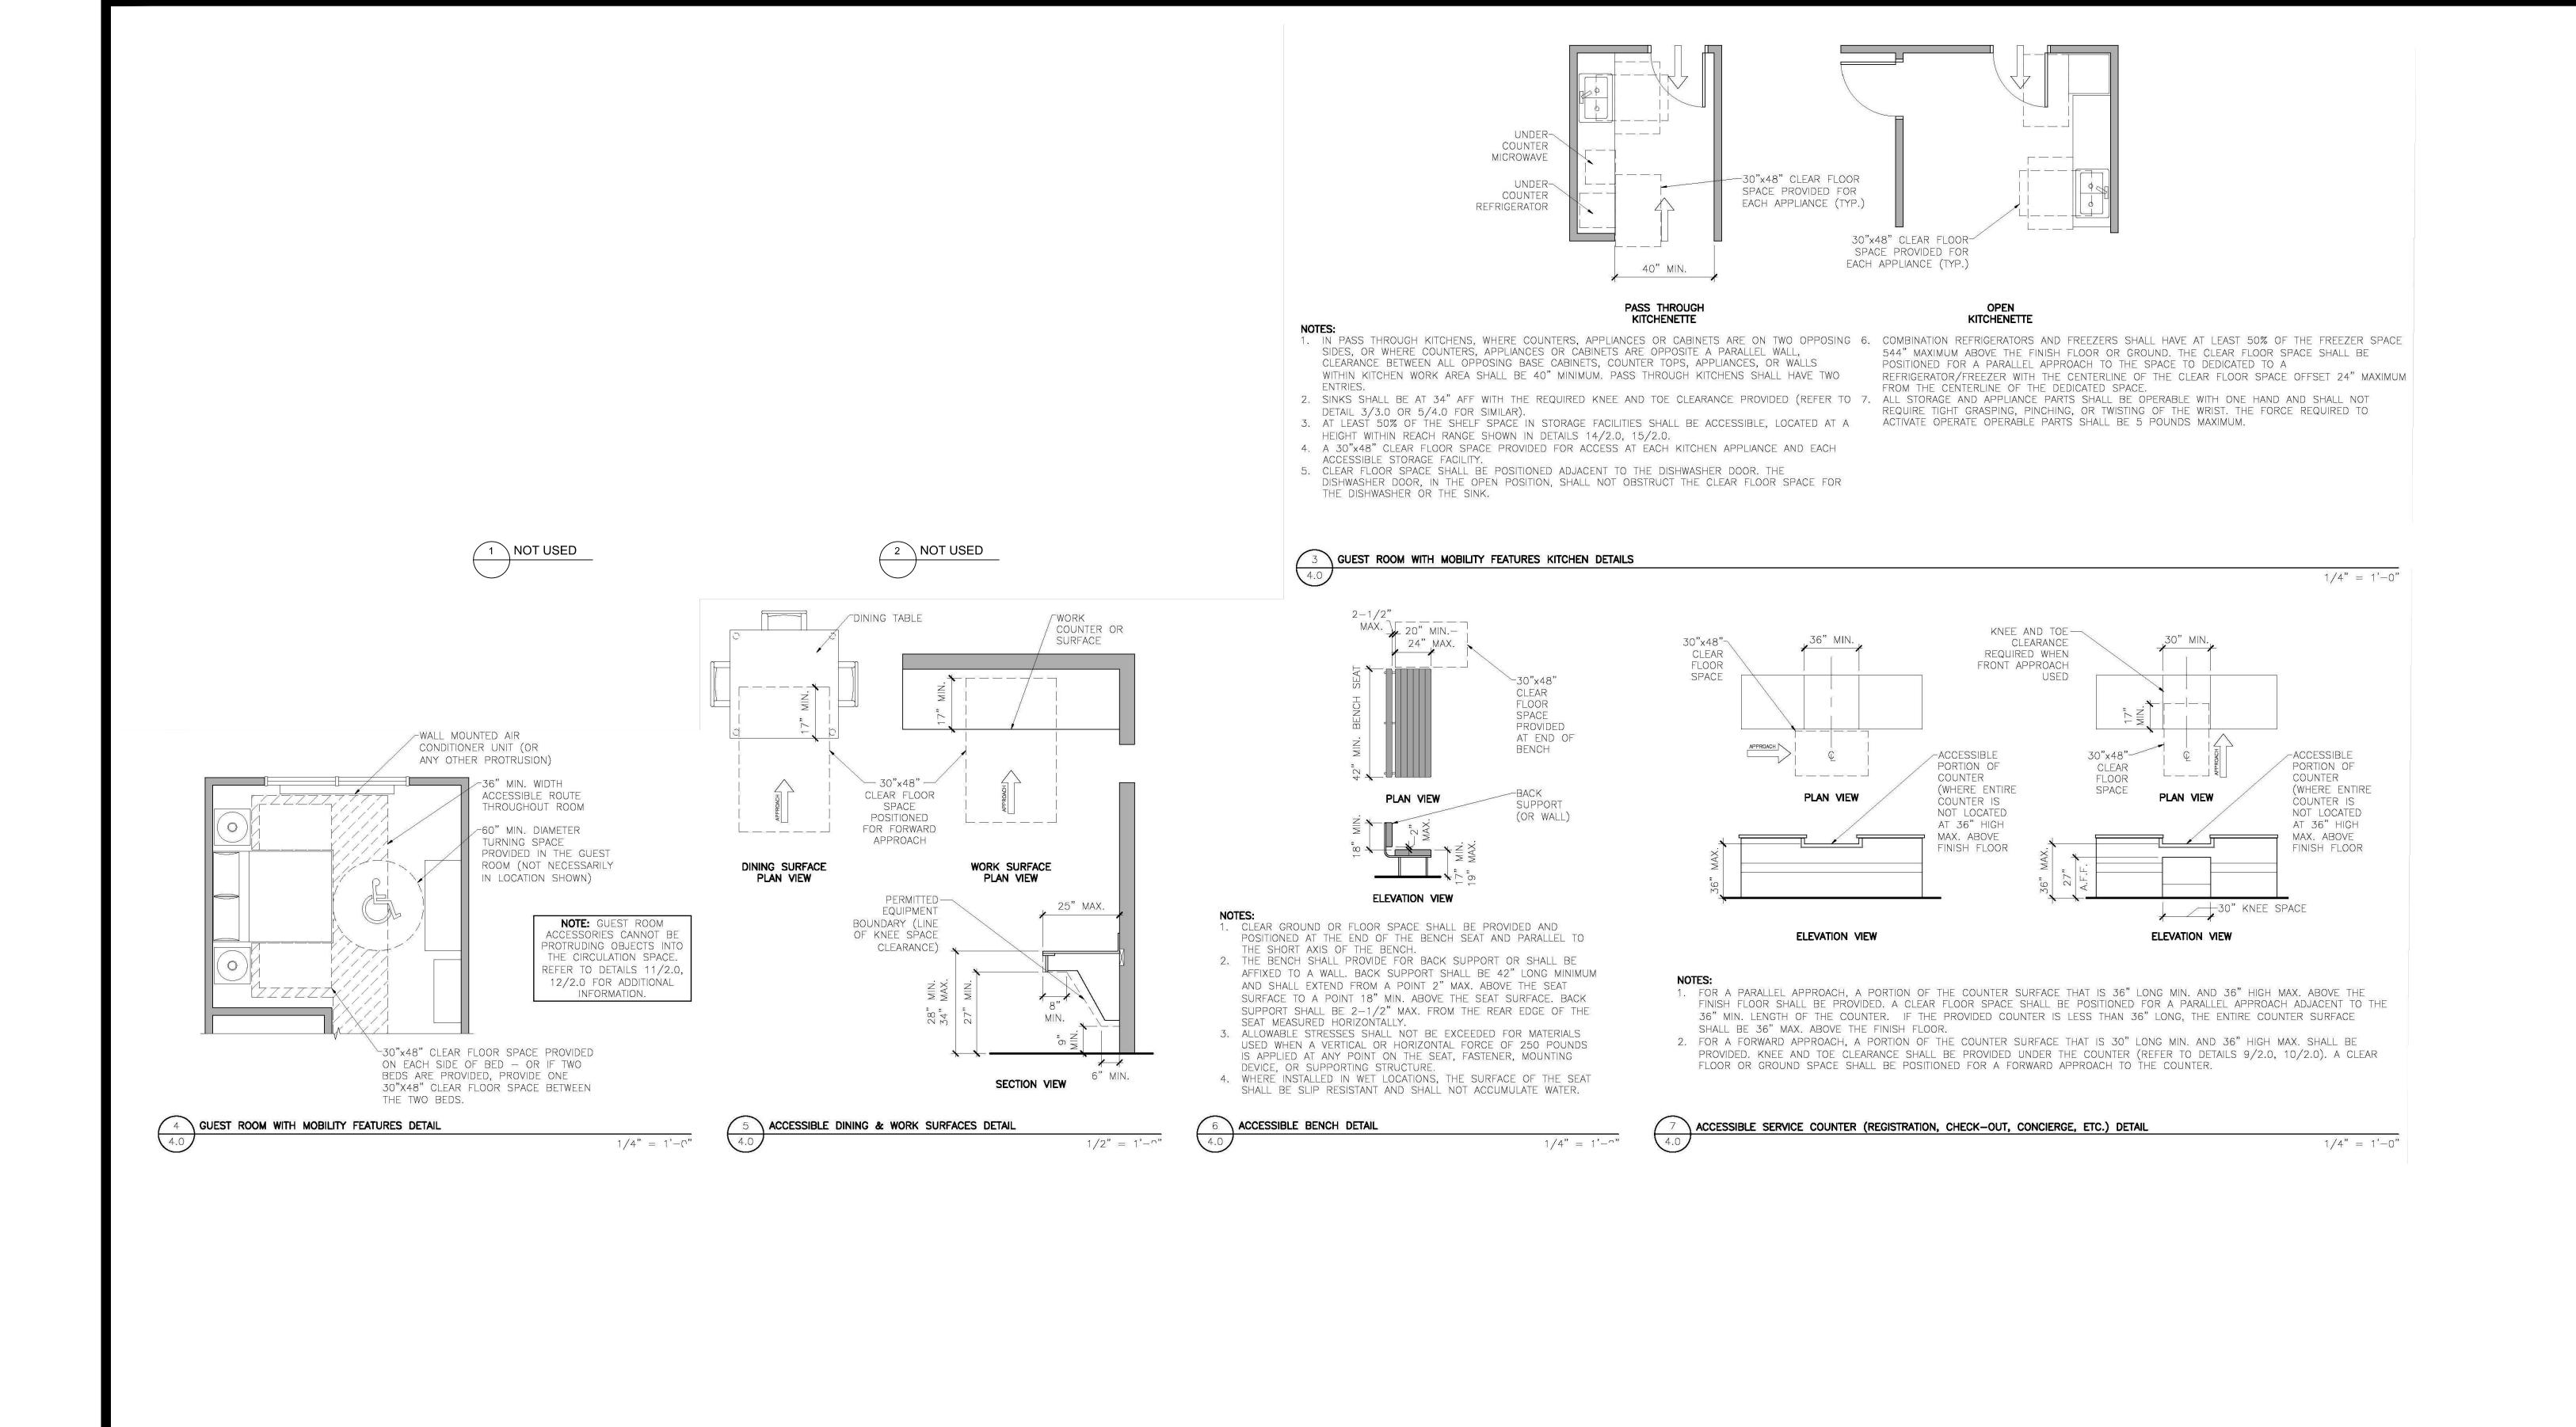


DRAWN:


CHECKED:


DATE: JAN 2018

NEW LAWRENCE GROCERY

902 E. BAYSHORE, LEON, TEXAS 77539

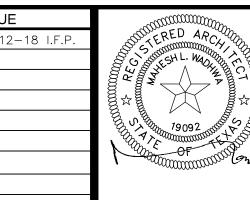


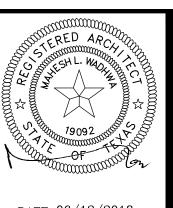


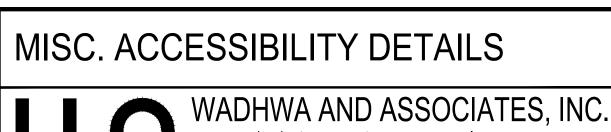


V I S I O N 1 2 2 0 B I a I o c k # 2 3 0 P h : (7 1 3) 4 6 5 - 0 0 0 9

SCALE: N.T.S 18-02-003 SHEET NO.

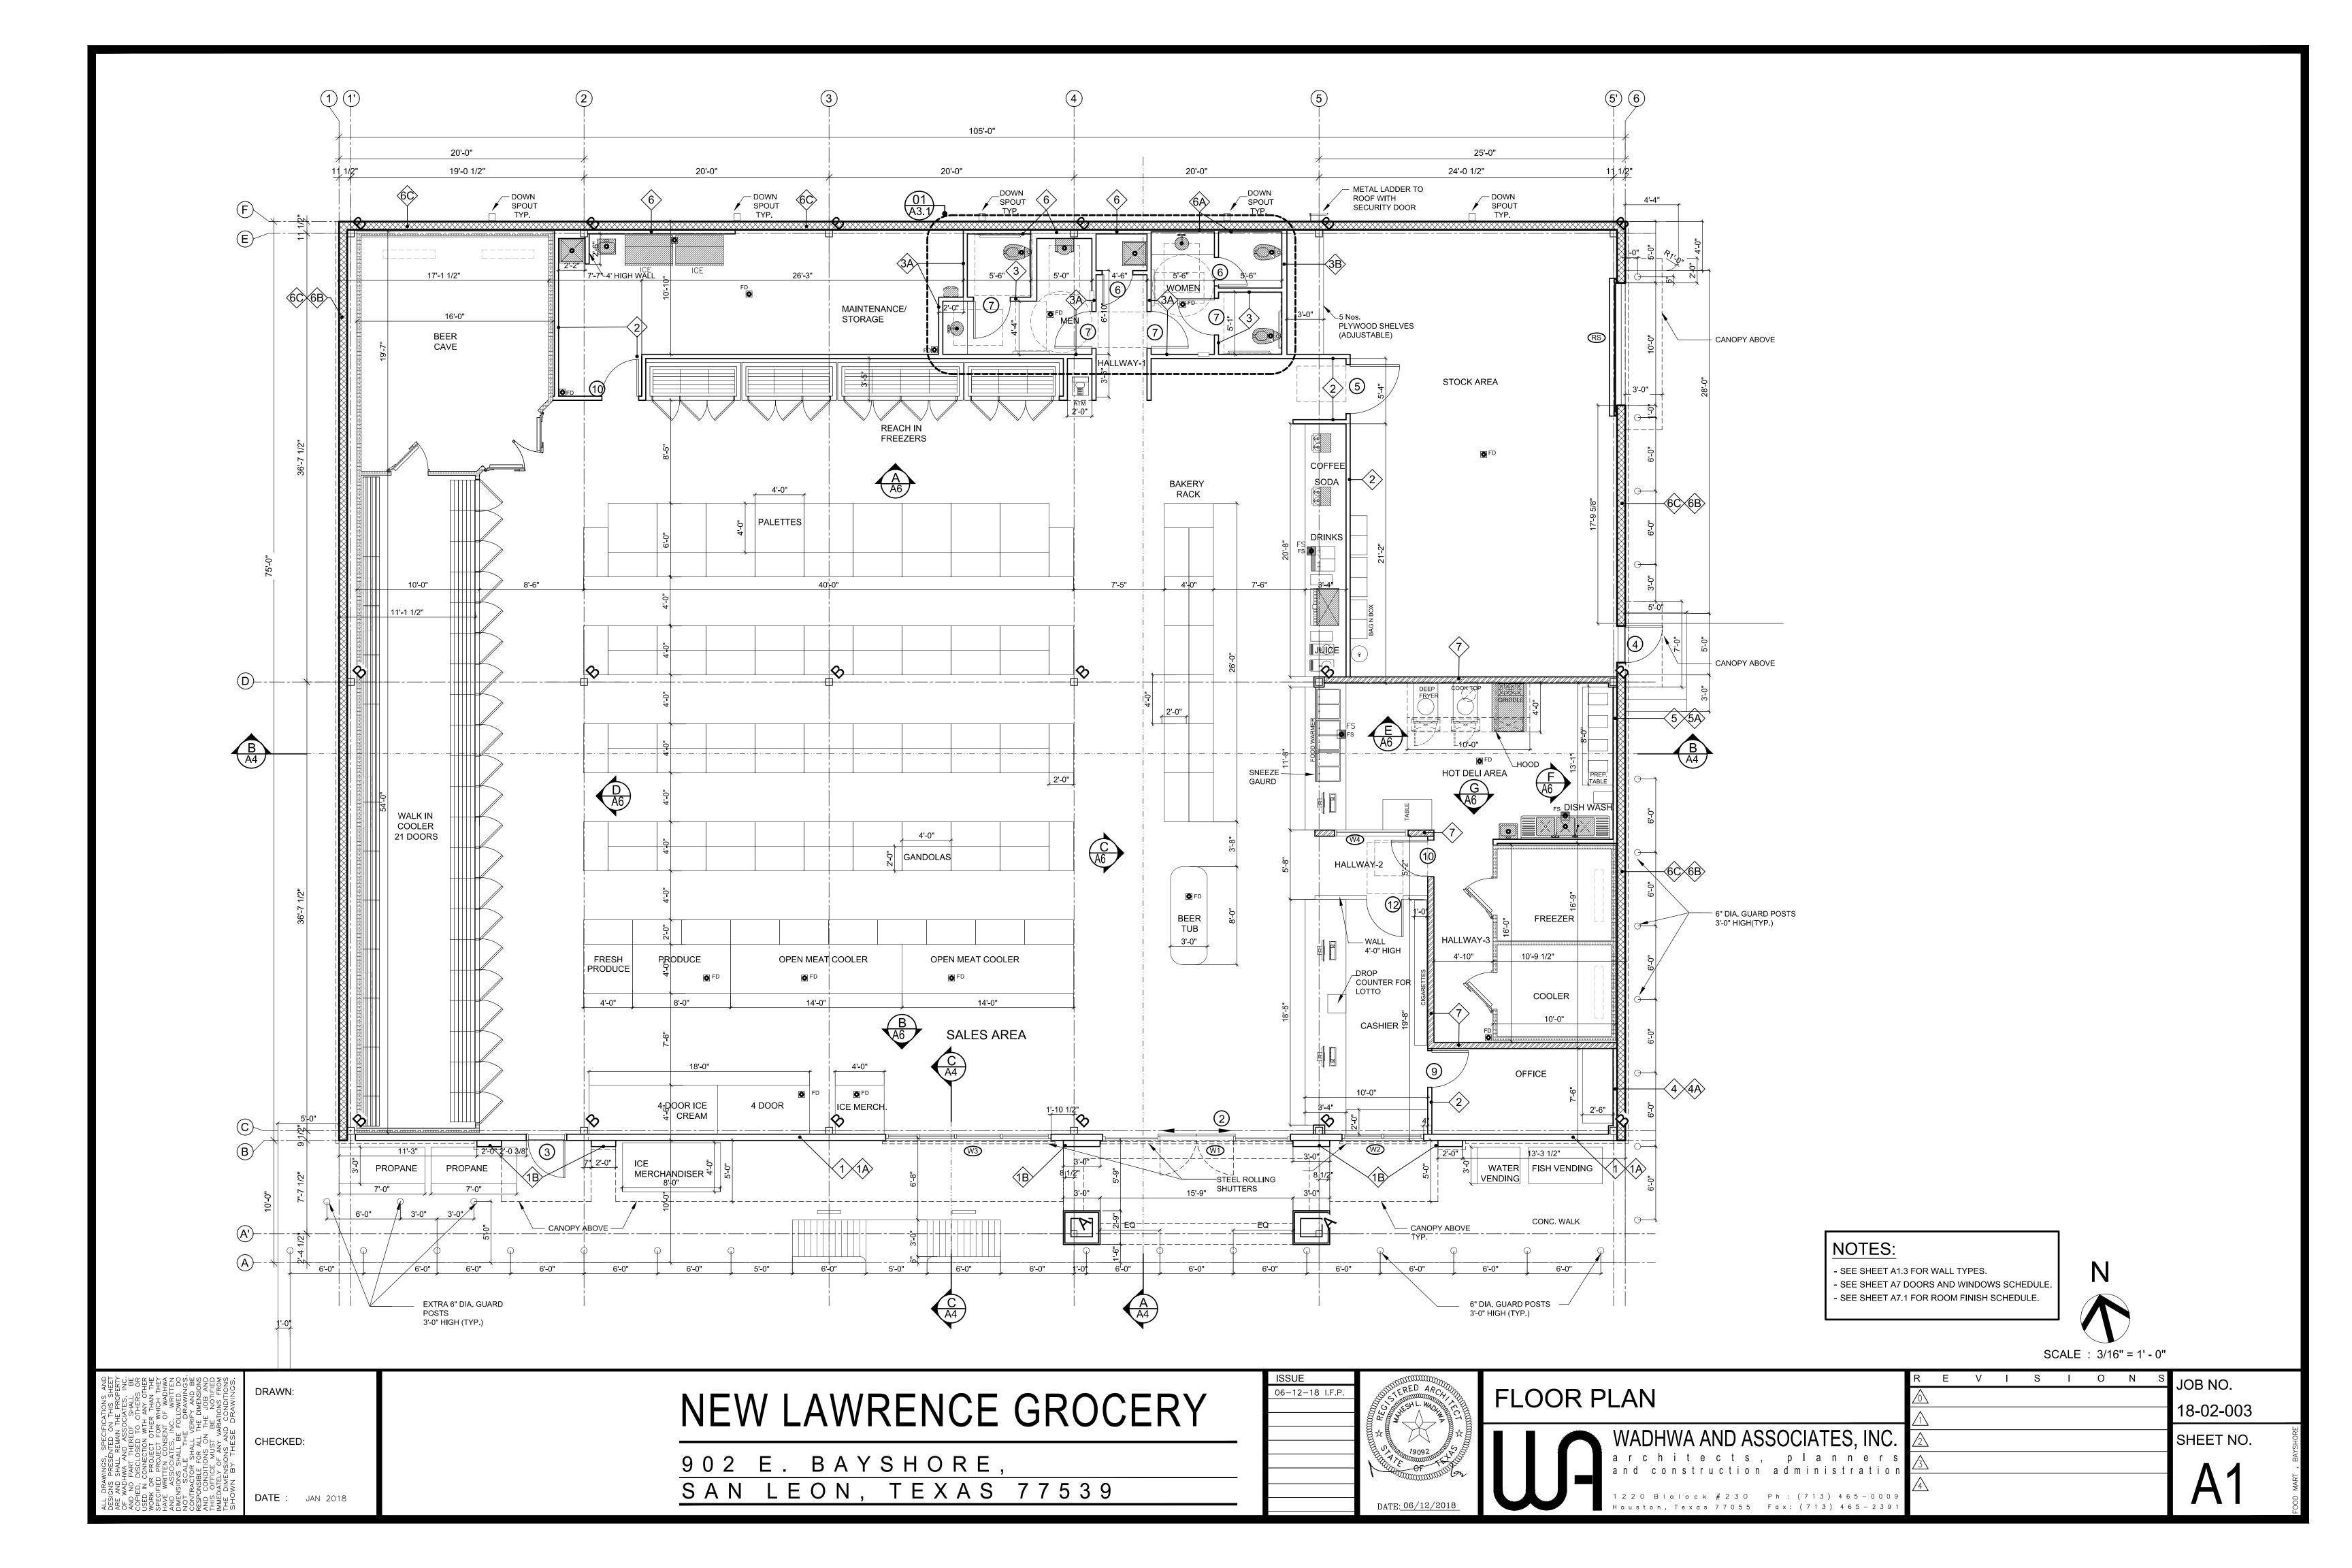

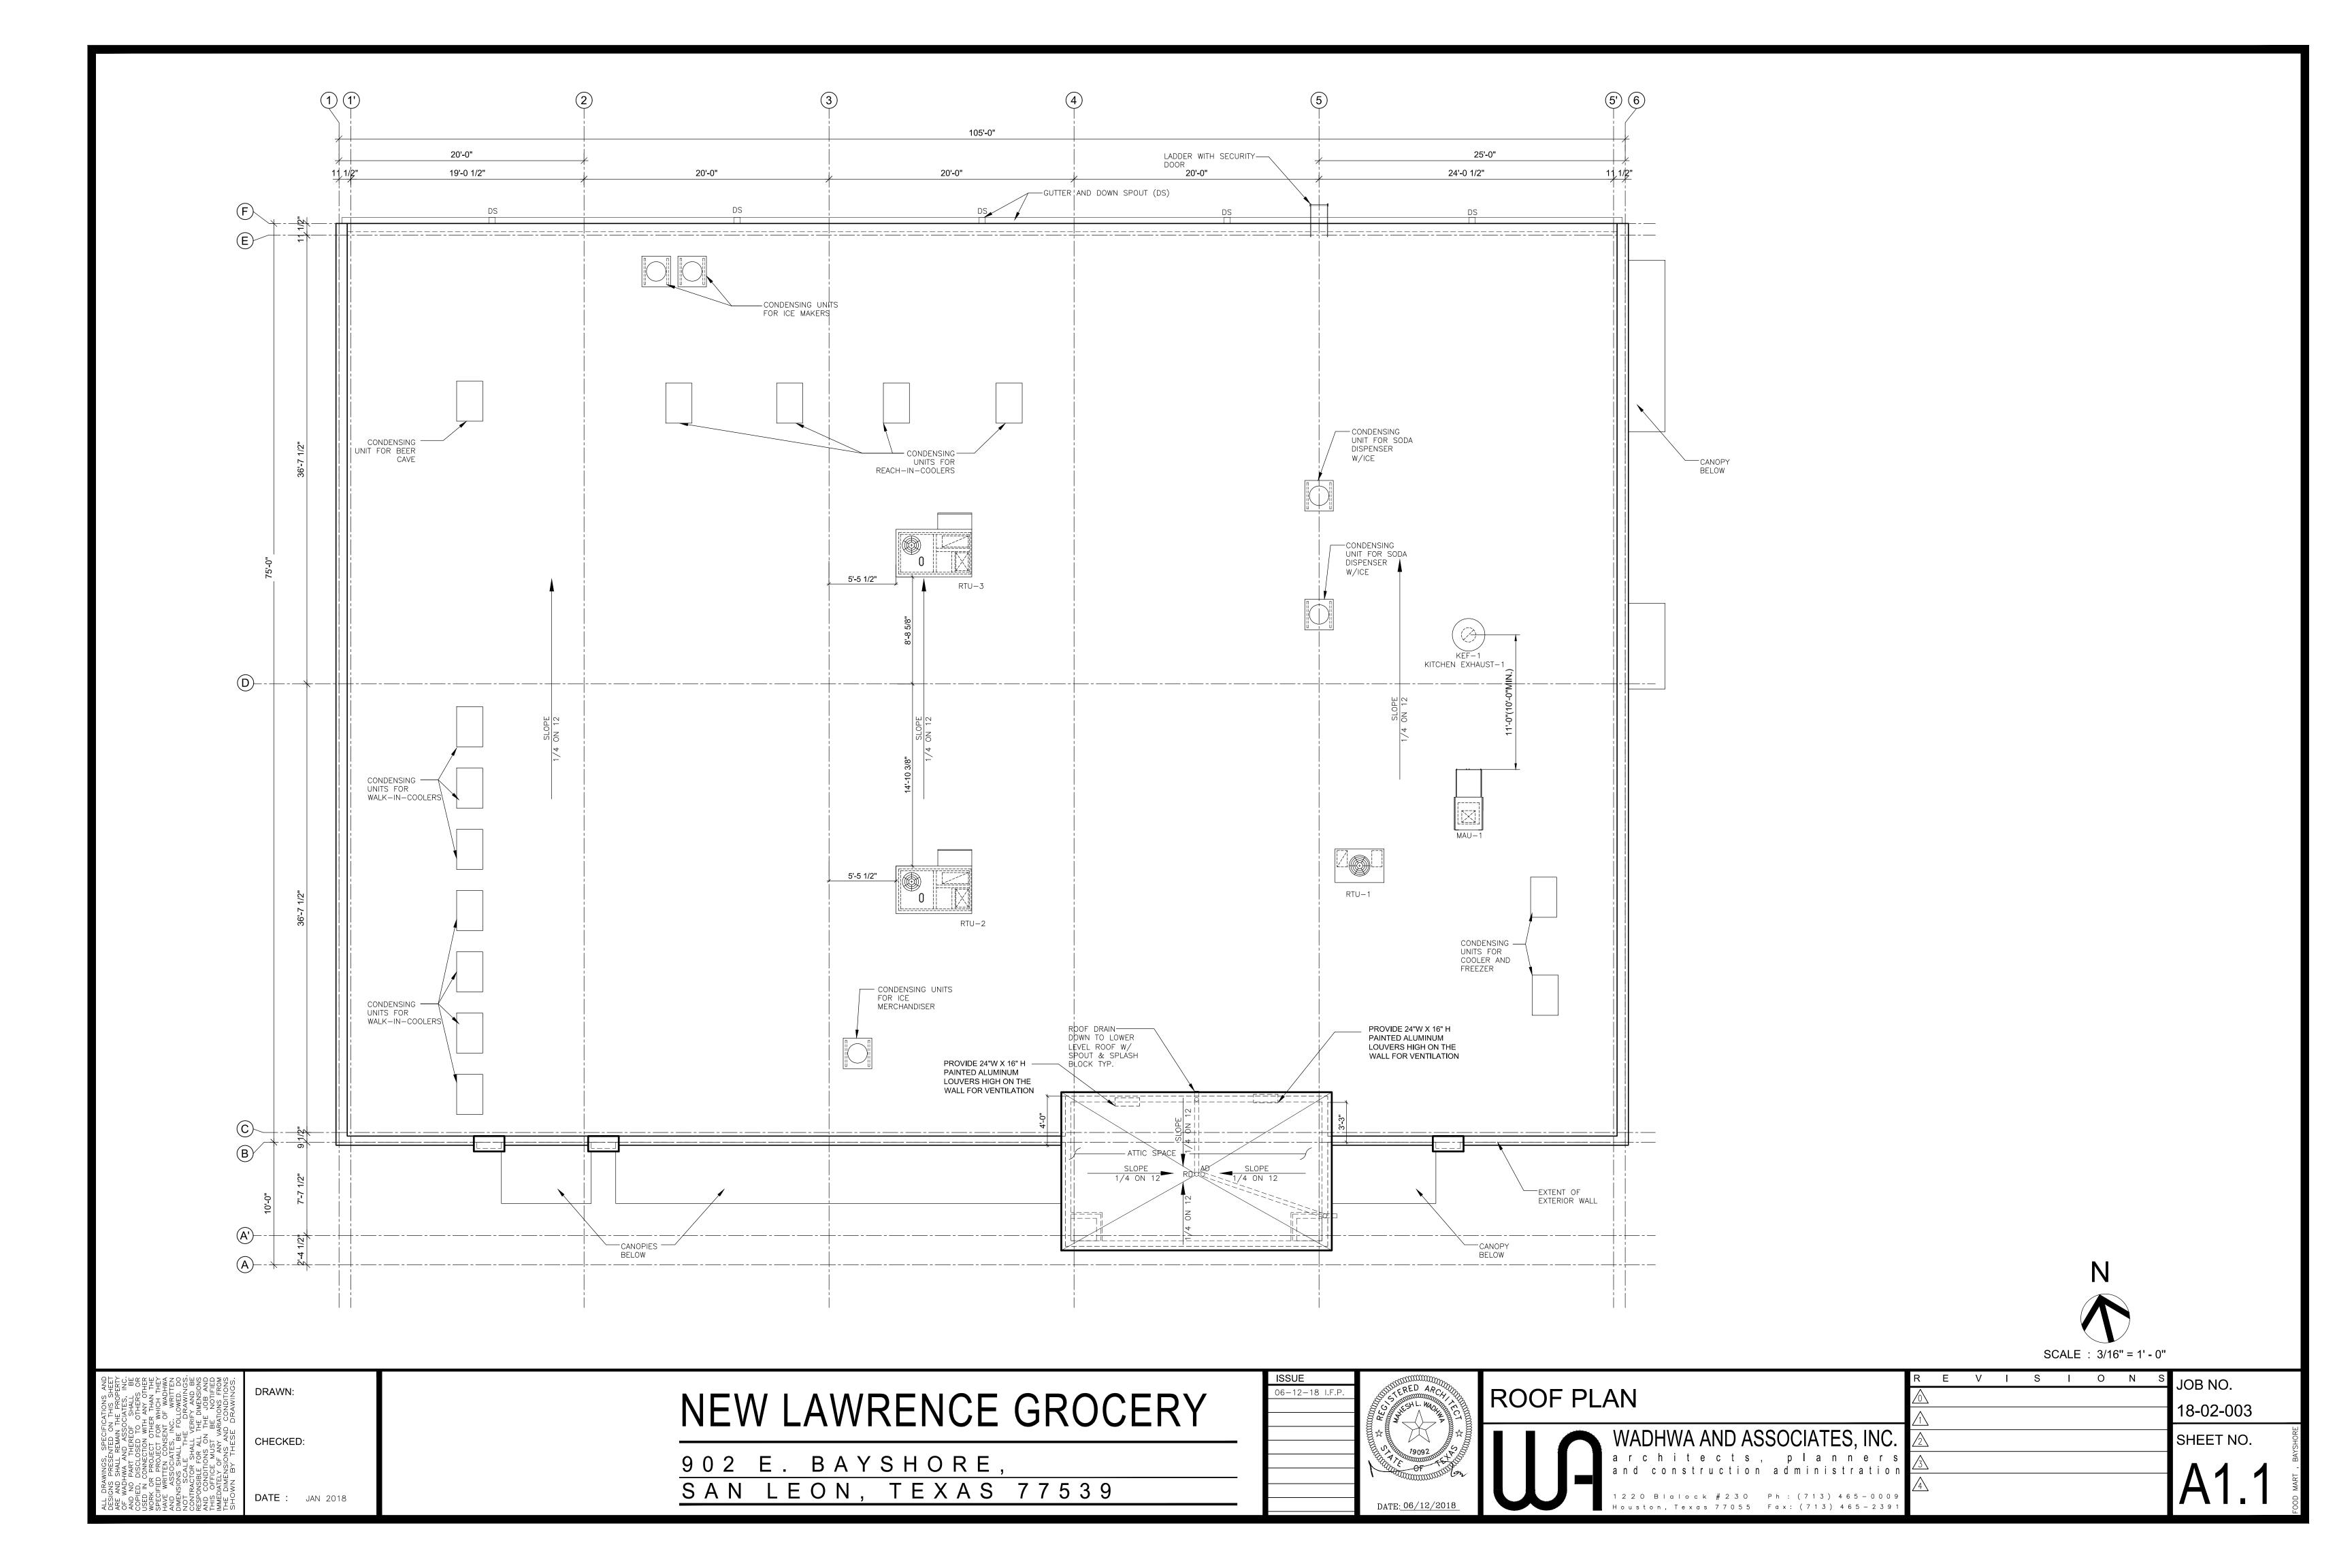

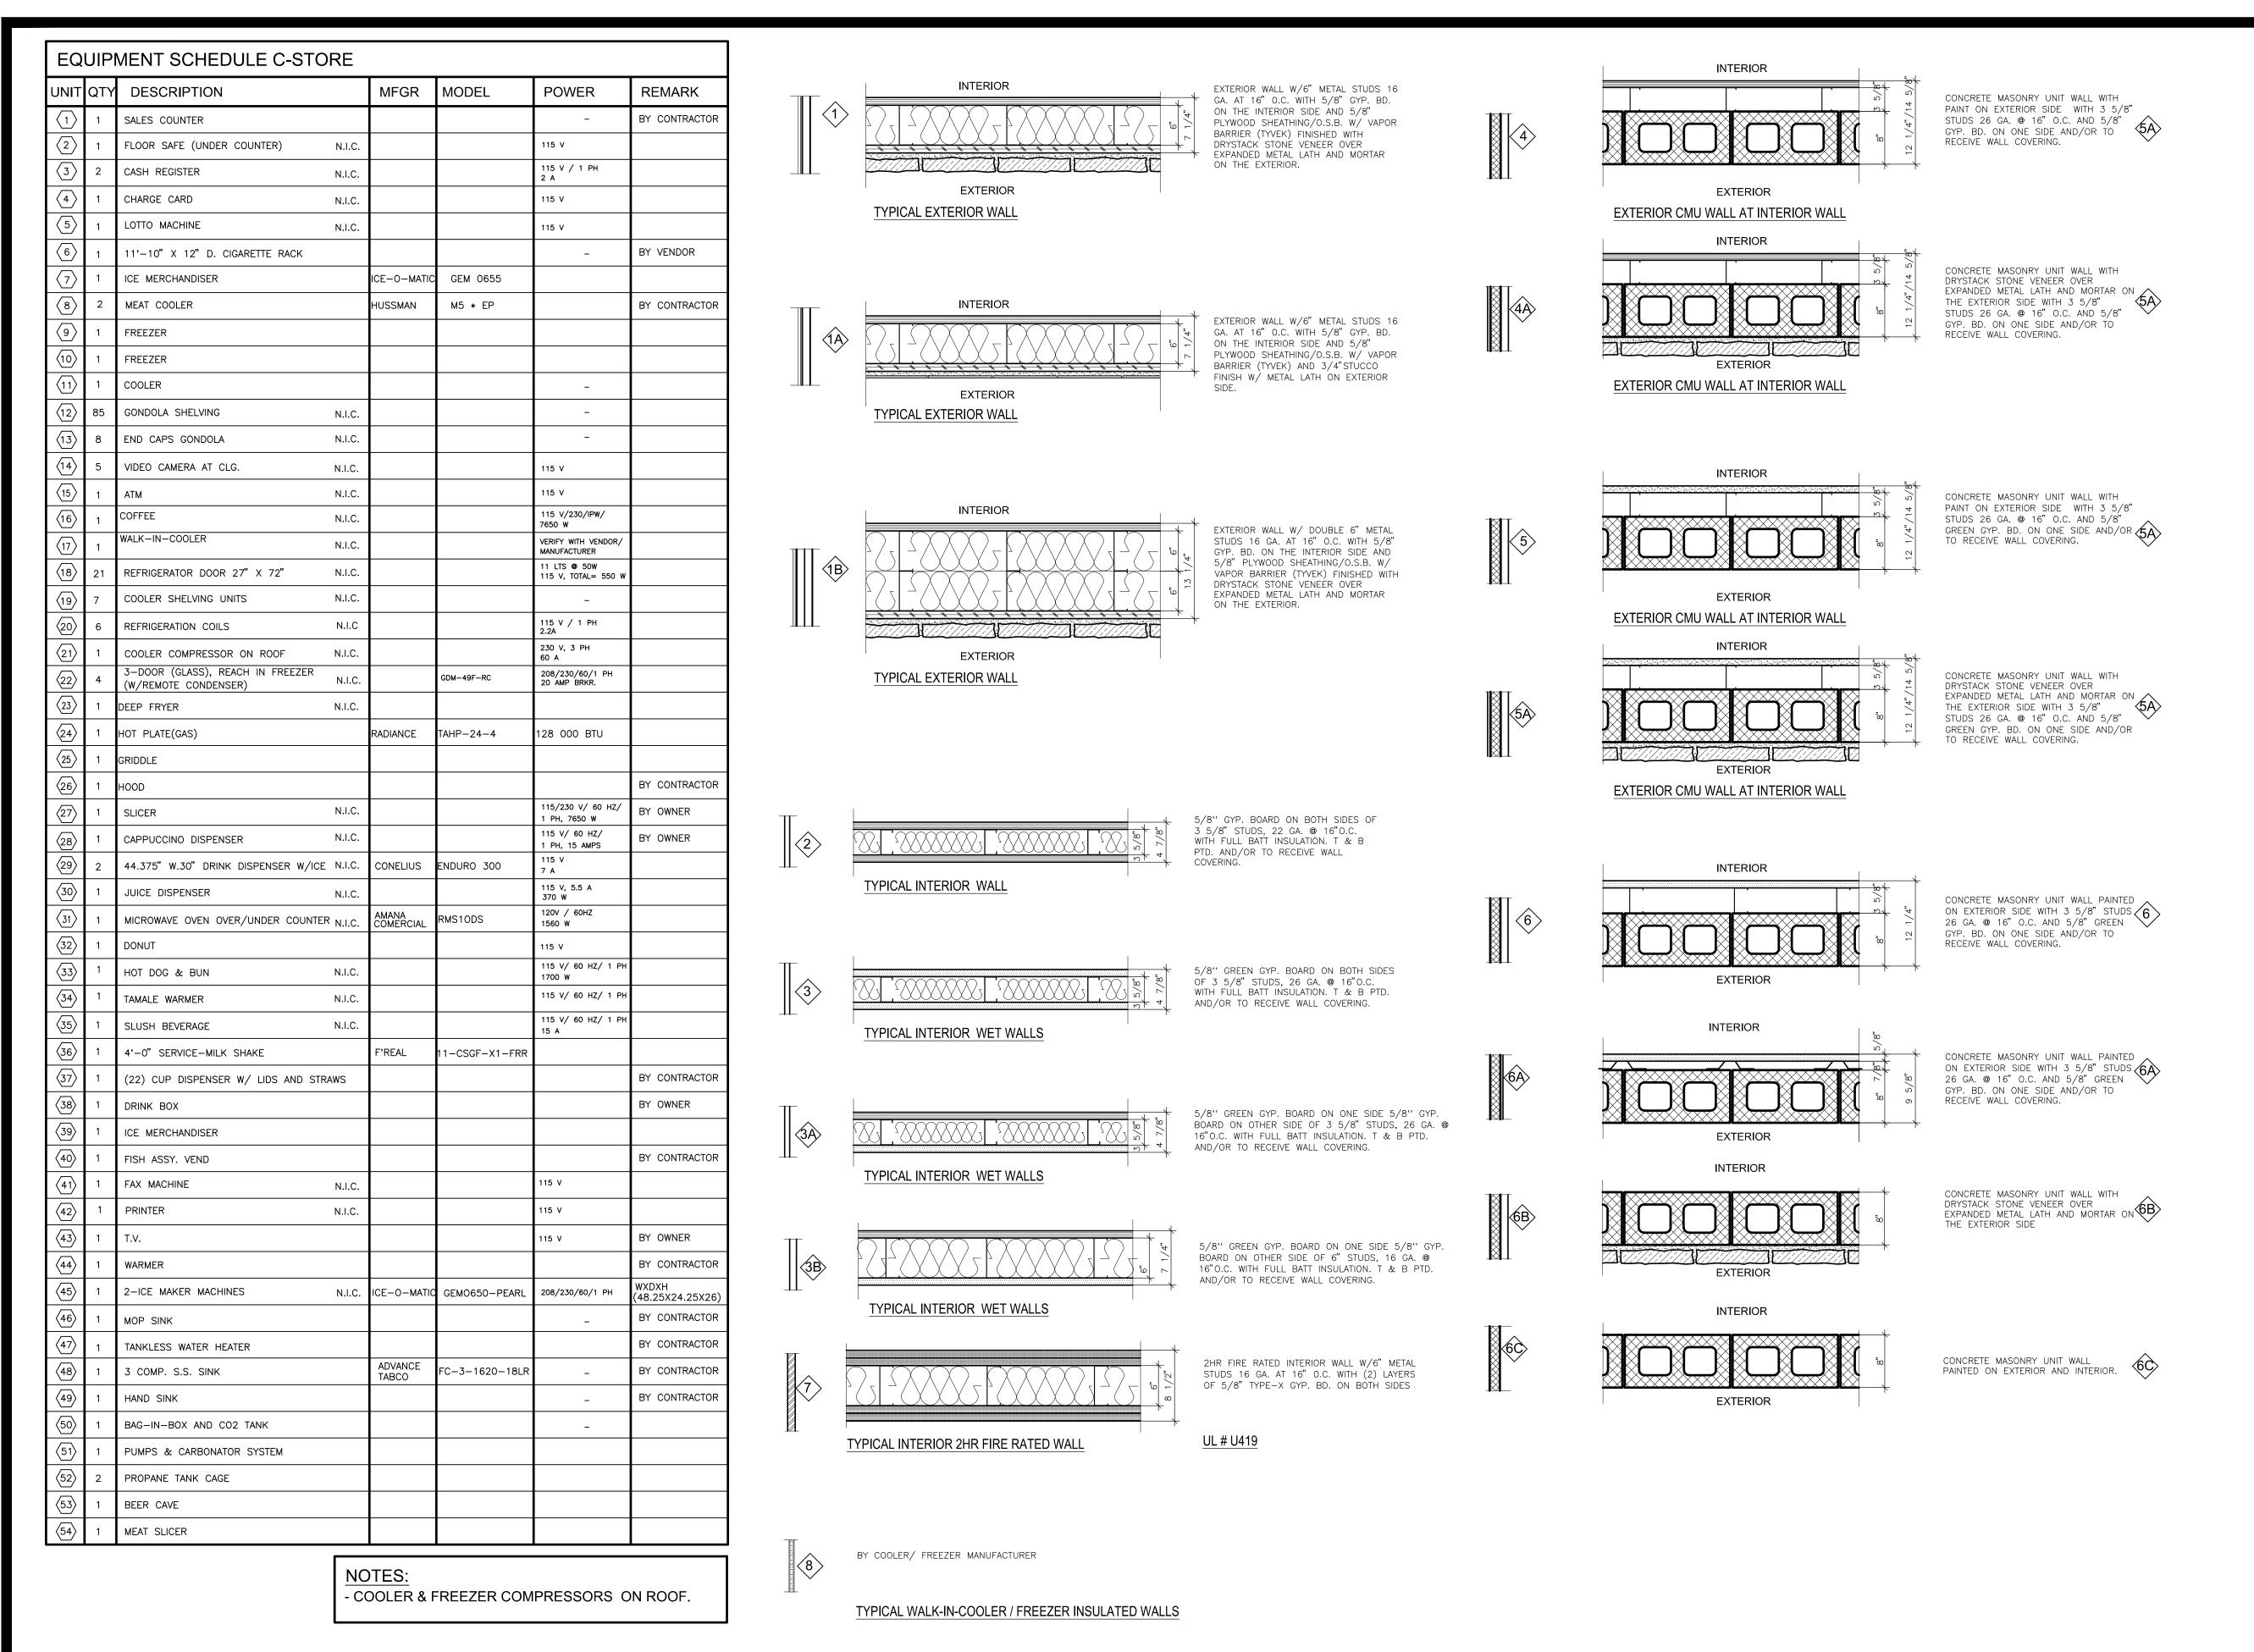

GENERAL NOTES:

ANY DISCREPANCIES IN THE DWGS. WITH FIELD CONDITIONS SHALL BE NOTIFIED TO WAI IMMEDIATELY PRIOR TO START OF WORK.

ALL WORK SHALL BE DONE PER IBC 2012 AND PER CITY OF BROOKSHIRE, TEXAS, REGULATIONS.

CONTRACTOR MUST VISIT THE JOB SITE PRIOR TO BIDDING FOR THE

FIELD VERIFY ALL SITE CONDITIONS, DIMENSIONS, UTILITY LOCATION, SIZE AND CONDITIONS.

CONTRACTOR SHALL OBTAIN AND PAY FOR ALL PERMITS.

CONTRACTOR SHALL BE RESPONSIBLE FOR PROTECTING ALL WATER LINES. PLUMBING LINES AND ANY OTHER UTILITY LINES DURING CONSTRUCTION WORK.

STRUCTURAL SHOP DRAWINGS SHALL BE APPROVED BY WAI PRIOR TO FABRICATION.

CONTRACTOR TO COORDINATE WITH OWNER AND EQUIPMENT SUPPLIER FOR EXACT LOCATION AND CONNECTION TO THE EQUIPMENTS.

9. ALL WORK SHALL CONFORM TO HEALTH CODES AND REGULATIONS.

10. ALL EQUIPMENT SHALL MEET N.S.F. STANDARDS. 11. ALL INTERIOR WALLS TO BE WITH 3 5/8" METAL STUDS U.N.O.

12. ENTIRE V.C.T. FLOOR SHALL BE SEALED AND WAXED.

13. CONTRACTOR TO PROVIDE COMPLETE SPECIFICATIONS AND ENGINEERING DWGS. FOR CANOPY WITH THE BID.

14. ALL INSULATION SHALL HAVE FLAME SPREAD RATING OF NOT MORE THAN 25 AND SMOKE DEVELOPED RATING OF LESS THAN 450

15. DO NOT SCALE THE DRAWINGS. WRITTEN DIMENSIONS SHALL BE FOLLOWED.

16. STEEL SHOP DRGS. SHALL BE PROVIDED BY FABRICATOR AND SHALL BE SUBMITTED TO WAI FOR REVIEW PRIOR TO FABRICATION. 17. BLDG STEEL FRAMING SHALL BE DESIGNED TO CARRY WIND LOADS

18. MILLWORK SHOP DRAWINGS SHALL BE APPROVED BY WAI PRIOR TO

FABRICATION.

19. ALL EXITS SHALL BE INSECT/RODENT PROOF.

HEALTH NOTES

ALL NEW EXHAUST HOODS WILL BE CONSTRUCTED TO MEET THE FOLLOWING STANDARDS, "NSF, UL, AND NFPA-96". ALL NEW HOODS TO BEAR UL CLASSIFIED LABEL WITHOUT DAMPERS IN EXHAUST VENT COLLARS. HOODS ARE DESIGNED TO MEET OR EXCEED 50 FPM CAPTURE VELOCITY AT THE COOKING SURFACE EDGE AND HAVE 1'-0" MINIMUM OVERHANG AT ALL EXPOSED COOKING AREAS.

ALL COOKING EQUIPMENT UNDER EXHAUST HOODS ARE EITHER ON CASTERS WITH FLEXIBLE UTILITY QUICK DISCONNECTS OR FIXED ON STAINLESS STEEL LEGS AND SEALED TO WALLS WITH CLEAR SILICONE SEALANT

DISHWASHERS WILL BE DESIGNED AS HIGH TEMPERATURE WASH SYSTEM. WITH A WASH TEMPERATURE OF 140° MINIMUM AND A FINAL RINSE TEMPERATURE OF 180° MINIMUM.

THE HOODS AND EXHAUST DUCT SYSTEMS BY G.C. SHALL BE PROVIDED WITH AN AUTOMATIC FIRE EXTINGUISHING SYSTEM.

SHUT-OFF VALVES, REQUIRED AS PART OF THE FIRE SUPPRESSION SYSTEM FOR GAS AND/OR ELECTRIC COOKING EQUIPMENT, UNDER OR ADJACENT TO HOODS, SHOULD BE PROVIDED BY G.C. AS REQUIRED PER GOVERNING JURISDICTION AND LOCAL AND/OR STATE CODES.

ALL REFRIGERATION EQUIPMENT SHALL HAVE THERMOMETERS WHICH ARE EASILY READABLE, IN PROPER WORKING CONDITION AND

ACCURATE. WITHIN A RANGE OF PLUS OR MINUS TWO (2) DEGREES. COUNTER TOP EQUIPMENT NOT READILY MOVABLE, WEIGHING OVER 80 POUNDS, WILL BE PROVIDED WITH LEGS OR FEET AT LEAST FOUR (4") INCHES HIGH.

ALL CHEMICAL INJECTION SYSTEMS MUST BE INSTALLED DOWNSTREAM FROM A VACUUM BREAKER OR AIR GAP TO PREVENT POSSIBLE BACK SIPHONAGE TO THE CHEMICALS INTO THE WATER LINE SYSTEM.

ALL CUTTING BOARDS AND WORK SURFACES SHALL BE OF NON-WOOD CONSTRUCTION.

0. AN AISLE SPACE OF THIRTY-SIX (36") INCHES OR MORE SHALL BE PROVIDED WITHIN ALL WORK AND STORAGE AREAS.

11. BACKSPLASHES OF EQUIPMENT SHALL BE SEALED TO WALLS WITH CLEAR SILICONE.

12. VACUUM BREAKERS, WHEN USED, TO BE MINIMUM OF SIX (6") INCHES ABOVE THE FLOOD LEVEL RIM WITH NO SHUT OFF DEVICES BEYOND THE DISCHARGE OF THE VACUUM BREAKER

13. PROVIDE A MINIMUM OF 50 FOOT CANDLES OF LIGHTING IN ALL FOOD PREPARATION, COOKING AND DISHWASHING AREAS. LIGHTING IS TO BE SHIELDED OVER EXPOSED FOOD AND UNTENSIL AREAS. PROVIDE A MINIMUM OF 50 FOOT CANDLES OF LIGHTING OVER FOOD SERVING AND

14. HAND WASHING FACILITIES ARE REQUIRED FOR FOOD PREPARATION, SERVING AND/OR UTENSIL WASHING AREAS AND ARE SHOWN ON THE

KITCHEN EQUIPMENT FLOOR PLAN. 15. ALL OPENINGS IN CONSTRUCTION WILL BE SEALED TO WITHIN 1/32 OF

16. THE USE OF SEALANTS MUST BE LISTED AS APPROVED BY THE NATIONAL SANITATION FOUNDATION (NSF) UNDER STANDARD C-2.

. SEALANTS MAY BE USED ONLY IN STRUCTURALLY SOUND JOINTS AND SEAMS. SEALANTS MAY NOT BE UTILIZED IN FOOD AND SPLASH CONTACT SURFACES, TO FILL OPEN SPACES OR VOIDS WHICH RESULT DUE TO IMPROPER FABRICATION. ANY OPENING IN EXCESS OF 1/8 INCH SHALL BE CONSIDERED EXCESSIVE AND MUST BE CLOSED USING PROPER FIELD JOINT.

18. OPENINGS AROUND SERVICE AND UTILITY LINES SHOULD BE CLOSED AS FAR AS POSSIBLE WITH COLLARS, GROMMETS AND FLEXIBLE FORM GASKETS. SEALANTS MAY NOT BE USED TO SEAL SERVICE AND UTILITY LINES TO WALLS OR ADJACENT PIECES OF EQUIPMENT.

9. REFER TO PLUMBING DRAWINGS ON RPZ (BACKFLOW PREVENTER) ON ALL KITCHEN EQUIPMENT.


NEW LAWRENCE GROCERY


902 E. BAYSHORE, LEON, TEXAS 77539


DRAWN:

CHECKED:

DATE: JAN 2018

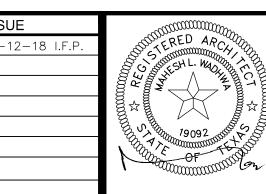

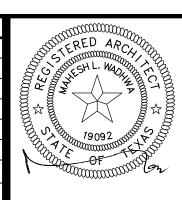

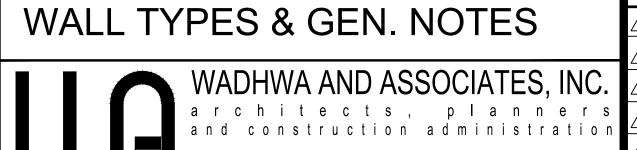


1220 Blalock #230 Ph: (713) 465-0009


Houston, Texas 77055 Fax: (713) 465-239


V I S I O N

18-02-003 SHEET NO.


SCALE: N.T.S

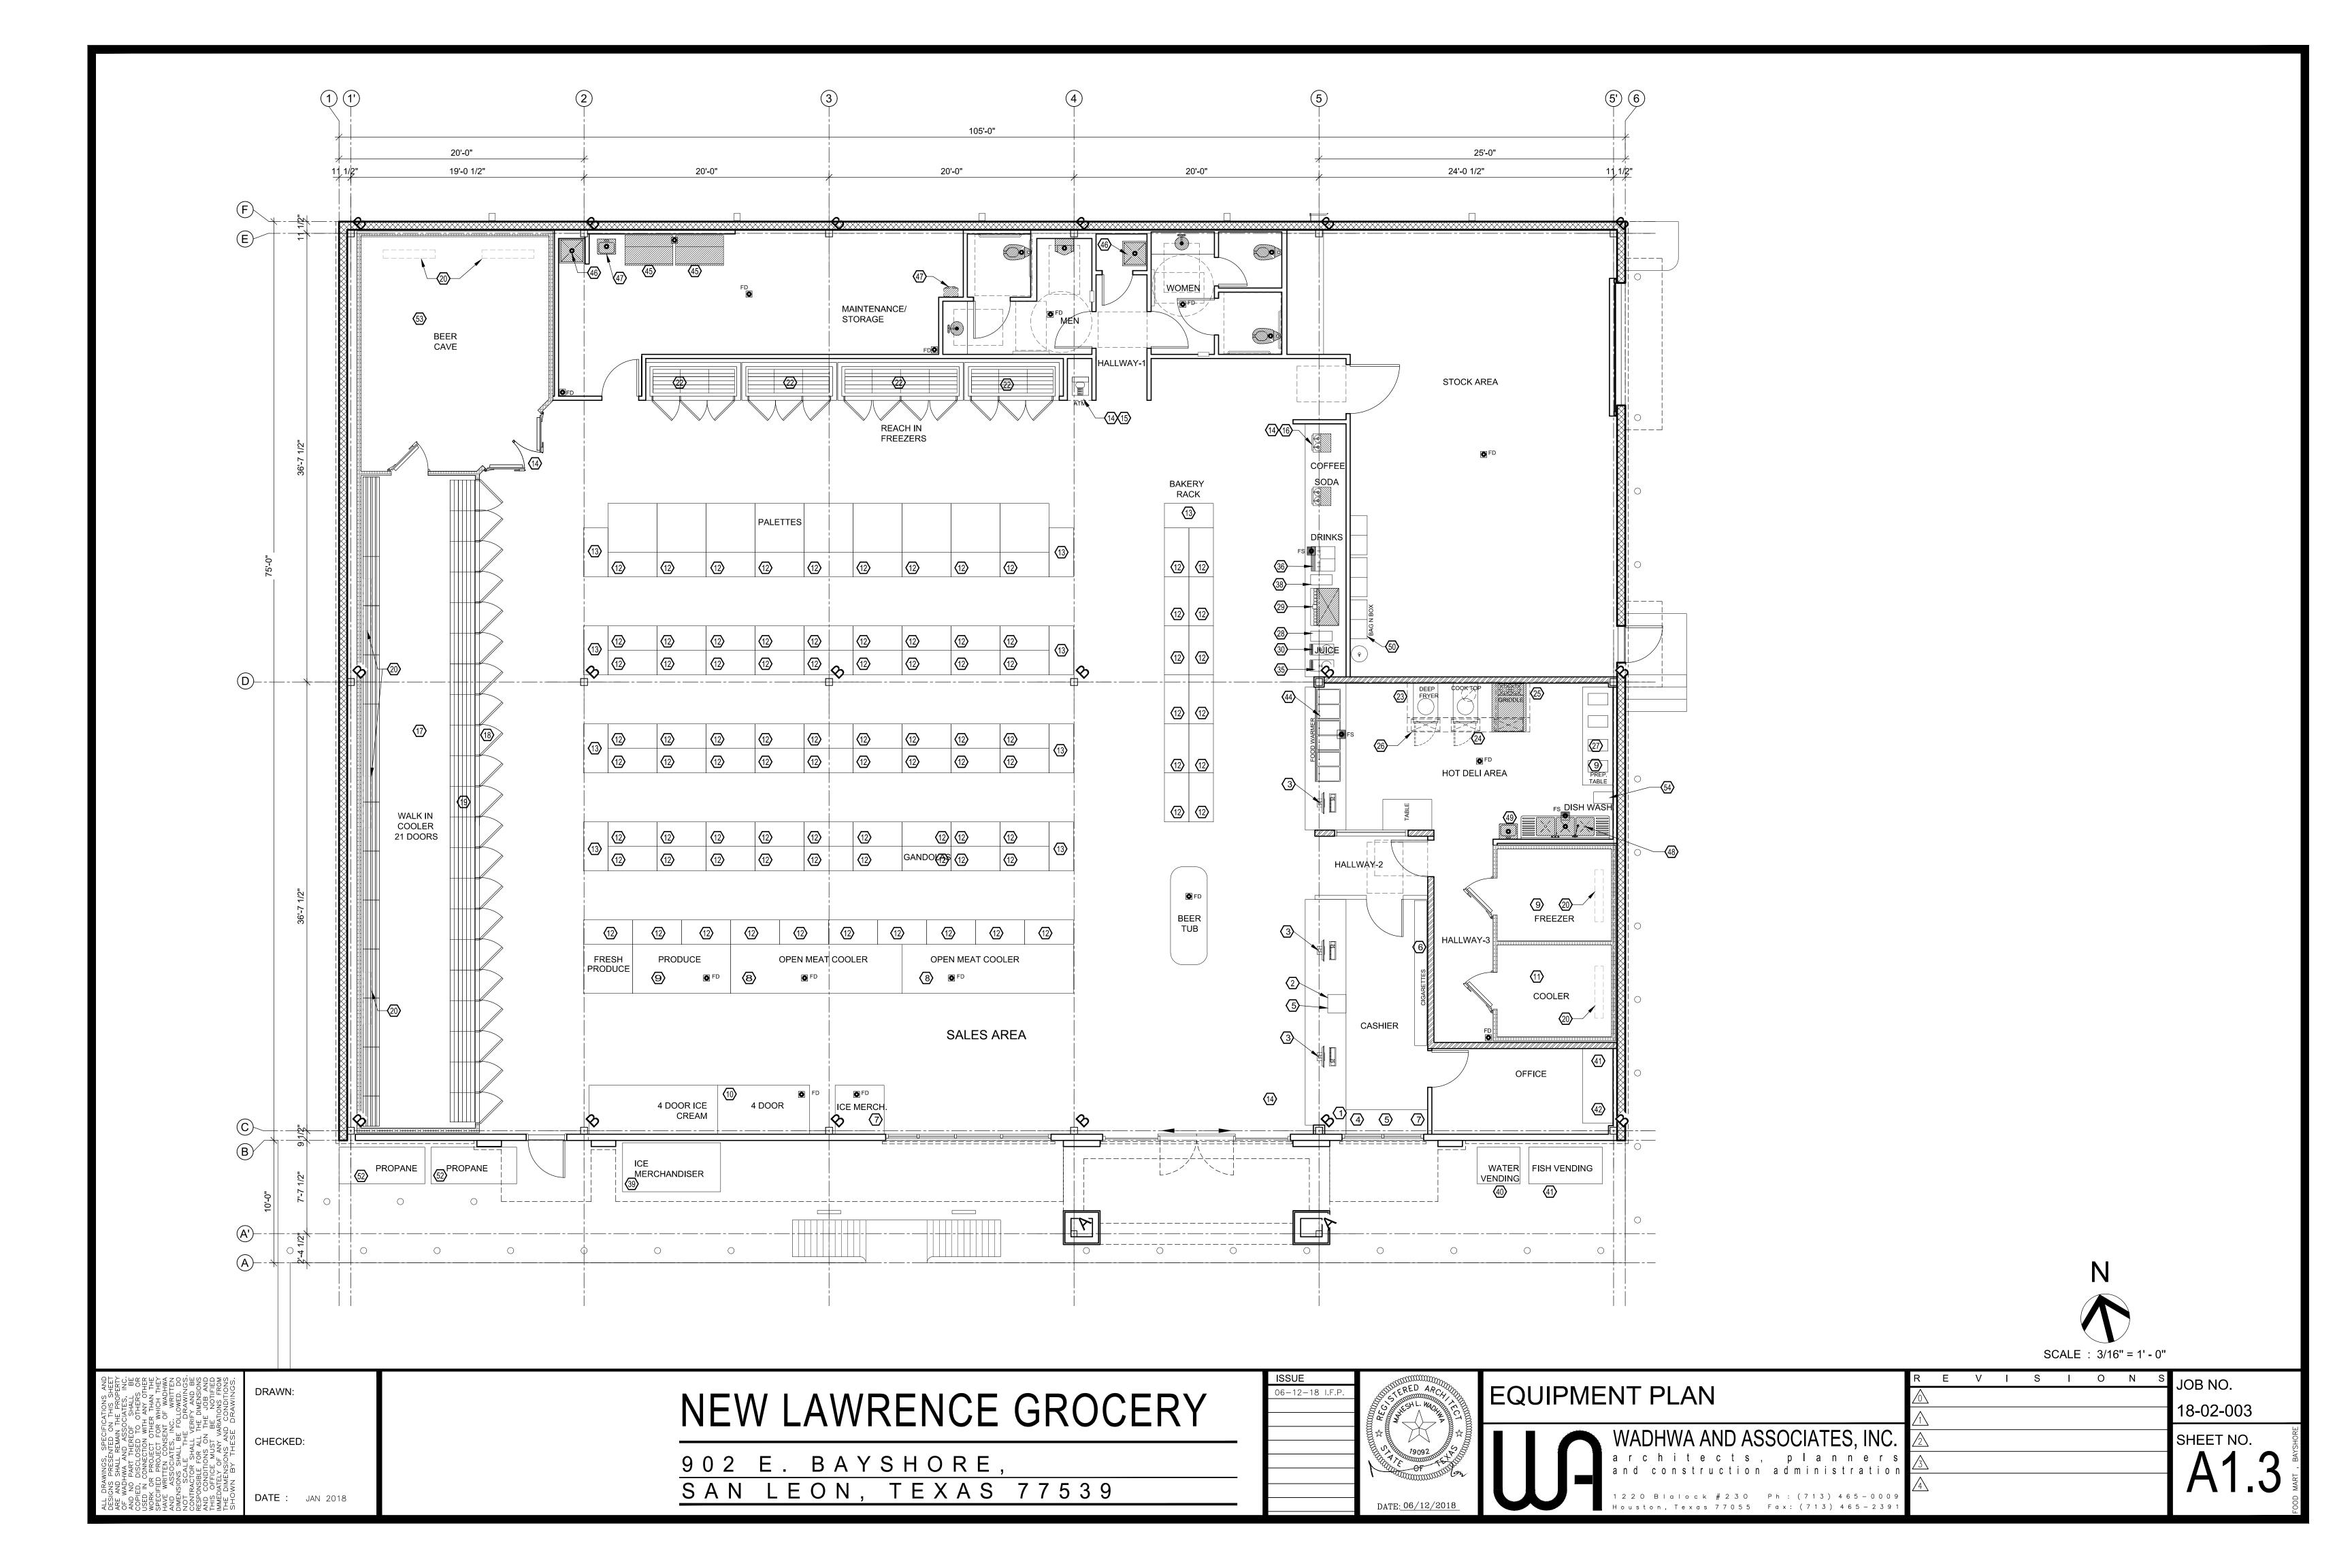

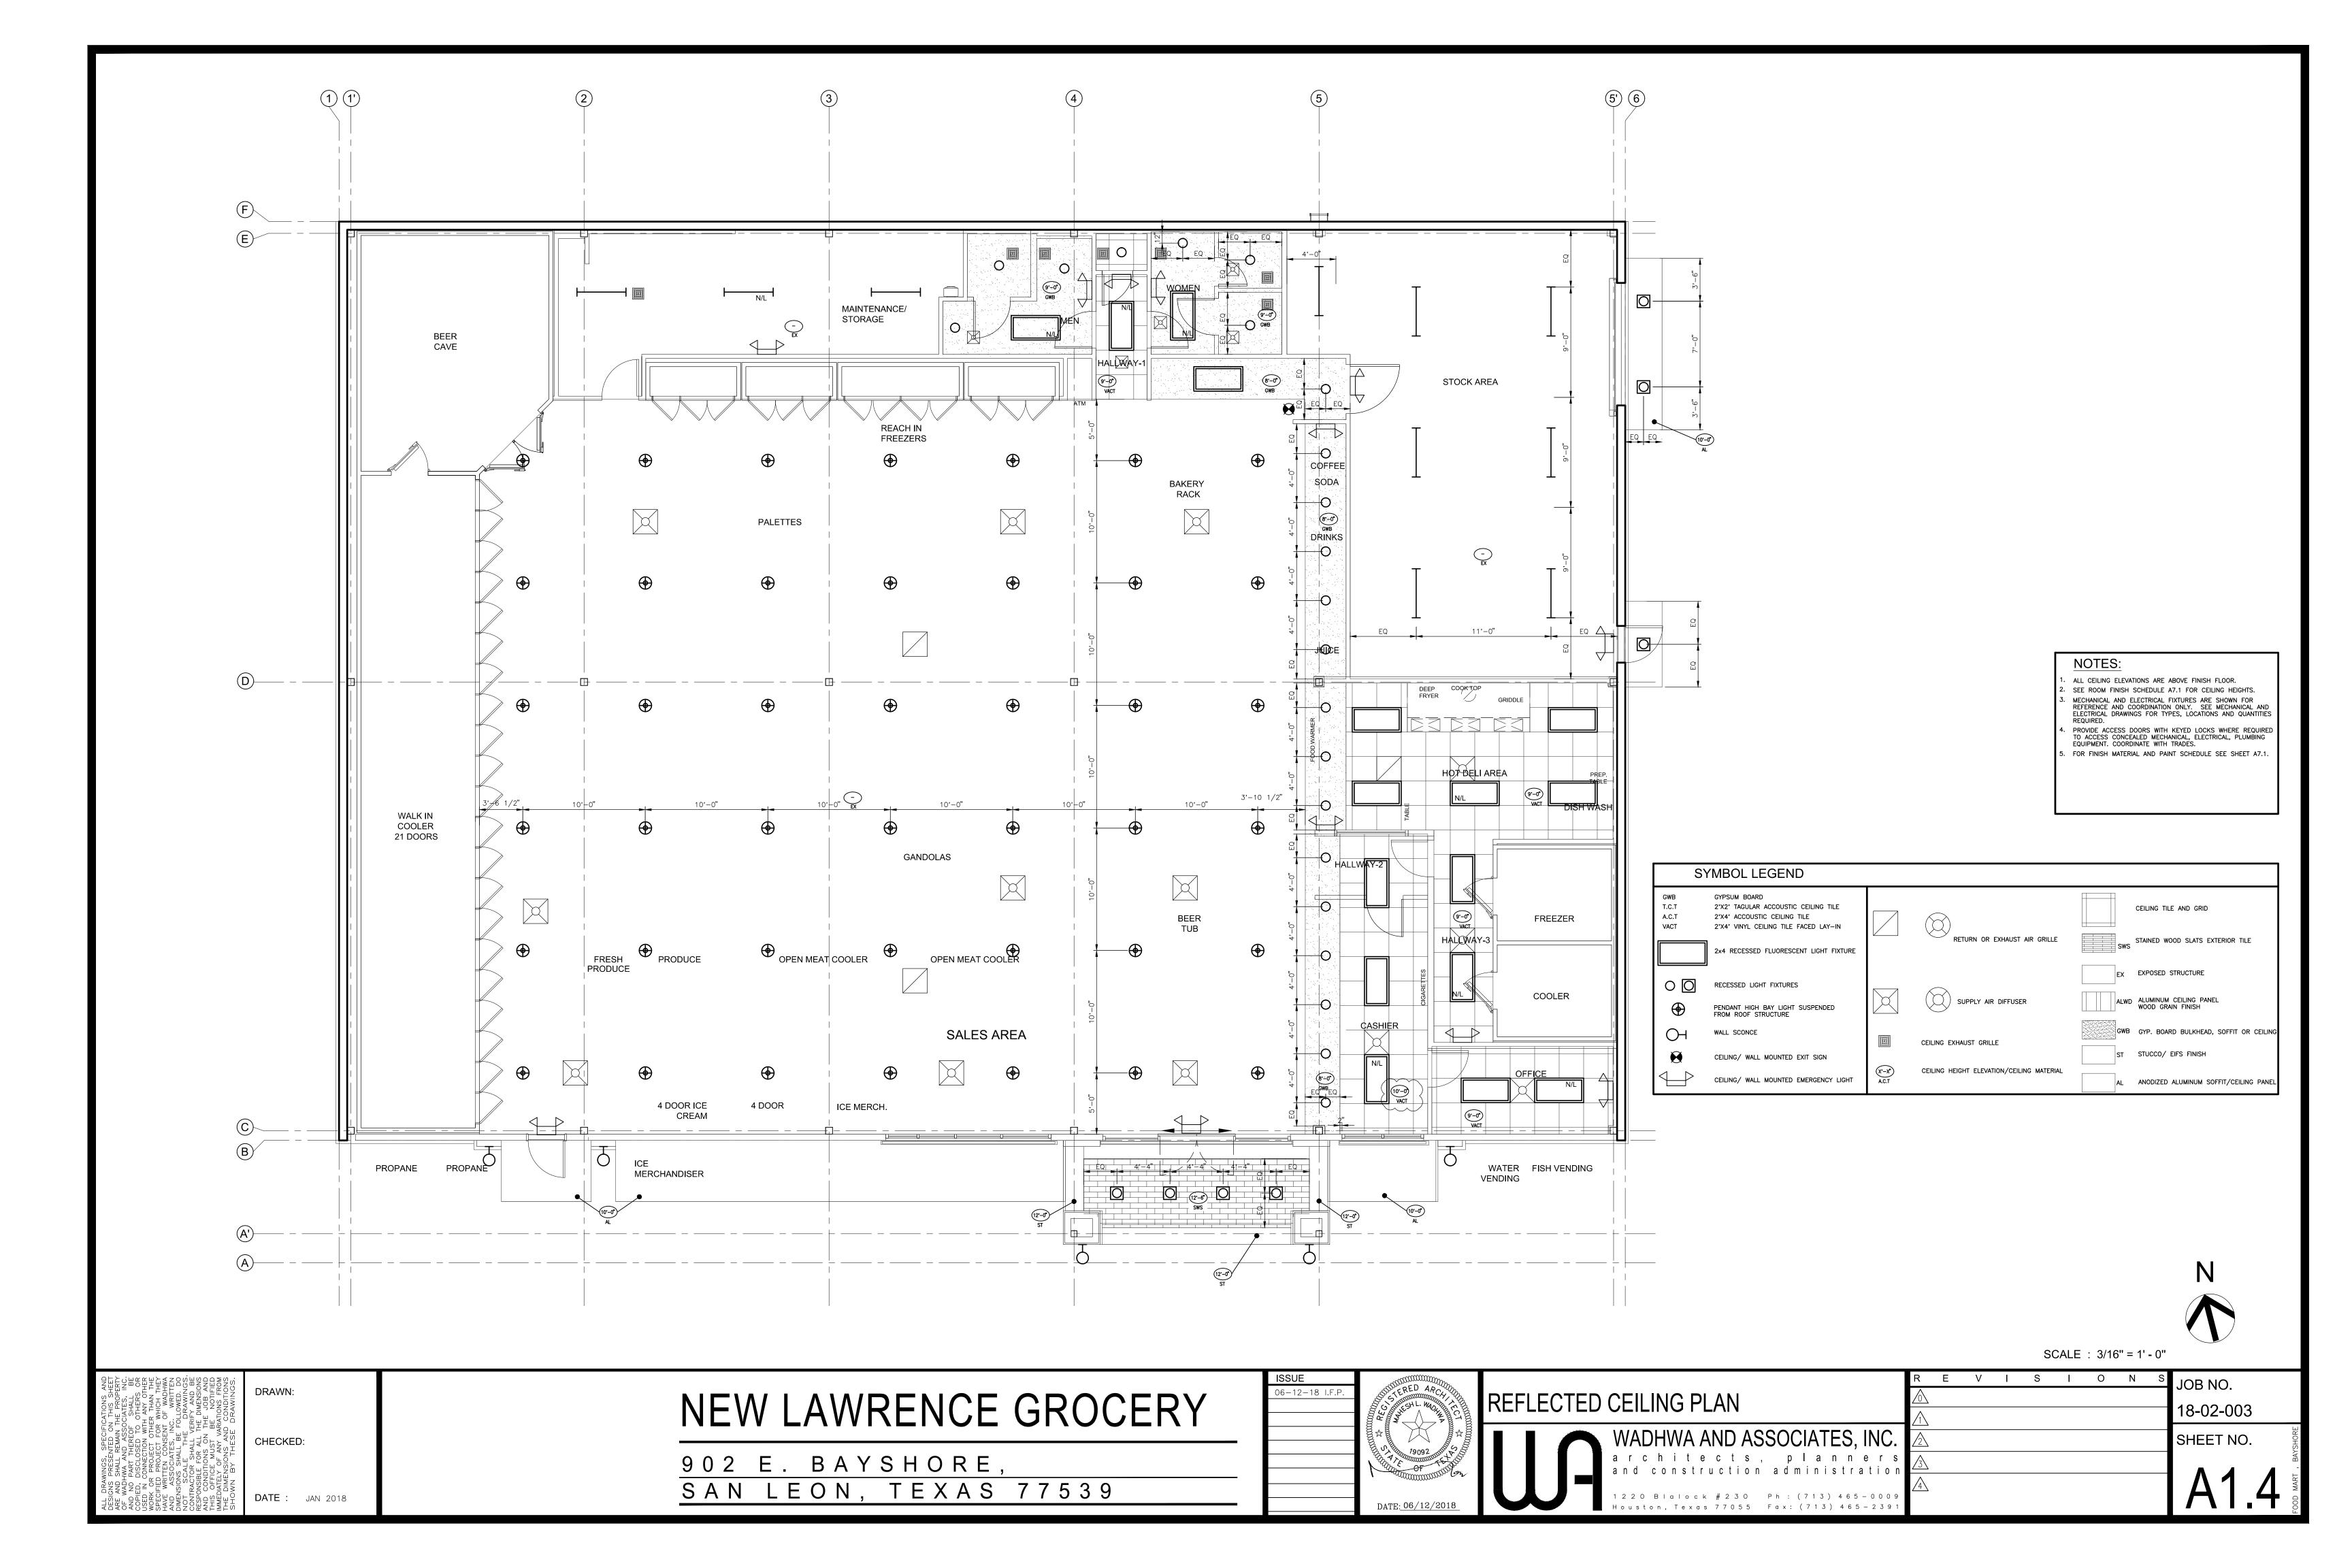

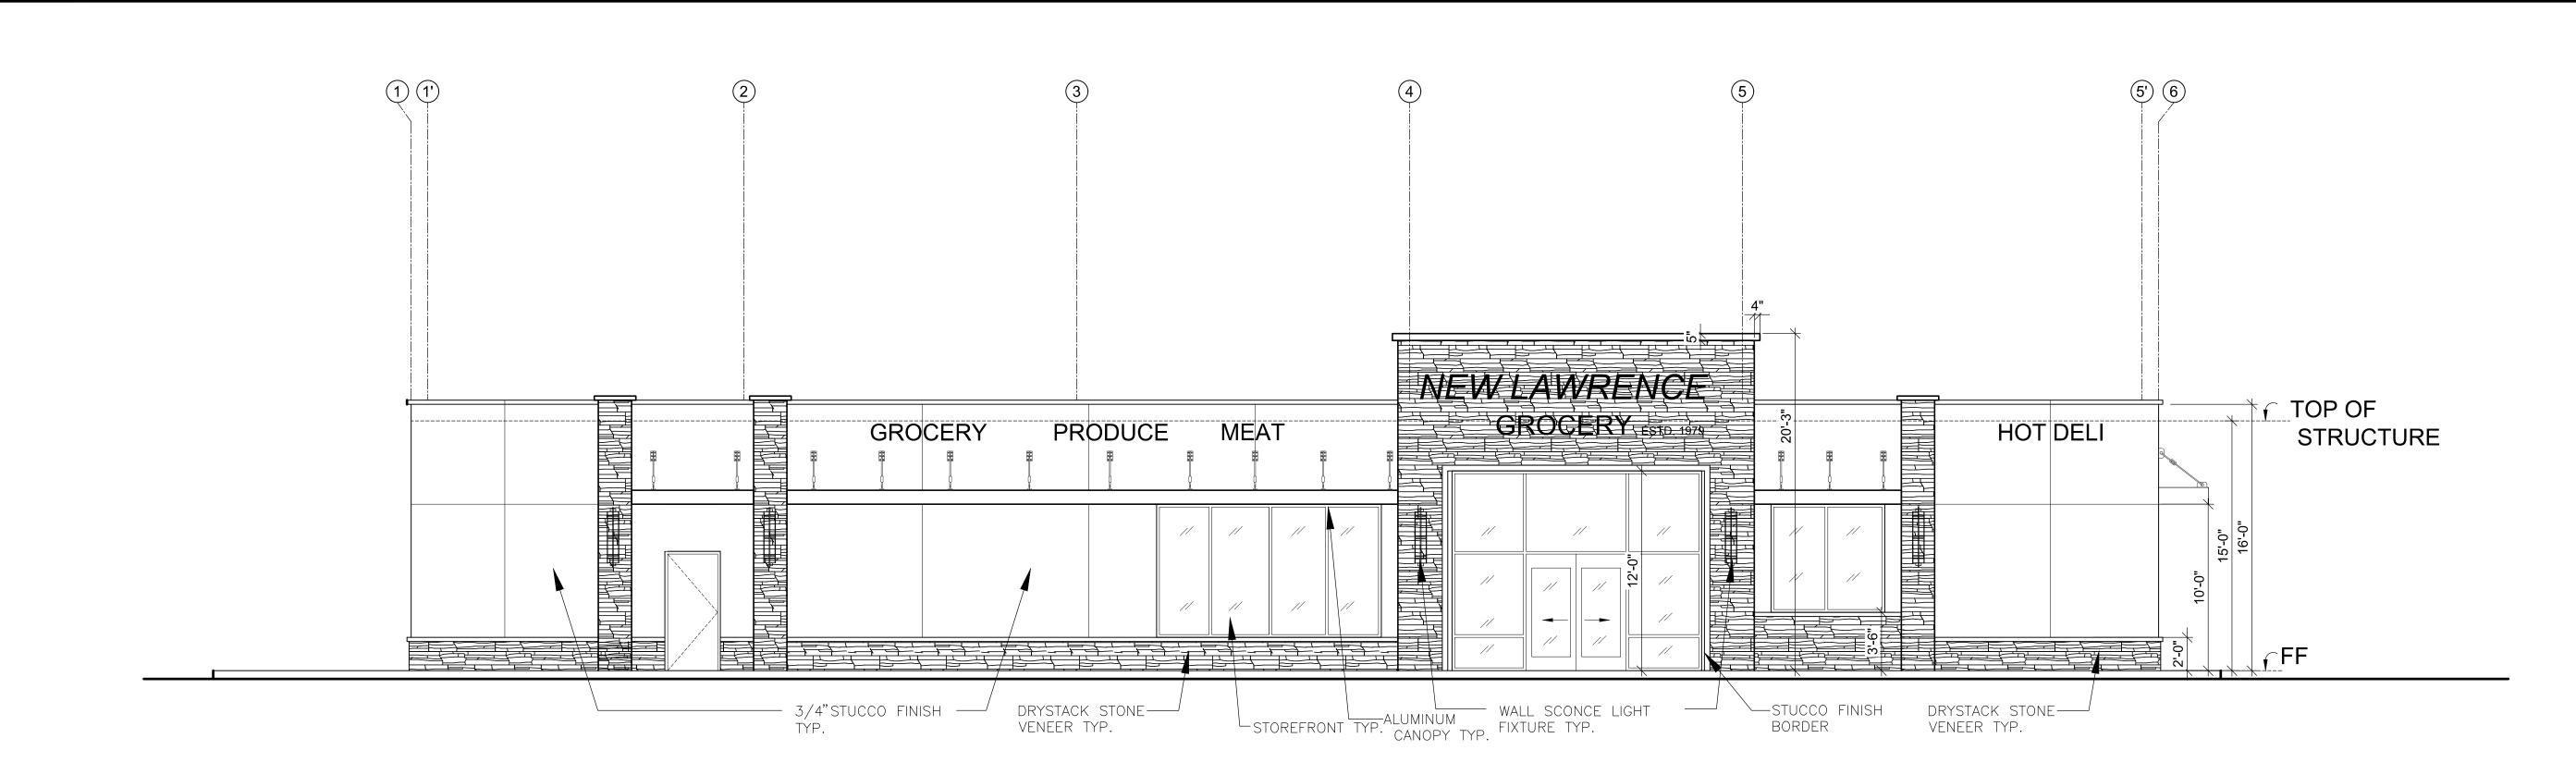


FRONT ELEVATION

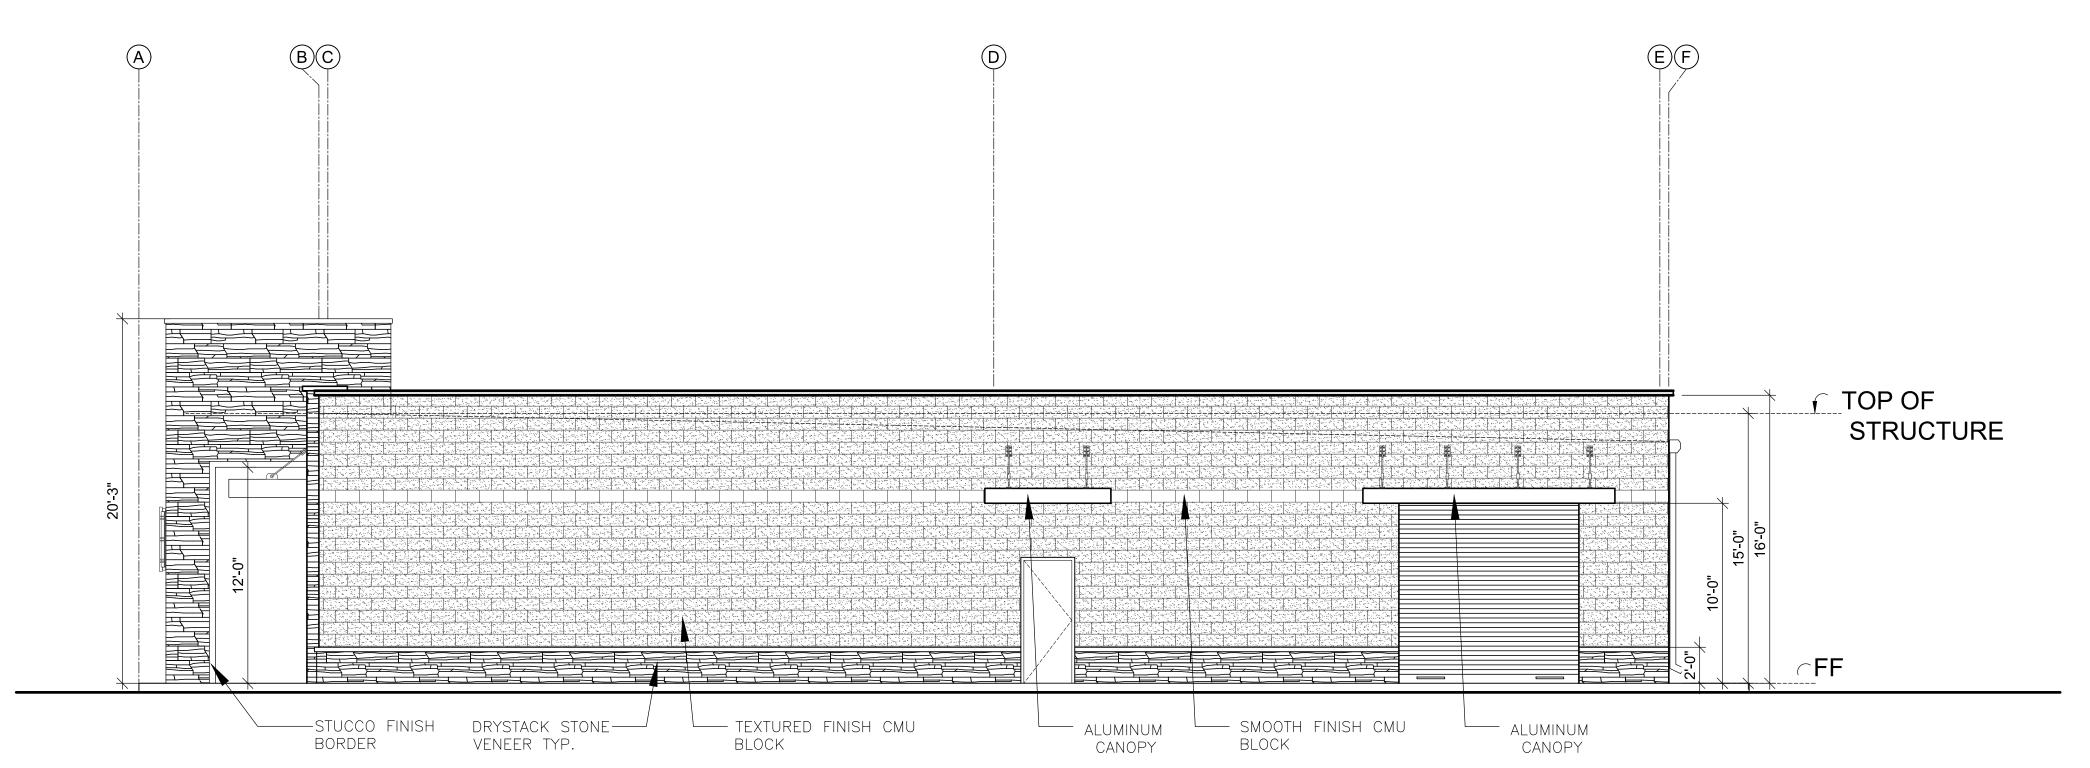


EAST ELEVATION


SCALE: 3/16" = 1' - 0"

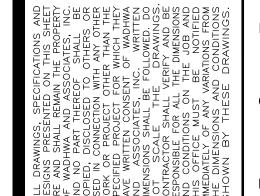


NEW LAWRENCE GROCERY


902 E. BAYSHORE, LEON, TEXAS 77539

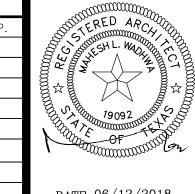

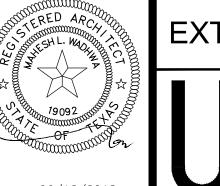


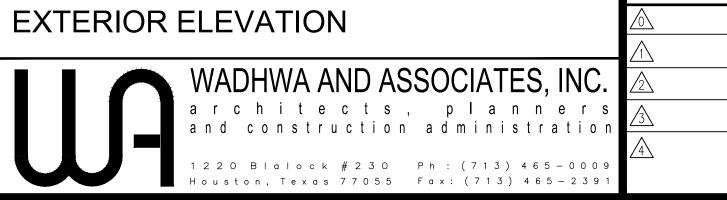

18-02-003

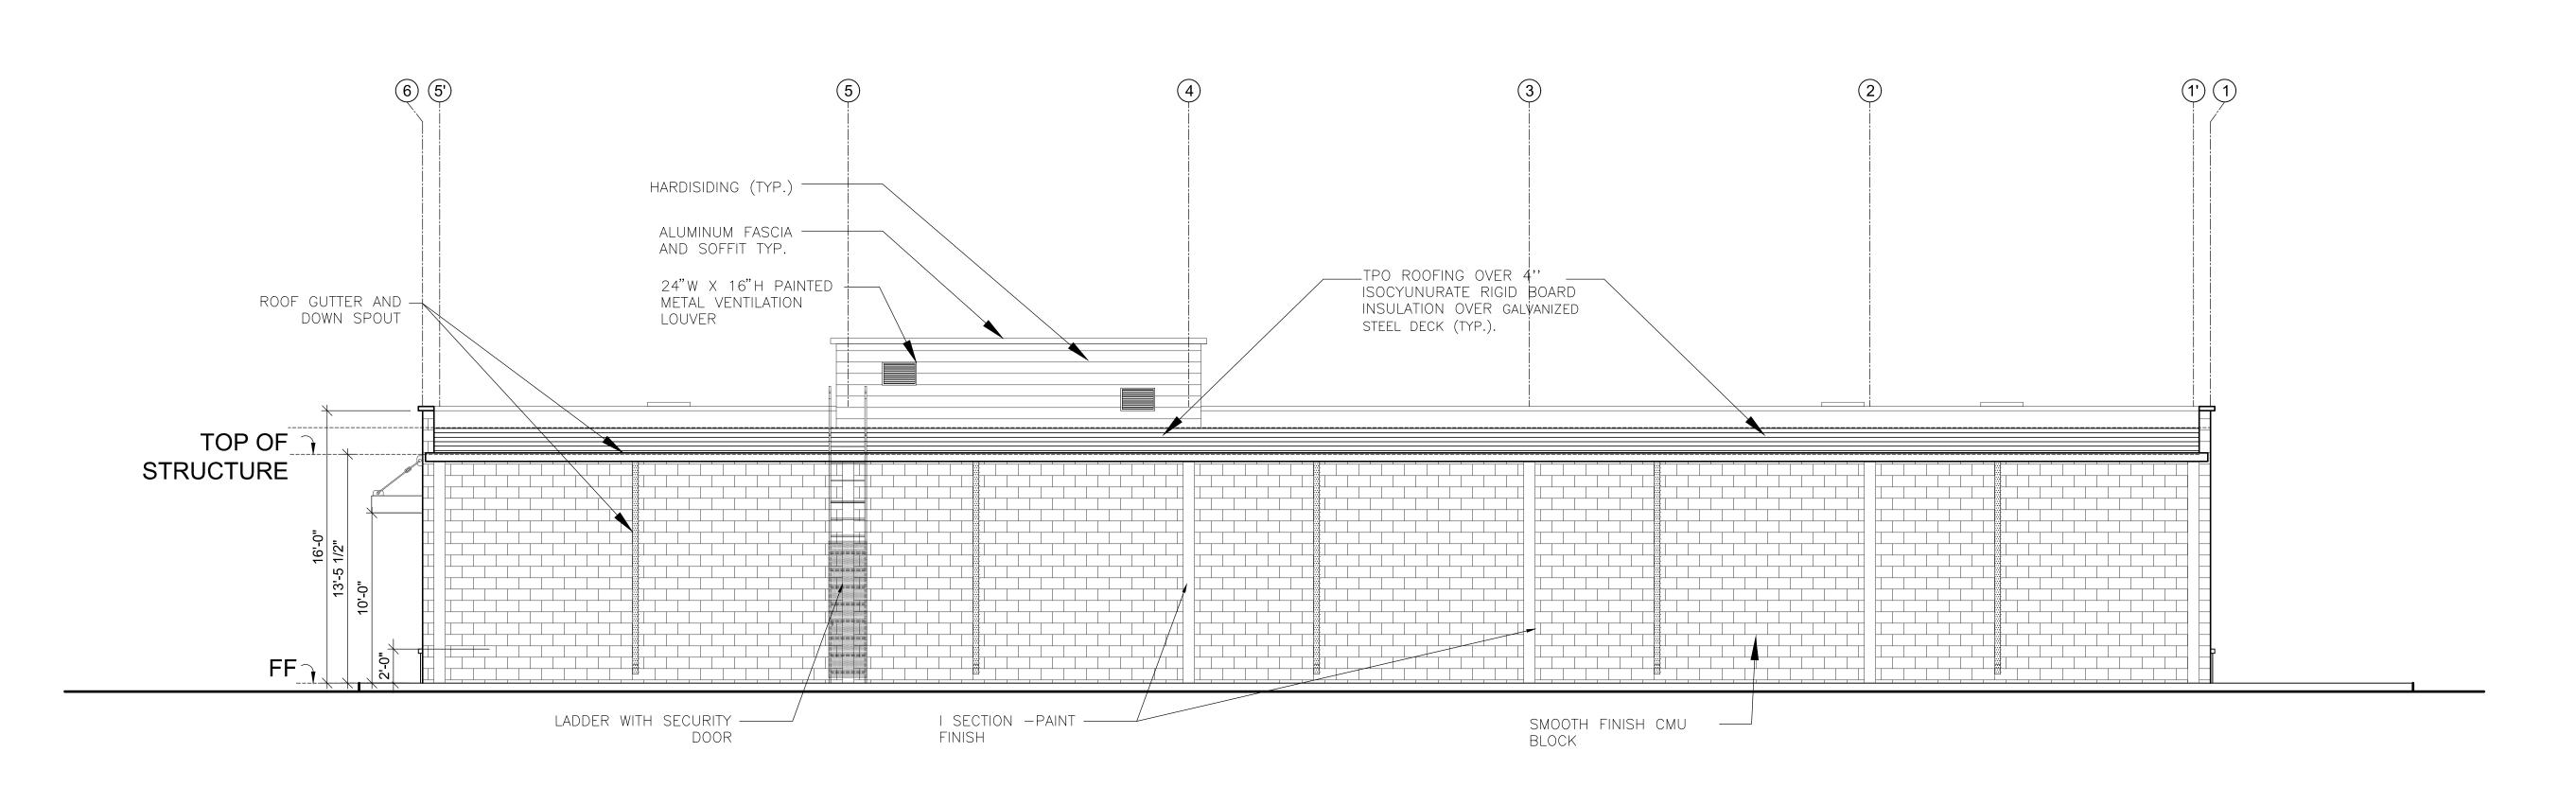


1 REAR ELEVATION

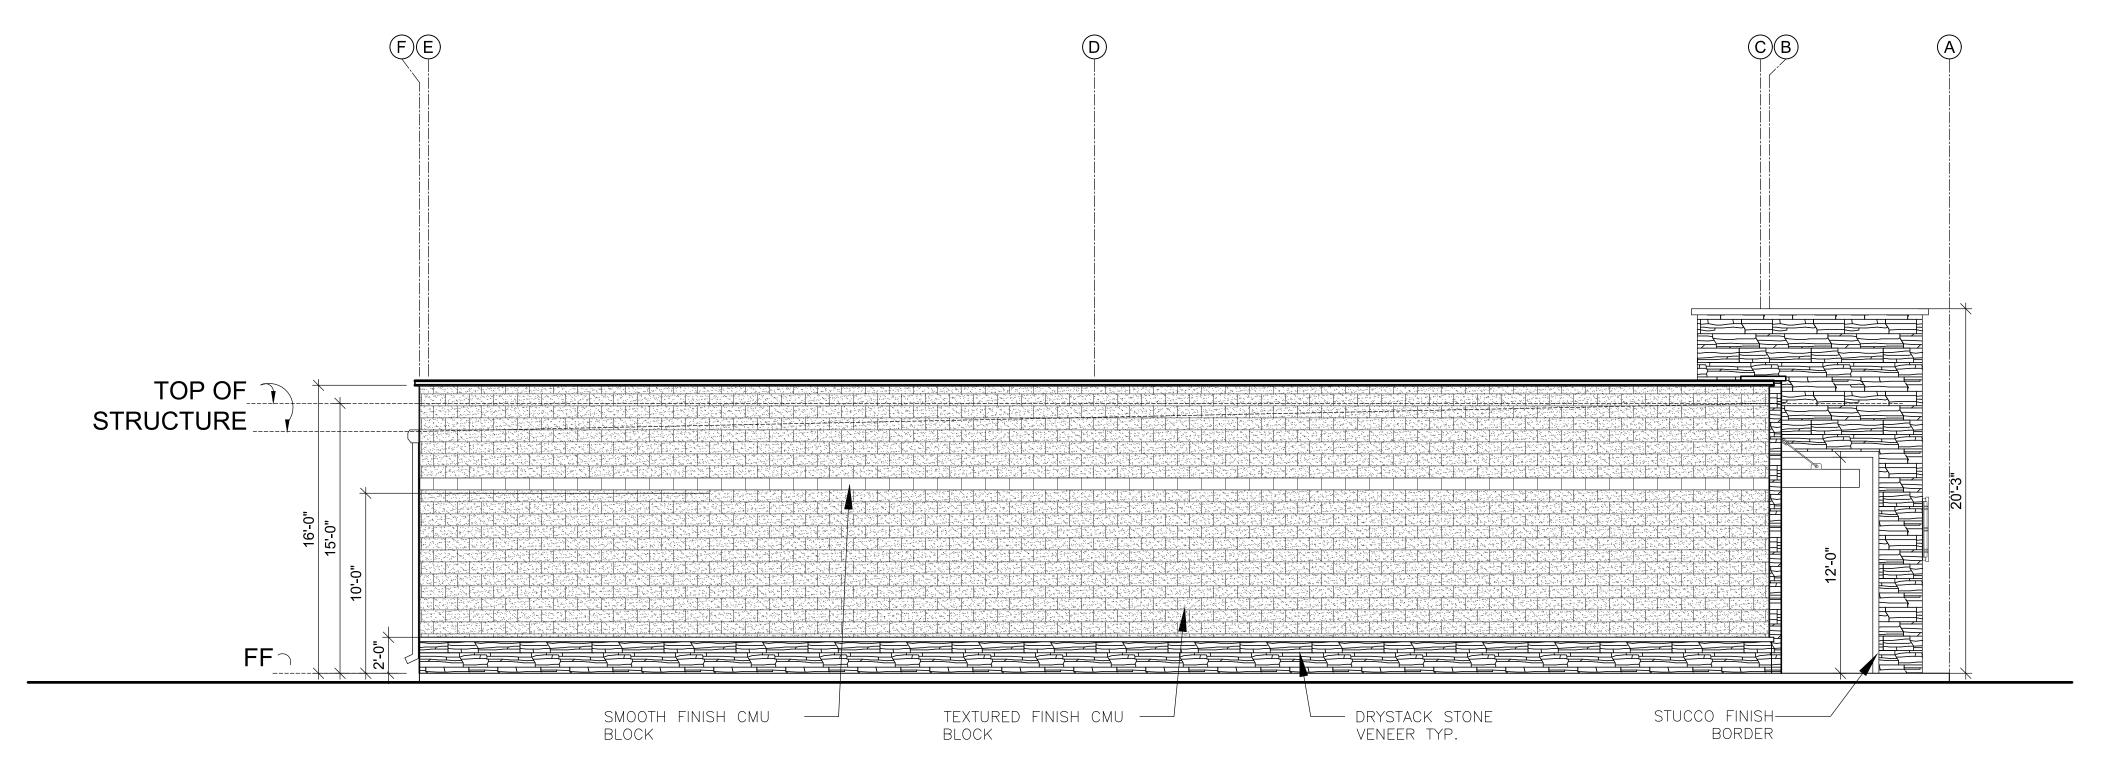


2 WEST ELEVATION

NEW LAWRENCE GROCERY

902 E. BAYSHORE, LEON, TEXAS 77539

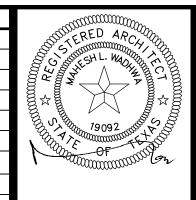


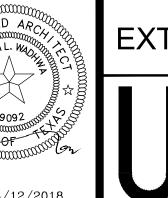





SCALE : 3/16" = 1' - 0"

18-02-003

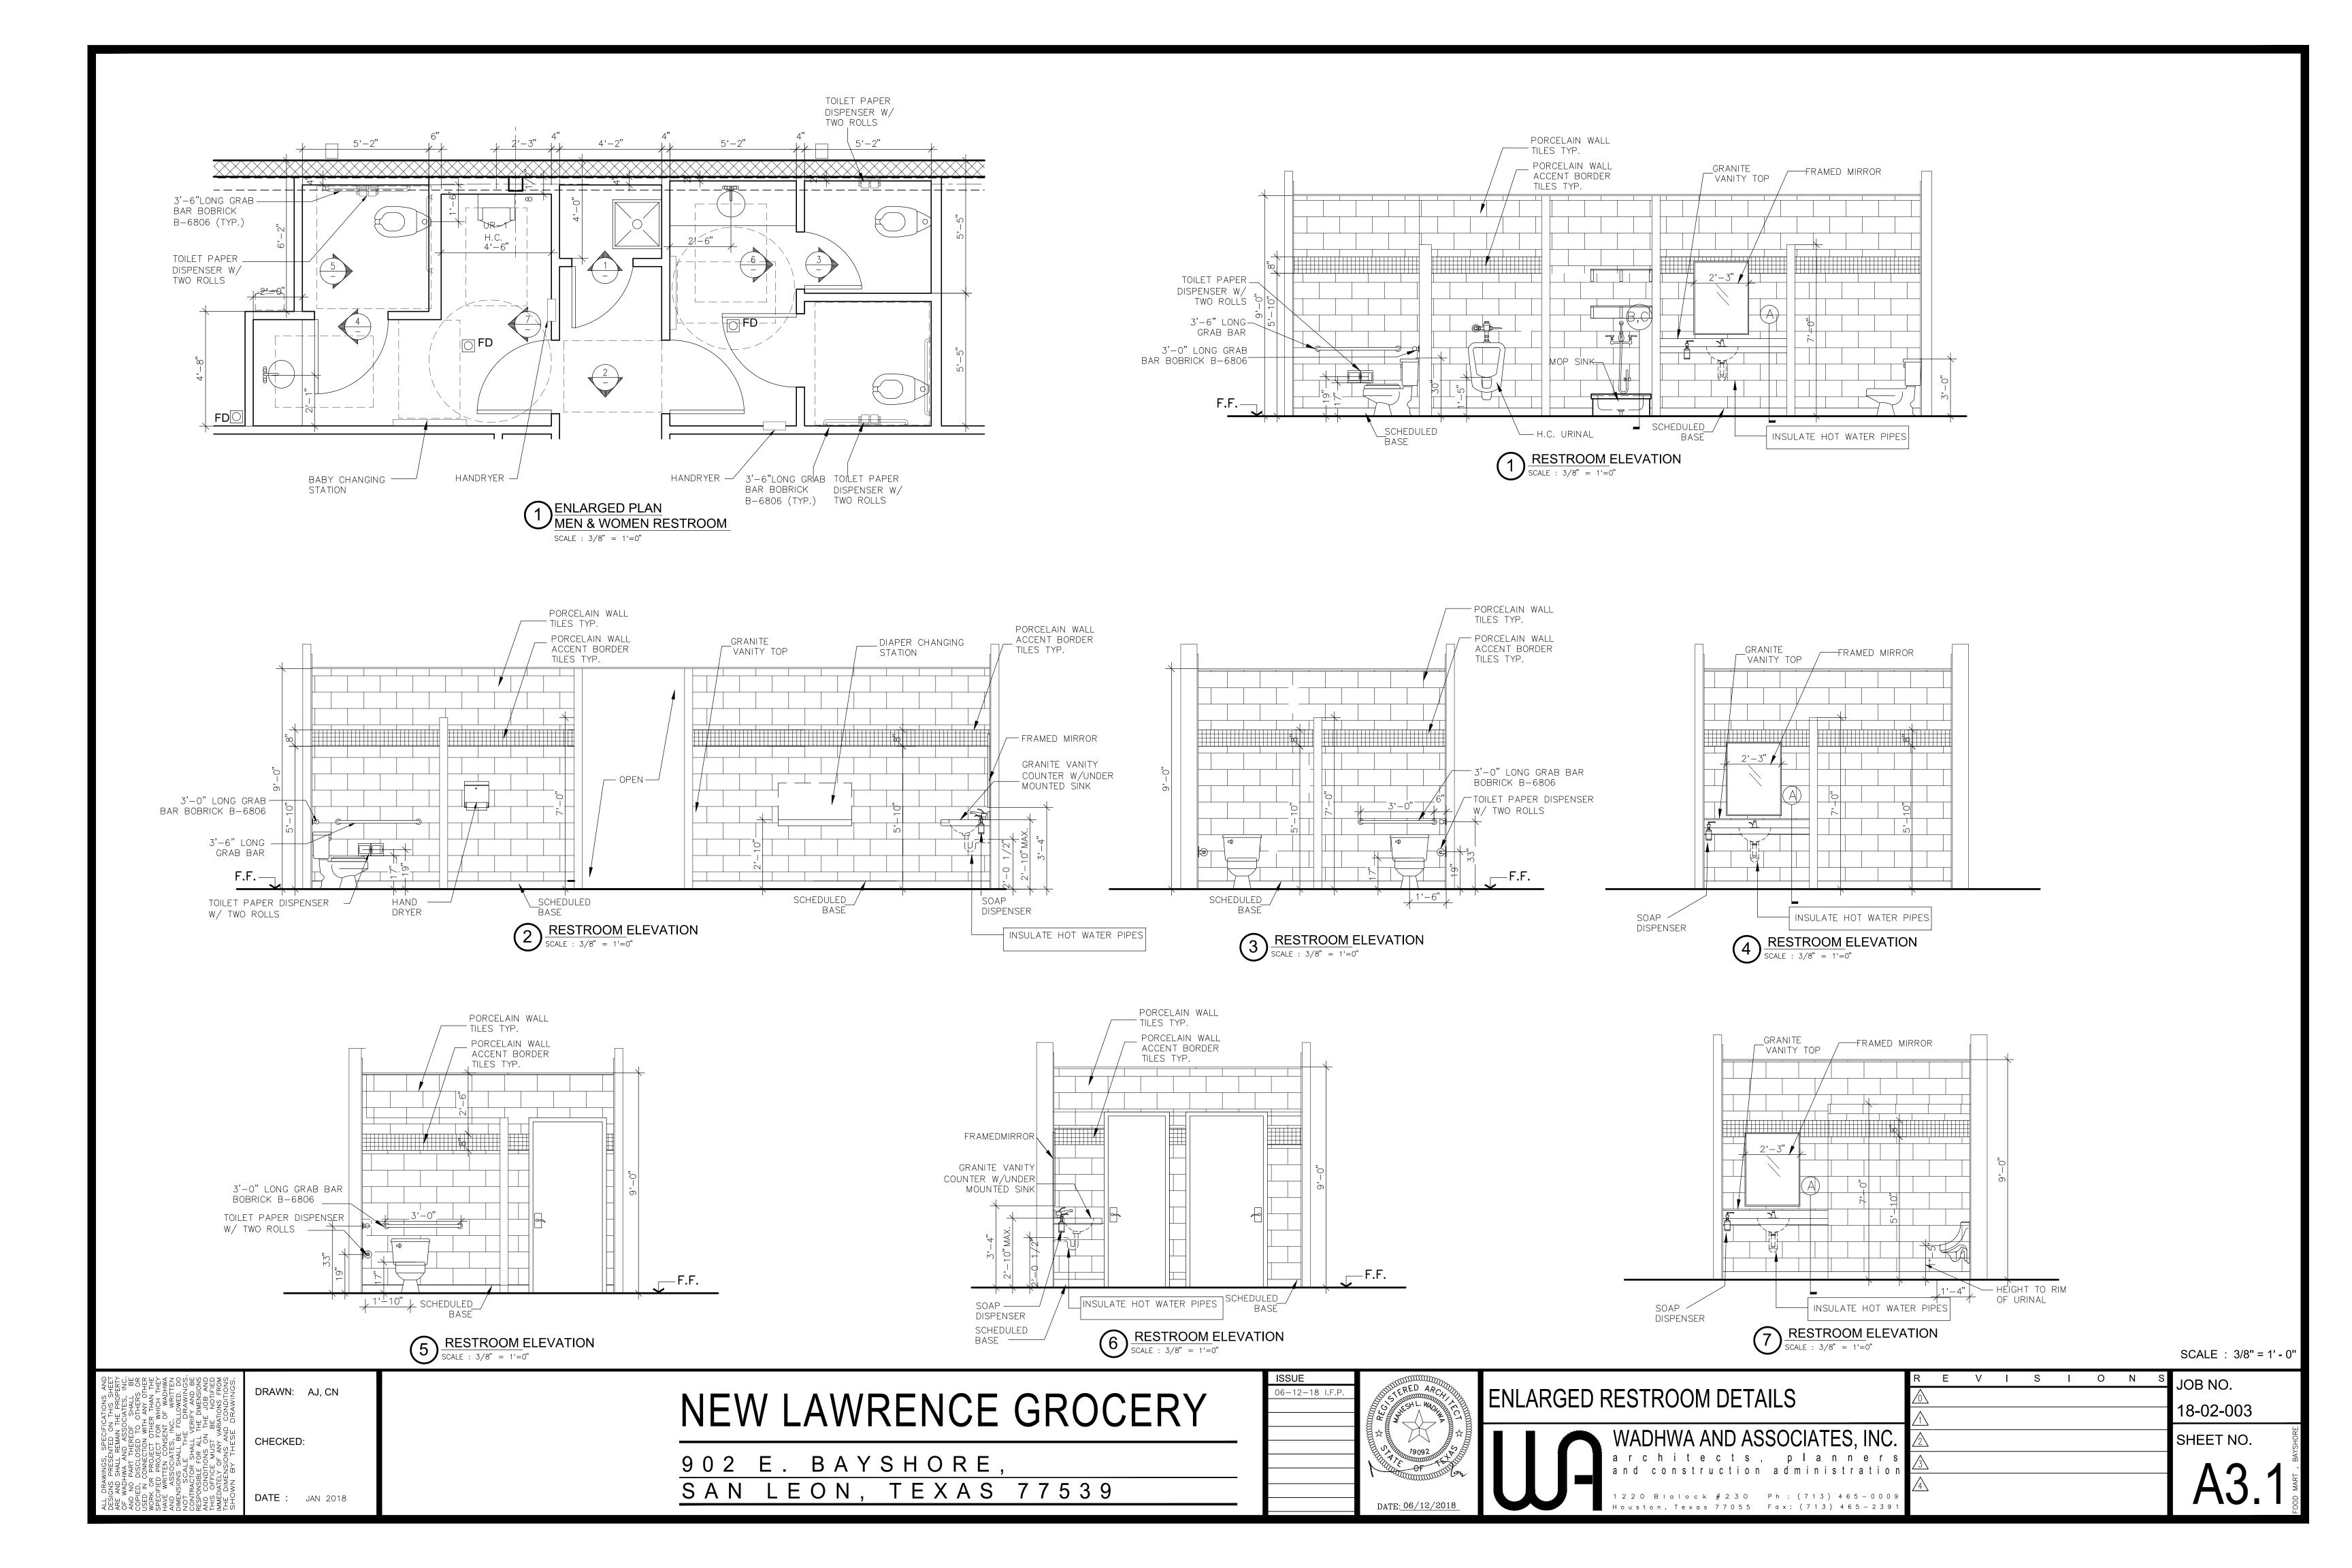


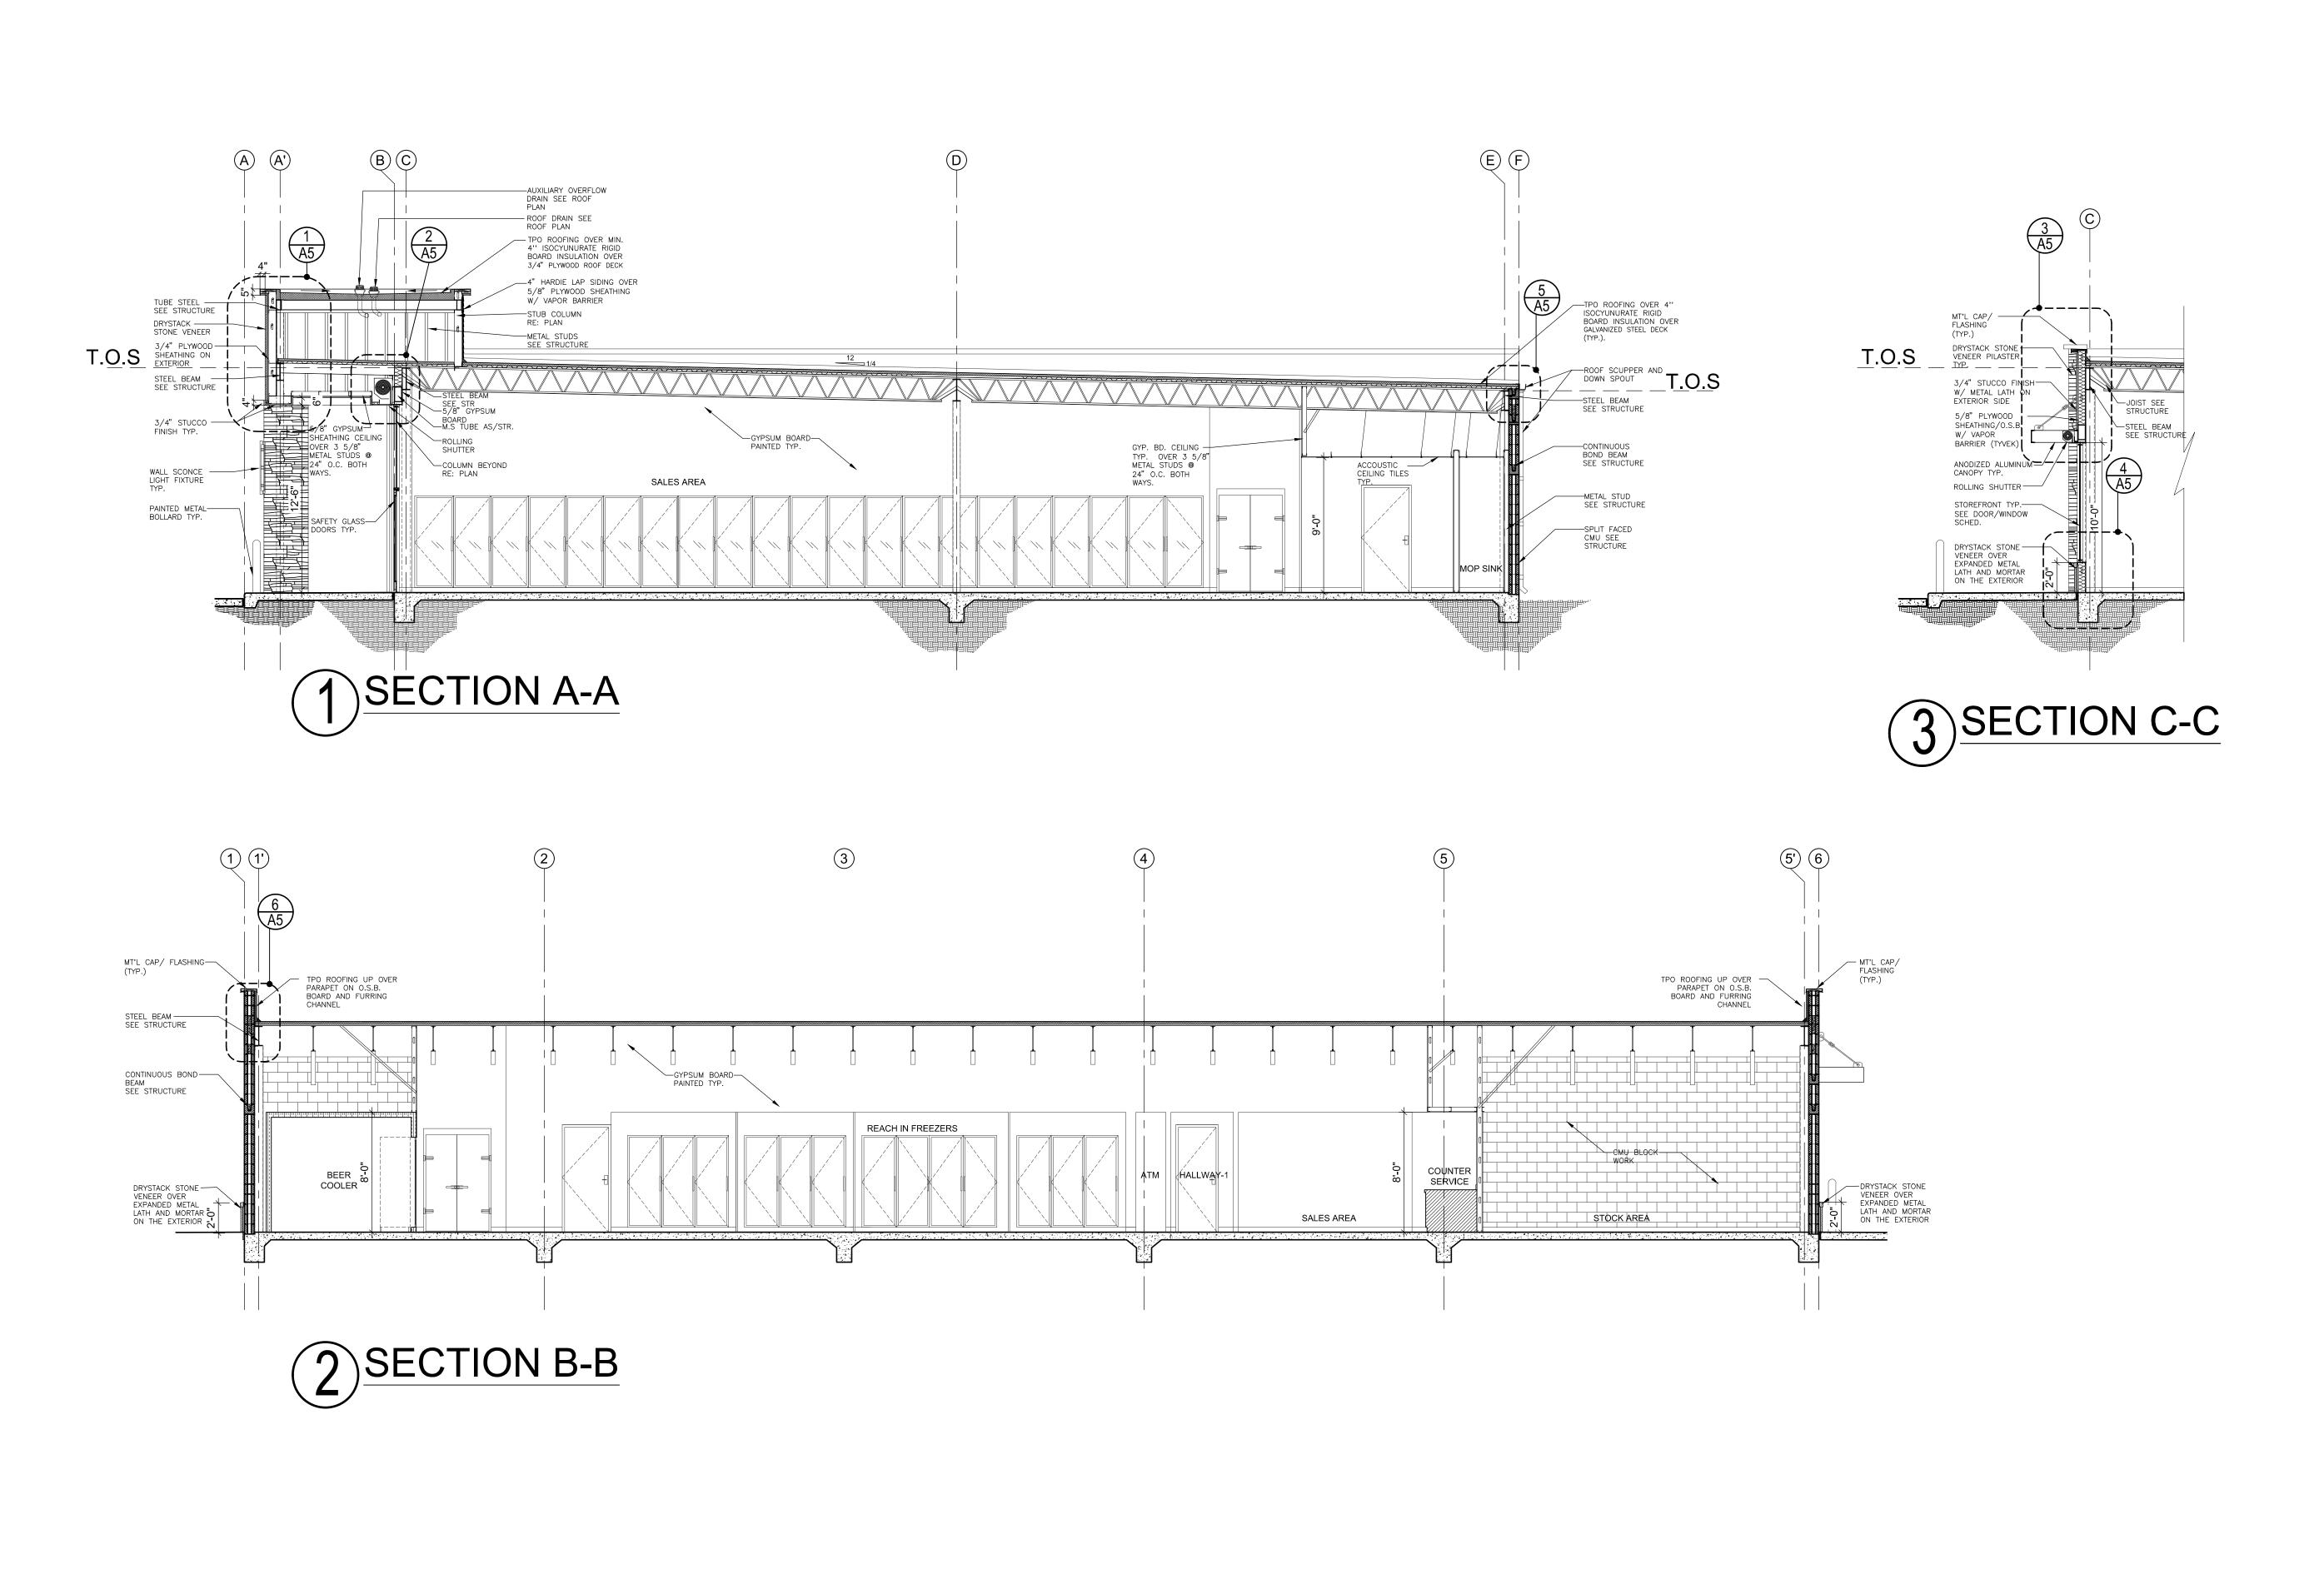

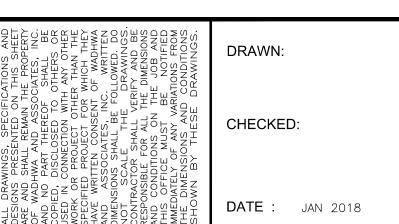

NEW LAWRENCE GROCERY

902 E. BAYSHORE, SAN LEON, TEXAS 77539

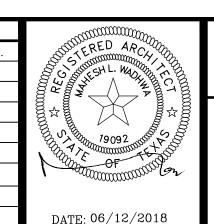





SCALE : 3/16" = 1' - 0"


N S
JOB NO.
18-02-003
SHEET NO.


<u>A4</u>

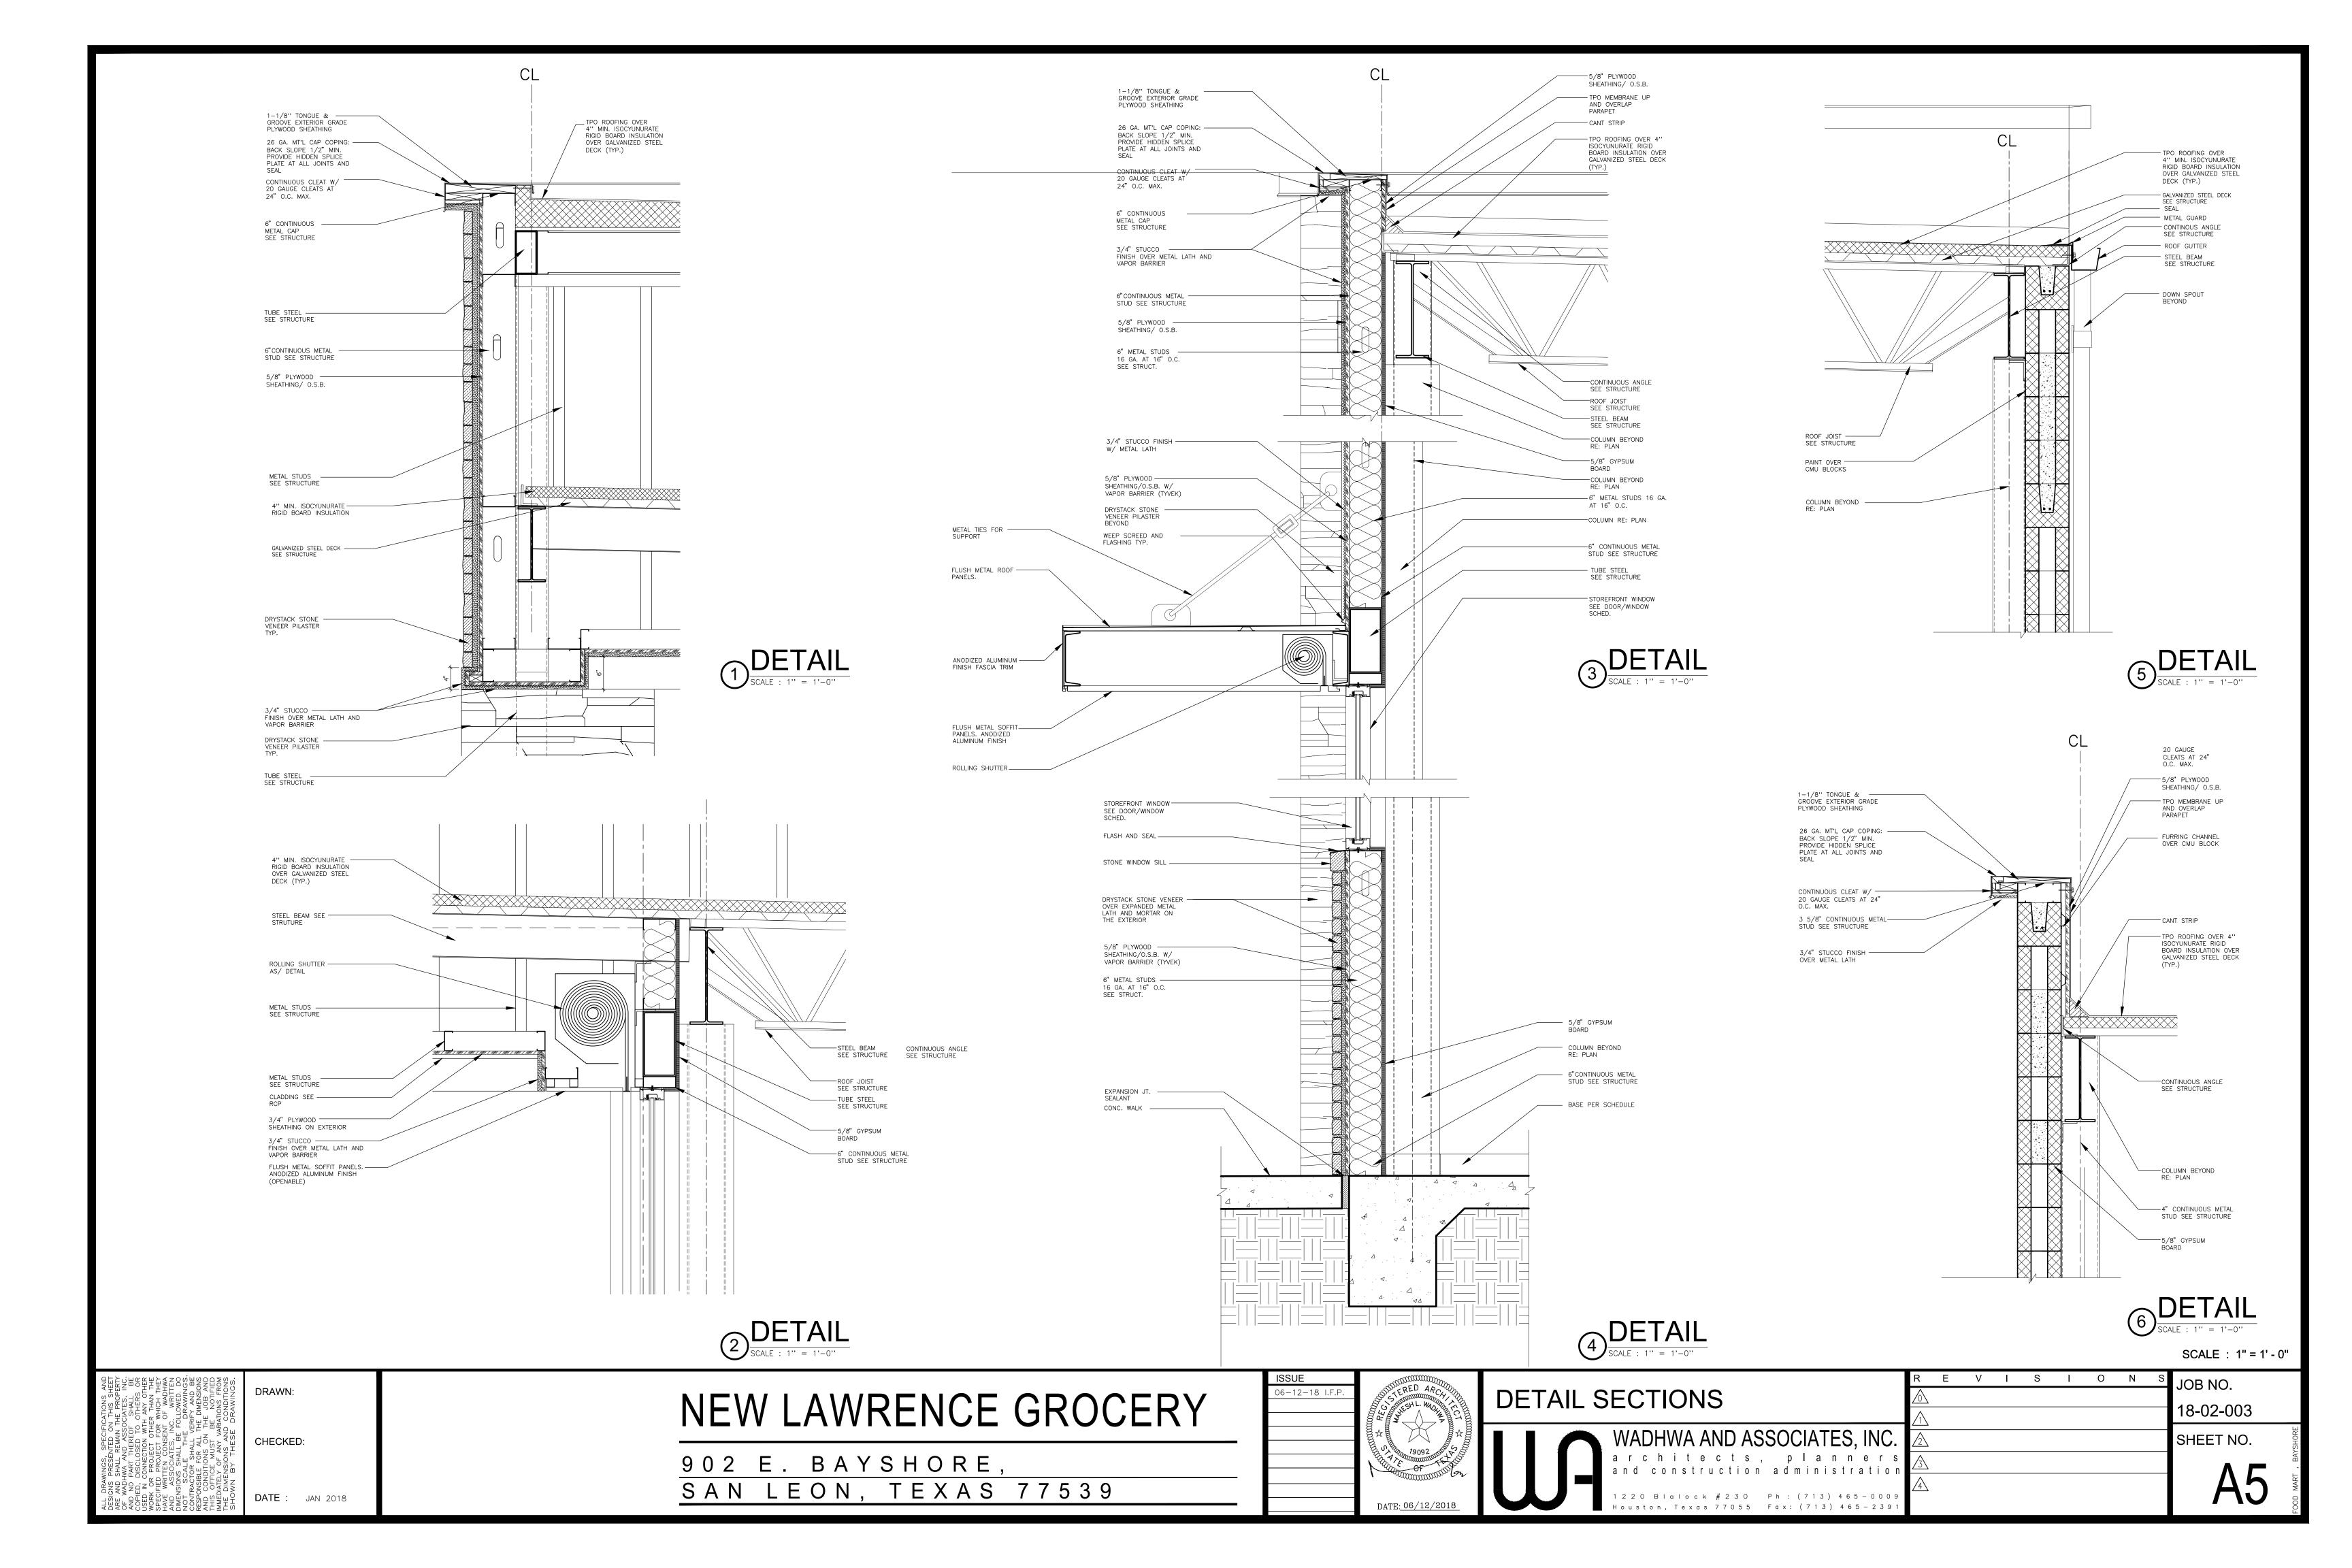



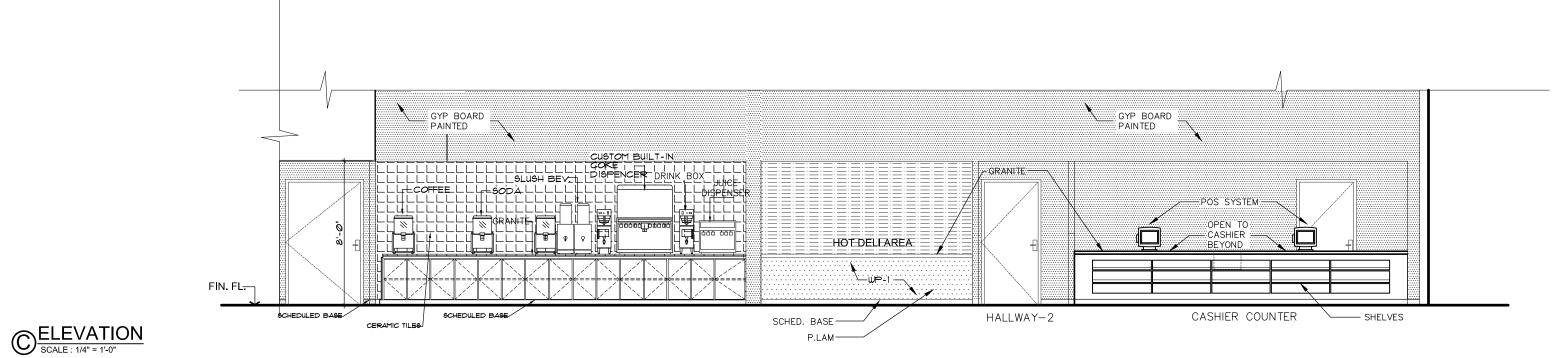


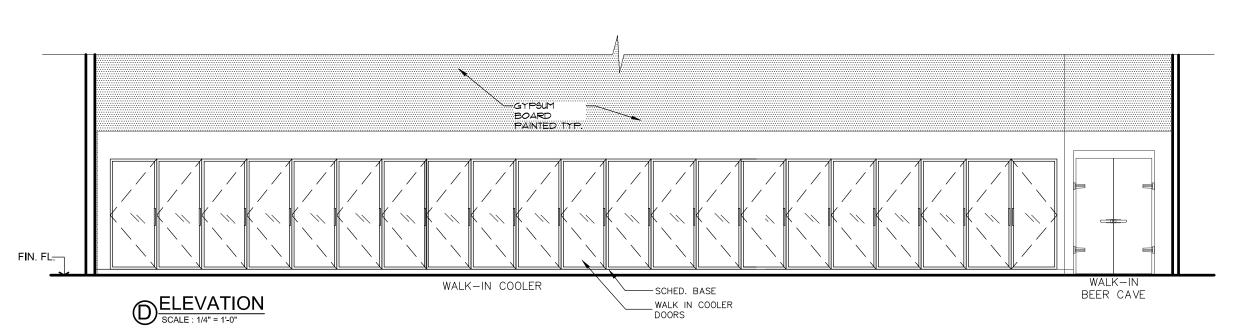


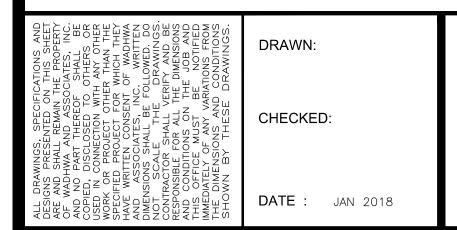



NEW LAWRENCE GROCERY


902 E. BAYSHORE, LEON, TEXAS 77539

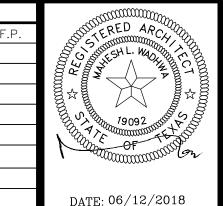


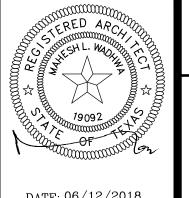

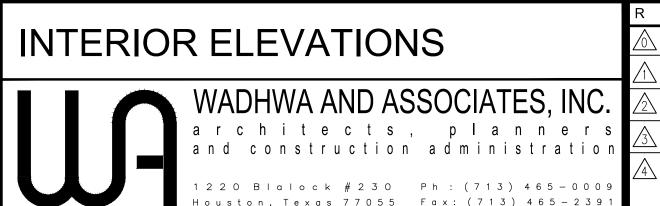


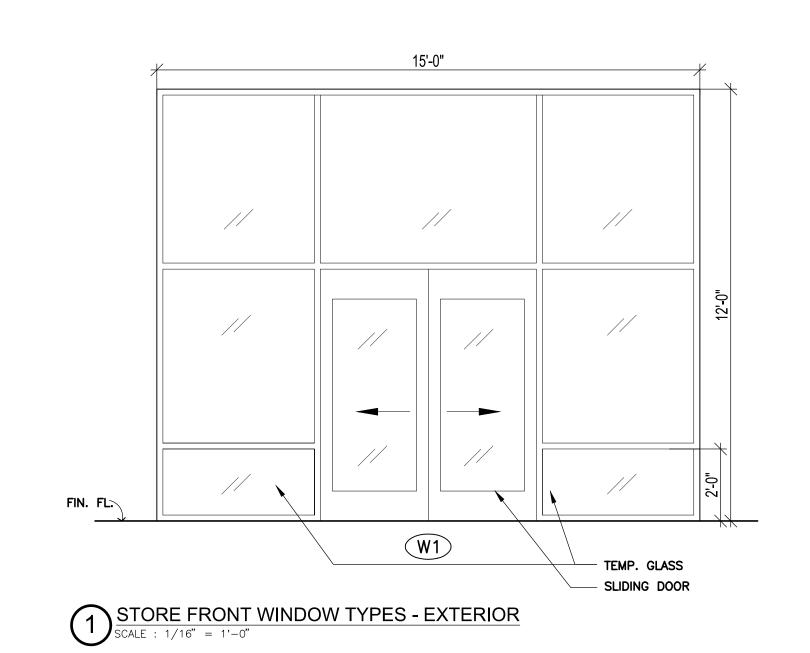

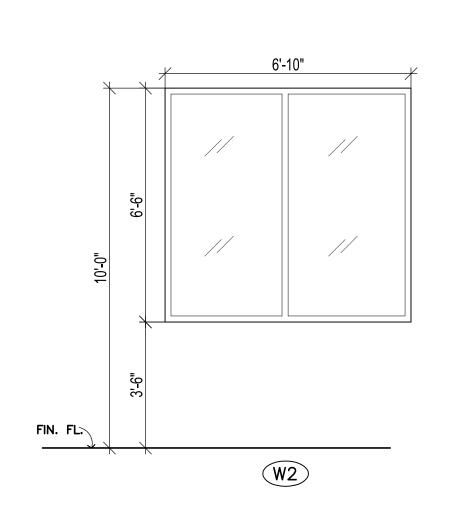

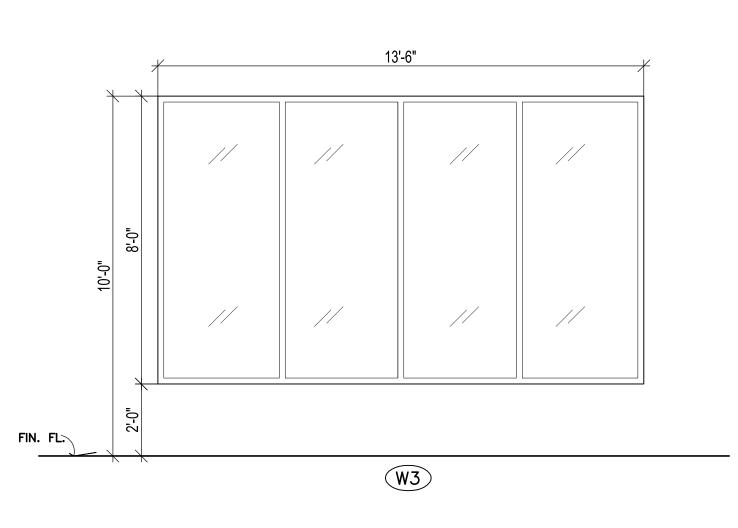



DOOR SCHEDULE FRAME HDWE. & REMARKS DESCRIPTION DOUBLE CYL. LOCK, CLOSER, STOP, STD. HDWE. GLASS DOOR PR -3'-0" X 7'-0" ALUMINIUM (LABEL ON DOOR "THIS DOOR SHALL REMAIN UNLOCKED ANODIZED NARROW STYLE DURING BUSINESS HOURS") SLIDING DOOR -PR. 3'X 7' ALUMINIUM STORE FRONT SLIDING GLASS DOOR AUTOMATIC GLASS DOOR PR -3'-0" X 9'-0" ALUMINIUM NARROW STYLE ANODIZED HARDWARE BY MANUFACTURE WELDED STEEL STD.HDWE., THRESHOLD, WEATHERSTRIP, CLOSER 3'-0"X7'-0"X1 3/4" HM DOOR 20 GA. PAINTED BOTT. SWEEP & HEAD DRIP TRIM W/ PANIC HDWE. BY A.J. AMERICAN DOOR STD.HDWE., THRESHOLD, WEATHERSTRIP, CLOSER 4'-0"X7'-0"X1 3/4" HM DOOR 20 GA. PAINTED STEEL BOTT. SWEEP & HEAD DRIP TRIM W/ PANIC HDWE. S.C WOOD DOOR PLASTIC LEVER LOCK SET, STOP, STD. HDWE., CLOSER 4'-0"X7'-0"X1 3/4" LAMINATE FINISH UNDER CUT 1" WELDED 2'-6"X5'-0"X1 3/4" |PTD WOOD LOUVERED DOOR LEVER PRIVACY LOCK SET, STOP, ROBE HOOKS. STEEL LEVER PRIVACY LOCK SET (ADA APPVD.), CLOSER, STOP, 3'-0"X5'-0"X1 3/4" PTD WOOD LOUVERED DOOR ROBE HOOKS. H.C. ACCESS SYMBOL "MEN" / "WOMEN", S.C WOOD DOOR PLASTIC LEVER LOCK SET, STOP, STD. HDWE., CLOSER, S.S. KICK 3'-0"X7'-0"X1 3/4" LAMINATE FINISH PLATE ,UNDER CUT 1" S.C WOOD DOOR PLASTIC 3'-0"X7'-0"X1 3/4" LEVER LOCK SET, STOP, STD. HDWE., 4 X 24 GLASS PANEL, CLOSER, ST. STL KICK PLATE LAMINATE FINISH LEVER LOCK SET, STOP, STD. HDWE., ST. STL KICK 3'-0"X7'-0"X1 3/4" | S.C | WOOD DOOR PAINTED STEEL STD.HDWE., THRESHOLD, WEATHERSTRIP, BOTT. SWEEP 3'-0"X7'-0"X1 3/4" HM DOOR 20 GA. PAINTED & HEAD DRIP TRIM. PROVIDE 24"W X 16"H LOUVERS BY A.J. AMERICAN DOOR LATCH SET, STD. HARDWARE WELDED PR -3'-0" X 4'-0" | S.C WOOD S.C WOOD DOOR PLASTIC WELDED LEVER LOCK SET, STOP, STD. HDWE., CLOSER $^{2}R - 2' - 6" \times 5' - 0" \times 1 = 3/4' \text{LAMINATE FINISH}$

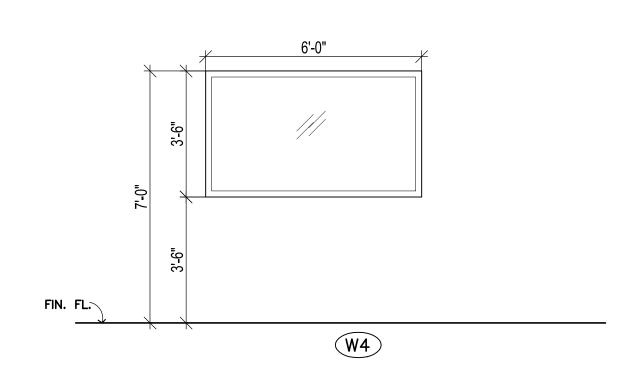

STORE FRONT WINDOW TYPES - INTERIOR

SCALE: 1/16" = 1'-0"

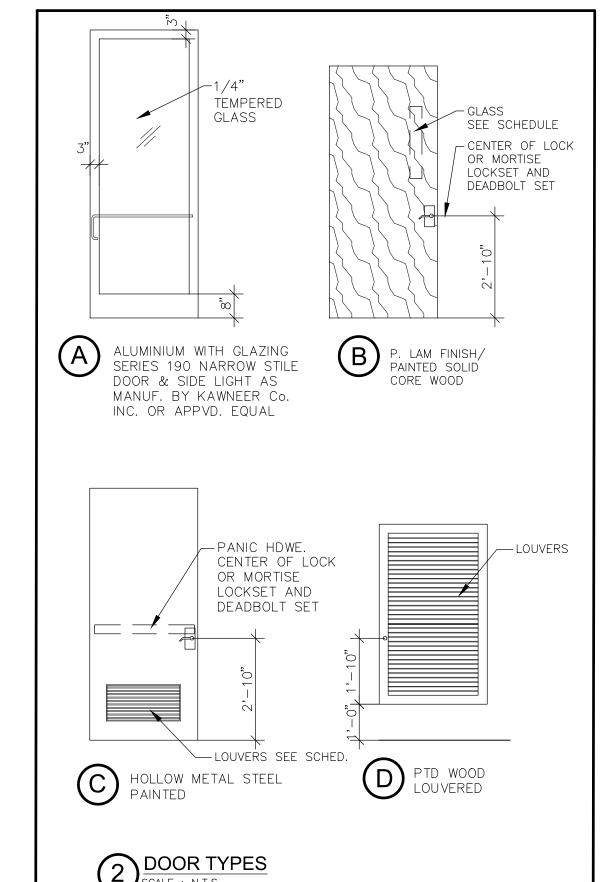

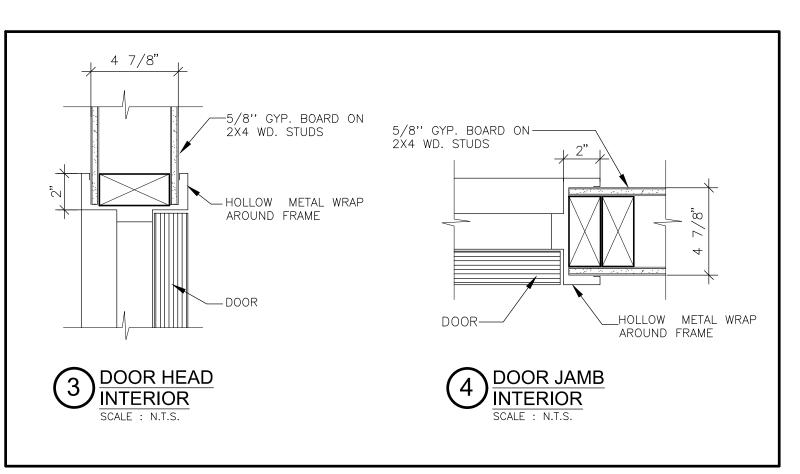

- ALL DOORS SHALL HAVE LEVER HANDLES OR EQUIVALENT MOUNTED NOT MORE THAN 42" A.F.F. EXCEPT AT ACCESSIBLE AREAS WHICH SHALL BE MOUNTED BETWEEN 34" & 36" A.F.F. MAXIMUM OPENING FORCE FOR EXTERIOR DOORS SHALL NOT EXCEED 8.5 POUNDS & 5 POUNDS FOR INTERIOR.
- FINISH HARDWARE TO BE SATIN NICKEL FINISH
- PROVIDE DOOR STOPS AT ALL DOORS.
- ALL EXTERIOR DOORS SHALL HAVE DOOR BOTTOM SWEEP "HAGER 778" & HEAD DRIP TRIM.

- ALL EXTERIOR STOREFRONT FRAMES SHALL BE CLEAR ANODIZED ALUMINUM FINISH W/ THERMAL BREAK.
- . FIELD VERIFY DIMENSIONS BEFORE FABRICATION OF STOREFRONT.
- STOREFRONT GLASS SHALL BE DOUBLE PANE WITH LOW-E GAS, GREY TINTED GLASS WITH SHGC 0.25 AND PF 0.22.
- REFER SHEET A2 AND A2.1 FOR EXTERIOR ELEVATIONS FOR STOREFRONT

DOORS & WINDOWS SCHEDULES WADHWA AND ASSOCIATES, INC. and construction administration

SCALE: AS NOTED 18-02-003

SHEET NO.

DRAWN: CHECKED:

DATE: JAN 2018

NEW LAWRENCE GROCERY

902 E. BAYSHORE, LEON, TEXAS 77539

ROOM FINISH SCHEDULE																	
			W	/ALL MA	ATERIA	4L	WALL FINISH										
ROOM NAME	FLOOR	BASE	NORTH	SOUTH	EAST	WEST	NORTH	SOUTH	EAST	WEST	CEILING	HEIGHT	REMARKS	LEGEND			
SALES	P.T.	4" P.T.	В	В	В	В	Р	Р	Р	Р	EX.	-		B 5/8" GYP. BD.			
CASHIER	P.T.	4" P.T.	В	в в в в		Р	Р	Р	Р	ALWD	10'-0"		P.T. PORCELAIN TILE				
OFFICE	V.C.T.	4" RUBBER	В	В	В	В	Р	Р	Р	Р	A.C.T.	9'-0"		P PAINT			
HALLWAY-1	P.T.	4" P.T.	В	В	В	В	Р	Р	Р	Р	T.C.T.	9'-0"		ST. STORE FRONT			
HALLWAY-2,3	V.C.T. 4" RUBBER B B B		В	Р	Р	Р	Р	A.C.T.	9'-0"		V.C.T. VINYL COMPOSITION TILE 1/8"						
STOCK AREA	S.C.	4" RUBBER	В	В	В	В	Р	Р	Р	Р	VACT	9'-0"		EX. EXPOSED STRUCTURE			
MEN RESTROOM	P.T.	4" P.T.	В	В	В	В	P.T.	P.T.	P.T.	P.T.	GYP. BD.	9'-0"	P.T. FULL HIGH ALL WALLS	S.C. SEALED CONCRETE			
MOP SINK AREA	P.T.	4" P.T.	В	В	В	В	P.T.	P.T.	P.T.	P.T.	GYP. BD.	9'-0"		Q.T. QUARRY TILE			
WOMEN RESTROOM	P.T.	4" P.T.	В	В	В	В	P.T.	P.T.	P.T.	P.T.	GYP. BD.	9'-0"	P.T. FULL HIGH ALL WALLS	T.C.T. LAY—IN TEGULAR 2' X 2' CLG. TILES			
MAINTENANCE/ STORAGE	S.C.	4" RUBBER	В	В	В	В	Р	Р	Р	Р	VACT	9'-0"		A.C.T. LAY-IN ACOUSTIC 2' X 4' CLG. TILES			
														V.C.T. VINYL COMPOSITION TILE 1/8"			
									-		VACT VINYL TILE FACED LAY—IN 2'X4' WASHABLE COLOR — WHITE						
													FRP FIBER REINFORCED PLASTIC				
HOT DELI AREA	F-3	B-1	CT-1	CT-1	CT-1	CT-1	CT-1	CT-1	CT-1	CT-1	VACT	9'-0"		ALWD ALUMINUM CEILING PANEL WOOD GRAIN FINISH			

- . ALL PAINTS SHALL BE SEMIGLOSS SATIN FINISH, "SHERWIN WILLIAM" U.N.O.
- 2. 2'X2' LAY IN ACCOUSTIC TILES SHALL BE "ARMSTRONG-ULTIMA" OR APPROVED EQUAL, FINE TEXTURE, SQUARE LAY IN TEGULAR, W/ 15/16" EXPOSED T-GRID.
- 3. 2'X4' LAY IN ACCOUSTIC TILES SHALL BE "ARMSTRONG" OR APPROVED EQUAL, FINE TEXTURE.
- 3. VINYL COMPOSITION TILE SHALL BE "ARMSTRONG" STANDARD EXCELLON OR APPROVED EQUAL. 4. PORCELAIN FLOOR TILES SHALL BE "DAL-TILE" NON-SKID OR APPROVED EQUAL.
- 5. ALL P.T. BASE SHALL BE COVED.
- 6. COLOR PANELS SHALL BE SUBMITTED TO WADHWA AND ASSOCIATES, INC./ OWNER FOR APPROVAL.


- F-3 6" RED QUARRY TILE FINISH - RED MFGR. - EMSER
- B-1 4" QUARRY TILE WI 3/8" R. BASE FINISH - BRICK SMOOTH MFGR. - EMSER


SWS STAIN WOOD SLATS EXTERIOR TILE

CT-1 AREA GLOSSY WHITE 4.25X10 MFGR. - EMSER TILE

FINISH - W82AREAWH0410

- GROUT: MAPEI 47 CHARCOAL GROUT LINES =114 "AT ALL LOCATIONS
- WP-1 RECLAIMED WOOD SLATS FINISH - SPECS AND SUPPLIER TBA MFGR. - QUALSERV

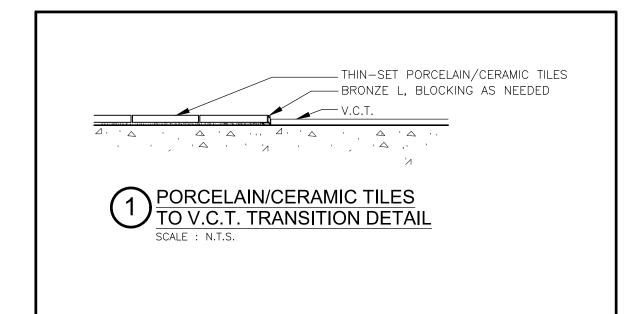

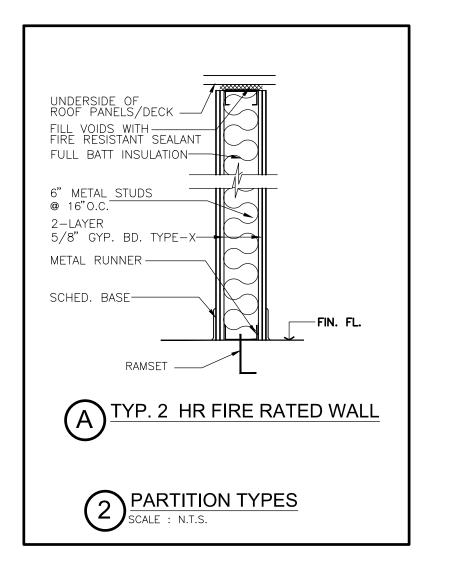



SCALE: AS NOTED




NEW LAWRENCE GROCERY


902 E. BAYSHORE, SAN LEON, TEXAS 77539

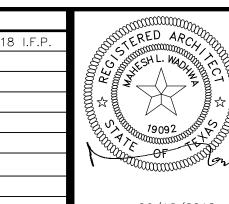

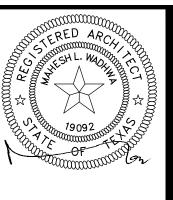



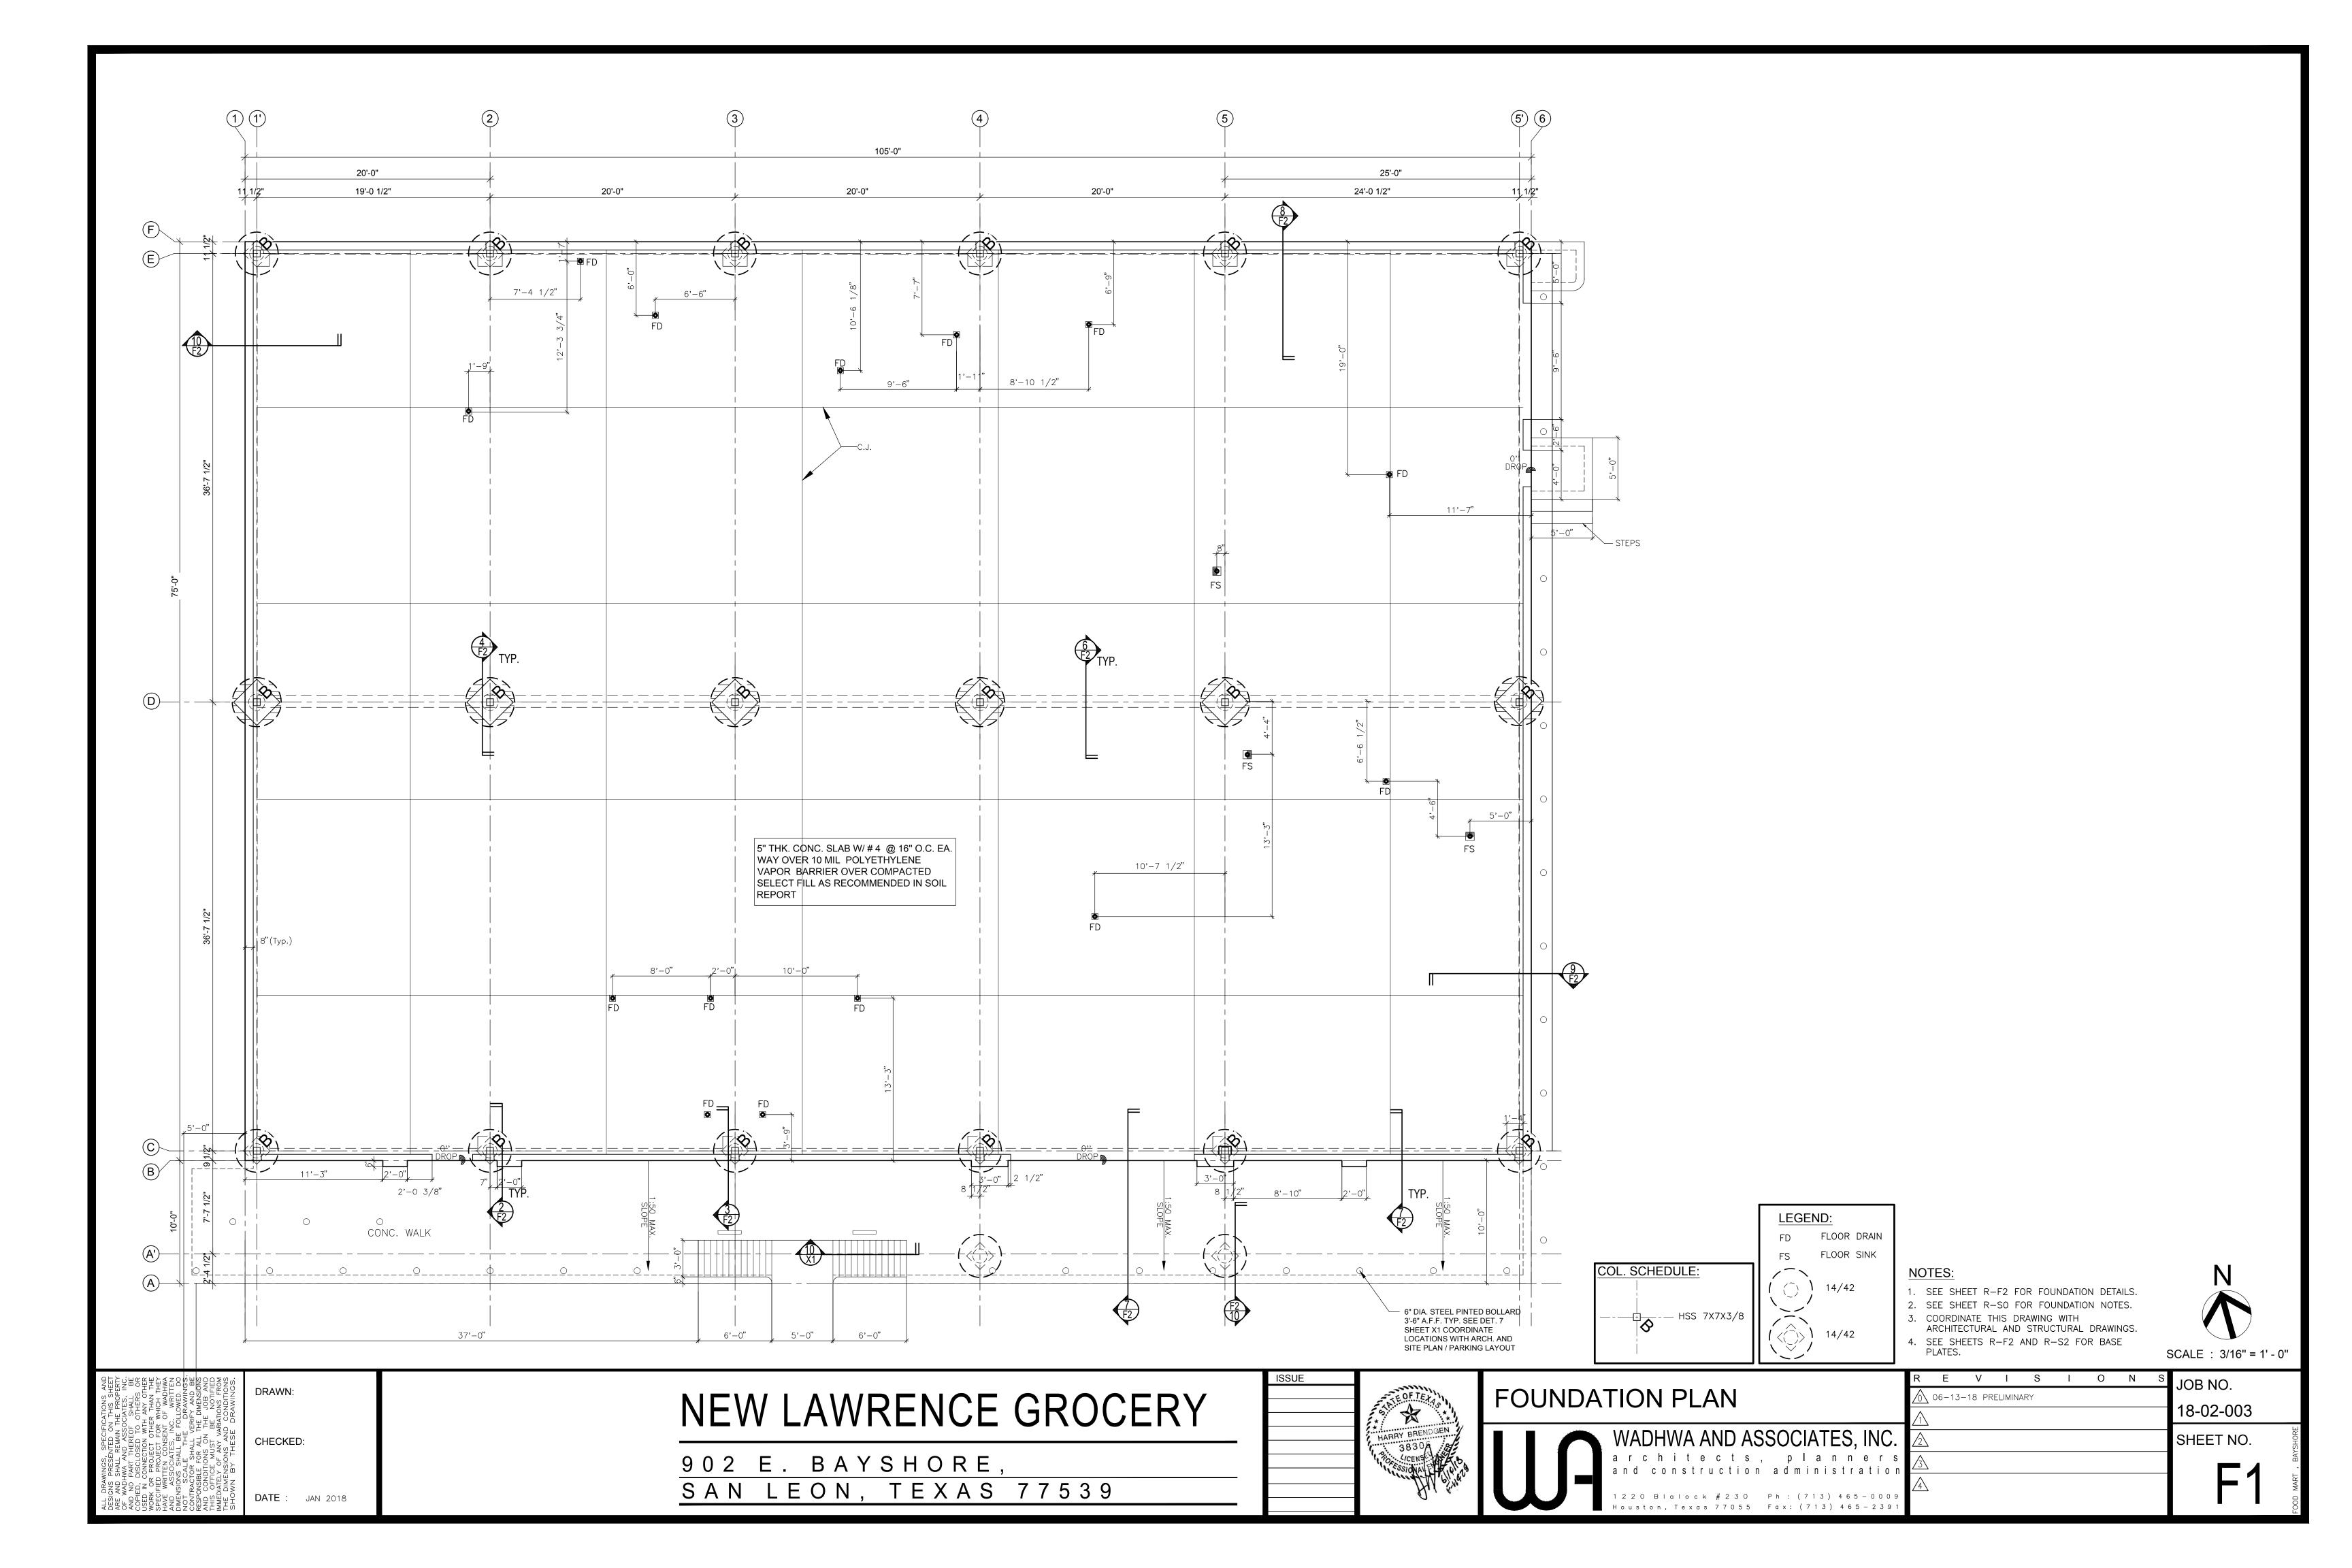

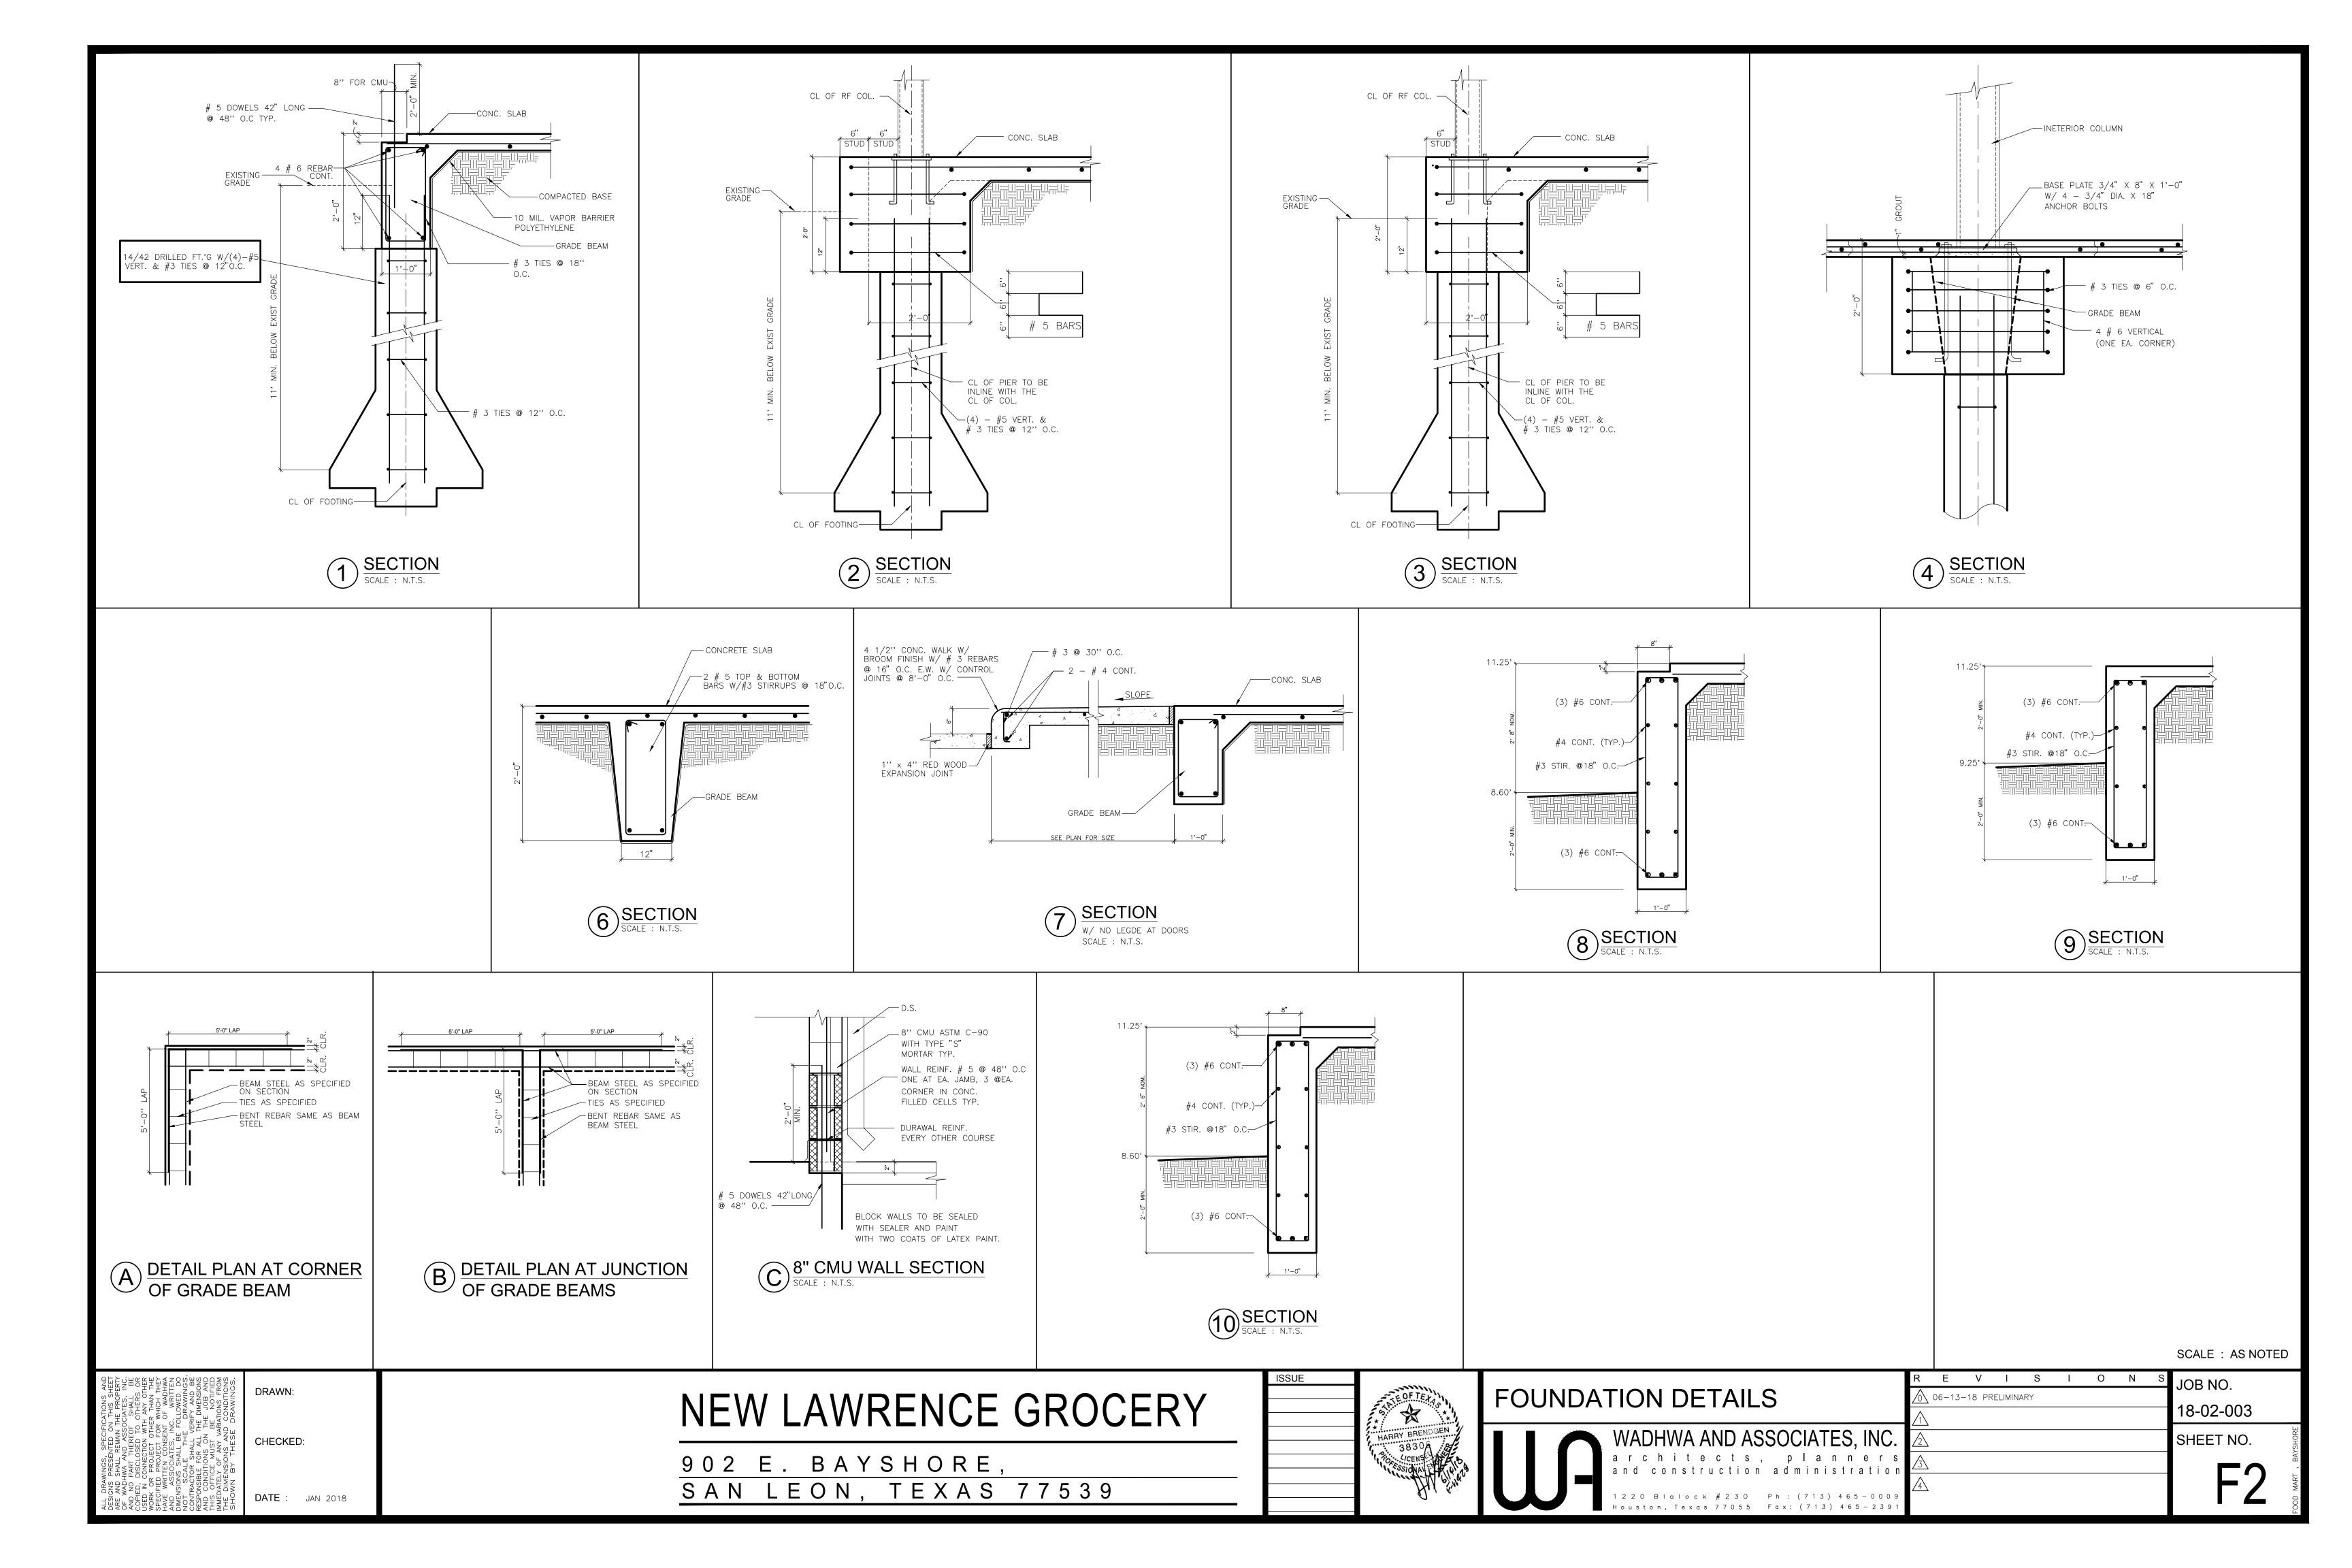

STRUCTURAL CONCEPTS, STANDARDS & LOADS

1. THE STRUCTURE AS SHOWN HAS BEEN DESIGNED IN ACCORDANCE WITH THE BUILDING CODE REQUIREMENTS AND DESIGN STANDARDS TO SUPPORT THE FINAL BUILDING SERVICE LOADS. THE CONTRACTOR SHALL BE RESPONSIBLE FOR PROVIDING ADDITIONAL SUPPORTS FOR THE STRUCTURE IF NECESSITATED BY THE CONSTRUCTION SEQUENCE OR METHODS OF FABRICATION, HANDLING, ERECTION AND OTHER CONSTRUCTION OPERATIONS.

B. <u>BUILDING CODES AND DESIGN STANDARDS</u>:

1. AMERICAN CONCRETE INSTITUTE (ACI), BUILDING CODE REQUIREMENTS FOR REINFORCED

CONCRETE, ACI 318. 2. AMERICAN INSTITUTE OF STEEL CONSTRUCTION (AISC), MANUAL OF STEEL CONSTRUCTION, 2005, AS AMENDED.

3. INTERNATIONAL BUILDING CODE, 2012 EDITION. 4. STEEL JOIST INSTITUTE (SJI), STANDARD SPECIFICATIONS FOR OPEN-WEB STEEL JOISTS.

5. STEEL DECK INSTITUTE (SDI), DESIGN MANUAL FOR COMPOSITE DECKS, FORM DECKS, ROOF DECKS AND CELLÙLAR METAL FLOOR DECK WITH ELECTRICAL DISTRIBUTION.

C. <u>GRAVITY LOADS</u>:

1. LOADS ARE GIVEN IN POUNDS PER SQUARE FOOT (PSF).

BUILDING AREA	DEAD LOAD (PSF)	LIVE LOAD (PSF)
1. ROOF	15	20

* INCLUDES AN ALLOWANCE OF 10 PSF FOR PARTITION.

2. LIVE LOADS ON FOUNDATIONS HAVE BEEN REDUCED IN ACCORDANCE WITH THE 3. ROOF MEMBERS HAVE BEEN DESIGNED TO SUPPORT 3" OF WATER.

D. <u>LATERAL DESIGN LOADS</u>:

1. WIND LOADS -INLAND 1, 120 MPH WITH EXPOSURE B AND CATEGORY II.

STRUCTURAL STEEL

A. <u>ROLLED SHAPES</u>:

B. <u>CONNECTIONS</u>

1. PROVIDE STRUCTURAL STEEL FOR W-SHAPE MEMBERS CONFORMING TO AMERICAN SOCIETY FOR TESTING MATERIALS ASTM A992, GRADE 50 (50 KSI), UNLESS OTHERWISE NOTED.

2. PROVIDE STRUCTURAL STEEL FOR ALL OTHER SHAPES, PLATES AND BARS CONFORMING TO ASTM GRADE 50, UNLESS OTHERWISE NOTED.

3. PROVIDE STRUCTURAL STEEL FOR HOLLOW STRUCTURAL SECTIONS CONFORMING TO ASTM A500, GRADE B,

4. PROVIDE STRUCTURAL STEEL FOR PIPE CONFORMING TO ASTM A53, TYPE E OR S, GRADE B, UNLESS OTHERWISE NOTED.

1. ALL BOLTED CONNECTIONS SHALL BE STANDARD AMERICAN INSTITUTE OF STEEL CONSTRUCTION BOLTED CONNECTIONS: USING AMERICAN SOCIETY FOR TESTING MATERIALS A325 BOLTS.

2. ALL WELDED CONNECTIONS SHALL CONFORM TO AMERICAN WELDING SOCIETY UNLESS OTHERWISE NOTED. 3. SURVEY ALL PLANS, DETAILS, SECTIONS, SCHEDULES AND SPECIFICATIONS FOR SPECIAL CONNECTIONS. 4. UNLESS OTHERWISE NOTED AND/OR SPECIFIED, ALL BEAM CONNECTIONS SHALL BE DESIGNED TO SUPPORT 1/2 OF THE TOTAL UNIFORM LOAD FOR THE APPLICABLE MEMBER SIZE AND SPAN AS DETERMINED BY THE TABLES FOR ALLOWABLE UNIFORM LOADS ON BEAMS IN THE 9TH EDITION OF THE AMERICAN INSTITUTE OF STEEL CONSTRUCTION MANUAL OF STEEL CONSTRUCTION (ASD).

5. MOMENT CONNECTIONS SHOWN SHALL BE DESIGNED TO FULLY DEVELOP THE SECTION IN FLEXURE AND TO SUPPORT 1/2 THE TOTAL UNIFORM LOAD FOR SHEAR AS DESCRIBED IN NOTE 4 ABOVE.

C. OPEN-WEB STEEL JOISTS: 1. AS APPLICABLE FOR THE OPEN WEB STEEL JOIST TYPES INDICATED ON THE DRAWINGS

CONFORMING TO STEEL JOIST INSTITUTE 2. PROVIDE BRIDGING IN ACCORDANCE WITH THE STEEL JOIST INSTITUTE.

3. DESIGN ROOF JOISTS FOR NET UPLIFT PRESSURE OF 10 POUNDS PER SQUAREFOOT. D. <u>STEEL DECK:</u> TYPE 1: STEEL DECK

STEEL ROOF DECK SHALL BE 1 1/2" DEEP, TYPE B (WIDE RIB) FORMED FROM 22 GAUGE STEEL SHEETS, ASTM A611, GRADES C, D OR E, OR ASTM A653, STRUCTURAL STEEL (SS), GRADE 33, WITH G60 COATING.

GENERAL NOTES FOR CONSTRUCTION

A. CONSTRUCTION METHODS, PROCEDURES AND SEQUENCES ARE THE RESPONSIBILITY OF THE CONTRACTOR AND THE CONTRACTOR SHALL TAKE ALL THE NECESSARY MEANS TO MAINTAIN AND PROTECT THE STRUCTURAL INTEGRITY OF ALL CONSTRUCTION AT ALL STAGES.

B. ANY PROPOSED SUBSTITUTION MUST BE EQUAL OR BETTER AND SHALL BE REVIEWED BY THE ARCHITECT/ENGINEER PRIOR TO ANY PERTINENT WORK AND PRIOR TO THE AWARD OF THE

C. NOT ALL OPENINGS AND OTHER COMPONENTS THAT ARE REQUIRED HAVE BEEN SHOWN IN THE STRUCTURAL DRAWINGS. COORDINATE WITH THE ARCHITECTURAL, MECHANICAL, PLUMBING AND ELECTRICAL DRAWINGS AND VERIFY THE LOCATIONS AND SIZES OF ALL CHASES, INSERTS, OPENINGS, SLEEVES, FINISHES, DEPRESSIONS, PADS AND OTHER PROJECT REQUIREMENTS.

D. THE CONTRACTOR IS RESPONSIBLE FOR REVIEWING THE MECHANICAL, ELECTRICAL, PLUMBING AND ARCHITECTURAL DRAWINGS TO DETERMINE WHERE OPENINGS ARE REQUIRED IN REINFORCED CONCRETE BEAMS AND SLABS.

E. THE CONTRACTOR SHALL SUBMIT SHOP DRAWINGS, DETAILING ALL THE OPENINGS, INCLUDING ADDED REINFORCEMENT AS SHOWN ON THE TYPICAL WALL, SLAB AND BEAM OPENING DETAILS FOR

F. ADDITIONAL REINFORCEMENT ABOVE THAT SHOWN IN THE TYPICAL SLAB AND BEAM OPENING

DETAILS MAY BE REQUIRED AND WILL BE REVIEWED ON THE SHOP DRAWINGS.

G. USE THE MANUFACTURER'S CERTIFIED DRAWINGS AND SPECIFICATIONS FOR THE EQUIPMENT ANCHORAGE AND DETAILS.

H. ALL CONSTRUCTION JOINTS SHOWN ON THE STRUCTURAL DRAWINGS SHALL BE INCORPORATED INTO THE STRUCTURE. ADDITIONAL CONSTRUCTION JOINTS TO FACILITATE CONSTRUCTION SHALL BE LOCATED AND DETAILED ON THE SHOP DRAWINGS FOR REVIEW. I. HORIZONTAL CONSTRUCTION JOINTS SHALL NOT BE PERMITTED IN BEAMS UNLESS SHOWN ON THE

STRUCTURAL DRAWINGS. J. ALL CONSTRUCTION AND CONTROL JOINTS FOR BEAMS WHICH ARE EXPOSED TO VIEW ARE TO BE LOCATED TO COINCIDE WITH THE ARCHITECTURAL RUSTICATION JOINTS AS SHOWN ON THE

BUILDING ELEVATION SHEETS OR AS REVIEWED IN WRITING K. ALL WELDING SHALL CONFORM TO AWS STANDARDS. THE THICKNESS AND THE LENGTHS OF THE WELDS ARE AS SHOWN, SPECIFIED OR AS REQUIRED.

L. SHOP DRAWINGS: 1. THE TERM "SHOP DRAWINGS" INCLUDES FABRICATION, MANUFACTURING, ERECTION AND SETTING DRAWINGS, BROCHURES, CERTIFICATES, AND PRODUCT DATA DESCRIBING MATERIALS AND EQUIPMENT. SHOP DRAWINGS SHALL INCLUDE ALL PERTINENT INFORMATION REQUIRED FOR THE ENGINEER TO FULLY EVALUATE THE MATERIALS BEING REPRESENTED BY THE SUBMITTAL INCLUDING THE PHYSICAL PROPERTIES, DIMENSIONS LOCATIONS AND METHOD OF INSTALLATION.

2. SHOP DRAWINGS WILL BEAR THE REVIEW STAMP OF THE CONTRACTOR INDICATING THAT HE HAS REVIEWED THE DRAWINGS FOR CONFORMANCE WITH THE CONTRACT DOCUMENTS; COORDINATED ITEMS INCLUDED IN THE SUBMITTAL WITH RELATED ITEMS; AND VERIFIED AND COORDINATED DIMENSIONS.

3. REPRODUCTIONS OF THE ENGINEERING DRAWINGS WILL NOT BE ACCEPTABLE AS SHOP DRAWINGS.

4. ANY SHOP DRAWING THAT DOES NOT CONFORM TO THESE REQUIREMENTS WILL BE CAUSE FOR REJECTION AND WILL BE RETURNED WITHOUT ANY FURTHER ACTION.

M. STEEL ERECTOR SHALL INSTALL TEMPORARY CABLE BRACING UNTIL ALL WELDING INCLUDING ROOF DECK IS COMPLETED AND ALL WALL SHEATHING IS INSTALLED.

CONCRETE MASONRY NOTES:

- 1. MASONRY CONSTRUCTION SHALL CONFORM TO THE REFERENCED BUILDING CODE, (ACI 531-79) AND (ACI 531R-79). HOLLOW CONCRETE MASONRY UNITS SHALL CONFORM TO ASTM C90, LIGHT WEIGHT, TYPE N1, WITH A MINIMUM COMPRESSIVE STRENGTH OF 1350 PSI ON THE NET AREA OF THE BLOCK.
- 2. MORTAR SHALL CONFORM TO ASTM C 270, TYPE S WITH A MINIMUM COMPRESSIVE STRENGTH OF 1800 PSI. COARSE GROUT SHALL CONFORM TO ASTM C476 WITH A MAXIMUM AGGREGATE SIZE OF 3/8", AND A MINIMUM COMPRESSIVE STRENGTH OF 3000 PSI @ 28
- 3. CONCRETE SHALL CONFORM TO ACI 318-83 WITH A MAXIMUM AGGREGATE SIZE OF 3/8" AND A MINIMUM COMPRESSIVE STRENGTH OF 3000 PSI @ 28 DAYS.
- 4. ALL CELLS CONTAINING VERTICAL REINFORCING STEEL, LINTEL BEAMS AND BOND BEAMS SHALL BE FILLED SOLID WITH COARSE GROUT OR CONCRETE AS DESCRIBED ABOVE.
- 5. THE FIRST TWO CELLS AT WALL OPENINGS AND WALL ENDS SHALL BE REINFORCED WITH

1-#5 VERTICAL EACH CELL SHALL EXTEND FROM FOUNDATION TO TOP OF WALL.

- 6. REINFORCING STEEL SHALL BE LAPPED 30 BAR DIAMETERS MINIMUM WHERE SPLICED AND SHALL BE WIRED TOGETHER.
- 7. WIRE REINFORCEMENT, "DUR-O-WALL" OR EQUAL, SHALL BE LAPPED AT LEAST 6 INCHES AT SPLICES AND SHALL CONTAIN AT LEAST ONE CROSS WIRE OR EACH PIECE OF REINFORCEMENT IN THE LAPPED DISTANCE.
- 8. VERTICAL BARS SHALL BE HELD IN POSITION AT TOP AND BOTTOM AND AT INTERVALS NOT EXCEEDING 4'-0" WITH A MINIMUM CLEARANCE OF 1/2 INCH FROM THE MASONRY. AND NOT LESS THAN ONE BAR DIAMETER BETWEEN BARS. BARS SHALL BE PLACED AS SHOWN AND NOTED ON DETAILS.
- 9. VERTICAL REINFORCING BARS MAY BE SPLICED IN 6' TO 8' LENGTHS, PROVIDED THE SPLICES IN ADJACENT BARS ARE STAGGERED AND ARRANGED SO THAT NO MORE THAN 1/3 OF THE TOTAL NUMBER OF BARS ARE SPLICED AT ANY LOCATION AND NOT MORE THAN 1/2 OF THE TOTAL NUMBER OF BARS ARE SPLICED AT MID-HEIGHT OF THE WALL. ALL BARS SHALL BE TIED AT SPLICES.
- 10. WHEN A FOUNDATION DOWEL DOES NOT LINE UP WITH A VERTICAL CORE, IT SHALL NOT BE SLOPED MORE THAN ONE HORIZONTAL TO SIX VERTICAL. REMOVE CELL DIVIDER WHEN
- 11. STANDARD WEIGHT 9 GAGE TRUSS TYPE "DUR-O-WALL", OR EQUAL SHALL BE PLACED HORIZONTALLY AT 16" O.C. AT ALL WALLS,
- 12. HORIZONTAL REINFORCING BARS SHALL BE PLACED IN CONTINUOUS MASONRY COURSES. CONSISTING OF BOND-BEAM OR LINTEL BLOCK UNITS, AND SHALL BE SOLIDLY GROUTED IN PLACE. AT LINTEL BEAMS, BARS SHALL EXTEND NOT LESS THAN 20 BAR DIAMETERS OR 16" (WHICHEVER IS GREATER) PAST THE OPENING FACE.
- 13. LINTEL BEAMS SHALL BE CONTINUOUS AT CONTROL & EXPANSION JOINTS-PROVIDE DUMMY JOINT WHEN REQUIRED, UNLESS NOTED OTHERWISE. BOND BEAMS SHALL BE DISCONTINUOUS AT CONTROL AND EXPANSION JOINTS. BOND BEAMS SHALL BE REINFORCED WITH 2-#5 BARS, UNLESS NOTED OTHERWISE.
- 14. REFER TO ARCHITECTURAL DRAWINGS FOR CONTROL AND EXPANSION JOINT LOCATIONS. THE MASONRY CONTRACTOR SHALL NOTIFY THE ENGINEER OF ANY DISCREPANCIES IN JOINT LOCATIONS. IN ADDITION, THE MASONRY CONTRACTOR SHALL NOTIFY THE ENGINEER OF ANY JOINT LOCATIONS, OR ABSENCE OF JOINTS, THAT DO NOT CONFORM TO THE ABOVE REFERENCED BUILDING CODES.

15. MASONRY TIES TO STRUCTURAL STEEL FRAMING SHALL BE "POS.I.TIE" BY NATIONAL WIRE PRODUCTS CORPORATION (OR EQUAL). TIES SHALL BE PLACED AS SHOWN ON DETAILS.

16. SLEEVE ANCHORS INTO MASONRY SHALL BE "SLEEVE ANCHORS" BY HILTI OR EQUAL.

17. DESIGN STRESSES HAVE BEEN LIMITED TO ALLOW FOR "NO SPECIAL INSPECTION REQUIRED" FOR CONCRETE BLOCK CONSTRUCTION.

1. REFER TO STEEL BUILDING MANUFACTURER ANCHOR BOLT PLAN FOR SIZES, QUANTITIES AND LOCATION OF ANCHOR BOLTS

CONCRETE DESIGN:

- A. CLASS 'A' CONCRETE SHALL HAVE A 28 DAY DESIGN STRENGTH OF 4500 PSI WHEN TESTED UNDER
- B. CLASS 'B' CONCRETE SHALL HAVE A 28 DAY DESIGN STRENGTH OF 3000 PSI WHEN TESTED UNDER LABORATORY CONDITIONS IN ACCORDANCE WITH ACI 318, LATEST EDITION.
- C. CLASS 'C' CONCRETE SHALL HAVE A 28 DAY DESIGN STRENGTH OF 2500 PSI WHEN TESTED UNDER LABORATORY CONDITIONS IN ACCORDANCE WITH ACI 318, LATEST EDITION.

CLASS 'A' ----ALL MACHINE AND EQUIPMENT FOUNDATIONS. (NOT USED)

LABORATORY CONDITIONS IN ACCORDANCE WITH AD 318, LATEST EDITION.

CLASS 'B' ----ALL GRADE BEAMS AND SLABS ON GRADE.

CLASS 'C' ----ALL DRILLED AND BETTED PIERS.

BE UNIFORM WITH LESS THAN 5% PASSING THE #200 SIEVE.

D. COURSE AGGREGATE SHALL NOT EXCEED 1 1/2" AND GRADATION FROM COURSE AGGREGATE TO FINES SHALL

E. AIR ENTRAINMENT SHALL BE A MIN. OF 41/2% BY VOLUME USING AN APPROVED AIR-ENTRAINING AGENT.

F. REINFORCING STEEL SHALL CONFORM TO THE REQUIREMENTS OF ASTM AL5, GRADE 60, FABRICATED IN ACCORDANCE WITH ASTM A305.

CONCRETE MIXING AND POUR INSTRUCTIONS:

- 1. CONCRETE SHALL BE MIXED, TRANSPORTED AND PLACED IN ACCORDANCE WITH ACI 304-73 OR LATEST
- 2. TEST CYLINDERS SHALL BE PREPARED BY AN EXPERIENCED TECHNICIAN WITH A MINIMUM OF THREE (3) CYLINDERS PER 25 C1Y1 OR ONE SET OF THREE (3) PER POUR, WHICHEVER IS GREATER
- 3. CYLINDER CURING SHALL BE ACCOMPLISHED UNDER SITE CONDITIONS AND SHALL NOT BE DISTURBED DURING THE FIRST 72 HOURS. TRANSPORTATION TO THE LABORATORY SHALL BE VIA AN APPROVED LINED AND
- 4. CONCRETE SHALL NOT BE PLACED WHEN THE AMBIENT TEMPERATURE IS ABOVE 90 DEGREES AND RISING OR BELOW 40 DEGREES AND FALLING WITHOUT AN APPROVED MEANS OF PROTECTING THE CONCRETE DURING AND AFTER THE POUR.
- 5. SLUMP SHALL BE MEASURED ON EACH POUR AND SHALL NOT BE LESS THAN 1" NOR MORE THAN 4" FOR CLASS 'A' OR 'B' CONCRETE. NO MORE THAN 5% TOTAL WATER CONTENT MAY BE ADDED AT THE JOB-SITE. DESIGN MIX PROPORTIONS, INCLUDING WATER SHALL BE CONTROLLED AT THE BATCH PLANT. CONCRETE SHALL NOT BE ALLOWED TO 'FLOW', BUT SHALL BE PLACED IN THE FINAL LOCATION VIA USE OF CHUTES, GEORGIA BUGLES, PUMP TRUCK OR OTHER MEANS OF DELIVERY APPROVED BY THE ENGINEER.
- 6. PENCIL VIBRATORS SHALL BE USED IN THE PROXIMITY OF REINFORCING RODS AND SIDE FORMS TO ELIMINATE VOIDS AND ASSURE CONSOLIDATION OF THE CONCRETE AROUND THE REINFORCING.
- 7. CURING SHALL BE ACCOMPLISHED IN ACCORDANCE WITH ACI 308. IF WATER IS USED, THE CONCRETE SHALL BE MAINTAINED IN A SURFACE SATURATED CONDITION FOR A PERIOD OF 7 DAYS. APPROVED LIQUID MEMBRANE CURING COMPOUNDS SHALL COMPLY WITH THE REQUIREMENTS OF ASTM C309 AND SHALL BE APPLIED IN ACCORDANCE WITH ACI 308.2.3.3.
- 8. FINISH OF THE EXPOSED PERIMETER GRADE BEAMS SHALL BE HAND RUBBED TO REMOVE ALL FORM MARKS AND FILL ANY VOIDS. RUBBING SHALL BE ACCOMPLISHED BY WETTING THE SURFACE AND WORKING A PASTE FROM THE IN-PLACE CONCRETE, NOT FROM ADDED CEMENT AND FINE AGGREGATE.
- 9. FINISH SHALL BE LIGHT BROOM. 10. THE INTERIOR SLAB SHALL BE FINISHED UTILIZING A 'JITTER-BUG' TO REMOVE THE EXPOSED LARGE
- AGGREGATE FROM THE SURFACE AND SHALL BE STEEL TROWELED TO A SMOOTH DENSE WEARING SURFACE. 11. FLOOR HARDENER SHALL BE APPLIED DURING THE FINISHING OPERATION TO EFFECT A FINISHED CONCRETE SURFACE FREE OF DUST AND EFFERVESCENCE,
 - 12. MOISTURE BARRIER SHALL BE MEET THE REQUIREMENTS OF ASTM 2103, 10 MIL THICK POLYETHYLENE FILM.

BACK FILL NOTES:

- . SELECT FILL OR BACK FILL SHALL BE AN APPROVED TYPE OF SAND OR SANDY CLAY FREE OF FOREIGN SUBSTANCES AND HAVING A PLASTICITY INDEX BETWEEN 8 & 20 WITH A LIQUID LIMIT OF 40 OR LESS.
- 2. COMMON FILL OR BACK FILL SHALL BE AN APPROVED SITE EXCAVATED MATERIAL OF SIMILAR CLASSIFICATION AND CHARACTERISTICS.
- 3. SAND FILL SHALL BE CLEAN BANK SAND, FREE DRAINING AND ABSENT OF ANY FOREIGN MATTER.
- 4. SAND FILL OR BACK FILL SHALL BE COMPACTED IN 6" LIFTS TO A MINIMUM RELATIVE DENSITY OF 75%, SANDY CLAY SHALL BE COMPACTEDTO MIN-DENISITY OF 95% PROCTOR AS DETERMINED BY LABORATORY ANALYSIS. A MINIMUM OF 2 DENSITY TESTS PER LIFT SHALL BE TAKEN. IN PLACE DENISITY TEST SHALL BE PER ASTM D1556 OR D2922 AND FURTHER PLACEMENT SHALL NOT BE ALLOWED UNTILL THE REQUIRED DENISITY HAS BEEN
- 5. SLOPE GRADE AWAY FROM SLAB AS DESIGNATED ON THE DRAWINGS TO NATURAL SITE GRADE ELEVATIONS AT THE PROJECT LIMITS, UNLESS OTHERWISE NOTED OR DIRECTED.
- 6. IF TESTS INDICATE THE WORK DOES NOT MEET THE SPECIFIED REQUIREMENTS, REMOVE THE WORK, REPLACE AND RETEST AT NO COST TO THE OWNER OR HIS DESIGNATED REPRESENTATIVE.
- SUB GRADE SHALL BE STABILIZED WITH THE ADDITION OF LIME SLURRY, NOT TO EXCEED 7% BY VOLUME TO A MINIMUM DEPTH OF 6 INCHES.

FOUNDATION NOTES:

- 1. VERIFY ALL DIMENSIONS EXISTING UNDERGROUND UTILITIES AND ANY OTHER EXISTING CONDITIONS IN THE FIELD BEFORE COMMENCING WORK.
- 2. NOTIFY THE ENGINEER SHOULD DIMENSIONS OR CONDITIONS VARY FROM THE PLANS.
- 3. ALL EARTH WORK SHALL BE DONE AS RECOMMENDED BY THE SOIL REPORT, PREPARED BY QUARTET ENGINEERS, PLLC 1839 HARLAND DRIVE, HOUSTON, TX 77055. REPORT # PGH-18-0117 , DATED: APR. 9 2018
- 4. POUR CONCRETE AND SET THE REBARS FOOTING IMMEDIATELY AFTER DRILLING AND INSPECTION. UNCLEAN HOLES AT BOTTOM OF SLOUGH SIDED SHAFT SHALL CAUSE
- FOR REJECTION. 5. ALL FORM WORK SHALL BE PLACED AND SHORED, ALL REINFORCING SHALL BE SET AND TIED, ALL CONCRETE SHALL BE PLACED, FINISHED, AND CURED PER ACI 318-83 SPECIFICATIONS AND PER ALL SAFETY PROVISIONS OF O.S.H.A.
- 6. LAP REBAR AT ALL SPLICES A MINIMUM OF 36 BAR DIAMETERS. PROVIDE CORNER BARS AT ALL GRADE BEAM CORNERS A 10 FT. LONG 90 DEG. BENT BARS.
- 7. ALL CONCRETE SURFACES SHALL BE PROPERLY CURED AND SUFFICIENT TIME ALLOWED BEFORE PERMITTING TRAFFIC OR CONSTRUCTION TO PROCEED. EXPOSED INTERIOR CONCRETE SURFACES SHALL RECEIVE A HARD STEEL TROWEL FINISH. EXTERIOR CONCRETE SHALL RECEIVE A LIGHT BROOM FINISH. CURING SHALL BE DONE WITHIN 14 DAYS PER ACI PROCEDURE.
- 8. CONCRETE IN SLABS, GRADE BEAMS AND FOOTINGS SHALL HAVE A MIX DESIGN OF 3000 PSI. WITH 3/4" AGGREGATE, OR SPECIAL SIZED AGGREGATE IF PUMPING IS NECESSARY, AND A MINIMUM OF 5 SACKS OF STANDARD TYPE I CEMENT. THE ULTIMATE STRENGTH SHALL BE TESTED AT 28 DAYS AND AT OTHER TIMES AS IS NECESSARY TO PROCEED SAFELY WITH CONSTRUCTION, ANY ADDITIVES FOR ANY PURPOSE SHALL BE SUBMITTED TO THE ENGINEER FOR APPROVAL. NO ADMIXTURES CONTAINING CALCIUM CHLORIDE SHALL BE USED OVER METAL DECK.
- 9. ALL REINFORCING BARS SHALL BE CLEAN, NEW, AND FREE OF DIRT, RUST, OR OIL, AND SHALL MEET OR EXCEED THE REQUIREMENTS OF ASTM A—615, GRADE 60 EXCEPT #3 BARS MAY BE GRADE 40.
- 10. SAND SHALL BE CLEAN, SHARP, GRANULAR TYPE, LOCALLY AVAILABLE AND EASILY COMPACTABLE, FREE OF VEGETATION OR OTHER DELETERIOUS MATERIAL.
- 11. ANCHOR BOLTS SHALL BE ASTM A-307 STANDARD BLACK (NOT GALVANIZED) BOLTS. 12. PROVIDE CONTROL JOINTS AS SHOWN.
- 13. SLAB ON GRADE SHALL BE PLACED ON 36" SELECT FILL. THE EXISTING SUB-GRADE AND ADDITIONAL FILL SHALL BE COMPACTED TO 95% OF ITS MAXIMUM DRY DENSITY WITHIN MINUS ONE TO PLUS TWO PERCENT AS DETERMINED BY TEX 113-E. SELECT OR STRUCTURAL FILL SHALL HAVE PLASTICITY INDEX (P.I.) OF 8 TO 20 AND A MAX. LIQUID LIMIT OF 40.
- 14. CONCRETE COVERING OF THE REBAR SHALL BE:

3" BOTTOM

DRILLED FTG. - 3" SIDE SLAB ON GRADE - 1 1/2" FROM TOP GRADE BEAM - 1 1/2" TOP

SPREAD FTG.

- 2" SIDE 15. SELECT FILL BENEATH THE BUILDING SHALL BE PLACED IN LOOSE LIFTS NOT EXCEEDING IN 9" IN THICKNESS AND AS RECOMMENDED BY THE ENGINEER.

SCALE: NO SCALE

18-02-003

ĬĄĮ,ŒŊĮ,ĒŊ


DRAWN:

CHECKED:


DATE: JAN 2018

NEW LAWRENCE GROCERY

902 E. BAYSHORE LEON, TEXAS 77539

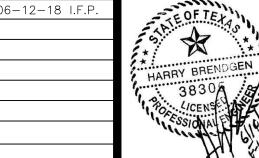





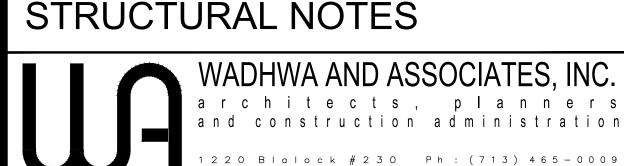

06-13-18 PRELIMINARY Houston, Texas 77055 Fax: (713) 465-239

V I S I O N

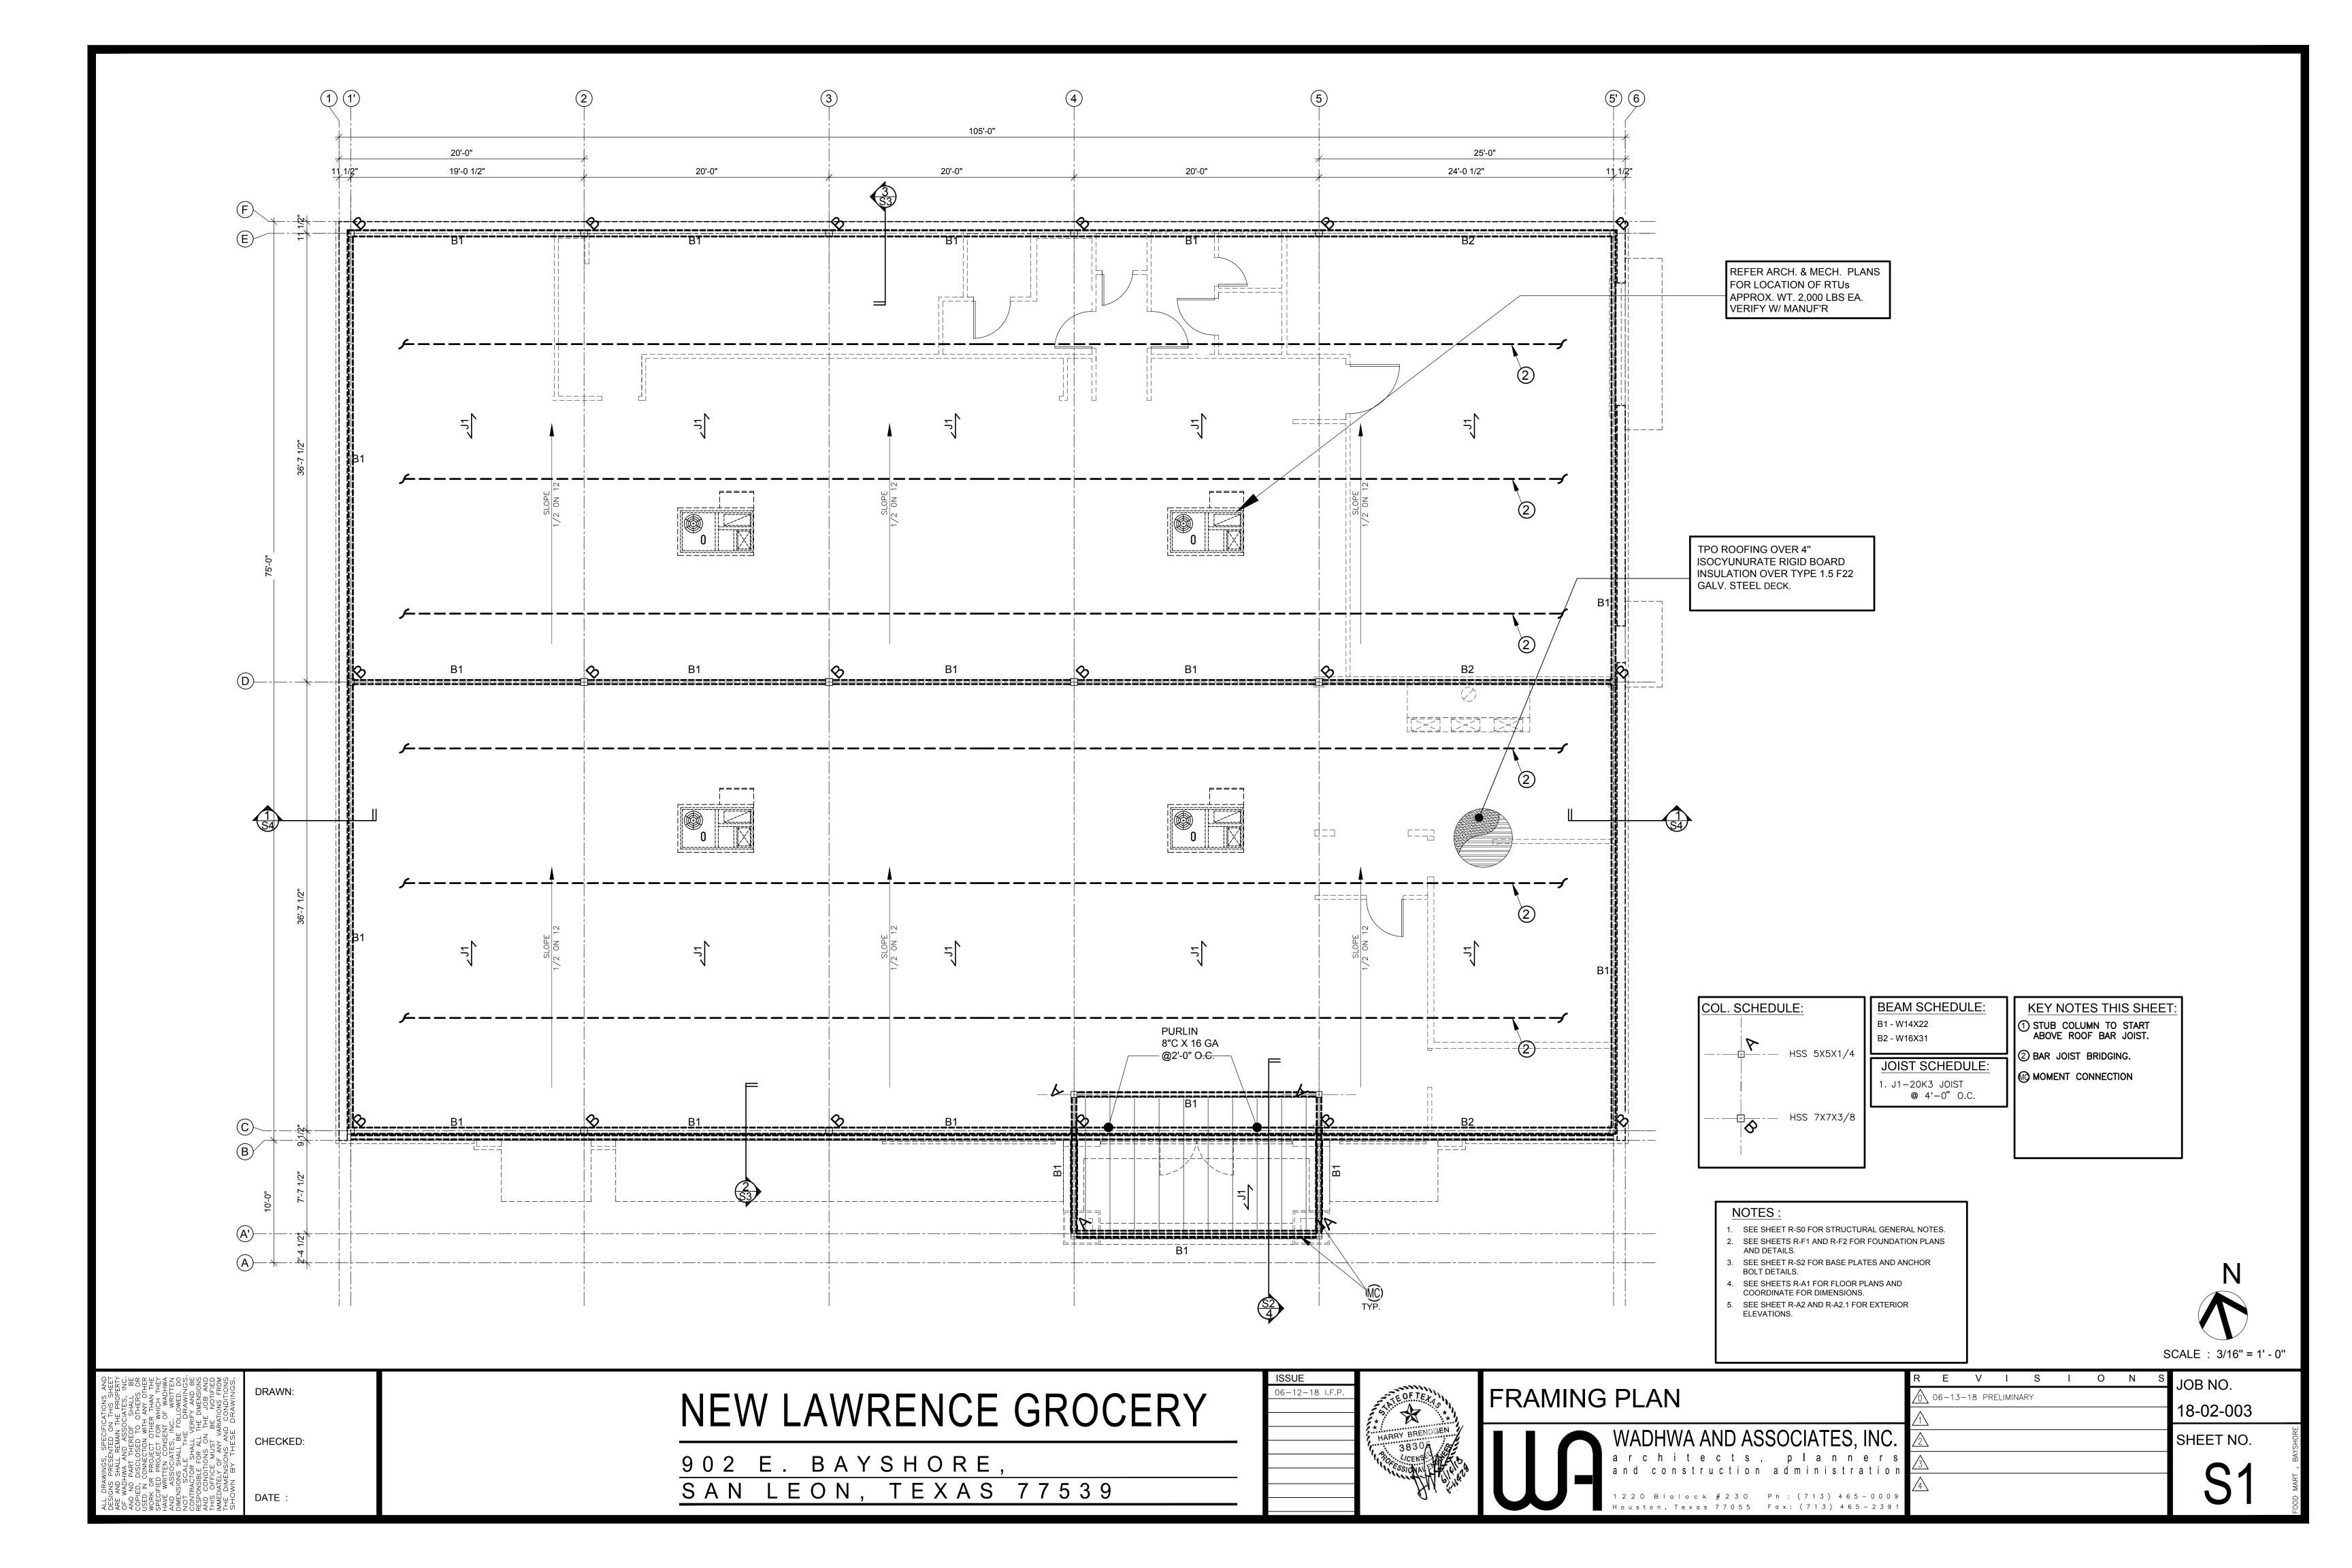

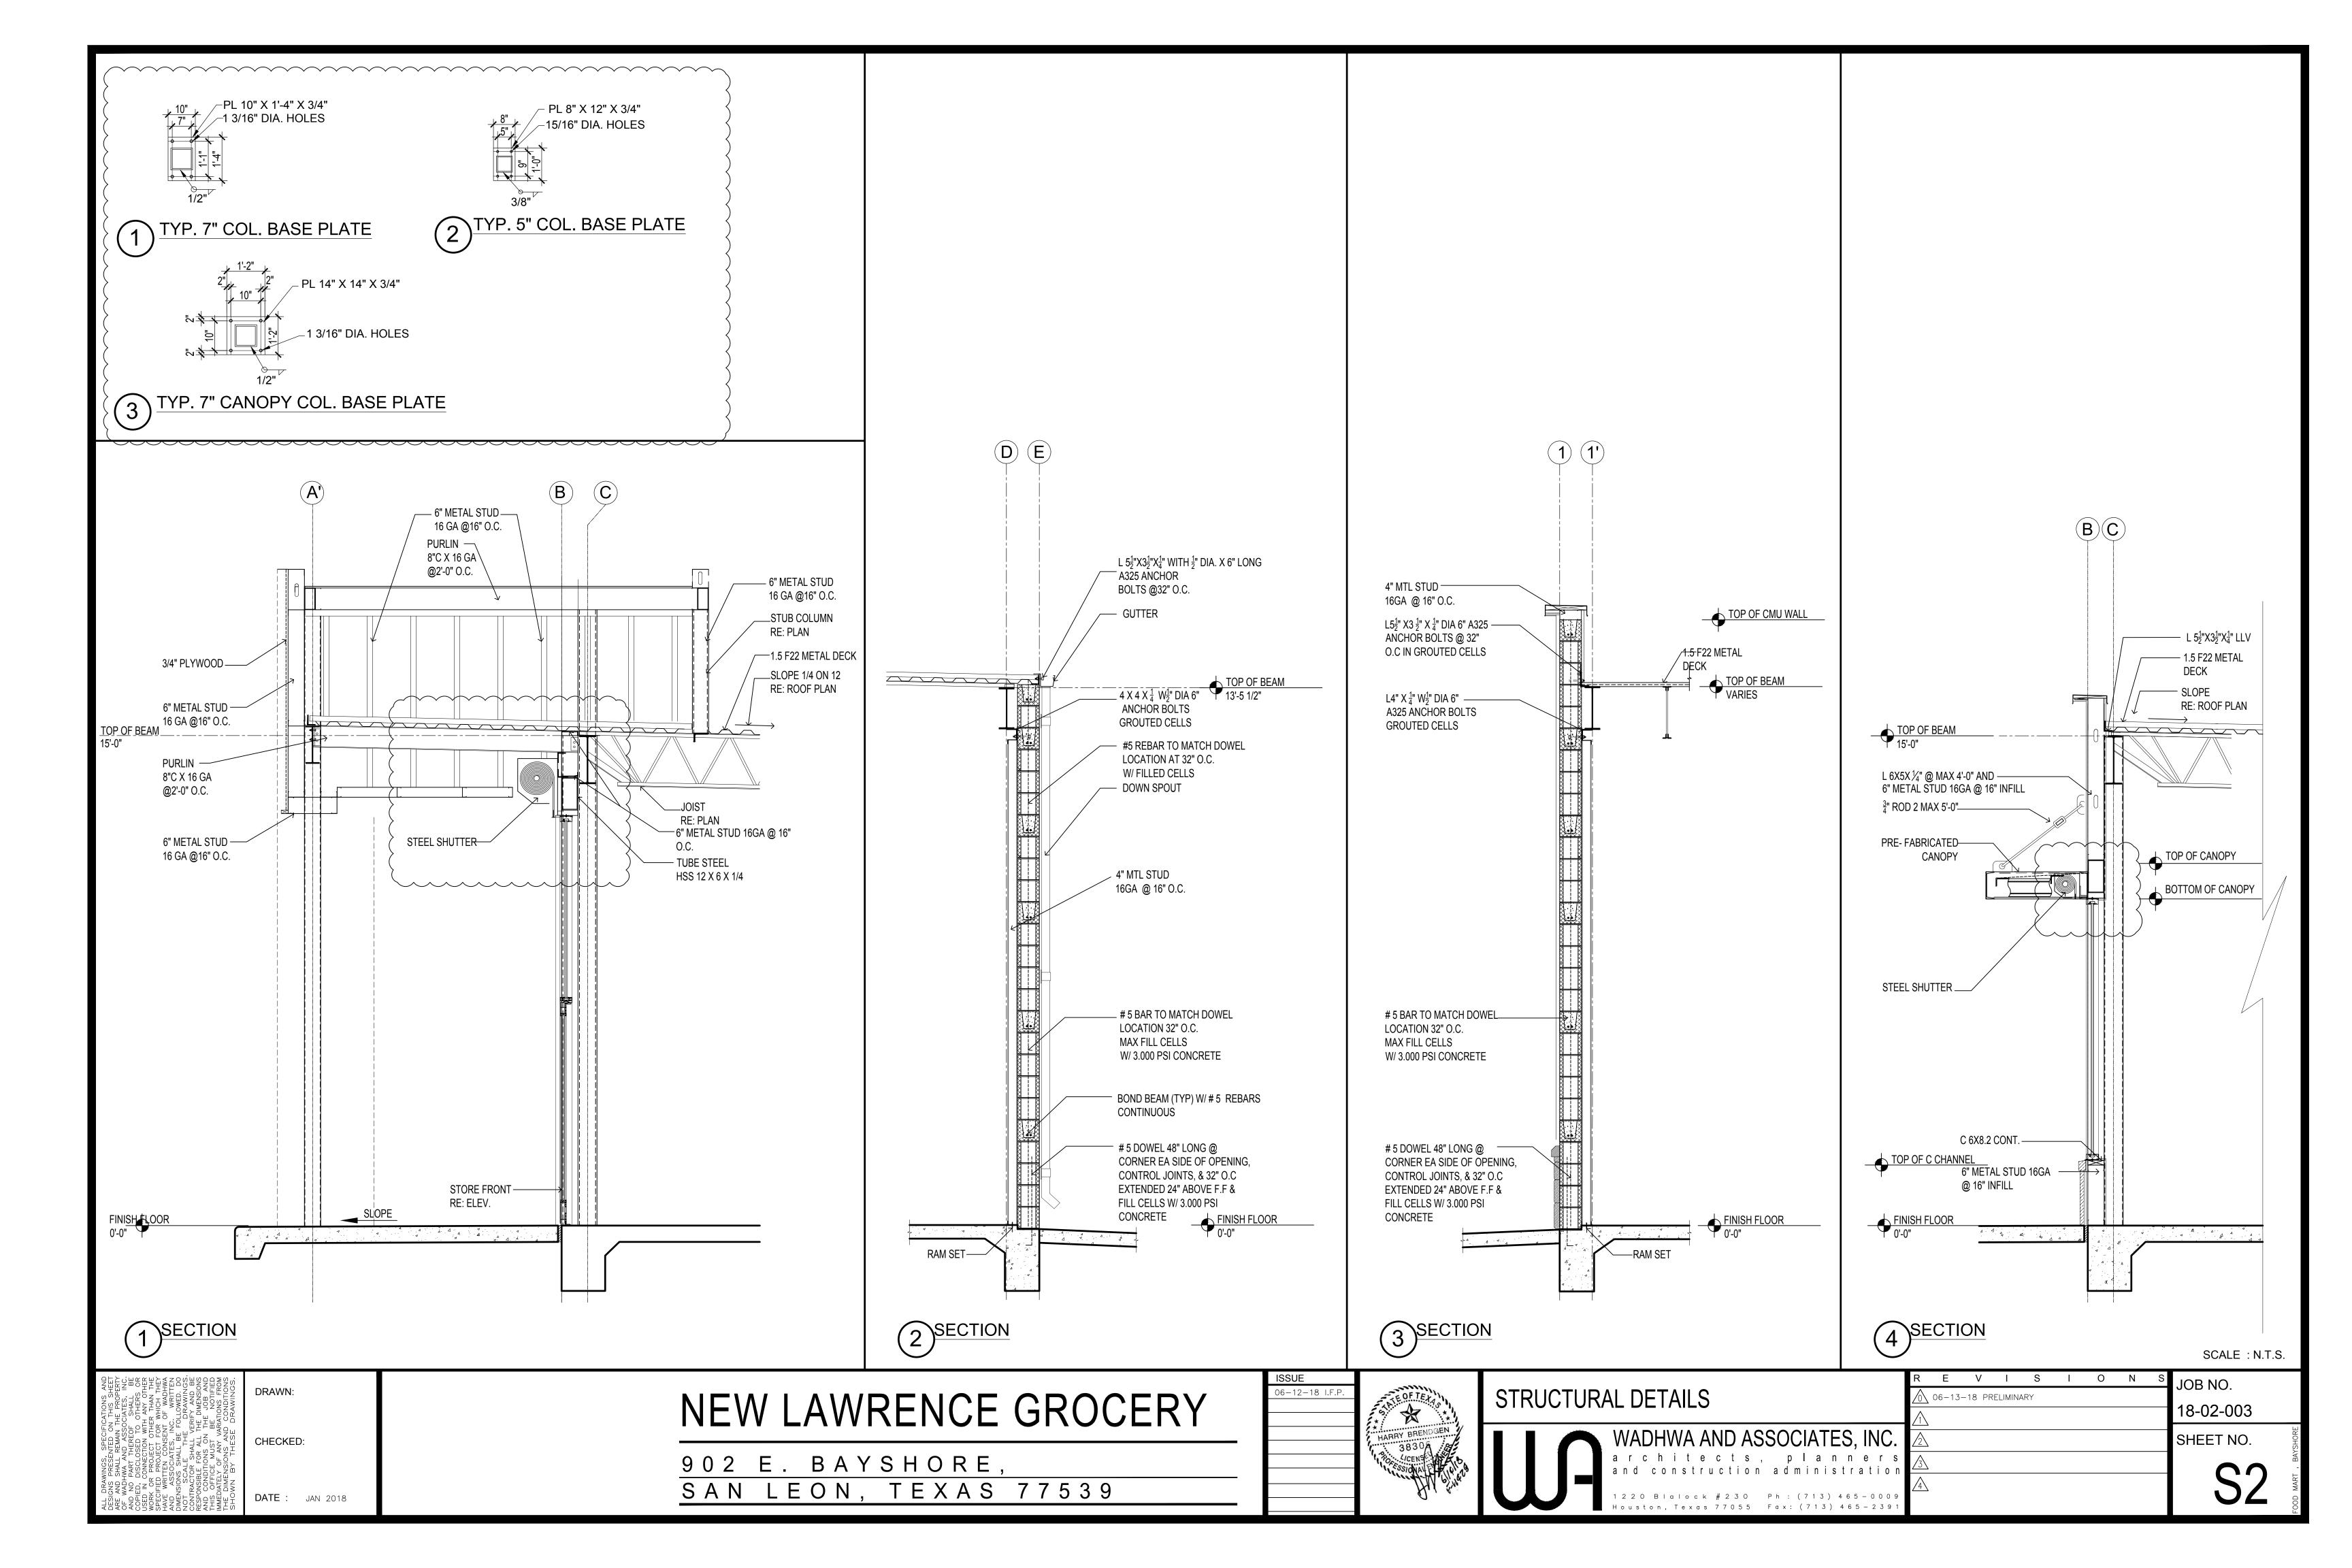

	EXHAUST FAN SCHEDULE														
Mark	Model	Volume (CFM)	Total SP: (in. wg)	I SNAAN I	dBA	Inlet Sones	Motor Size (hp)	Enclosur e	Voltage	Phase	Cycle	EC Motor	Total Weight (Ib)	NOTES	
TOLIET EF-1	G-098-VG	425	0.279	1107	50	5	1/4	ODP	115	1	60 Cycle	VariGreen	57	1,2	
TOLIET EF-2	G-098-VG	425	0.279	1107	50	5	1/4	ODP	115	1	60 Cycle	VariGreen	57	1,2	
MAINTAINENCE EF-3	G-098-VG	300	0.265	916	45	3	1/4	ODP	208	1	60 Cycle	VariGreen	57	1,2	
STORAGE EF-4	G-097-VG	60	0.251	779	38	2	1/4	ODP	208	1	60 Cycle	VariGreen	57	1,2	
DICKEY'S BBQ KEF-1	CUE-141- VG	1360	0.75	1185	59	10	1/2	ODP	208	1	60 Cycle	VariGreen	92	1,2	
TACO CORNER KEF-2	CUE-141- VG	1385	0.75	1192	59	10	1/2	ODP	115	1	60 Cycle	VariGreen	104	1,2	

EXHAUST FAN NOTES

1. PROVIDE BACKDRAFT DAMPER.

2. PROVIDE ROOF CURB.

	DIFFUSER SCHEDULE														
Mark	Manufacturer	Туре	CFM	Model	Neck	Face Size	Notes	NOTES							
D-1	Price Supply 325-425		325-425	RCDA	12" DIA.	27" DIA.	OPEN CEILING; CONNECT TO DUCT	1,2							
D-2)-2 Price Supply 40			SPD	12" DIA.	24 × 24	LAY-IN CEILING	1,2							
D-3	Price	Supply	300-350	SPD	10" DIA.	24 × 24	LAY-IN CEILING	1,2							
D-4	Price	Supply	200-250	SPD	8" DIA.	24 × 24	LAY-IN CEILING	1,2							
D-5	Price	Supply	75–125	SPD	6" DIA.	24 × 24	LAY-IN CEILING	1,2							
D-6	Price	Supply	50	SPD	6" DIA.	24 × 24	LAY-IN CEILING	1,2							
D-7	Price	Return	800	RCDA	12" DIA.	27" DIA.	OPEN CEILING; CONNECT TO DUCT	1,2							
D-8	Price	Return	100-400	80	VARIES	VARIES	LAY-IN CEILING	1,2							
D-9	-9 Price Exhaust 60-500		85	VARIES	24 X 24	LAY-IN CEILING	1,2								
D-10	D-10 Price Transfer Varies				VARIES	VARIES	WALL/ CEILING	1,2							

IMC 2012 TESTING:

506.3.2.5 GREASE DUCT TESTS -

PERFORM THE FOLLOWING TESTS PER IMC 2012:

- (1) LEAKAGE TEST PRIOR TO THE USE OR CONCEALMENT OF ANY PORTION OF A GREASE DUCT SYSTEM, A LEAKAGE TEST SHALL BE PERFORMED. DUCTS SHALL BE CONSIDERED TO BE CONCEALED WHERE INSTALLED IN SHAFTS OR COVERED BY COATINGS OR WRAPS THAT PREVENT THE DUCTWORK FROM BEING VISUALLY INSPECTED ON ALL SIDES. THE PERMIT HOLDER SHALL BE RESPONSIBLE TO PROVIDE THE NECESSARY EQUIPMENT AND PERFORM THE GREASE DUCT LEAKAGE TEST. A LIGHT TEST SHALL BE PERFORMED TO DETERMINE THAT ALL WELDED AND BRAZED JOINTS ARE LIQUID TIGHT
- (2) A LIGHT TEST SHALL BE PERFORMED BY PASSING A LAMP HAVING A POWER RATING OF NOT LESS THAN 100 WATTS THROUGH THE ENTIRE SECTION OF DUCTWORK TO BE TESTED. THE LAMP SHALL BE OPEN SO AS TO EMIT LIGHT EQUALLY IN ALL DIRECTIONS PERPENDICULAR TO THE DUCT WALLS. A TEST SHALL BE PERFORMED FOR THE ENTIRE DUCT SYSTEM, INCLUDING THE HOOD-TO-DUCT CONNECTION. THE DUCT WORK SHALL BE PERMITTED TO BE TESTED IN SECTIONS, PROVIDED THAT EVERY JOINT IS TESTED. FOR LISTED FACTORY-BUILT GREASE DUCTS, THIS TEST SHALL BE LIMITED TO DUCT JOINTS ASSEMBLED IN THE FIELD AND SHALL EXCLUDE FACTORY WELDS.
- 507.16 PERFORMANCE TEST A PERFORMANCE TEST SHALL BE CONDUCTED UPON COMPLETION AND BEFORE FINAL APPROVAL OF THE INSTALLATION OF A VENTILATION SYSTEM SERVING COMMERCIAL COOKING APPLIANCES. THE TEST SHALL VERIFY THE RATE OF EXHAUST AIRFLOW REQUIRED BY SECTION 507.13, MAKEUP AIRFLOW REQUIRED BY SECTION 508 AND PROPER OPERATION AS SPECIFIED IN THIS CHAPTER. THE PERMIT HOLDER SHALL FURNISH THE NECESSARY TEST EQUIPMENT AND DEVICES REQUIRED TO PERFORM THE TESTS.
- 507.16.1 CAPTURE AND CONTAINMENT TEST THE PERMIT HOLDER SHALL VERIFY CAPTURE AND CONTAINMENT PERFORMANCE OF THE EXHAUST SYSTEM. THIS FIELD TEST SHALL BE CONDUCTED WITH ALL APPLIANCES UNDER THE HOOD AT OPERATING TEMPERATURES, WITH ALL SOURCES OF OUTDOOR AIR PROVIDING MAKEUP AIR FOR THE HOOD OPERATING AND WITH ALL SOURCES OF RECIRCULATED AIR PROVIDING CONDITIONING FOR THE SPACE IN WHICH THE HOOD IS LOCATED OPERATING. CAPTURE AND CONTAINMENT SHALL BE VERIFIED VISUALLY BY OBSERVING SMOKE OR STEAM PRODUCED BY ACTUAL OR SIMULATED COOKING, SUCH AS WITH SMOKE CANDLES, SMOKE PUFFERS, ETC.

SEQUENCE OF OPERATION:

EACH ZONE SHALL BE PROVIDED WITH 7-DAY PROGRAMMABLE THERMOSTATS. CONTROLS SHALL MAINTAIN PROGRAMMING AND TIME SETTING DURING A LOSS OF POWER PERIOD OF 10 HOURS MINIMUM. CONTROLLER SHALL BE CAPABLE OF OCCUPIED/UNOCCUPIED HEATING AND COOLING CONTROL WITH THERMOSTATIC SETBACK CONTROLS. BOTH OUTDOOR AIR SUPPLY AND EXHAUST DUCTS SHALL BE EQUIPPED WITH MOTORIZED DAMPERS THAT WILL AUTOMATICALLY SHUT WHEN THE SYSTEMS OR SPACES SERVED ARE NOT IN USE.

TEMPERATURE AND HUMIDITY CONTROL

COOLING/HEATING DINING: 75°F DB, 50% RH / 70°F DB COOLING/HEATING KITCHEN: 75°F DB, 50% RH / 70°F DB DEADBAND: +/- 5°F

COOLING/HEATING SETBACK: 85°F / 60°F DB (SET-BACK 1-HR PRIOR TO OCCUPANCY IS ADJUSTED TO 80°F / 65°F DB).

UNIT WILL TURN OFF AND ACTIVATE AUDIO-VISUAL ALARM UPON ACTIVATION OF SMOKE ALARM. DUCT SMOKE DETECTORS TO PROVIDE SHUT DOWN IN 30 SECONDS OR LESS.

ECONOMIZER

ECONOMIZER WILL UTILIZE DIFFERENTIAL ENTHALPY CONTROL.

DIFFUSER NOTES

. FINISH TO MATCH ARCHITECTURAL SPECIFICATIONS PROVIDE ALL REQUIRED MOUNTING FRAMES AND HARDWARE

100% MAKEUP AIR UNIT SCHEDULE																			
	MANUFACTURER					SUPPLY			GROSS	GAS HEATING					COMPI	RESSOR		WEIGHT	NOTES
MARK	AND MODEL	TON	CFM	ESP (INCH)	BHP	FAN HP	VOLTAGE	COOLING	SCMS COOLING	EMT ALK	GAS SUPPLY	LVG AIR	TEMP RISE	RLA	LRA	MCA	МОСР	#	
MAU #1	CARRIER 62DAB009 N8B3B-ADF	8	1385	0.89	0.53	1.0	208/3ø	98.44	61.28	27.0	80 MBH	80.7	53.7	23.3	164	36	50.0	1,920	1,2,3,4,5
MAU #2	CARRIER 62DAB009 N8B3B-ADF	8	1385	0.75	0.60	1.0	208/3ø	98.44	61.28	27.0	80 MBH	81.7	54.7	23.3	164	36	50.0	1,920	1,2,3,4,5

1. PROVIDE 4" MERV 8 FILTERS

2. PROVIDE 14" ROOF CURB.

3. INTIGRAL 100A FUSED DISCONNECT. 4. MODULATING 100,000 BTUH GAS HEAT

5. IHP SUPPLY FAN WITH VFD.

	NODOD-ADF																		`	o. IIII 501
	ROOF TOP UNIT SCHEDULE																			
	MANUFACTURER		OUTSIDE	OUTSIDE SUPPLY		PLY FAN		COOLING				GAS H	HEATING		ELEC	CTRICAL				
MARK	AND MODEL	TON	AIR CFM	CFM RANGE	ESP (INCH)	BHP	TOTAL GROSS MBH	SENSIBLE GROSS MBH	CONDENSER ENT AIR DB	ENT AIR WB	ARI EER/EER	INPUT MBH	OUTPUT MBH	COMPR- -ESSORS	COMP RLA	MCA	MOCP	VOLTS	WEIGHT #	NOTES
RTU-1	CARRIER 48HCSE11L2A5	10	900	3,400	0.70	1.94	113.48	92.74	98	81.6	12.00	180.0	120.0	1	15.9	53	60	230/3ø	1,457	1,2,3
RTU-2	CARRIER 48HCSE09L2A50AIJO	8.5	500	2,600	0.70	1.14	97.42	67.54	98	66.4	12.00	125.0	90.0	1	13.7	41	50	230/3ø	1,312	1,2,3
RTU-3	CARRIER 48HCSE09L2A50AIJO	8.5	500	2,600	0.70	1.14	97.42	67.54	98	66.4	12.00	125.0	90.0	1	13.7	41	50	230/3ø	1,312	1,2,3
RTU-4	CARRIER 48HCSB06L2A50AICO	5.0	200	2,000	0.70	1.59	58.03	46.59	98	65.4	15.20	72.0	50.0	1	15.9	28	40	230/3ø	866	1,2,3
RTU-5	CARRIER 48HCSB06L2A50AICO	5.0	300	2,000	0.30	1.24	57.77	49.44	98	65.1	15.20	72.0	50.0	1	15.9	28	40	230/3ø	866	1,2,3
RTU-6	CARRIER 48HCSB06L2A50AICO	5.0	300	2,200	0.30	1.57	57.44	50.12	98	64.2	15.20	72.0	50.0	1	15.9	28	40	230/3ø	866	1,2,3

- APPLY ROOF SYSTEM AND FLASHING WATER TIGHT ALL AROUND CURB.
- . INSTALL 3/8" VIBRATION ISOLATING RUBBER GASKET

. DUCT CONNECTION FRAME INTEGRAL TO ROOF CURB.

CONTINUOUS AROUND BASE OF CURB.

MECHANICAL NOTES:

PERFORMING ALL THE WORK SHOWN.

- GENERAL NOTES:

 VISIT SITE AND BECOME FAMILIAR WITH THE EXISTING BUILDING CONDITIONS. INFORM THE ENGINEER OF ANY CONTINGENCIES WHICH INFLUENCE THE EXECUTION OF THE WORK. NO EXTRAS WILL BE ALLOWED DUE TO FAILURE TO MAKE THE ABOVE EXAMINATION OR NEGLECT TO INCLUDE ALL MATERIALS AND LABOR REQUIRED TO PROPERLY COMPLETE THE PROJECT.
- PERMITS, FEES AND CODE REGULATIONS IE CONTRACTOR SHALL, AT HIS OWN EXPENSE, OBTAIN ALL NECESSARY PERMITS, PAY ALL LEGAL FEES AND CHARGES PERTAINING TO THE WORK UNDER THIS SECTION, COMPLY WITH ALL NATIONAL CODES, STATE OR LOCAL MUNICIPAL BUILDING CODES, SAFETY LAWS, ORDINANCES AND REGULATIONS REGARDING BUILDING AND PUBLIC SAFETY APPLICABLE TO THE PROJECT.
- CONTRACTOR'S FOR THE VARIOUS PORTIONS OF THE WORK UNDER THIS SECTION SHALL GUARANTEE AND FURNISH WRITTEN CERTIFICATE TO THIS EFFECT, THAT ALL SYSTEMS SHALL BE LEFT IN PERFECT WORKING ORDER AND THAT ANY AND ALL DEFECTS WHICH DEVELOP WITHIN ONE(1) YEAR, EXCEPTING NORMAL WEAR AND TEAR, WILL BE REPLACED AT NO ADDITIONAL COST TO THE OWNER.
- 4. SHOP DRAWINGS, SUBMITTAL DRAWINGS AND RECORD DRAWINGS SUBMIT SHOP DRAWINGS, SUBMITTAL DRAWINGS AND RECORD DRAWINGS TO ARCHITECTS.
- 5. CLARITY AND UNDERSTANDING OF CONTRACT DOCUMENTS THE CONTRACTORS, BY SUBMITTING A BID, SHALL INDICATE THAT THEY HAVE THOROUGHLY REVIEWED THE DOCUMENTS AND IN THEIR OWN OPINION, AGREE THAT THE WORK SHOWN OR INDICATED THEREON IS FEASIBLE FOR A PROJECT OF THIS NATURE AND THAT EACH CONTRACTOR IS CAPABLE FINANCIALLY AND OTHERWISE, OF
- SCOPE OF WORK:
 PROVIDE NEW HVAC SYSTEM AS SHOWN ON THE DRAWINGS. COORIDINATE WORK WITH OTHER TRADES TO AVOID INTERFERENCES AND TO PRESENT A NEAT, WORKMANLIKE APPEARANCE. INTERFERENCES WHICH RESULT FROM POOR COORDINATION WILL NOT BE CONSIDERED AS EXTRA WORK. ALL MINOR DEVIATIONS REQUIRED DUE TO INTERFERENCES WITH THE WORK OF OTHERS SHALL BE MADE BY HVAC CONTRACTOR AT NO EXTRA COST. 7. THE DRAWINGS ARE SCHEMATIC IN NATURE AND SHOW APPROXIMATE LOCATIONS OF
- EQUIPMENT, DUCTWORK ETC. IT SHALL BE CONTRACTOR'S RESPONSIBLITY TO FIELD VERIFY LOCATIONS OF NEW EQUIPMENT, DUCTWORK ETC. 8. INSTALL AHU'S AND DUCTWORK TO PROVIDE CLEARANCE FOR FIXTURES. PROVIDE ISOLATION DAMPERS TO REDUCE NOISE TRANSMISSION TO STRUCTURAL MEMBERS.
- USE FLEX CONNECTIONS BETWEEN AHU'S AND DUCTS 9. ALL DUCTWORK NOT LOCATED IN THE AIRCONDITIONED SPACE SHALL BE INSULATED ON THE OUTSIDE WITH A MINIMUM OF 1-INCH THICK INSULATION. DUCT CONSTRUCTION SHALL CONFORM TO ASHRAE OR SMACNA STANDARDS. DUCT SHALL BE #1 GALVANIZED IRON. LOW VELOCITY FLEXIBLE CONNECTIONS SHALL BE FLEXMASTER, TRIPLE LOCK FLEXIBLE ALUMINUM DUCT, MAX LENGTH 6-FT
- CONNECTIONS EXCEEDING 6-FT SHALL BE W/ 1" RIGID FIBERGLASS DUCT W/VAPOR BARRIER TO WITHIN 6 FT OF DIFFUSER. DUCT SIZES SHOWN ARE NET. 10. WHERE SUPPLY OR RETURN GRILLS OR DIFFUSERS ARE INSTALLED IN FIRE RATED WALL OR CEILING, INSTALL FIRE DAMPER AHEAD OF IT AS A PART OF THE
- DIFFUSER OR GRILI 11. INSTALL FIRE DAMPER WHEREVER FIRE WALLS ARE PENETRATED BY DUCTWORK. 12. ALL AHU'S/ RTU'S SHALL HAVE SMOKE DETECTORS OR FIRESTAT THAT SHUT DOWN
- UNIT WHEN ACTIVATED. FURNISH TEST AND INDICATOR CIRCUITS 13. INSTALL VOLUME DAMPERS IN ALL DIFFUSERS OR IN THE NECK SECTION OF
- DIFFUSERS (OPPOSED BLADE DAMPER). 14. DUCT DIMENSIONS ARE TYPICAL AND MAY BE ADJUSTED TO FIT CONSTRUCTION METHOD AND LOCATION WITHOUT DECREASING THE CROSS-SECTIONAL AREA SPECIFIED. VERIFY CLEARANCES THROUGH ALL STRUCTURAL OPENINGS BEFORE
- 15. ALL T-STATS SHALL HAVE LOCKABLE COVERS. VERIFY LOCATION W/ ARCHITECT BEFORE INSTALLING. INSTALL @ 48" AFF.
- 16. ROUTE CONDENSATE DRAIN AS SHOWN OR TO NEAREST FLOOR DRAIN.
- 17. ALL DUCT SIZES SHOWN ARE CLEAR AIR STREAM DIMENSIONS. 18. DO NOT FABRICATE DUCT FROM THESE DRAWINGS. FIELD VERIFY ALL DIMENSIONS. AND AVAILABLE SPACE. DIMENSIONS GIVEN ON DRAWINGS ARE INSIDE FREE AREA. BALANCE DAMPERS IN ALL SUPPLY AND RETURN BRANCHES. BRANCH TAKEOFFS
- SHALL HAVE 45 DEGREE ENTRY FITTING W/VOLUME DAMPER. 19. COORDINATE ALL WORK INDICATED WITH ALL OTHER TRADES INVOLVED IN THIS PROJECT, AS NECESSARY: IT IS THE RESPONSIBILITY OF THE CONTRACTOR TO VERIFY DIMENSIONS, WORKING CLEARANCES, AND THE WORKING ARRANGEMENT OF EQUIPMENT, AS WELL AS THE LOCATIONS OF THE EQUIPMENT, AND ASSOCIATED
- DUCTWORK, PIPING, ETC., AND TO COORDINATE THE INSTALLATION ACCORDINGLY. 20. CONTRACTOR SHALL PROVIDE ALL HVAC UNITS, EXHAUST FANS, SENSORS, CONTROLS, AND ALL OTHER DEVICES AND EQUIPMENT FOR COMPLETE AND FULLY OPERATIONAL SYSTEMS, UNLESS SPECIFICALLY NOTED AS FURNISHED BY OTHERS. ALL EQUIPMENT USED ON THIS PROJECT IS TO BE UL LISTED AND BEAR THE UL
- 710 LISTED LABEL. 21. HVAC WORK SHALL INCLUDE FURNISHING (EXCEPT WHERE NOTED), INSTALLING, AND TESTING ALL HVAC SYSTEMS FOR A COMPLETE, FULLY OPERATIONAL, AND CODE COMPLIANT INSTALLATION INCLUDING BUT NOT LIMITED
- A. MANUFACTURER'S STANDARD ROOF CURBS OR AS SPECIFIED, C. COPPER CONDENSATE DRAINS WITH MINIMUM 3" TRAP DEPTH (U.N.O.) AND PROPER
- SLOPE, GAS PIPING SUPPORTED EVERY 10 FEET, AND OTHER PIPING AND FITTINGS, D. DUCTWORK, TURNING VANES, SPLITTERS, DAMPERS, SPIN-INS, ETC. IN ACCORDANCE WITH SMACNA STANDARDS FOR LOCATION, THICKNESS, AND CONSTRUCTION, E. DIFFUSERS, SUPPLY AND RETURN GRILLES,
- F. LINE SETS, AUXILIARY DRAIN PANS AND PIPING, AND FRESH AIR INTAKE FOR EACH AIR HANDLER IN SPLIT SYSTEMS (IF USED), G. CONTROLS, SENSORS, AND LOW VOLTAGE WIRING (E.G. 8-STRAND, 18 AWG.
- NON-SHIELDED CABLE), H. SHIMS AND MISCELLANEOUS STEEL FOR LEVEL INSTALLATION AND PROPER
- CONDENSATE DRAINAGE I. SMOKE DETECTORS IN RETURN AIR DUCTS OR SUPPLY DUCTS AS REQUIRED BY
- LOCAL CODE OFFICIALS, J. WEATHER-PROOF ROOF AND WALL PENETRATIONS FOR COPPER PIPING, MAKE-UP
- 22. CONTRACTOR SHALL VERIFY PLACEMENT AND SUPPORT OF ROOFTOP AIR CONDITIONING UNITS, EXHAUST FANS, CONDENSING UNITS, AND ALL OTHER ROOF SUPPORTED EQUIPMENT PRIOR TO FABRICATION OF DUCTWORK. CONTRACTOR SHALL PROVIDE MISCELLANEOUS STRUCTURAL STEEL SUPPORT FOR ROOFTOP. SUSPENDED AND WALL-MOUNTED EQUIPMENT AND COORDINATE FINAL LOCATIONS OF EQUIPMENT WITH EXISTING CONDITIONS, E.G. JOIST/TRUSS LOCATIONS, AND WITH LANDLORD WHERE REQUIRED. CONTRACTOR SHALL SUBMIT SHOP DRAWINGS, SEALED BY THE STRUCTURAL ENGINEER, FOR EQUIPMENT SUPPORT.
- 23. SUBMITTALS AND SUBSTITUTIONS: THE CONTRACTOR SHALL SUBMIT INFORMATION TO

- THE ENGINEER FOR ALL EQUIPMENT, DEVICES, AND PIPING COMPONENTS INTENDED TO BE PROVIDED FOR THIS PROJECT. ALL SUBSTITUTIONS FOR EQUIPMENT AND MATERIALS OTHER THAN WHAT IS SPECIFIED SHALL BE SUBMITTED FOR REVIEW
- PRIOR TO PURCHASE AND/OR INSTALLATION. 24. UNLESS OTHERWISE SPECIFIED, ALL REQUIRED CUTTING AND PATCHING OF FLOORS. WALLS, PARTITIONS AND OTHER MATERIALS IN THE BUILDING IS TO BE INCLUDED IN THE SCOPE. THE CONTRACTOR SHALL RESTORE THESE AREAS TO ORIGINAL CONDITION UPON COMPLETION. ALL PENETRATIONS OF WALLS, CEILINGS, OR FLOORS SHALL BE CORE-DRILLED, SLEEVED, AND SEALED TO COMPLY WITH RESPECTIVE
- SHALL COMPLY WITH UL LISTED SLEEVE ASSEMBLY REQUIREMENTS. 25. THE CONTRACTOR SHALL KEEP ALL EQUIPMENT AND MATERIALS, AND ALL PARTS OF THE BUILDING, EXTERIOR SPACES AND ADJACENT STREETS, SIDEWALKS AND PAVEMENTS, FREE FROM MATERIAL AND DEBRIS RESULTING FROM THE EXECUTION OF THIS WORK. EXCESS MATERIALS WILL NOT BE PERMITTED TO ACCUMULATE

FITHER ON THE INTERIOR OR THE EXTERIOR

BUILDING CODE REQUIREMENTS. ALL PENETRATIONS THROUGH FIRE RATED WALL

- 26. ALL CONSTRUCTION DEBRIS TO BE REMOVED UNDER THIS CONTRACT SHALL BECOME THE PROPERTY OF THE CONTRACTOR WITH THE EXCEPTION OF SPECIFIC EQUIPMENT AND APPARATUS REQUESTED BY THE BUILDING REPRESENTATIVE, ARCHITECT OR AS NOTED TO BE RELOCATED ON THE DRAWINGS SHALL BE PROPERLY DISPOSED OF BY
- 27. DUCTWORK IS SHOWN DIAGRAMMATICALLY AND DOES NOT SHOW ALL OFFSETS, DROPS AND RISES OF RUNS. THE CONTRACTOR SHALL ALLOW IN HIS PRICE FOR ROUTING OF DUCTWORK TO AVOID OBSTRUCTIONS. EXACT LOCATIONS ARE SUBJECT
- TO APPROVAL OF ARCHITECT. COORDINATION WITH OTHER TRADES IS REQUIRED. 28. ALL DUCT SIZES SHOWN ARE INSIDE, FREE AREA DIMENSIONS REQUIRED FOR PROPER AIRFLOW. UNLESS SPECIFICALLY INDICATED, ALL DUCT TRANSITIONS SHALL BE SMOOTH AND GRADUAL WITH MAXIMUM DIVERGENT ANGLE OF 15°.
- 29. SUPPORT ALL DUCTWORK FROM BUILDING STRUCTURE AND/OR FRAMING IN AN APPROVED MANNER. WHERE OVERHEAD CONSTRUCTION DOES NOT PERMIT FASTENING OR SUPPORTS FOR EQUIPMENT, FURNISH ADDITIONAL FRAMING. INSTALL DUCTWORK AS HIGH AND TIGHT TO THE STRUCTURE AS POSSIBLE. 30. PROVIDE VOLUME DAMPER AT CONNECTION OF DIFFUSER BRANCH INCLUDING THOSE
- CONNECTING TO THE BOTTOM OF MAIN TRUNK. 31. PROVIDE TURNING VANES IN ALL ELBOWS IN SUPPLY ALL ELBOWS IN SUPPLY AIR
- 32. ALL FLEXIBLE DUCTWORK SHALL BE STRETCHED AND SUSPENDED IN ACCORDANCE WITH LOCAL CODE. SUPPORT EVERY 3' WITH 2" WIDE GALVANIZED STEEL BANDS (MAX. SAG 1/2" BETWEEN SUPPORTS). MAX. LENGTH OF DUCT SHALL BE SIX (6)
- 33. CONTRACTOR SHALL COVER ALL HVAC UNITS, ALL RELATED DISTRIBUTION EQUIPMENT AND ALL DUCT OPENINGS DURING STORAGE AT CONSTRUCTION SITE AND AT THE TIME OF ROUGH INSTALLATION UNTIL FINAL STARTUP TO PREVENT DIRT, DEBRIS,
- CONSTRUCTION DUST, AND MOISTURE FOR ENTERING 34. CONTRACTOR SHALL NOT OPERATE A/C UNITS WITHOUT CONSTRUCTION FILTERS IN PLACE. REPLACE ALL FILTERS AFTER CONSTRUCTION AND BEFORE REQUESTING
- FINAL PAYMENT WITH MINIMUM MERV 8 FILTERS. 35. REMOVABLE ACCESS TILE AND/OR ACCESS DOOR ARE REQUIRED IN HUNG CEILINGS, SHAFTS AND WALLS FOR ALL VOLUME AND FIRE DAMPERS, AUTOMATIC DAMPERS AND ALL OTHER MECHANICAL EQUIPMENT AND DEVICES. HVAC CONTRACTOR TO FURNISH ACCESS LOCATION REQUIREMENTS TO GENERAL CONTRACTOR. ACCESS TILE IDENTIFICATION: PROVIDE BUTTONS, TABS, AND MARKERS TO IDENTIFY LOCATION OF
- CONCEALED DAMPERS AND EQUIPMENT 36. CONTRACTOR SHALL PROVIDE CURBS/SEALS, FLASHING, EXPANSION DUCTS, WEATHER CUPS, ETC. FOR ALL EXTERIOR MOUNTED EQUIPMENT AND PENETRATIONS TO MAKE WEATHER-PROOF AND WATER-TIGHT. COORDINATE WITH PENETRATIONS FOR ELECTRICAL SERVICE TO MOTORIZED EQUIPMENT. COMPLY WITH THE OWNER/LANDLORD AND THE OWNER'S/LANDLORD'S ROOFING CONTRACTOR TO
- MAINTAIN ROOF WARRANTY. 37. CONTRACTOR SHALL PROVIDE THERMOSTATS AND REMOTE SENSORS FOR NEW COOLING AND HEATING EQUIPMENT. DO NOT INSTALL THERMOSTATS OR SENSORS
- CLOSE TO HEAT AND/OR STEAM PRODUCING APPLIANCES. 38. CONTRACTOR SHALL INSULATE SUPPLY GRILLES/DIFFUSERS IN THE PLENUM SIDE TO
- PREVENT CONDENSATION OR PROVIDE INSULATED SUPPLY GRILLES/DIFFUSERS. 39. PAINT ALL SUPPLY AND RETURN AIR DEVICES AS REQUIRED BY THE OWNER. 40. ALL DUCTWORK SHALL BE SEALED FOR SEAL CLASS B AND LEAK TESTED AT THE
- RATED PRESSURE. 41. FIRE DAMPERS MUST BE INSTALLED AT ALL LOCATIONS WHERE DUCT PENETRATES A FIRE RATED WALL. PROVIDE SMOKE/FIRE DAMPERS FOR AN EGRESS. PROVIDE ACCESS DOORS AS REQUIRED. FIRE DAMPERS TO BE OF TYPE APPROVED BY THE
- AGENCIES HAVING JURISDICTION. 42. PROVIDE MAXIMUM 6" WIDE FLEXIBLE CONNECTOR FOR VIBRATION ISOLATION TO CONNECT DUCTS TO ROTATING EQUIPMENT INCLUDING AIR HANDLING UNITS, FAN
- COIL UNITS, FANS, ROOF TOP UNITS, AND WHERE INDICATED ON THE DRAWINGS. 43. CONTRACTOR SHALL NOT LOCATE ANY FRESH AIR INTAKE AND MAKE-UP AIR INTAKE WITHIN TEN (10) FEET OF ANY EXHAUST OR VENT DISCHARGE.
- 44. CONTRACTOR SHALL FURNISH EQUIPMENT DISCONNECTS WHERE THEY ARE NOT FURNISHED BY EQUIPMENT MANUFACTURER. CONTRACTOR SHALL INSTALL ALL
- DISCONNECTS AND MAKE FINAL CONNECTION. 45. SEAL OPENINGS AROUND DUCTS AND PIPING THROUGH PARTITIONS, WALLS AND FLOORS (NOT IN SHAFTS) WITH MINERAL WOOL OR OTHER NONCOMBUSTIBLE
- 46. CONTRACTOR SHALL PERFORM TESTING, ADJUSTING, AND BALANCING (T.A.B.) OF ALL AIR SYSTEMS. CONTRACTOR SHALL ALSO PERFORM T.A.B. OF ALL CHILLED OR CONDENSER WATER SYSTEMS (WHERE SHOWN OR SPECIFIED). USE A.A.B.C. OR N.E.B.B. CERTIFIED TECHNICIANS AND PROVIDE A WRITTEN REPORT OF RESULTS TO TENANT (AND LL IF APPLICABLE) PRIOR TO REQUEST FOR FINAL PAYMENT. THE

TAB AGENCY SHALL SUBMIT TO THE OWNER (6) COPIES OF A WRITTEN REPORT

47. CONTRACTOR SHALL DEVELOP AND MAINTAIN A SET OF RED-LINED "AS BUILT" DRAWINGS AT THE PROJECT CONSTRUCTION SITE AND MADE AVAILABLE TO THE ARCHITECT/ENGINEER UPON REQUEST. RED-LINED DRAWINGS MUST BE KEPT CURRENT AND REFLECT ALL ACTUAL ASPECTS OF THE INSTALLATION THAT DEVIATE FROM RECORD DESIGN DRAWINGS. RED-LINED DRAWINGS SHALL INCLUDE ALL PUNCH-LIST ITEMS AND TESTING, AND SHALL BE SUBMITTED TO THE ARCHITECT/ENGINEER AT THE COMPLETION OF THE PROJECT.

WITHIN 10 DAYS AFTER THE INSPECTION IS COMPLETE.

- DO NOT EXCEED FLEX DUCT MORE THAN 6'-0". WHEN LENGTH IS GREATER THAN 6'-0", USE ROUND DUCT W/FLEX CONNECTION (1 1/2" THK. BLANKET INSULATION W/ VAPOR BARRIER & ALUM. DUCT TAPE).
- ALL REGISTERS 24" X 24" EXCEPT AS NOTED.
- COMPLETE KITCHEN EXHAUST AND SUPPLY AIR SYSTEM SHALL COMPLY WITH ALL REQUIREMENTS OF NFPA-96.
- ALL HOOD EXHAUST DUCT SHALL BE BLACK OR STAINLESS STEEL, WELDED CONSTRUCTION WITH ACCESS PANELS AT EVERY CHANGE IN DIRECTION.
- ALL DUCTWORK AT SEATING AND SALES AREAS SHALL BE SPIRAL STEEL ROUND DUCTS AND SHALL BE EXTERNALLY INSULATED WITH 1½" THK FIBERGLASS INSULATION WITH VAPOR BARRIER. ALL EXPOSED DUCTS, GRILLES AND SUPPORTS SHALL BE PAINTED MATT BLACK COLOR. DUCTWORK SHALL BE FABRICATED ACCORDING TO THE LATEST EDITION OF SMANCA AND ASHRAE STANDARDS.

SCALE: NO SCALE


DRAWN:

DATE: JAN 2018


CHECKED:

NEW LAWRENCE GROCERY


902 E. BAYSHORE, SAN LEON, TEXAS 77539

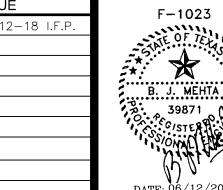





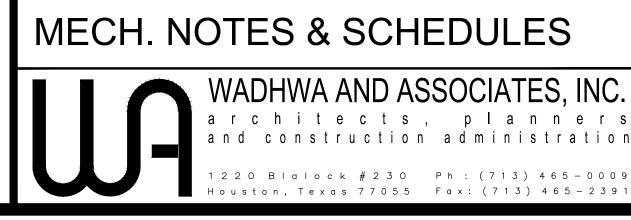

V I S I O N

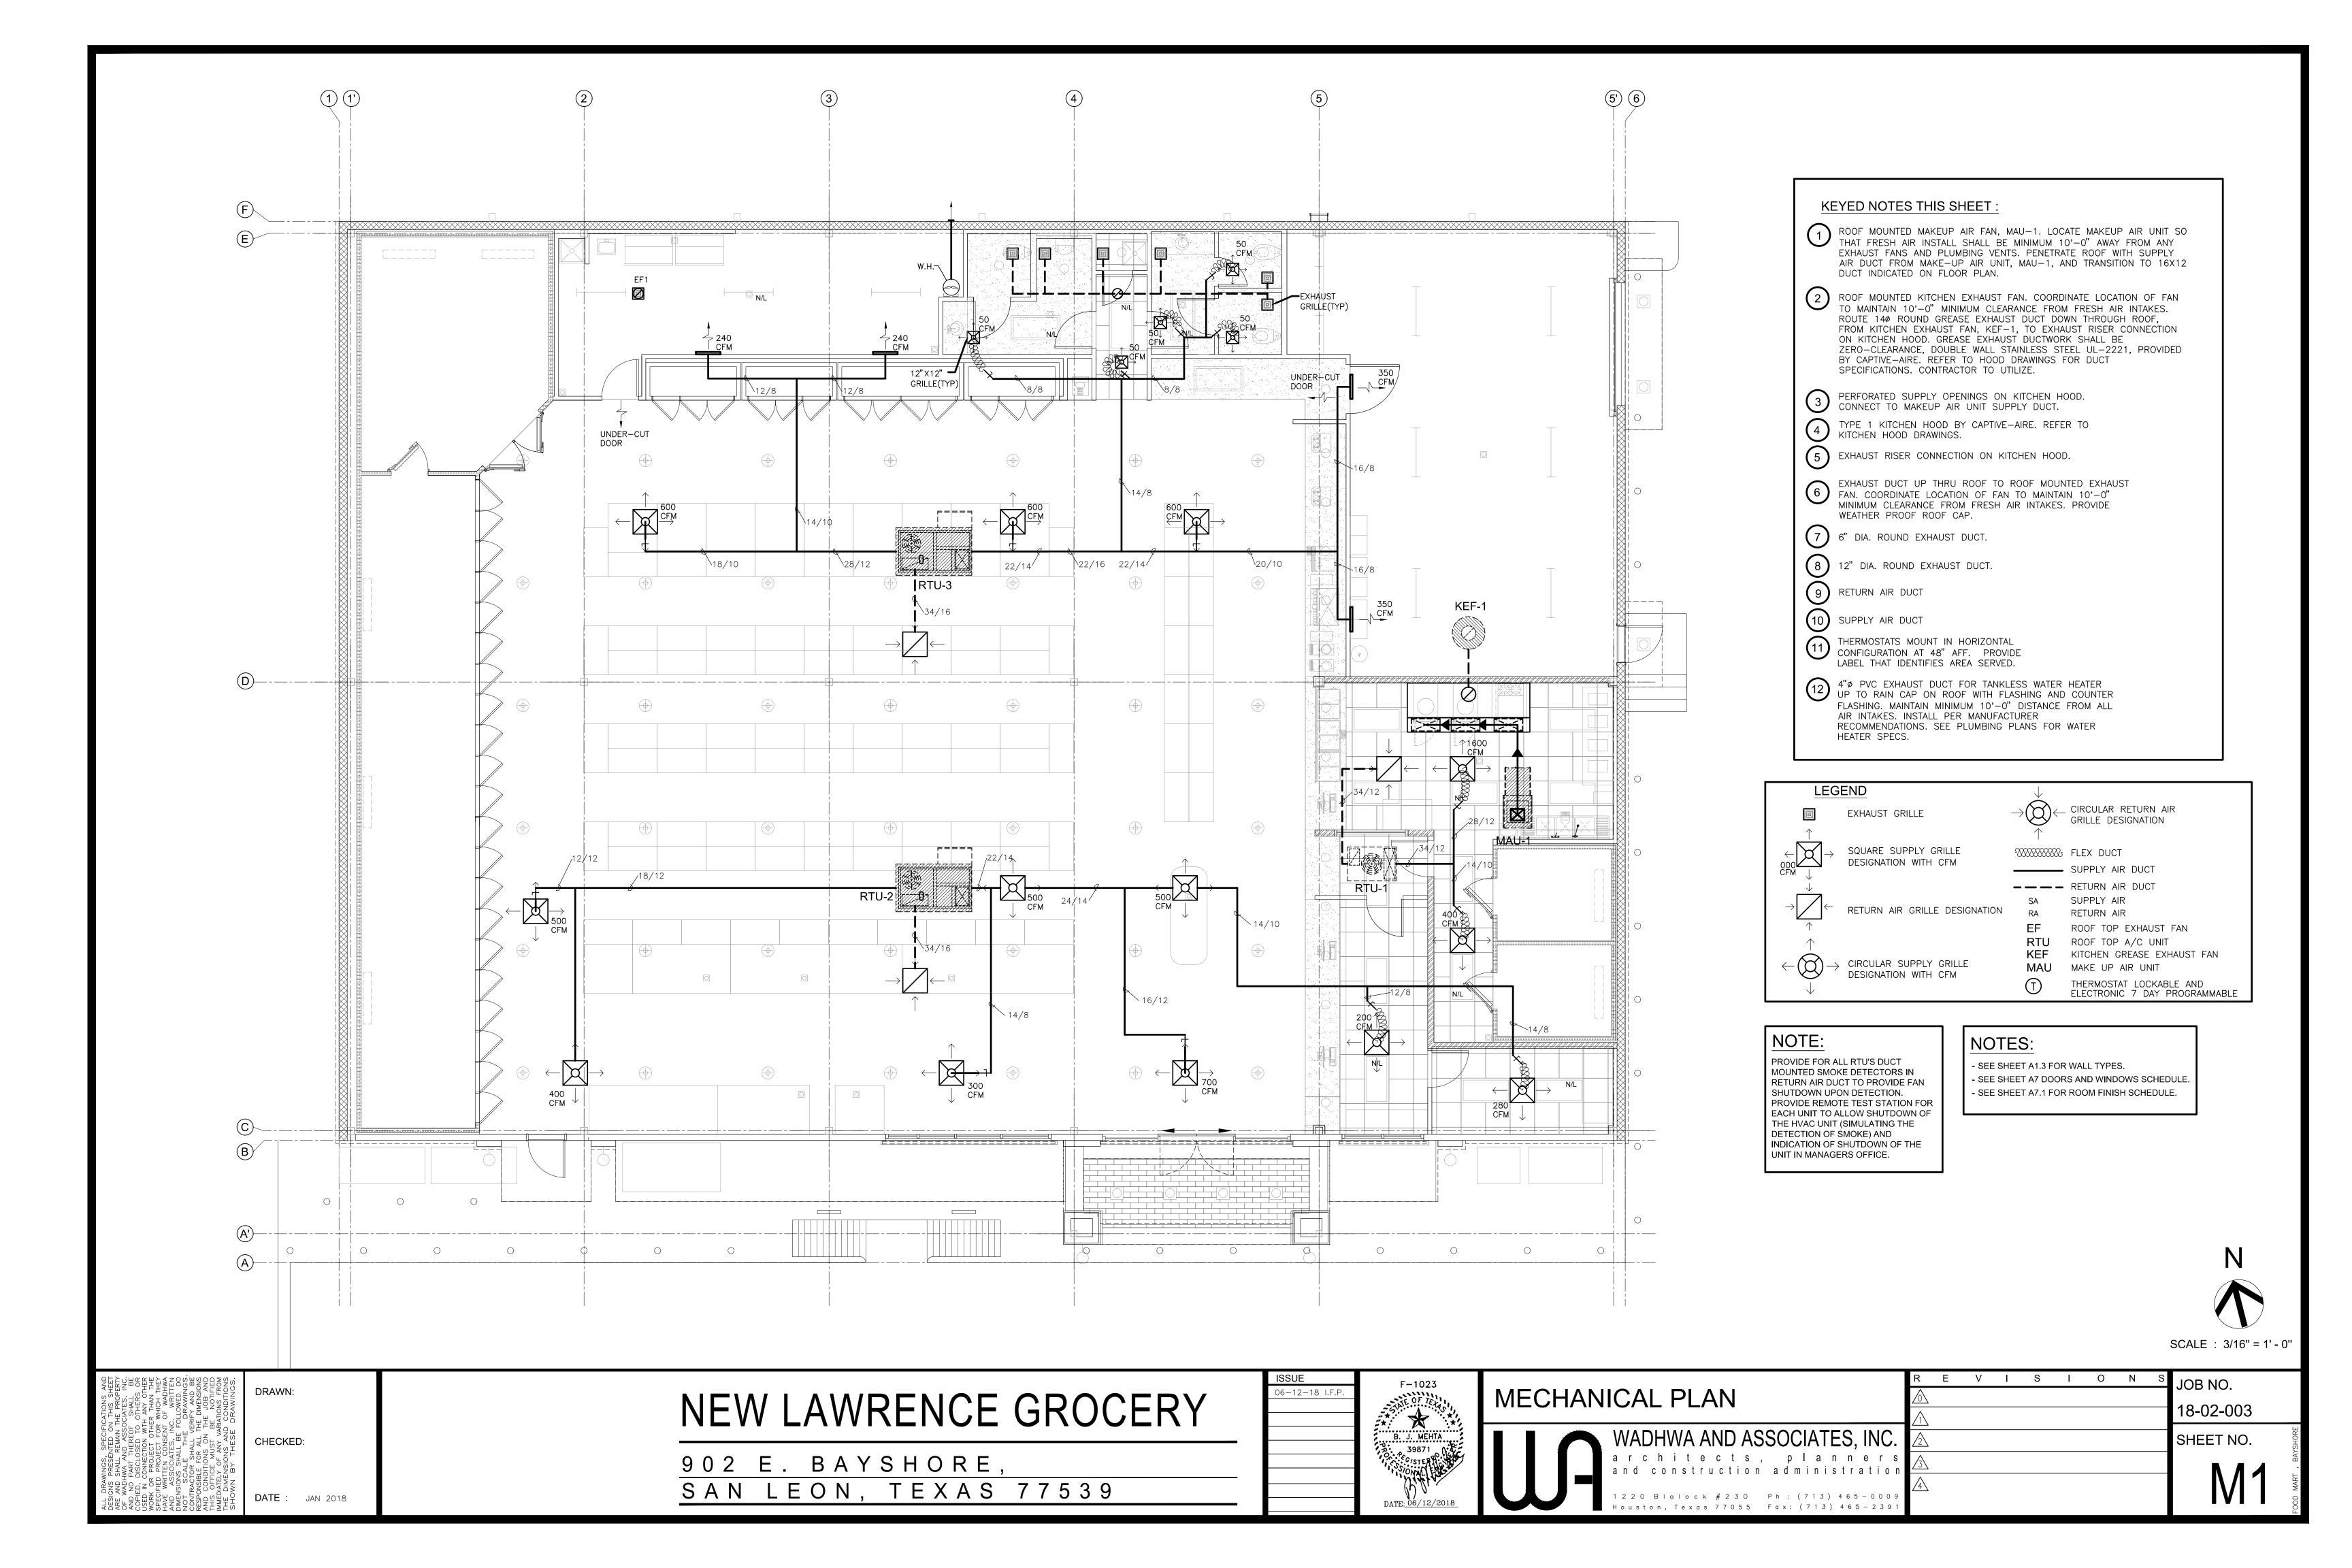

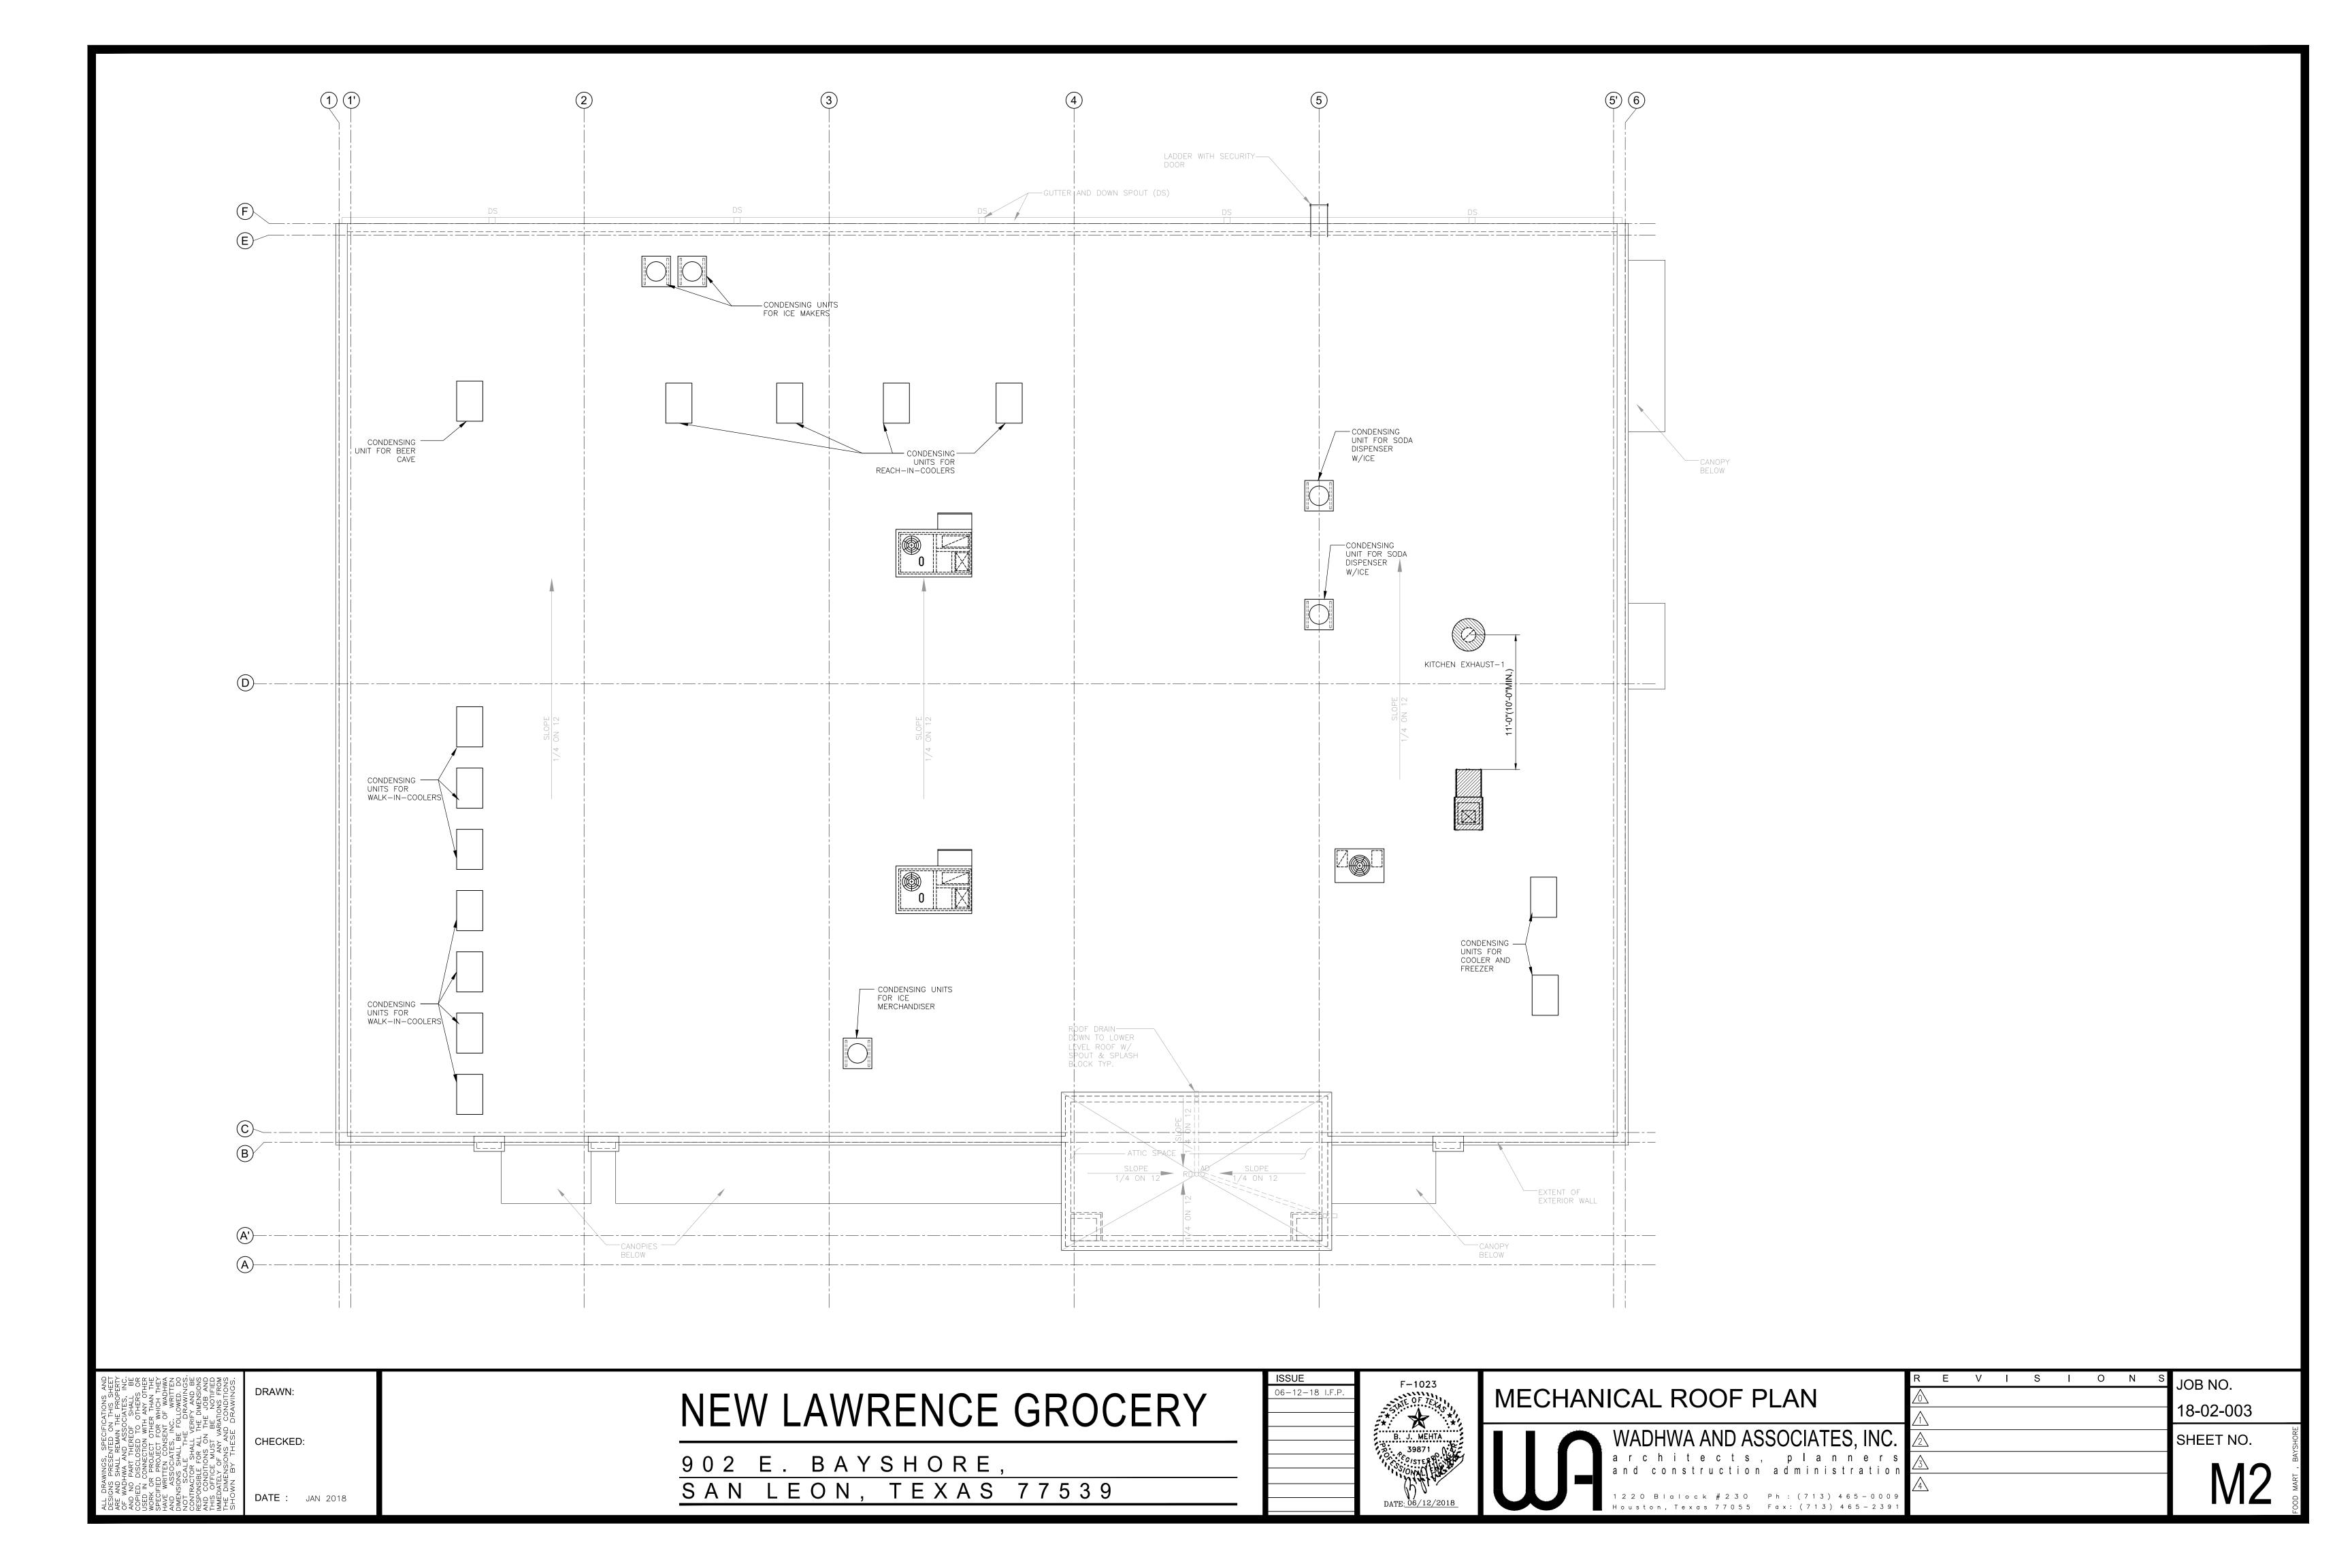

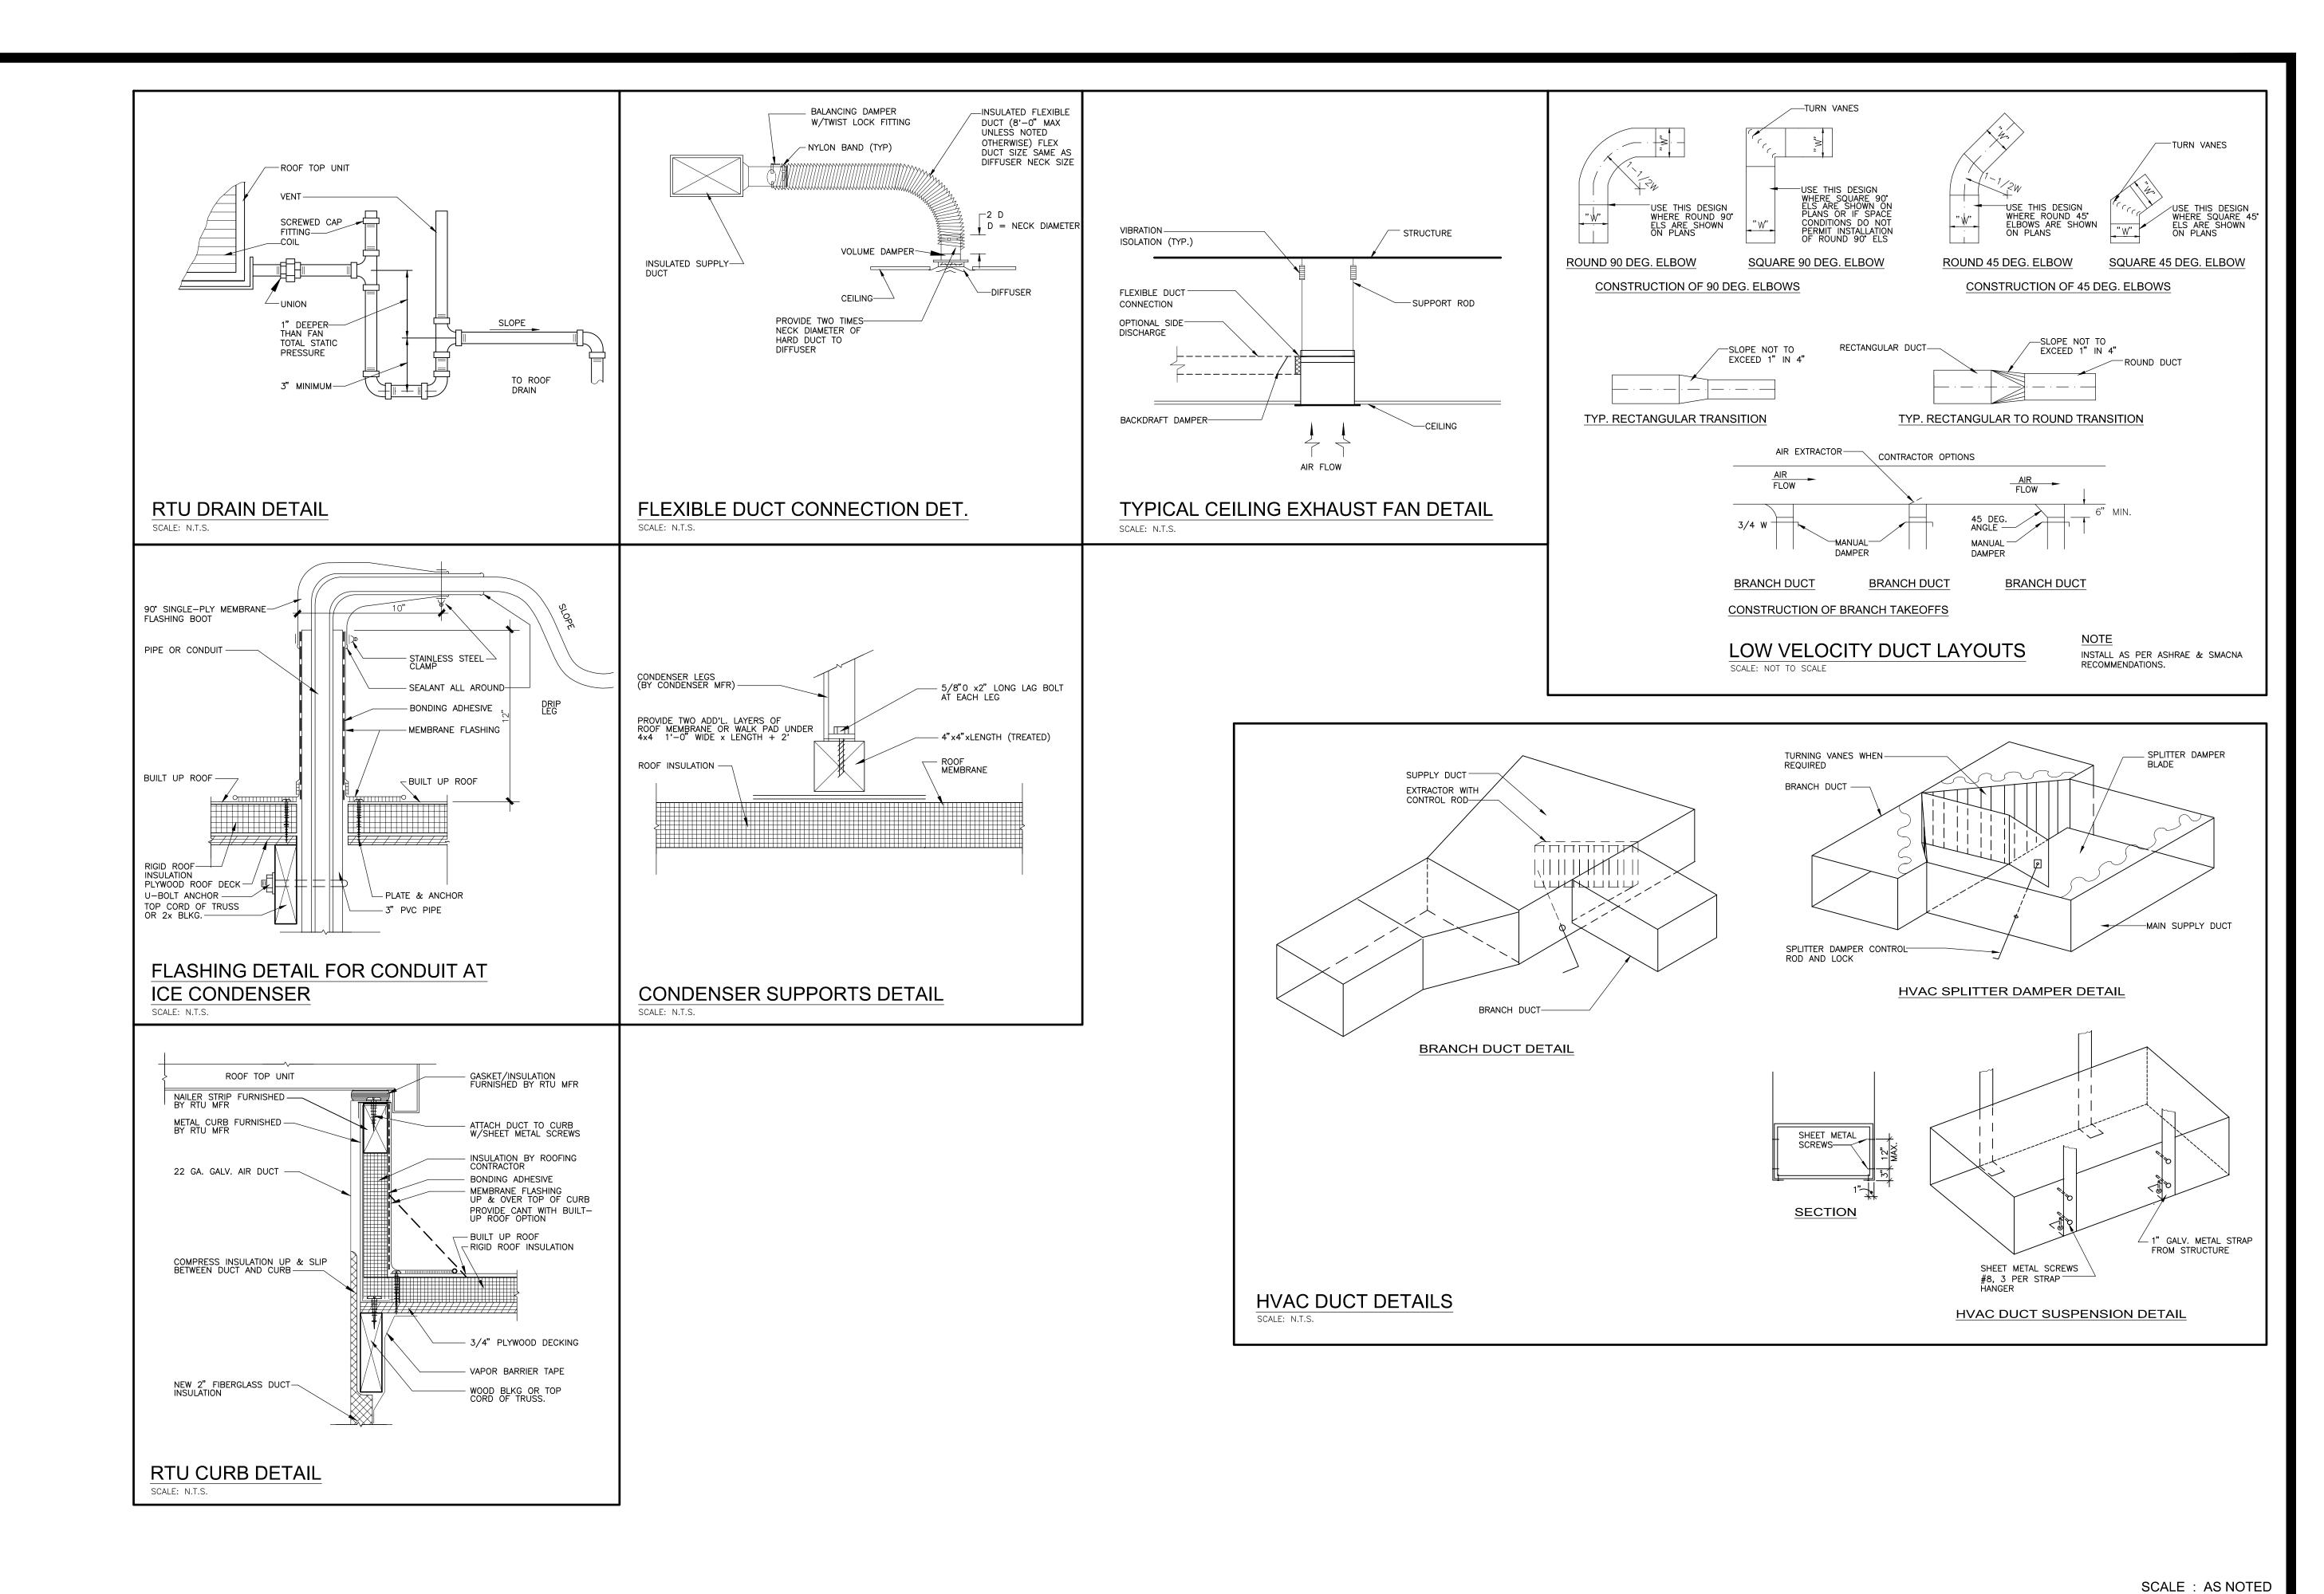


DRAWN: CHECKED:

DATE: JAN 2018


NEW LAWRENCE GROCERY


902 E. BAYSHORE, LEON, TEXAS 77539

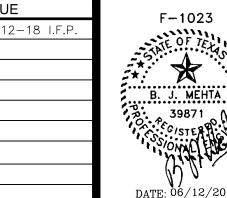






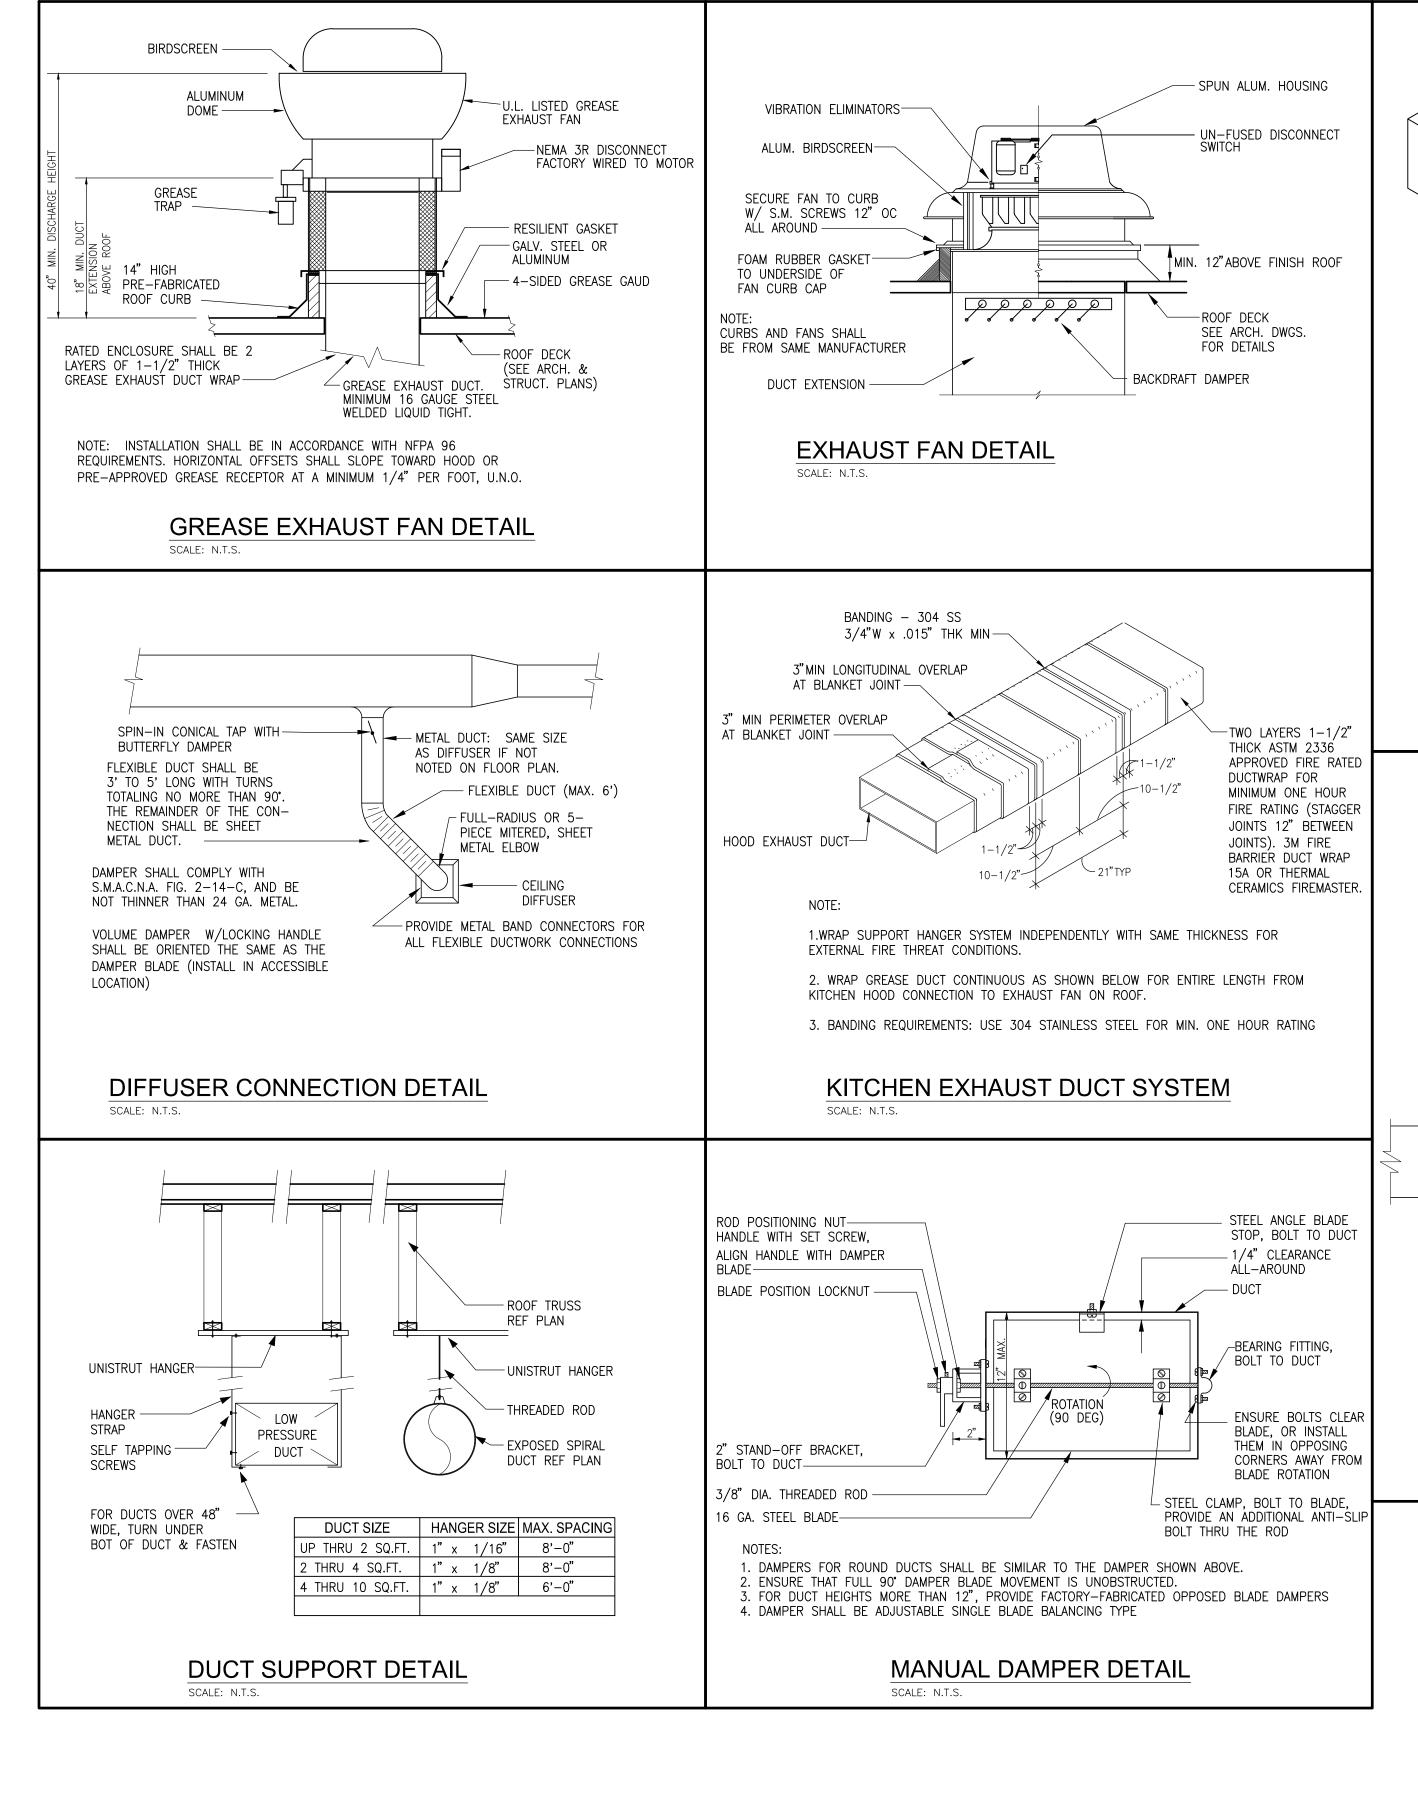

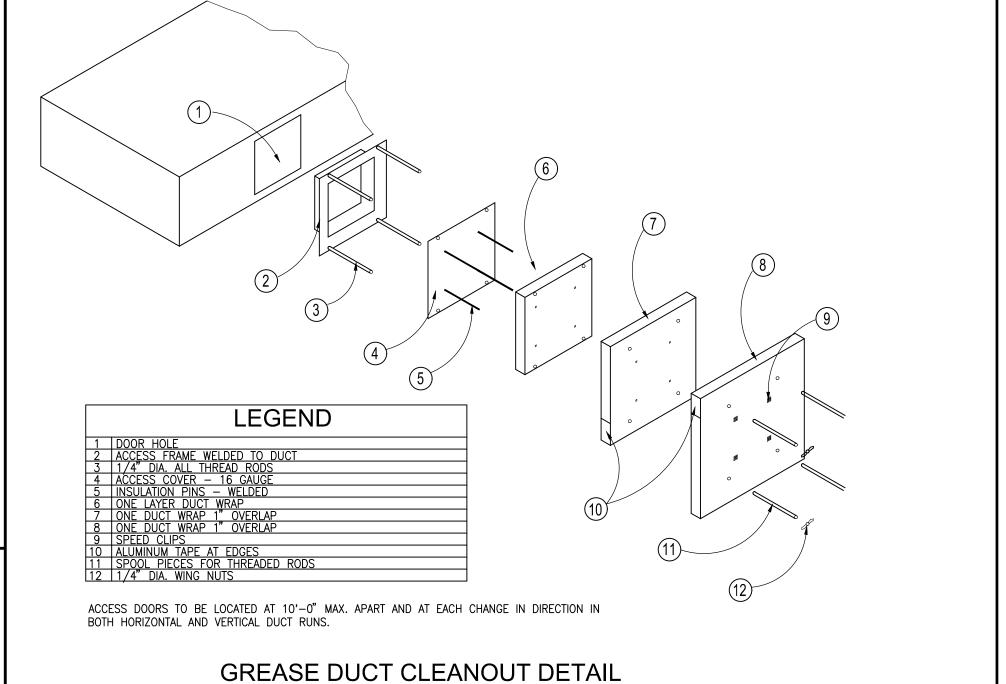

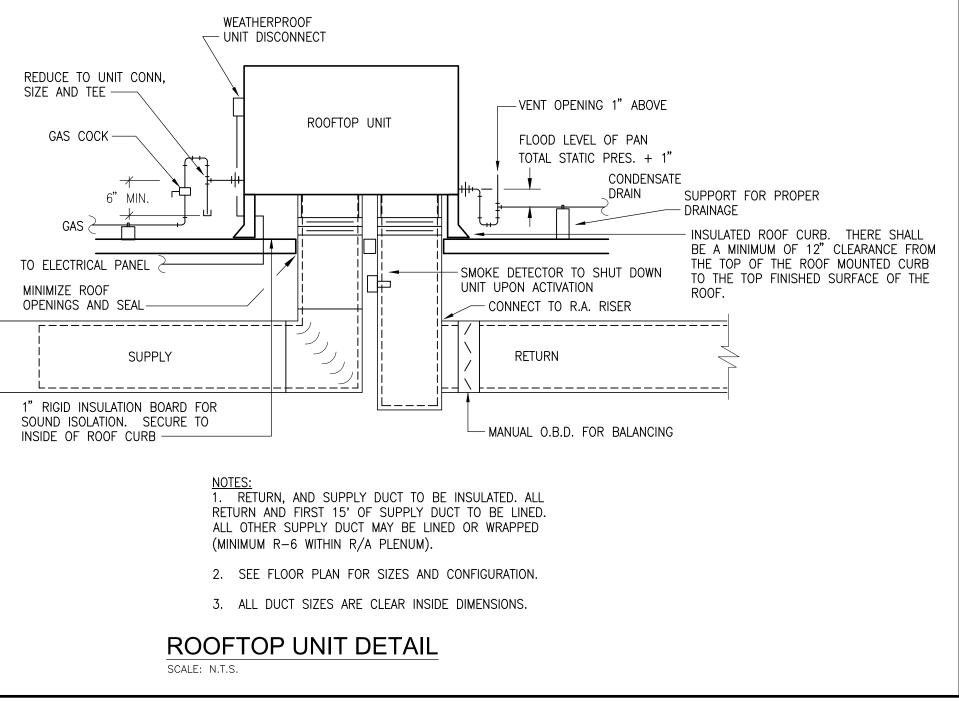

SCALE: AS NOTED


CHECKED:

DRAWN:


DATE: JAN 2018

NEW LAWRENCE GROCERY

902 E. BAYSHORE, LEON, TEXAS 77539

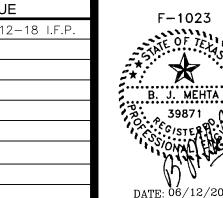



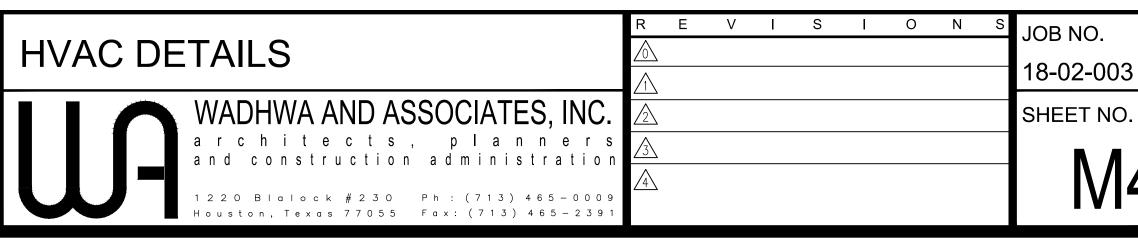

KITCHEN ELECTRICAL NOTES

- ELECTRICAL PLAN SHOWS ROUGH-IN POINTS AND SCHEDULED CONNECTION KITCHEN EQUIPMENT CONTRACTOR WILL PROVIDE DIMENSIONED ROUGH-IN DRAWINGS FOR CONSTRUCTION. 2. ELECTRICAL SYSTEM IS DESIGNED FOR $\underline{\hspace{0.5cm}}$ 120/208 VOLTS, $\underline{\hspace{0.5cm}}$ PHASE,
- 3. ELECTRICAL DIVISION SHALL FURNISH AND INSTALL ALL JUNCTION BOXES, RECEPTACLES, COVER PLATES, PULL BOXES, CONDUIT AND WIRING EXCEPT WHERE NOTED. RECEPTACLES AND COVER PLATES SHALL BE BRUSHED STAINLESS STEEL FURNISHED BY ELECTRICAL DIVISION.

<u>60</u> HERTZ, <u>4</u> WIRE SYSTEM.

- 4. ALL CONDUIT RUNS INDICATED FOR REFRIGERATION, DRINK AND LIQUOR SYSTEM LINES SHALL BE FURNISHED AND INSTALLED BY THE ELECTRICAL DIVISION. CONDUIT SHALL HAVE 24" MINIMUM RADIUS BENDS.
- KITCHEN EQUIPMENT CONTRACTOR SHALL FURNISH AND INSTALL VAPOR PROOF VENTILATOR LIGHTS COMPLETE WITH LAMPS. INTERCONNECTING CONDUIT, WIRING WITH WALL SWITCH FURNISHED AND INSTALLED BY THE ELECTRICAL DIVISION.
- . ADDITIONAL CONVENIENCE RECEPTACLES, TELEPHONE AND INTERCOM JACKS AND TEMPERATURE MONITORING SYSTEM ETC.. SHALL BE LOCATED PER OWNER AND AS REQUIRED BY CODE.
- ELECTRICAL DIVISION SHALL FURNISH AND INSTALL INTER-CONNECTING CONDUIT AND WIRE BETWEEN SWITCH, DISPOSER AND COMPONENTS. B. ELECTRICAL DIVISION SHALL FURNISH AND INSTALL ALL INTERCONNECTING CONDUIT AND WIRING BETWEEN MICRO-SWITCH AND SOLENOID FUEL SHUT

. KITCHEN EQUIPMENT CONTRACTOR SHALL FURNISH DISPOSER CONTROLS.

- OFF VALVE FURNISHED WITH FIRE SUPPRESSION SYSTEM SUPPLIED BY THE KITCHEN EQUIPMENT CONTRACTOR. PRE-FABRICATED COLD STORAGE ROOMS ARE FURNISHED BY THE KITCHEN EQUIPMENT CONTRACTOR COMPLETE WITH SPLICE BOXES, LIGHT FIXTURES, LAMPS, LIGHT SWITCHES AND DOOR HEATERS. ELECTRICAL DIVISION
- TO INSTALL SAME AND SHALL FURNISH AND INSTALL INTERCONNECTING CONDUIT, WIRING SEALOFFS, SEALANT AND MAKE FINAL CONNECTIONS. 10. ELECTRICAL DIVISION SHALL FURNISH AND INSTALL ALL INTERCONNECTING CONDUIT AND WIRING BETWEEN KITCHEN EQUIPMENT CONTRACTOR FURN-ISHED LOW TEMP COLD STORAGE ROOM EVAPORATOR TERMINAL BLOCK,
- SWITCH, FAN DOOR SWITCH AND COMPRESSOR CONTROL PANEL. . ELECTRICAL DIVISION SHALL FURNISH AND INSTALL EMPTY CONDUIT WITH JUNCTION BOXES FOR INSTALLATION OF OWNER SUPPLIED I.T. EQUIPMENT INCLUDING POS/ ELECTRONIC CASH CONTROL SYSTEM. ELECTRICAL DIVISION TO VERIFY INSTALLATION IN ACCORDANCE WITH OWNER'S REQUIREMENTS AND MANUFACTURER'S INSTRUCTIONS.
- 2. ELECTRICAL DIVISION SHALL FURNISH AND INSTALL DISCONNECTS FOR ALL ELECTRICAL EQUIPMENT UNDER HOOD ACTIVATED BY FIRE SUPPRESSION SYSTEM.

NOTE

ALL WALL MOUNT ELECTRICAL RECEPTACLE AND J-BOXES ARE TO BE FLUSH MOUNTED IN WALLS WITH NO EXPOSED CONDUIT SHOWING ON SURFACE OF WALLS. ARCHITECT TO PROVIDE MINIMUM WALL FURRING IF REQUIRED.


NOTE "A"


120V, 1 PHASE, SERVICE, 10.0 AMPS, STUB AS NOTED, FOR POS/PRE-CHECK SYSTEM STATIONS. (DEDICATED CIRCUIT, ISOLATED GROUND, PROVIDE (ADD PHONE LINE) EMPTY J-BOX WITH CONDUIT FOR INTERCONNECTING POS SYSTEM, PRE-CHECK AND PRINTERS) (VERIFY ALL REQUIRMENTS WITH POS SYSTEM SUPPLIER.)

NOTE: WALK-IN ELECTRICAL

ALL CONDUIT SHALL BE RUN ON THE EXTERIOR CEILING OF ALL COLD STORAGE ROOMS AND SHALL PENETRATE THE CEILING AT A POINT WHERE THE CONDUIT CAN DROP DIRECTLY TO THE POINT OF CONNECTION. UNDER NO CIRCUMSTANCES, WILL ELECTRICAL CONDUIT BE PERMITTED ON THE INTERIOR.

* SEE SHEETS E0 FOR GENERAL ELECTRICAL NOTES, E1 FOR LIGHTING PLAN, E3 FOR ROOF ELECTRICAL PLAN AND A1.2, A1.3 FOR EQUIPMENT PLAN AND SCHEDULE.

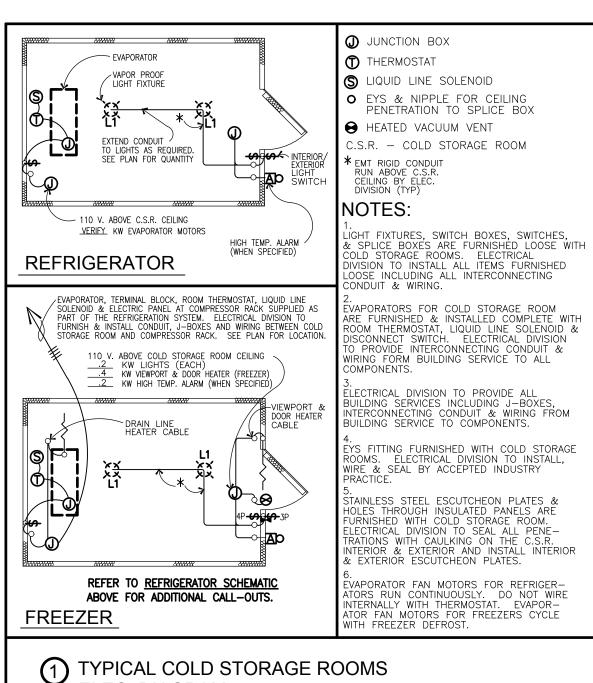

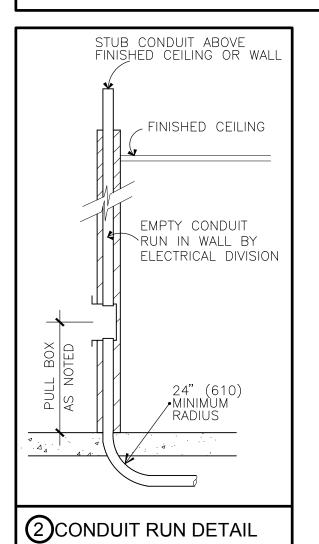

ELEC. DIAGRAM

	LIGHT FIX	TURE	SCHEDULE		* ALL LED LA	AMPS SHALL	BE 500	0°K UNLESS	OTHERWISE NOTED.
	SYMBOL/ MARK	MARK	MANUFACTURER/ MODEL	PRODUCT	MOUNT	LAMP	QTY.	VOLTS/ WATTS MAX.	LOCATION
	А	A	STAR LIGHTING FP2X4LED60W5K	LAY-IN 2'X4'	RECESSED	LED	1	120 – 60	OFFICES, MAINTENANCE/STORAGE, STORE, RESTROOM, HALLWAY-1&2, TACO CORNER, DICKEY'S BBQ
	A N/L	А	STAR LIGHTING FP2X4LED60W5K	LAY-IN 2'X4' W/ NIGHT LIGHT	RECESSED	LED	1	120 - 60	MAINTENANCE, RESTROOM, HALLWAY-1&2, TACO CORNER, DICKEY'S BBQ
	⊕ _B	В	STAR LIGHTING	HIGH BAY SUSPENDED	SUSPENDED	LED	1	120 — 150	SEATING, C-STORE SALES AREA
	O _C	С	STAR LIGHTING	RECESS 4" DIA	RECESSED	LED	1	120 – 18	CASHIER
	O _D	D	STAR LIGHTING	RECESS 4" DIA	RECESSED	LED	1	120 – 18	COUNTER SERVICE, SERVICE LINE
	O _E	Е	STAR LIGHTING	RECESS 6" DIA	RECESSED	LED	1	120 – 18	RESTROOMS
	O _F	F	STAR LIGHTING	RECESS 6" DIA FOR DAMP LOCATION	RECESSED	LED	1	120 – 18	ENTRANCE CANOPY
	\blacksquare_{G}	G	STAR LIGHTING STRWP100W WHITE FINISH	WALL PACK	SURFACE	LED	1	120 — 150	EXTERIOR BUILDING MOUNT
	ОН	Н	STAR LIGHTING V9636-20 SILVER GREY FINISH	WALL SCONCE EXTERIOR WITH BATTERY BACKUP FOR WET LOCATIONS	WALL	LED	2	120 — 34	EXIT/ ENTRY DOORS WITH BATTERY PACK FOR 90 MINUTES
	→ —J	J	STAR LIGHTING	LED STRIP-GRAZE	WALL/ CEILING	LED 4000K		120 –	ACCENTS AT ENTRANCE CANOPY AND EXTERIOR BUILDING PARAPET MOUNT
	⊢ K	К	STAR LIGHTING	STRIP LIGHT W/ VANDAL RESISTANT GUARD FOR WET LOCATIONS	SURFACE	LED	2	120 – 13	ATTIC SPACE
]	△ EXIT X	Х	STAR LIGHTING CXTEU WHITE FINISH	EMERGENCY WITH EXIT SIGN. NI CAD BATTERY BACKUP RED LETTERS	WALL/ CEILING	LED	2	120 - 10	SEATING, SALES AREA, TACO CORNER, DICKEY'S, HALLWAY—2
	4 _≯X1	X1	STAR LIGHTING	EMERGENCY W/O EXIT SIGN. NI CAD BATTERY BACKUP	WALL/ CEILING	LED	2	120 — 10	RESTROOM, TACO CORNER, DICKEY'S BBQ
	★)X2	X2	STAR LIGHTING	EXIT SIGN W/BATTERY BACKUP	WALL/ CEILING	LED		120 – 2	C-STORE SALES AREA
				EXHAUST FAN					SEE HVAC PLANS FOR SPECS.

LIGHT FIXTURE SCHEDULE NOTES:

- FIXTURES W/BATTERY BACKUP SHALL BE RATED FOR 90 MINUTES.
- 2. ALL HARD WIRED FIXTURES TO BE CONTRACTOR FURNISHED/CONTRACTOR INSTALLED U.N.O.

ELECTRICAL NOTES:

- 1. FURNISH ALL LABOR, MATERIAL, EQUIPMENT, TOOLS, INSURANCE, SERVICES AND PERMITS NECESSARY TO CONSTRUCT AND INSTALL A COMPLETE OPERATING ELECTRICAL SYSTEM.
- 2. ALL WORK SHALL CONFORM TO THE NATIONAL ELECTRICAL CODE (NEC) AND ALL APPLICABLE CODES AS REQUIRED BY LOCAL AUTHORITIES.
- 3. ELECTRICAL SUB CONTRACTOR SHALL OBTAIN ALL PERMITS AND SHALL PAY FOR ALL ASSOCIATED EXPENSES, PRINTING AND INSPECTIONS.
- 4. SUB CONTRACTOR SHALL VERIFY EXISTING CONDITIONS AND SHALL COORDINATE AND SCHEDULE HIS WORK WITH THE OWNER AND OTHER TRADES.
- 5. ALL MATERIAL SHALL BE NEW AND UL LISTED. MATERIAL SHALL BEAR THE APPROVAL LABEL OF UL, WHEN SUCH IS AVAILABLE.
- 6. UNLESS OTHERWISE SHOWN, ALL BRANCH CIRCUIT WIRES SHALL BE THHN/THWN COPPER. FEEDERS TO PANEL BOARDS AND INCOMING SERVICE SHALL BE THW OR THWN COPPER. MINIMUM SIZE #12 AWG.
- 7. ALL ELECTRICAL CONDUITS, RACEWAYS AND CABLES SHALL HAVE A GROUND CONDUCTOR. MINIMUM SIZE SHALL BE NO. 12 AWG. GROUND CONDUCTOR SHALL BE TERMINATED AT GROUND
- 8. EXACT LOCATION AND MOUNTING HEIGHT OF LIGHTING FIXTURES, WIRING DEVICES OUTLET SWITCHES AND CONTACTORS BOXES FOR ELECTRICAL EQUIPMENT SHALL BE COORDINATED WITH THE OWNER AND THE EQUIPMENT VENDOR.
- 9. TOGGLE SWITCHES SHALL BE MOUNTED AT 42 INCHES ABOVE FINISHED FLOOR. WALL MOUNTED RECEPTACLES SHALL BE MOUNTED AT 15 INCHES A.F.F. AND 6 INCHES ABOVE COUNTERS.
- 10. WIRING DEVICES THAT OCCUR TOGETHER SHALL BE GANGED UNDER A COMMON WALL PLATE.
- 11. COLOR OF WALL PLATES SHALL BE AS DIRECTED BY THE OWNER
- 12. OUTDOOR RECEPTACLES SHALL HAVE "IN-USE WEATHERPROOF" COVER BY CARLON ELECTRICAL
- 13. ALL BALLASTS SHALL BE OF A HIGH POWER FACTOR. FLUORESCENT LAMP BALLASTS SHALL BE ELECTRONIC, 20% THD, CBM CERTIFIED WITH "A" SOUND RATING. BALLASTS SHALL BE HOWARD INDUSTRIES OR EQUAL
- 14. EACH PANEL AND SAFETY SWITCH SHALL BE IDENTIFIED BY AN ENGRAVED LAMINATED NAMEPLATE.
- 15. ALL NEW PANEL BOARDS SHALL HAVE A GROUND BUS.
- 16. CONTRACTOR SHALL COORDINATE CONDUIT'S ROUTING AND METHOD OF SUPPORT WITH THE OWNER AND OTHER TRADES.
- 17. CONTRACTOR SHALL VERIFY ACTUAL NAMEPLATE LOADS OF EQUIPMENT AND SHALL INSTALL THE PROPER NEC SIZE FUSE OR CIRCUIT BREAKER. HE SHALL NOTIFY THE ENGINEER IF CHANGES IN WIRE AND RATING SIZES ARE REQUIRED.
- 18. FEEDERS INSTALLATION SHALL BE EMT INDOOR AND HDG RIGID STEEL CONDUIT FOR EXPOSED WORK OUTDOOR. MULTIPLE CONDUIT RUNS SHALL BE ON TRAPEZE HANGERS UTILIZING 3/8" RODS AND EPOXY PAINTED 12 GA. STRUTS. INSTALLATION IN THE OFFICE MAY BE IN TYPE AC CABLE WITH GROUND.
- 19. HOME RUNS OF 20 AMP BRANCH CIRCUITS, THAT EXCEED 100 FEET IN LENGTH SHALL BE NO.10 AWG. ALL HID LIGHTING WIRES SHALL BE #10 AWG. WIRES TO LIGHTING POLE SHALL BE #8 AWG.
- 20. COMPLETE TYPED PANEL'S DIRECTORIES SHALL BE PROVIDED UPON COMPLETION OF WORK.
- 21. UPON COMPLETION OF WORK, THE CONTRACTOR SHALL FURNISH THE OWNER A RED MARKED SET OF DRAWINGS INDICATING ALTERATION THAT WERE MADE, UNDERGROUND CONDUIT ROUTING, SCHEMATICS AND EQUIPMENT WIRING DIAGRAMS.
- 22. OUTDOOR LIGHTING SHALL BE CONTROLLED BY A PHOTOCELL.
- 23. WIRING DEVICES SHALL BE SPECIFICATION GRADE.

LIGHTING COMPLIANCE NOTES

- BI-LEVEL SWITCHING IS REQUIRED FOR SPACES LESS THAN 250 SQ.FT. HALF THE LUMINAIRES SHALL BE CONTROLLED BY
- SPACES GREATER THAN 250 SQ.FT, LUMINAIRES SHALL BE CONTROLLED BY OCCUPANT SENSOR DEVICE.
- OCCUPANT SENSOR SHALL BE A PRODUCT OF THE FOLLOWING
- WATT-STOPPER, LEVITON, HUBBELL, P&S OR EQUAL.
- OCCUPANT SENSOR SHALL BE WALL OR CEILING MOUNTED AND COORDINATED WITH ROOM LAYOUT AND SENSOR MANUFACTURER.
- OCCUPANCY SENSORS-ONLY ONE SWITCH, PER EACH ROOM, SHALL BE REQUIRED.

LIGHTING LEGEND

SINGLE POLE SWITCH AT 42" A.F.F. U.N.O. THREE WAY SWITCH AT 42" A.F.F. U.N.O. WALL MOUNTED OCCUPANCY SENSOR

ALPHABET DENOTES FIXTURE CONTROLLED.

- SINGLE POLE SWITCH AT 42" A.F.F. U.N.O.,
- AUTOMATIC LIGHTING SHUTOFF MAY BE PROVIDED IN LIEU OF

POWER NOTES

- ELECTRICAL OUTLETS ON OPPOSITE SIDES OF RATED WALLS AND PARTITIONS SHALL BE SEPARATED BY A HORIZONTAL DISTANCE OF ATLEAST 24".
- RECEPTACLES AND DEVICES PROVIDED AND INSTALLED IN MILLWORK BY MANUFACTURER. GC TO CIRCUIT AS SHOWN. COORDINATE EXACT LOCATIONS WITH SUPPLIED MILLWORK.
- THERMOSTATS FOR HVAC UNITS TO BE PROVIDED BY HVAC CONTRACTOR, REFER HVAC DRAWINGS FOR LOCATIONS.
- 4. VERIFY LOCATION OF ELECTRICAL CONNECTION TO HVAC UNITS AND MOUNT EACH DISCONNECT SWITCH TO UNIT. 5. ALL DISCONNECT SWITCHES SHALL BE NEMA 3R.
- 6. CONNECT DISCONNECT SWITCHES TO EACH RTU UNIT TERMINAL BOX WITH LIQUID-TIGHT FLEXIBLE CONDUIT HVAC DISCONNECTS ARE TO BE SUPPLIED BY CONTRACTOR.

- ALSO SEE SITE LIGHTING PLAN FOR ADDITIONAL SITE ELECTRICAL REQUIREMENTS. SEE SHEET E2 FOR POWER LEGEND.

EXHAUST FAN SEE HVAC PLANS FOR SPECS

W/ SWITCH AT 42" A.F.F. U.N.O. FOUR WAY SWITCH AT 42" A.F.F. U.N.O.

SCALE: NOT TO SCALE

DRAWN:

CHECKED:

DATE: JAN 2018

NEW LAWRENCE GROCERY


902 E. BAYSHORE, LEON, TEXAS 77539











18-02-003

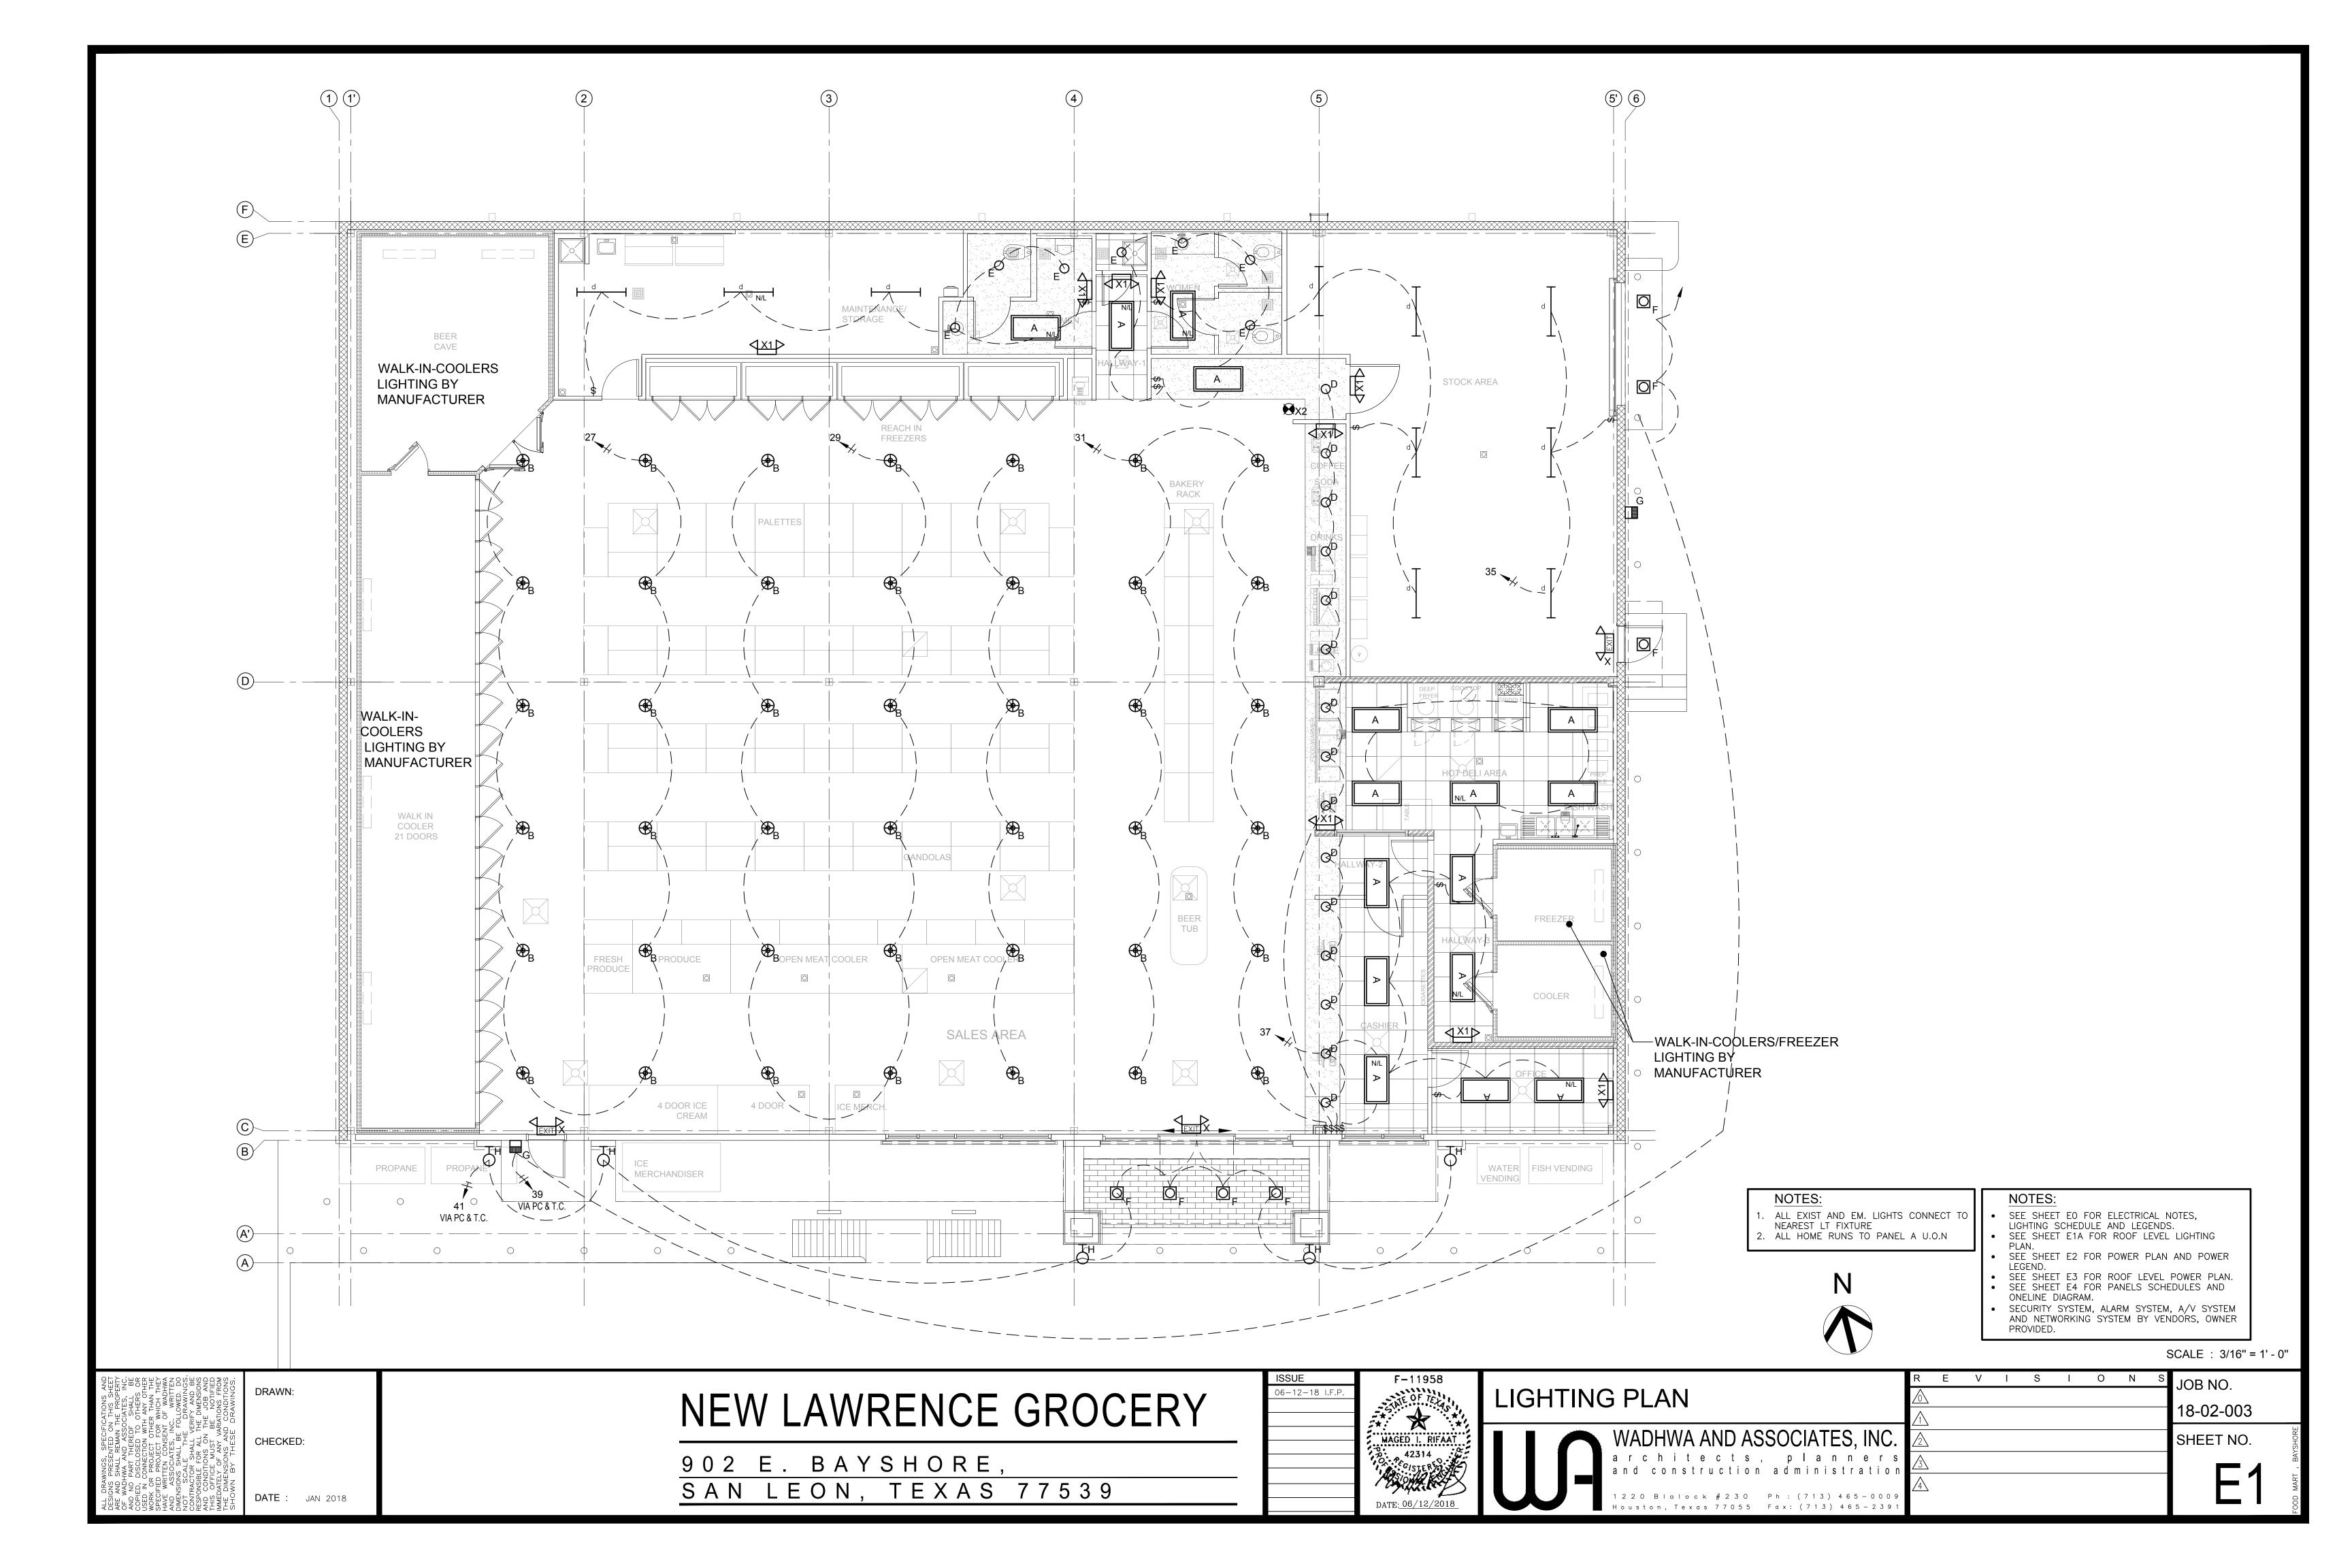

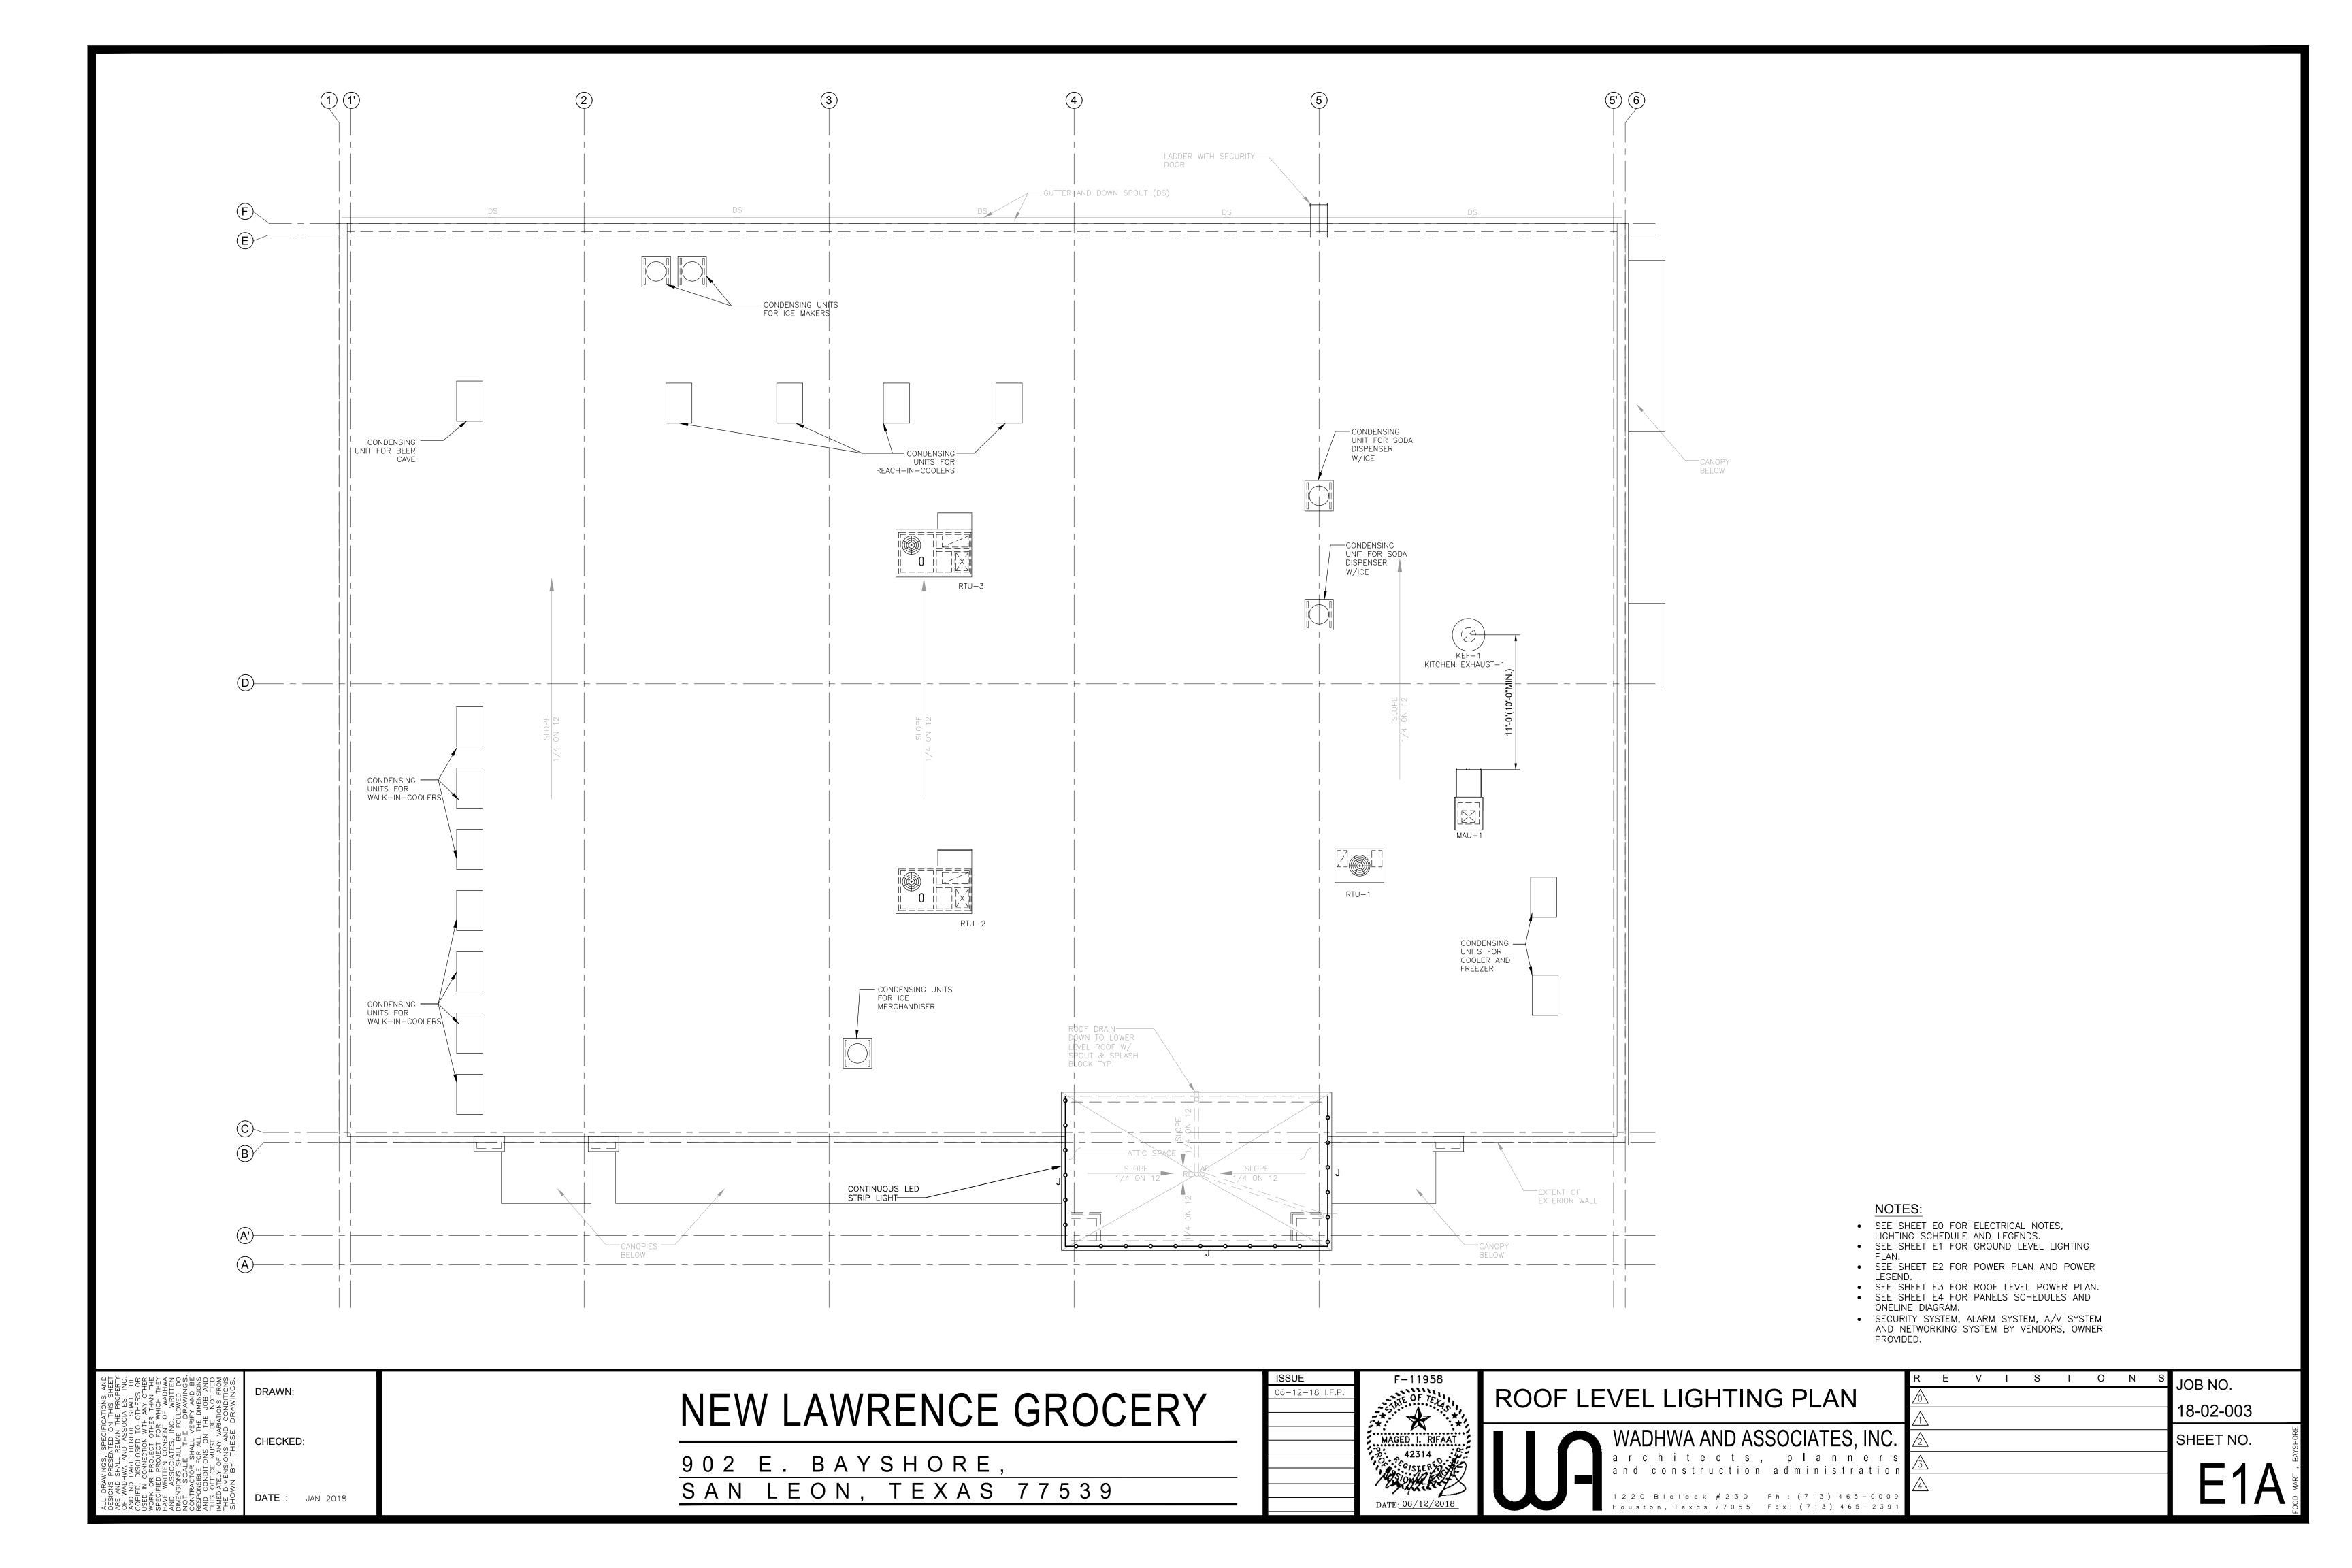


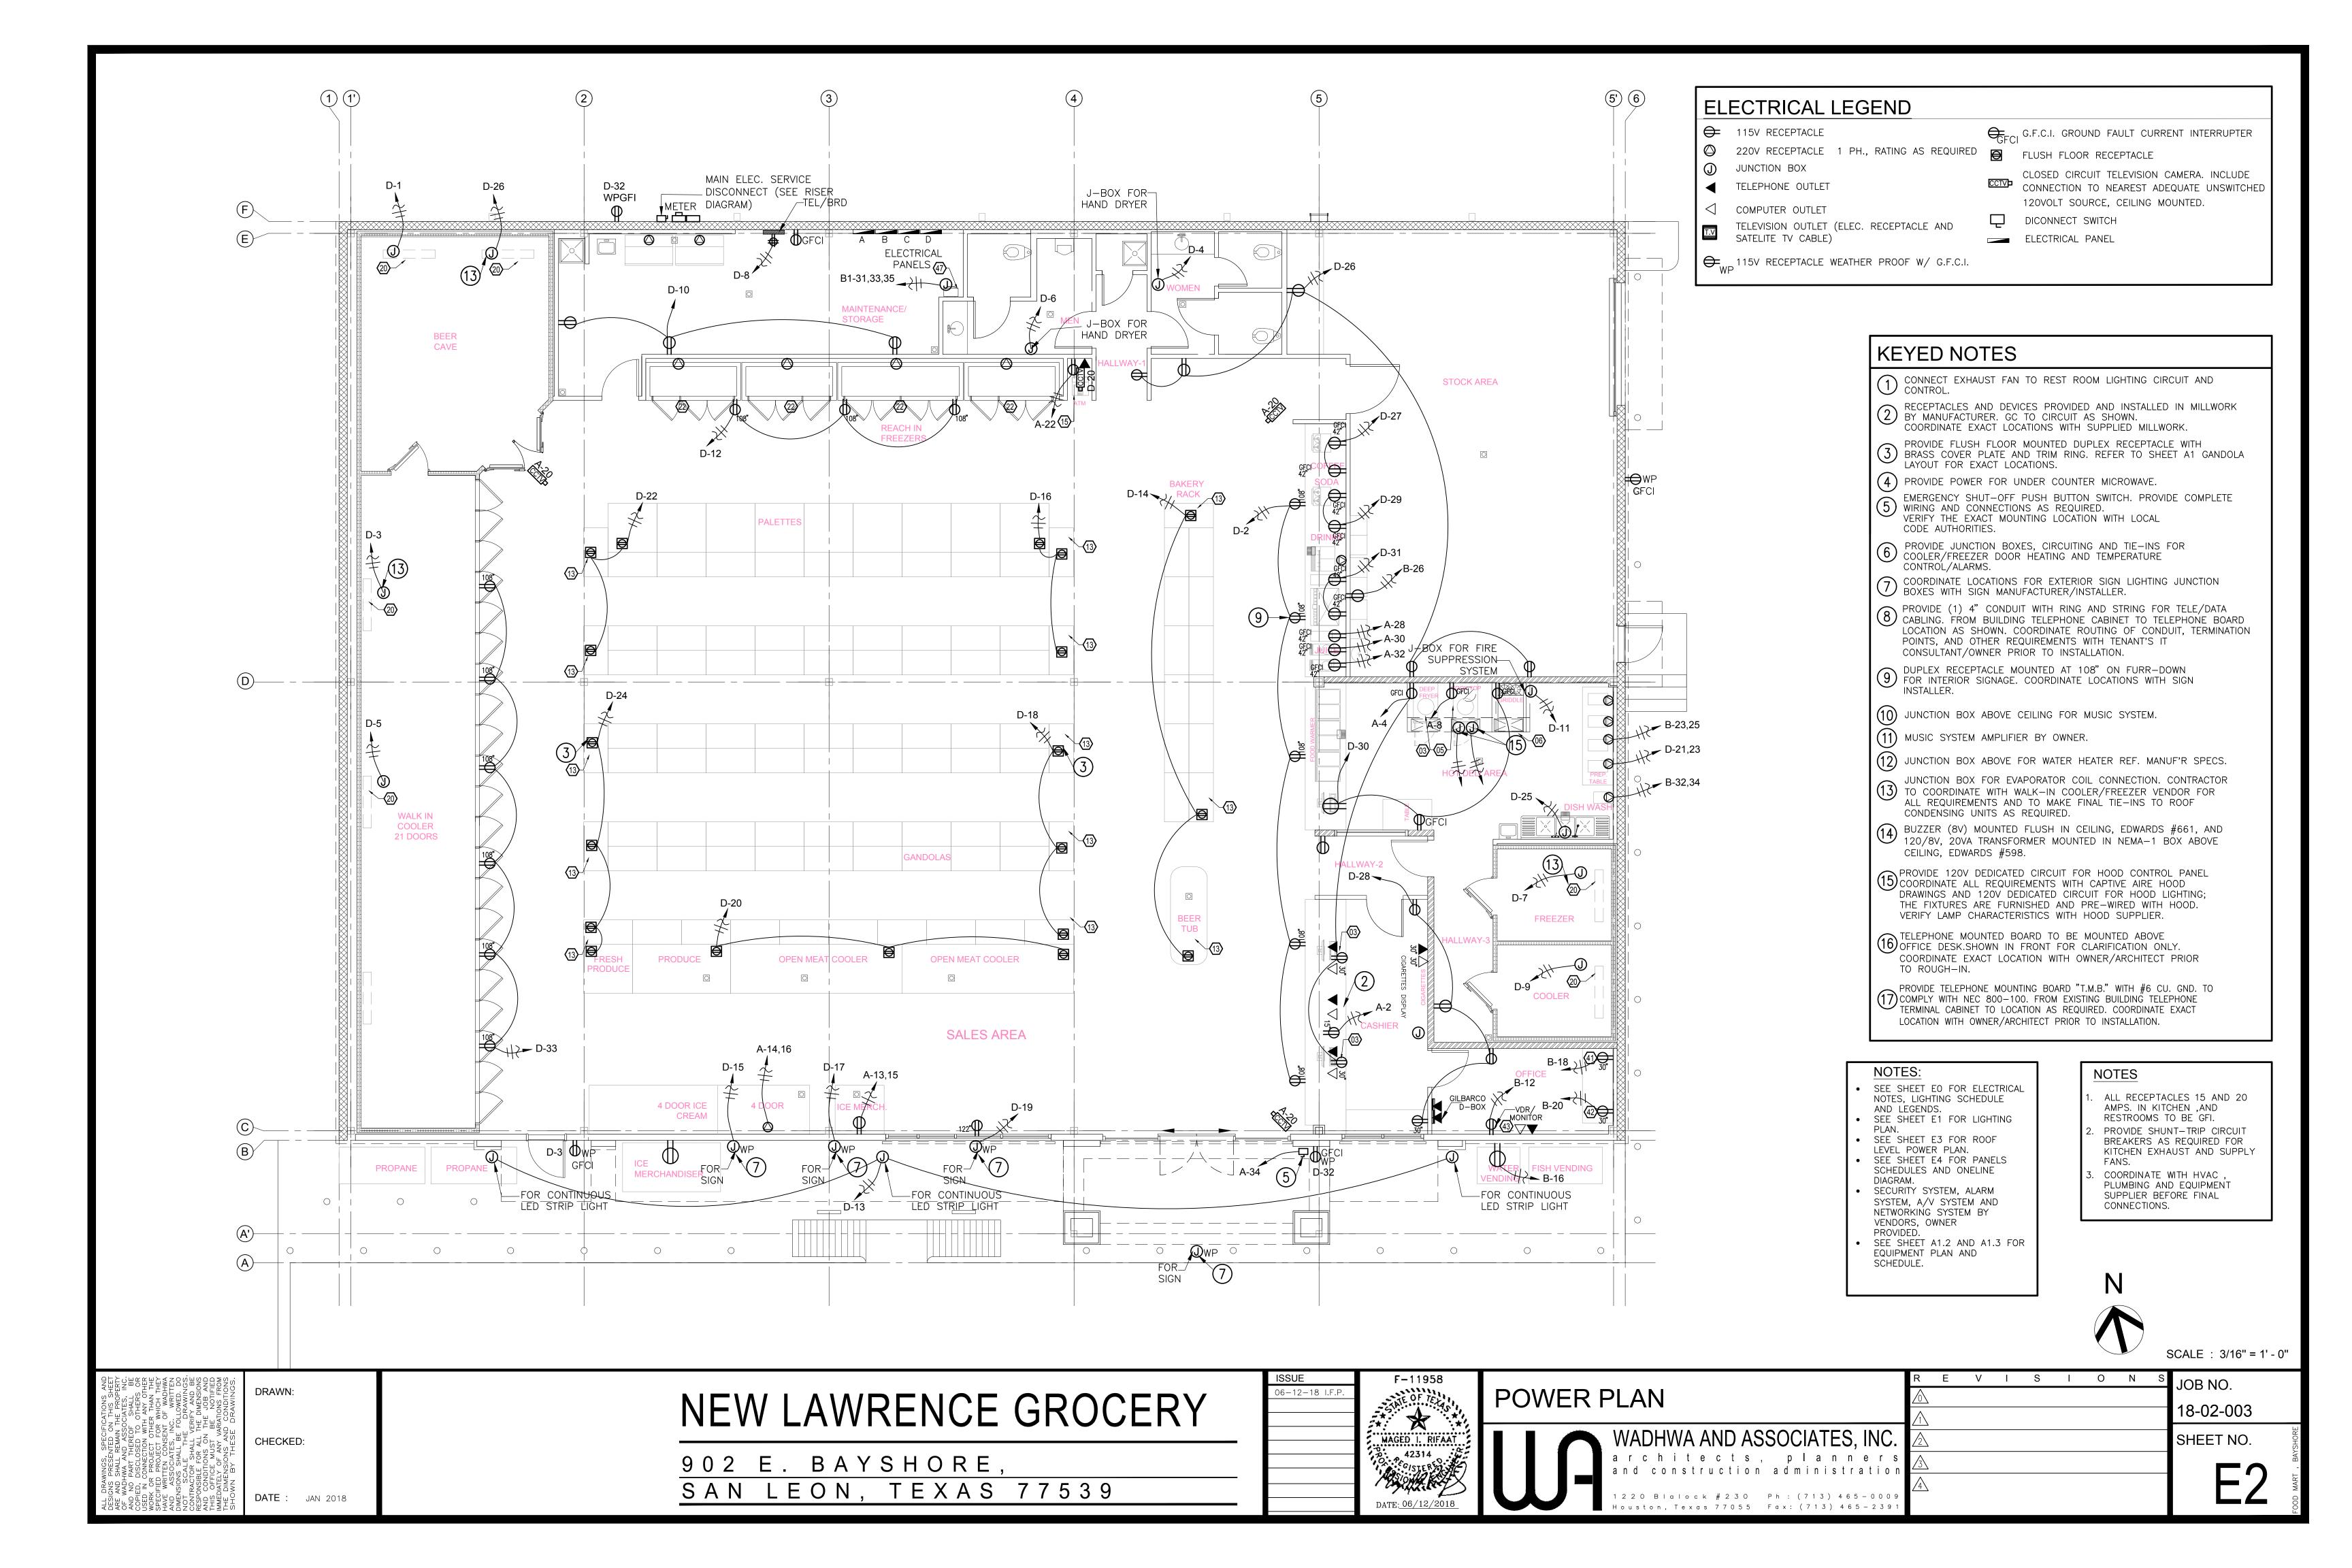


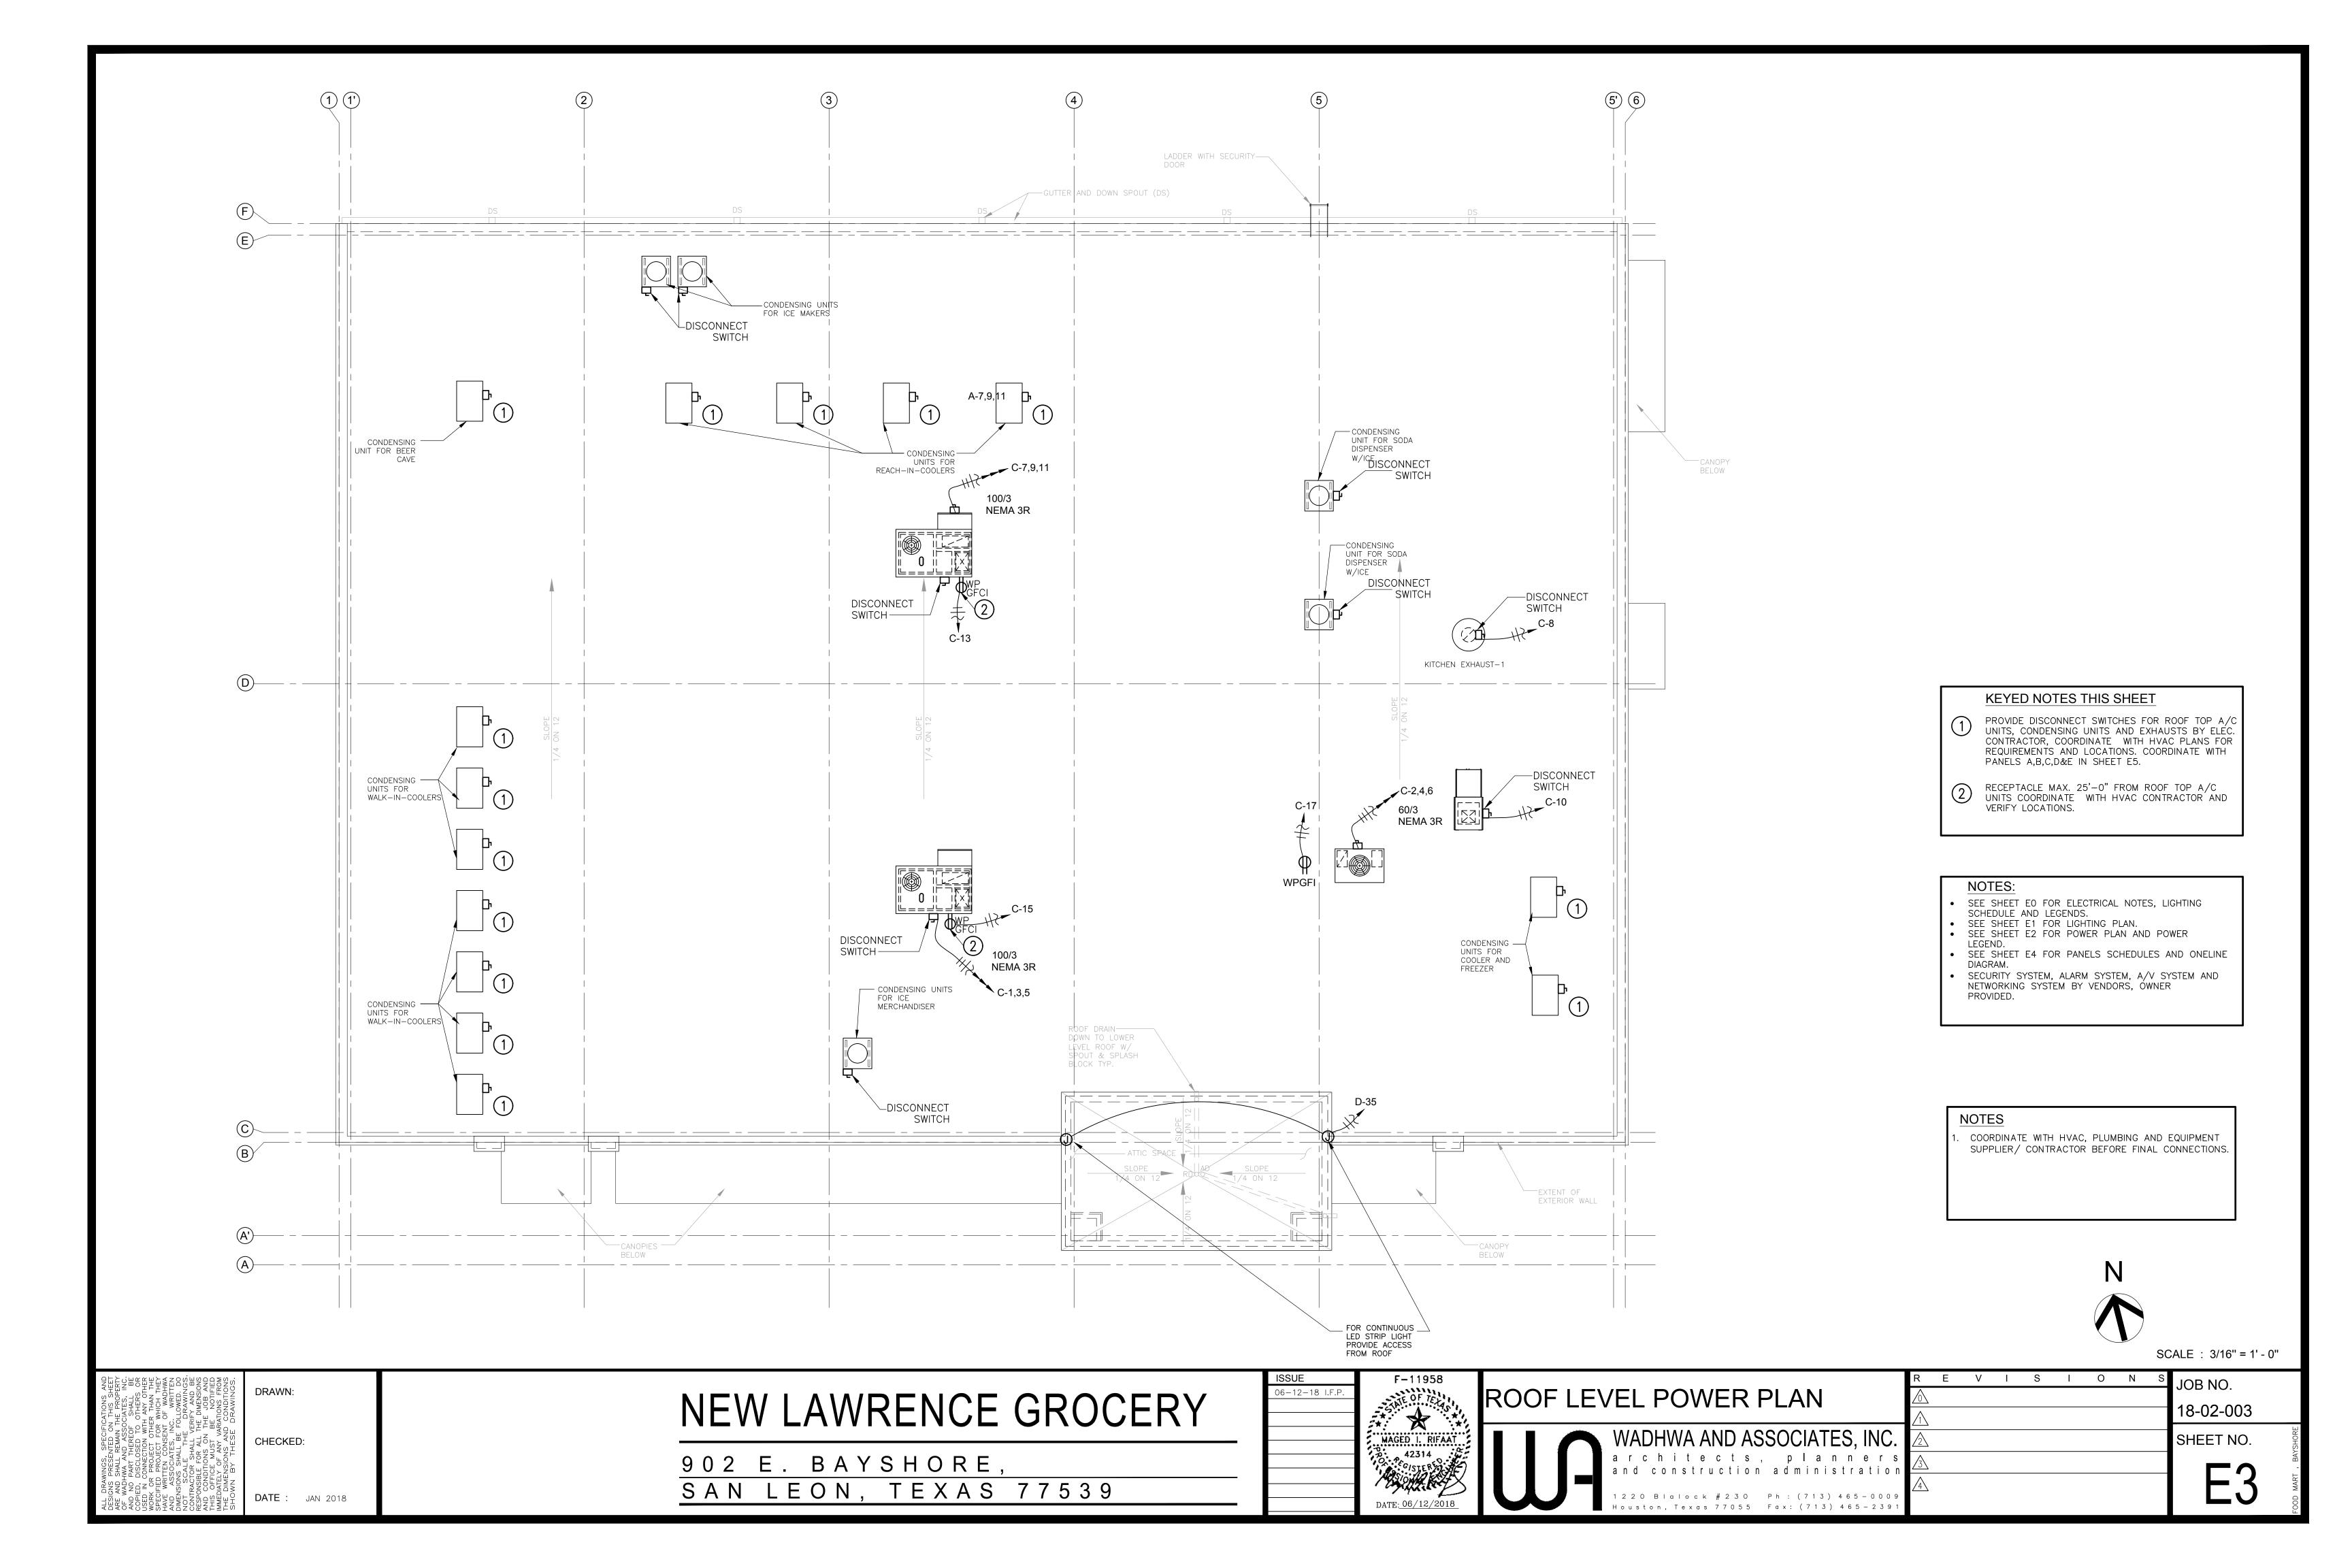

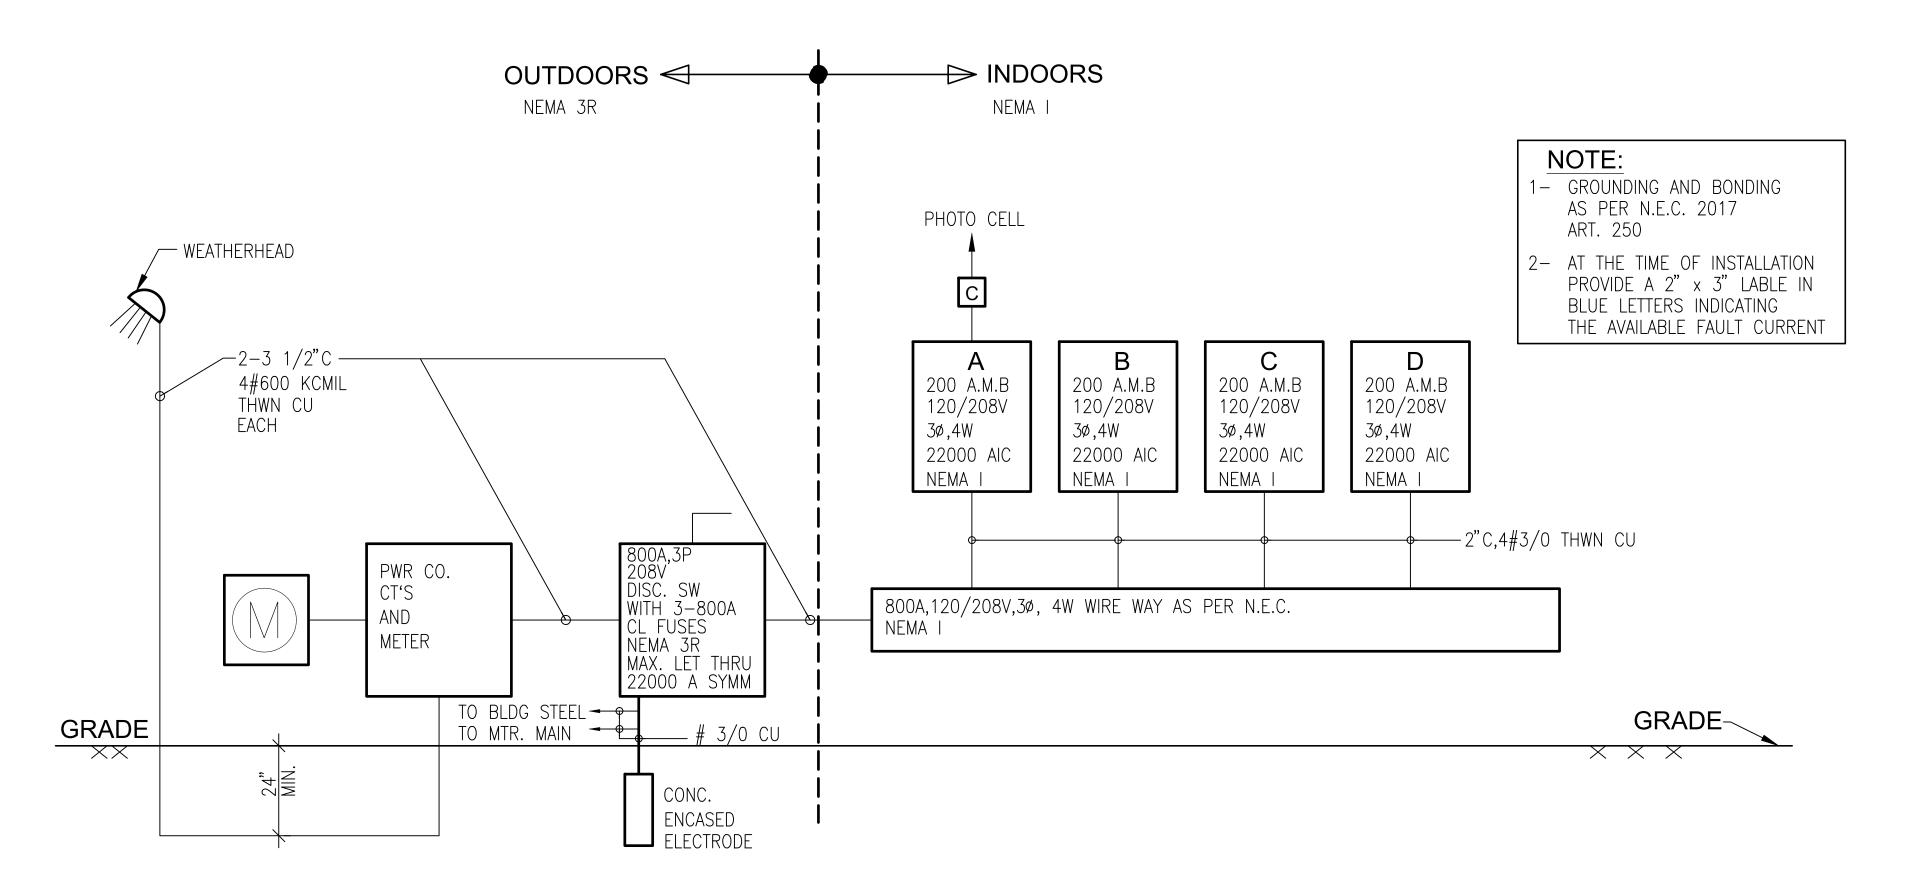

RISER DIAGRAM N.T.S.

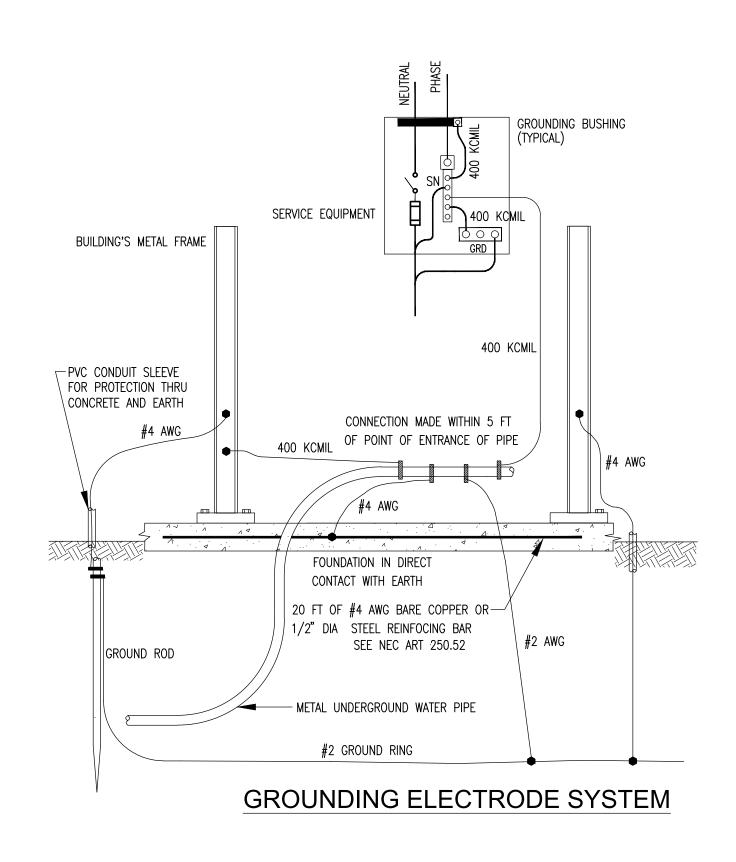

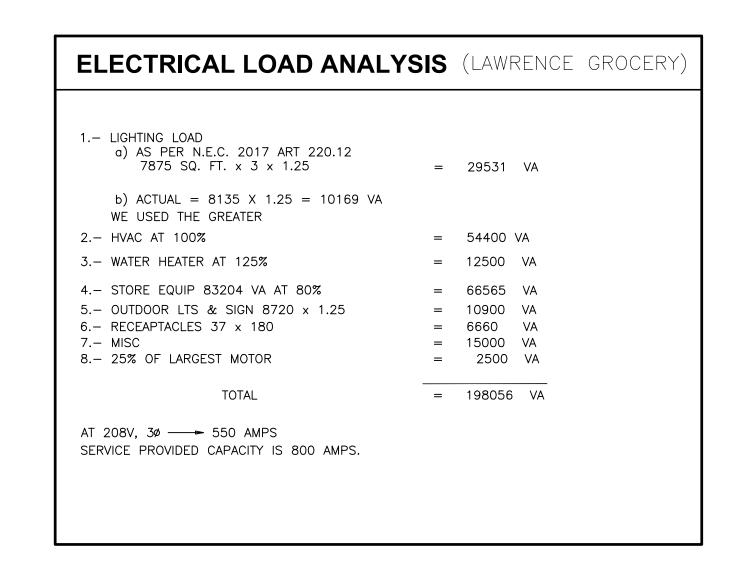


SCALE: NO SCALE


JOB NO.

DRAWN: CHECKED: DATE: JAN 2018

NEW LAWRENCE GROCERY

902 E. BAYSHORE, LEON, TEXAS 77539

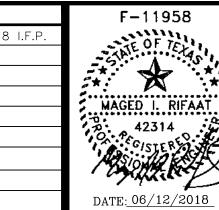

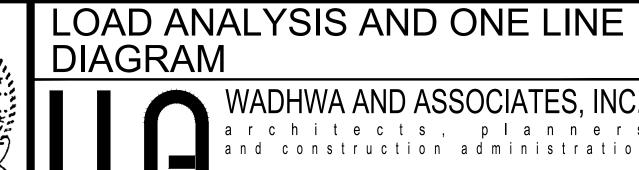

01-24-18 ISSUED FOR CUSTOMER FINAL REVIEW 18-02-003 SHEET NO.

BUS AMPS <u>200</u> MAIN BRKER AMPS: <u>200</u> WIRE SIZE FOLTS <u>120/208</u> AIC <u>22,000</u> PHASE <u>3</u> WIRE <u>4</u>	4# 3/0 CU		_	PANE	EL A		1. 2.	NEMA: I NOTES 1. ALL BRKS TO BE IP/20A U.N.O 2. BALANCE ALL LOAD 3. LABLE ALL CIRCUITS			
ert. Description	WATT LOAD	WIRE	BRKR			BRKR	WIRE	WATT LOAD	CRT. DESCRIPTION		
				1	2	20/1	# 12	1200	ITEM # 2		
PARKING LTS VIA PC. & TC.	2420	# 10	20/2	3	4			480	# 3		
CANOPY LTS	1300	# 10	20/1	5	6			500	# 4		
				7	8			1000	# 5		
SIGN	5000	# 8	30/	9	10			1800	# 8		
			/3	11	12	lacksquare	lacksquare	1800	₩ 8		
				13	14						
ГЕМ # 7	2400	# 12	20/2	15	16	20/2	# 12	2400	ITEM # 10		
			ļ	17	18	20/1	# 12	1800	# 11		
ГЕМ #16	7650	# 6	50/2	19	20			500	# 14		
				21	22			1000	# 15		
ΓΕΜ #17	10000	# 8	40/	23	24			550	# 18		
			/3	25	26			500	# 20		
LTS VIA P.L.C.P.	2100	# 10	30/1	27	28			1800	# 28		
" "	2100	# 10	30/1	29	30			840	# 29		
" "	2100	# 10	30/1	31	32		$oxedsymbol{oxed}$	1800	# 30		
" "	2100	# 10	30/1	33	34	lacksquare	lacksquare	500	EM. SHUT OF		
<u> </u>	996	# 12	20/1	35	36						
abla	990	# 12	20/1	37	38						
LTS VIA P.C. & T.C.	300	# 12	20/1	39	40						
" " " TG SIGN = 17554 x 1.25 = 21543 VA	248	# 12	20/1	41	42				lacksquare		

									EMA: I
BUS AMPS <u>200</u>									OTES
MAIN BRKER AMPS:	<u>4# 3/0 CU</u>			PANE	<u>L B</u>			2	. ALLBRKS TO BE IP/20A U.N.O . BALANCE ALL LOADS . LABLE ALL CIRCUITS
CRT. DESCRIPTION	WATT LOAD	WIRE	BRKR			BRKR	WIRE	WATT LOAD	CRT. DESCRIPTION
				1	2	20/1	# 12	660	ITEM # 30
ITEM # 21	18000	# 6	60/	3	4			1560	# 31
			/3	5	6			1800	# 32
				7	8			1700	# 33
ITEM # 22	3000	# 12	20/2	9	10			1800	# 34
				11	12			1800	₩ 35
# 22				13	14			1800	# 39
				15	16			1500	# 40
# 22				17	18			500	# 41
" 00	 			19	20			1200	# 42
# 22	V	lacksquare	<u> </u>	21	22			500	# 43
	5000	" 10	70 /4	23	24			1500	# 44
# 27	5000	# 10	30/1	25	26			1000	# 50
" 45	7500	" 10	70 /0	27	28	 		1800	# 51
# 45	3500	# 10	30/2	29	30	<u> </u>	V	1500	# 53
√7 # 47	40000	" 0	40 /	31	32	00.70	// 10	0.400	# F A
₩ 47	10000	# 8	40/ /3	33	34	20/2	# 12	2400	# 54
CDACE			/3	35	36				SPACE I
SPACE I				37	38				
17				39	40				
V	<u> </u>			41	42			<u> </u>	
CONN. LOAD = 66620 AT 80% = 54896 VA				—— NI-					
AT 208V,3¢ 152 AMPS				PANEL CAPACITY	IS 200 AMPS				

BUS AMPS 200 MAIN BRKER AMPS: WIRE SIZE VOLTS 120/208 AIC 22,000 PHASE 3 WIRE 4 _	1		ı	<u>Pane</u>	EL C			N 1 2 2	IEMA: I IOTES . ALLBRKS TO BE IP/20A U.N.O :. BALANCE ALL LOADS :. LABLE ALL CIRCUITS
CRT. DESCRIPTION	WATT LOAD	WIRE	BRKR			BRKR	WIRE	WATT LOAD	CRT. DESCRIPTION
RTU-2	2000	# 4	70/ /3	1 3 5	2 4 6	45/	# 8	1200	RTU-1
RTU-3	2000	# 4	70/	7 9 11	8 10 12	20/1	# 12	1225 1225 1225	KEF KMUAI KMUA2
WPGFI ON ROOF	180 180	# 12 # 12	20/1	13	14	V	V	500 500	EF-1 EF-2
2) 2)	180	# 12	20/1	17	18	· ·	*		SPACE
SPACE				19	20				
				21	22				
				23	24				
				25	26				
				27	28				
				29	30				
			-	31	32				
				33	34				
				35	36 38				
				37					+
\[\frac{1}{V}\]			 	39 41	40				
					-			l	¥
CONN. LOAD = 57215 VA AT 208V,30 → 159 AMPS				PANEL CAPACITY					

BUS AMPS <u>200</u> MAIN BRKER AMPS: WIRE SIZE VOLTS <u>120/208</u> AIC <u>22,000</u> PHASE <u>3</u> WIRE <u>4</u>	1		1	<u>PAN</u>	EL D			No. 1. 2. 2. 2.	EMA: I DTES ALLBRKS TO BE IP/20A U.N.O BALANCE ALL LOADS LABLE ALL CIRCUITS
CRT. DESCRIPTION	WATT LOAD	WIRE	BRKR			BRKR	WIRE	WATT LOAD	CRT. DESCRIPTION
ITEM # 20	500			1	2	20/1	# 12	1800	5 SIGN
" "	500	# 12	20/1	3	4			1800	HAND DRYER
"	500			5	6			1800	yy 19
" "	500			7	8			360	QUAD FOR TEC.
" "	500			9	10			540	3 REC.
FIRE SUPP	1500			11	12			540	3 REC.
LED LTS	500			13	14			540	3 FL. REC.
SIGN	1200			15	16				
"	1200			17	18				
"	1200		lacksquare	19	20				
				21	22			Λ	lack lac
ITEM # 9	2400		20/2	23	24			720	4 🌹 🔻
DISH WASH	1440		20/1	25	26			900	5 REC.
2 GFI	360			27	28			900	5 "
2 GFI	360			29	30			720	4 "
2 GFI	360			31	32		abla	720	4 WPGFI
6 REC.	1080	1 4	1 4	33	34		<u>'</u>		SPACE
LED	1000	\downarrow	\downarrow	35	36				
SPACE			1 • • • • • • • • • • • • • • • • • • •	37	38				
				39	40				
4				41	42				T
CONN. LOAD = 26520 VA	•	•	-	——————————————————————————————————————		•		•	· · · · · · · · · · · · · · · · · · ·
AT 208V,3ø — → 74 AMPS				PANEL CAPACIT					


SCALE: NO SCALE


18-02-003

SHEET NO.


NEW LAWRENCE GROCERY

902 E. BAYSHORE, SAN LEON, TEXAS 77539

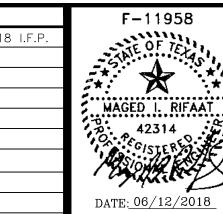

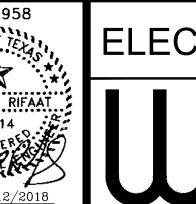



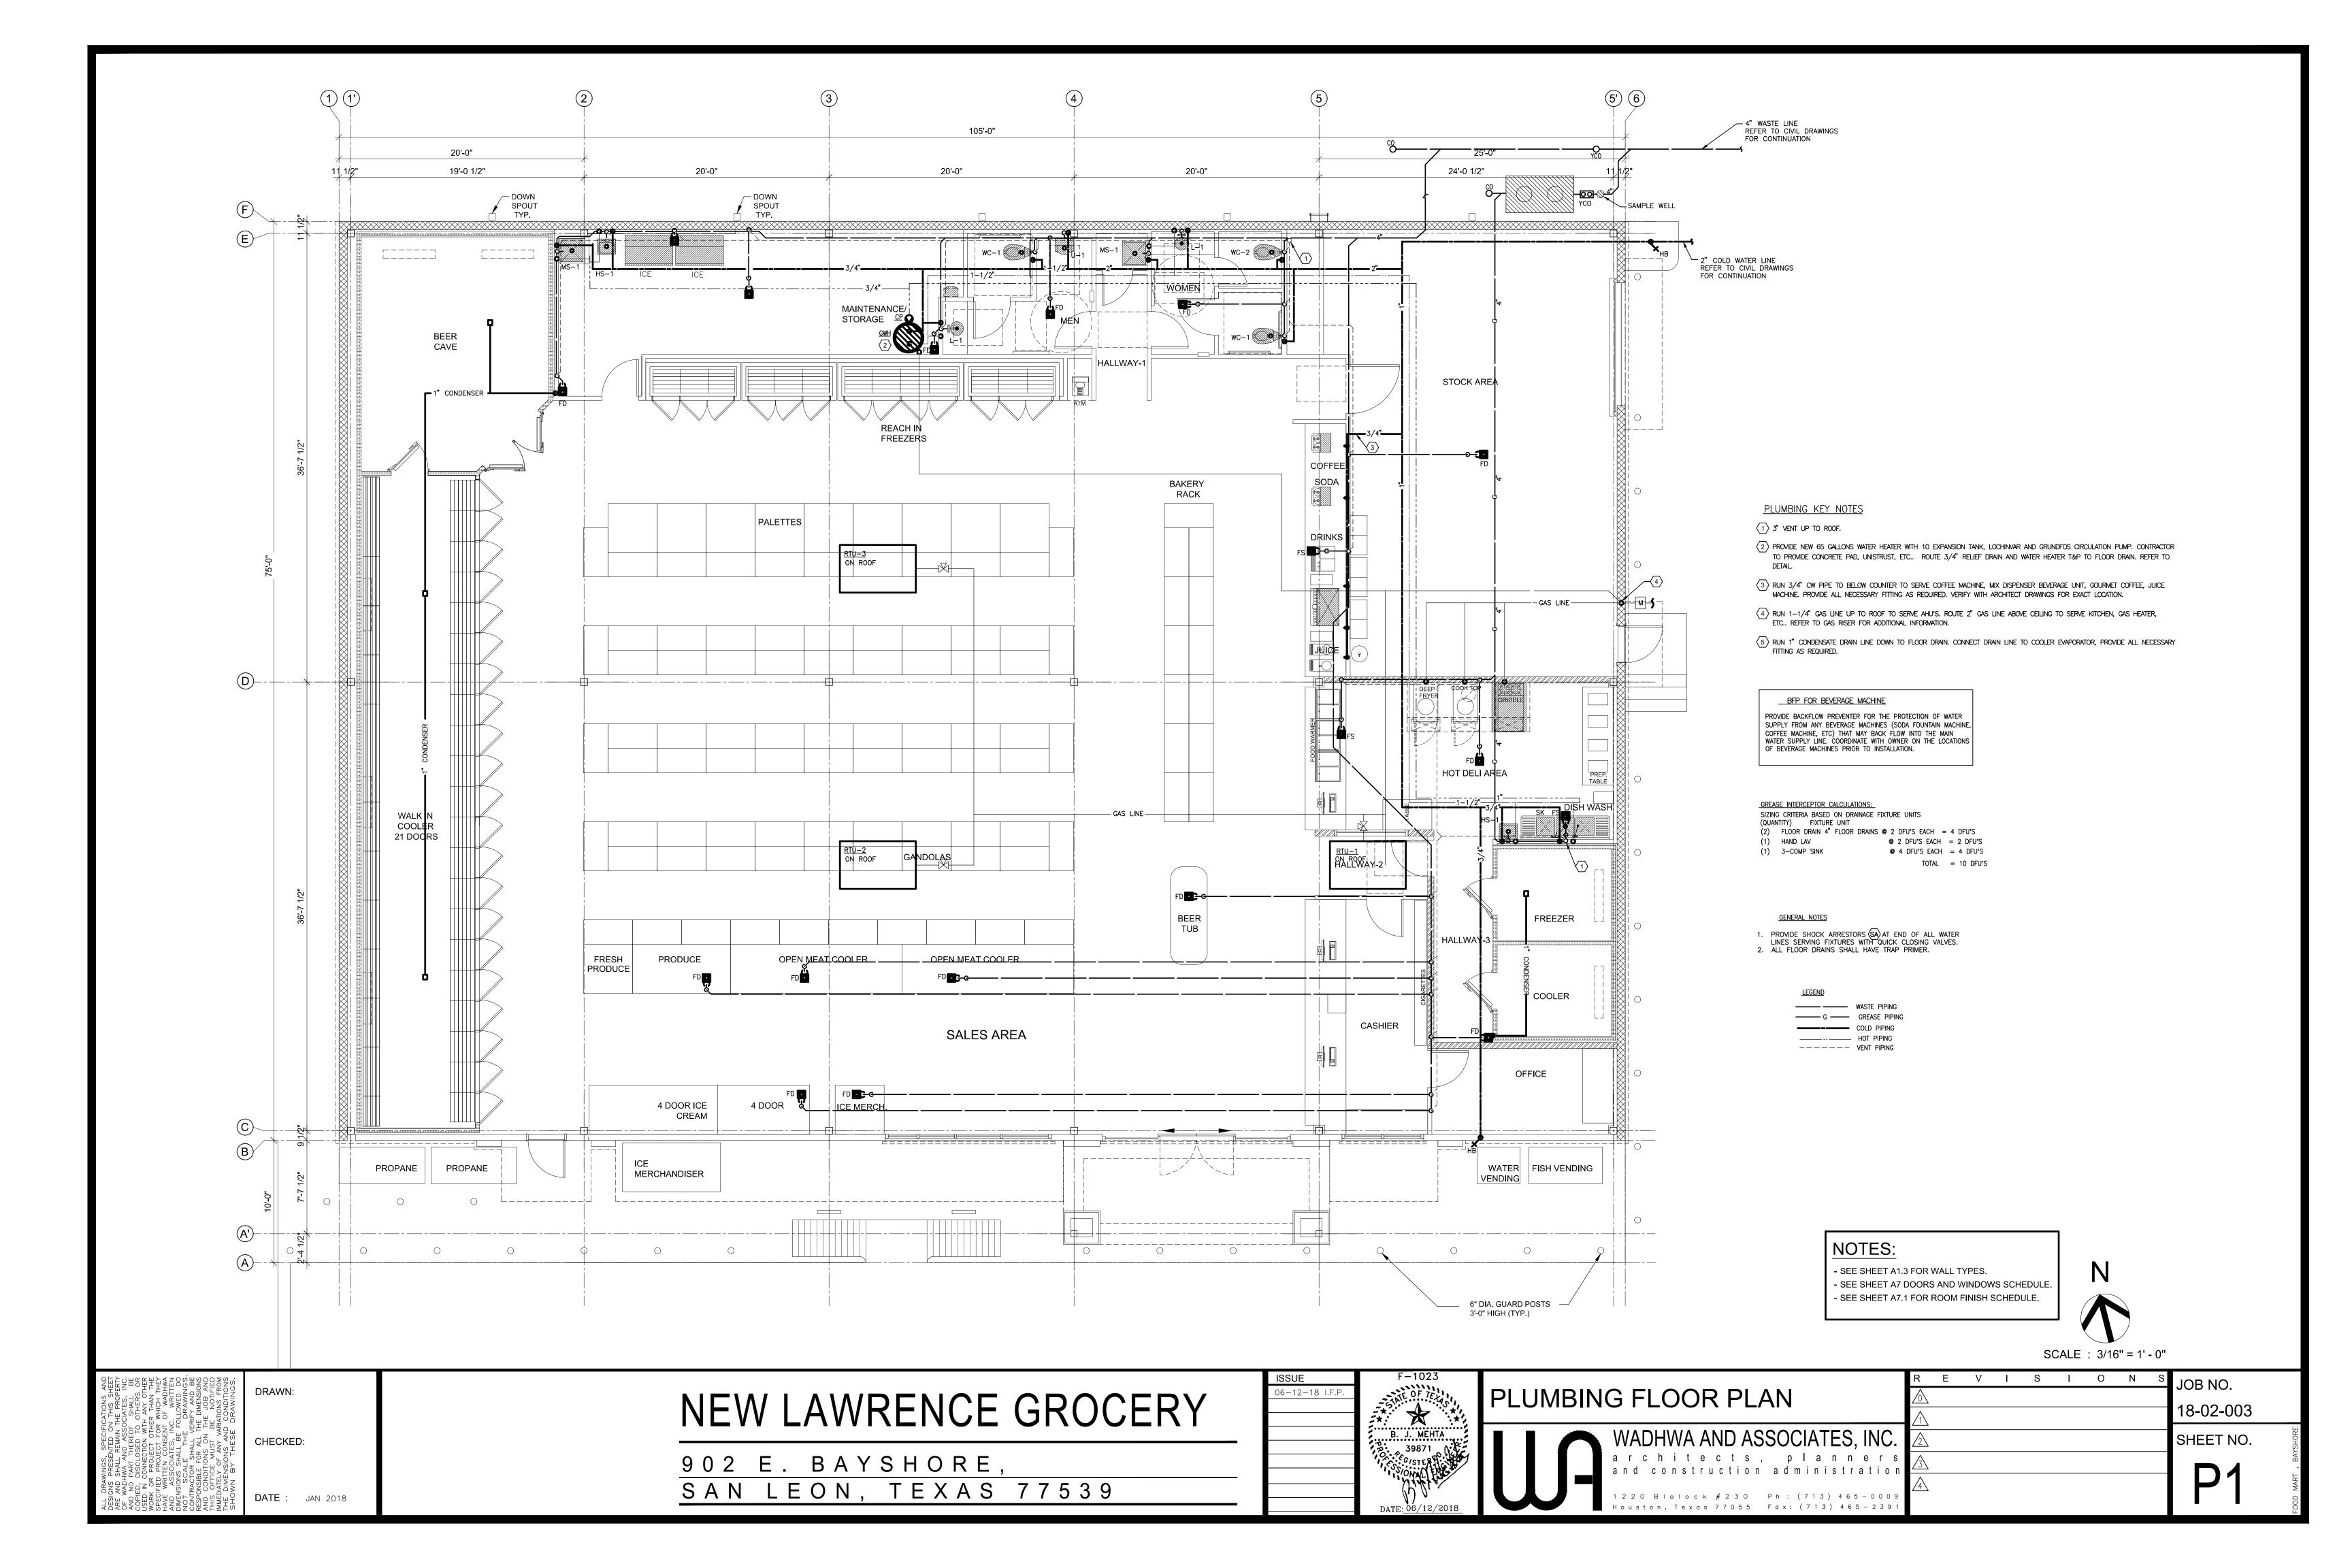

GENERAL NOTES

NO ADDITIONAL COST TO THE OWNER.

- VISIT SITE AND BECOME FAMILIAR WITH THE EXISTING CONDITIONS. INFORM THE ENGINEER OF ANY CONTINGENCIES WHICH INFLUENCE THE EXECUTION OF THE WORK. NO EXTRAS WILL BE ALLOWED DUE TO FAILURE TO MAKE THE ABOVE EXAMINATION OR NEGLECT TO INCLUDE ALL MATERIALS AND LABOR REQUIRED TO PROPERLY COMPLETE THE
- PERMITS, FEES AND CODE REGULATIONS. THE CONTRACTOR SHALL, AT HIS OWN EXPENSE, OBTAIN ALL NECESSARY PERMITS, PAY ALL LEGAL FEES AND CHARGES PERTAINING TO THE WORK UNDER THIS SECTION, AND COMPLY WITH ALL NATIONAL CODES, STATE OR LOCAL MUNICIPAL BUILDING CODES, SAFETY LAWS, ORDINANCES AND REGULATIONS REGARDING BUILDING AND PUBLIC SAFETY APPLICABLE TO THIS PROJECT.
- CONTRACTOR FOR THE VARIOUS PORTIONS OF THE WORK UNDER THIS SECTION SHALL GUARANTEE AND FURNISH WRITTEN CERTIFICATES TO THIS EFFECT. THAT ALL SYSTEMS SHALL BE LEFT IN PERFECT WORKING ORDER AND THAT ANY AND ALL DEFECTS WHICH DEVELOP WITHIN ONE (1) YEAR, EXCEPTING NORMAL WEAR AND TEAR, WILL BE REPLACED AT
- SHOP DRAWINGS, SUBMITTAL DRAWINGS AND RECORD DRAWINGS: SUBMIT SHOP DRAWINGS, SUBMITTAL DRAWINGS AND RECORD DRAWINGS TO THE ARCHITECT.
- CLARITY AND UNDERSTANDING OF CONTRACT DOCUMENTS: THE CONTRACTORS, BY SUBMITTING A BID, SHALL INDICATE THAT THEY HAVE THOROUGHLY REVIEWED THE DOCUMENTS AND IN THEIR OPINION AGREE THAT THE WORK SHOWN OR INDICATED THEREON IS FEASIBLE FOR A PROJECT OF THIS NATURE AND THAT EACH CONTRACTOR IS CAPABLE FINANCIALLY AND OTHERWISE, OF PERFORMING ALL THE WORK
- PROVIDE A NEW PLUMBING SYSTEM AS SHOWN ON DRAWINGS. COORDINATE WORK WITH OTHER TRADES TO AVOID INTERFERENCES AND TO PRESENT A NEAT, WORKMANLIKE APPEARANCE. INTERFERENCES WHICH RESULT FROM POOR COORDINATION WILL NOT BE CONSIDERED AS EXTRA WORK. ALL MINOR DEVIATIONS REQUIRED DUE TO INTERFERENCES WITH THE WORK OF OTHERS SHALL BE MADE BY PLUMBING CONTRACTOR AT NO ADDITIONAL COST.
- THE DRAWINGS ARE SCHEMATIC IN NATURE AND SHOW APPROXIMATE LOCATION OF EQUIPMENT, PIPING AND FIXTURES. IT SHALL BE THE RESPONSIBILITY OF THE CONTRACTOR TO FIELD VERIFY LOCATIONS OF OLD AND NEW EQUIPMENT, PIPING AND FIXTURES.
- . ALL WORK SHALL BE DONE IN ACCORDANCE WITH ALL APPLICABLE STATE, CITY AND LOCAL CODES.
- ALL SANITARY AND VENT LINES SHALL BE HUB LESS PVC SHED. 40 PIPE CONFORMING TO ASTM D-2665.
- D. ROVIDE CLEAN OUTS WHERE INDICATED ON PLANS. UNFURNISHED AREAS SHALL BE ZURN NO. 21440-1 SUPREMO CLEAN OUT WITH CADMIUM PLATED CAST IRON PLUG.
- . HOT AND COLD WATER PIPING SEE PLUMBING MATERIAL LIST. PROVIDE ISOLATION FITTINGS WHERE DISSIMILAR MATERIALS ARE USED.
- . INSULATE HOT AND COLD WATER LINES ABOVE CEILING WITH 1-1/2" JOHNS-MANSVILLE MICROLOC 650AP OR AP-T FIBERGLASS INSULATION WITH KRAFT-SCRIM-FOIL VAPOR BARRIER JACKET.
- 3. ALL INTERIOR GAS PIPING SHALL BE INSTALLED SO AS TO GRADE TOWARDS THE GAS GRADE. GAS PIPING CONCEALED IN WALLS, CHASES OR ABOVE CEILING SHALL BE INSTALLED IN A SCHEDULE 20 WELDED STEEL SLEEVE VENTED TO OUTSIDE ATMOSPHERE. GAS PIPING SHALL BE ASTM A53. SCHEDULE 40. BLACK STEEL JOINED BY SCHEDULE 40 BLACK WELDING FITTINGS. PROVIDE CONDENSATION TRAPS WITH REMOVABLE CAPS AT ALL EQUIPMENT CONNECTIONS.
- 4. PROVIDE AIR CHAMBERS AT EACH HOT AND COLD WATER SUPPLY PIPE AT EACH FIXTURE. PROVIDE AN AIR CHAMBER ONE SIZE LARGER THAN THE FIXTURE BRANCH AND NOT LESS THAN 18" HIGH.

PLUMBING NOTES:

- ALL PLUMBING INSTALLATIONS SHALL COMPLY WITH ALL APPLICABLE STATE AND LOCAL CODES AND ADA REQUIREMENTS, AND ASTM E2336
- INSTALL ALL THREADED CLEANOUT PLUGS WITH PIPE DOPE TO ALLOW EASY REMOVAL IN THE FUTURE.
- IT WILL BE THE RESPONSIBILITY OF THE PLUMBING CONTRACTOR TO INSURE THAT ITEMS TO BE FURNISHED UNDER PLUMBING CONTRACT WILL FIT THE SPACE AVAILABLE - PLUMBING CONTRACTOR SHALL MAKE NECESSARY FIELD MEASUREMENTS TO ASCERTAIN SPACE REQUIREMENTS. INCLUDING THOSE FOR CONNECTIONS AND SHALL FURNISH AND NSTALL SUCH SIZES AND SHAPES OF EQUIPMENT THAT ARE THE TRUE INTENT OF THE DRAWINGS AND SPECIFICATIONS.
- GENERAL CONTRACTOR SHALL PROVIDE ALL OPENINGS IN THE ROOF WITH EACH CONTRACTOR RESPONSIBLE FOR VERIFYING LOCATION AND SIZES OF ALL OPENINGS REQUIRED UNDER HIS CONTRACT, UNLESS NOTED OTHERWISE ON THE PLANS.
- PLUMBING CONTRACTOR SHALL SUPPLY AND INSTALL GAS PIPING AS SHOWN ON PLANS. ALL GAS PIPING SHALL COMPLY WITH LOCAL CODES. PLUMBING CONTRACTOR SHALL MAKE ALL FINAL CONNECTIONS TO ALL GAS EQUIPMENT. PROVIDE/INSTALL REGULATORS AT HVAC AND WATER HEATER EQUIPMENT WHERE REQUIRED TO REDUCE TO NORMAL OPERATING PRESSURE OF THE EQUIPMENT AS INDICATED ON THE EQUIPMENT NAME PLATES. DO NOT PRESSURE CHECK GAS LINES WHEN HOOKED UP TO EQUIPMENT OR HVAC UNITS. FINAL LEAK TEST FROM SHUTOFF TO EQUIPMENT SHALL BE DONE UNDER NORMAL PRESSURE WITH SOAP/WATER SOLUTION AFTER GAS PIPING IS CONNECTED.
- PLUMBING CONTRACTOR SHALL INSTALL SHOCK ABSORBERS TO MEET
- ALL STATE AND LOCAL CODE REQUIREMENTS. CONTRACTOR SHALL REFER TO ARCHITECTURAL PLANS FOR APPROVED FLOOR PLAN AND DIMENSIONS. DO NOT SCALE PLUMBING DRAWINGS.
- PLUMBING CONTRACTOR SHALL BE RESPONSIBLE FOR INSTALLING CONDENSATE DRAIN PIPING ON AIR HANDLING UNITS. COORDINATE WORK WITH MECHANICAL CONTRACTOR.
- PLUMBING CONTRACTOR SHALL INSTALL WATER SUPPLY PIPES SO THAT NO PIPE JOINTS ARE UNDER FLOOR SLAB. 10. ALL PIPES PASSING THROUGH FLOOR SLAB OR EXTERIOR WALLS SHALL BE INSTALLED WITH A PIPE SLEEVE AS REQUIRED, AND SEALED
- LIQUIDTIGHT. SEE STRUCTURAL SHEETS. 11. ALL INDIRECT WASTE OUTLETS SHALL TERMINATE WITH A 2" AIR
- 12. PLUMBING CONTRACTOR SHALL BE RESPONSIBLE FOR VENT LINE TESTS AND WASTE SYSTEM TESTS, PER LOCAL CODE REQUIREMENTS. ALL HVAC AND EXHAUST SYSTEMS MUST BE RUNNING WHILE THESE TESTS ARE BEING PERFORMED. THE PLUMBING CONTRACTOR SHALL PROVIDE A CERTIFICATE TO THE OWNER VERIFYING COMPLIANCE AND ACCEPTANCE
- 13. P.C. SHALL PROVIDE/INSTALL INSULATION ON ALL CW/HW MAINS OUTSIDE OF BUILDING CONNECTED TO TANKLESS WATER HEATER PER MANUFACTURER'S REQUIREMENTS. P.C. SHALL PROVIDE/INSTALL 1" INSULATION ON ALL CW/HW MAINS INSIDE OF THE BUILDING, 1/2" INSULATION MIN. ON ALL BRANCHES. CONDUCTIVITY RANGE SHALL BE 0.24 TO 0.28 BTU-IN./(HR-FT -°F). CW PIPING SHALL BE INSULATED TO PREVENT CONDENSATION.
- 14. VACUUM BREAKERS SHALL BE INSTALLED ON ALL HOSE
- 15. ALL WATER PIPING UNDER CONCRETE SLAB SHALL BE TYPE 'L' SOFT DRAWN COPPER.
- 16. P.C. SHALL FURNISH AND INSTALL A VACUUM BREAKER TYPE BACK-FLOW PREVENTER, AS REQUIRED BY LOCAL CODES, AT ANY POINT WHERE THERE IS DANGER OF THE NON-POTABLE WATER SYSTEM COMING IN CONTACT WITH THE POTABLE WATER SYSTEM OR ANY DANGER OF BACK-FLOW. COORDINATE WITH LOCAL INSPECTOR.
- 17. MECHANICAL DUCTWORK SHALL HAVE RIGHT-OF-WAY OVER ALL PLUMBING PIPES AND ELECTRICAL CONDUITS.
- 18. ALL FLOOR/HUB DRAINS AND FLOOR SINKS SHALL BE PROVIDED WITH DEEP SEAL TRAPS.
- 19. IF INCOMING WATER PRESSURE TO THE BUILDING EXCEEDS 80 PSI., A WATER PRESSURE REDUCING VALVE WITH STRAINER SHALL BE INSTALLED JUST DOWN STREAM OF BUILDING MAIN ISOLATION VALVE.
- P.C. SHALL INSTALL WATER METER IN APPROVED EXTERIOR LOCATION AND ENCLOSURE; COORDINATE ALL REQUIREMENTS WITH LOCAL WATER CO. SEE SITE PLAN FOR EQUIPMENT LOCATIONS. PROVIDE ALL NECESSARY PLUMBING EQUIPMENT TO ENSURE PROPERLY OPERATING WATER AND SEWER SERVICE.
- 21. P.C. SHALL REFERENCE SHEETS A1.2, A1.3 AND PO FOR EQUIPMENT NUMBERS.
- 22. P.C. SHALL REFERENCE SHEET A1.3 FOR HEALTH NOTES.
- 23. P.C SHALL ROUTE 3/4" DIA. COPPER CONDENSATE DRAIN LINE FROM RTU'S (3/4" DIA. INSIDE CURBS), INTERCONNECT AND RUN 1" DIA. TO MOP SINK. TERMINATE WITH 2" AIR GAP (MIN.) AND INSULATE DRAIN LINE ABOVE CEILING PER SPECIFICATIONS.
- 24. PROVIDE AND INSTALL A WATTS #N9 VACUUM BREAKER ON WATER SUPPLY LINE TO SODA DISPENSERS.

BACKFL	OW PREVENTIC	N SCHEDULE
QUIPMENT	MEDIUM HAZARD APPLICATIONS (SEE NOTE 1)	HIGH HAZARD APPLICATIONS (SEE NOTE 1 & 2)
MACHINE	WATTS MODEL: SD-2	WATTS MODEL: N9
T WATER HEATER	WATTS MODEL: SD-2	WATTS MODEL: 9D
RBONATOR	WATTS MODEL: 9BD (NOTE 3)	WATTS MODEL: 9BD (NOTE 3)
SE BIBB (HB)	INTEGRAL VACUUM BREAKER	INTEGRAL VACUUM BREAKER
SE BIBB (NFHB)	INTEGRAL VACUUM BREAKER	INTEGRAL VACUUM BREAKER

P.C. SHALL VERIFY BACKFLOW REQUIREMENT WITH LOCAL CODE OFFICIALS. USE MEDIUM HAZARD BACKFLOW DEVICES UNLESS LOCAL CODE OFFICIALS CLASSIFY AS

- P.C. SHALL INSTALL PER MANUFACTURER'S RECOMMENDATIONS, AND VENT PIPE TO DRAIN WHERE NEEDED INDIRECTLY WITH 2" (MIN.) AIR GAP. P.C. SHALL USE PLASTIC TUBING DOWNSTREAM OF THE CARBONATOR.
- BACKFLOW DEVICE ON CARBONATORS SHALL BE INSTALLED BY REGISTERED CONTRACTOR, APPROVED BY LOCAL REGULATIONS.

PLUMBING MATERIAL LIST

ABOVE GRADE, INSIDE BUILDING

PVC SCH 40 PIPING. OR AS REQUIRED BY LOCAL CODE.

DOMESTIC WATER PIPING

ALL WATER LINES IN CEILING AND WALL SHALL BE ASTM A-120 OR GREATER SCHEDULE 40 GALVANIZED IRON PIPE.

BELOW GRADE, INSIDE BUILDING SANITARY WASTE AND VENT PIPING

PROVIDE SLOPE 1/8" PER FOOT MIN. OR AS REQUIRED BY LOCAL CODES. DOMESTIC WATER PIPING

ANNEALED (SOFT) COPPER WATER TUBE TYPE "K", ASTM B88, WITH NO JOINTS OR FITTINGS BELOW SLAB. WHEN JOINTS ARE REQ'D USE SILVER SOLDER.

BELOW GRADE, OUTSIDE BUILDING

SIZE 2-1/2 INCHES AND SMALLER:

DOMESTIC WATER PIPING (VERIFY W/CITY CODE AUTHORITY)

SCH. 40 PVC OR EQUIVALENT WITH GLUED JOINTS. DOMESTIC WATER PIPING

SIZE 2-1/2 INCHES AND LARGER: SHALL BE SCH. 40 PVC OR EQUIVALENT WITH

PVC SCHEDULE 40 PIPING, SLOPE AS REQUIRED BY LOCAL CODE.

WC-1	WATER CLOSET	1"		4"	2"		INTEGRAL	VORMAX PLUS RIGHT HEIGHT ELONGATED COMPLETE TOILET, 1.28 GPF, MODEL #708AA.101.020 WHITE W/ OPEN SEAT
WC-2	HANDICAPPED WATER CLOSET	1"		4"	2"	INSTALL PER ADA.	INTEGRAL	EDGEMERE RIGHT HEIGHT ELONGATED TOILET, 1.28 GPF, MODEL #204AA.104.020 WHITE W/ OPEN SEAT
U-1	H.C. URINAL	3/4"		2"	1-1/2"	WALL HUNG INSTALL PER ADA. 17" MAX. HEIGHT TO RIM		AMERICAN STD., DECORUM 0.125 GPF, 6042-633 W/ ELECTRONICURINAL FLUSH VALVE
L-1	LAVATORY	1/2"	1/2"	1-1/2"	1-1/2"		1-1/4"	AMERICAN STD. "OVALYN UNDERCOUNTER SINK" BOWL: 17" X 14" X 5-1/2" / UNDERMOUNT (GRANITE), 0496.221.020. FAUCET: KOHLER "CORALAIS" SINGLE CONTROL WITH RED/BLUE INDEX AND GRID DRAIN 1.50 GPM (WATERSENSE CERTIFIED) 4-5/8" SPOUT / 4" CENTERS, K-15198-XF-CP. STRAINER: "DUOSTRAINER" K-8801-CP
L-2	LAVATORY	1/2"	1/2"	1-1/2"	1-1/2"	WALL HUNG	1-1/4"	AMERICAN STD., ELLISSE 9000-000. W/ AMERICAN STD. FAUCET AND LEVER HANDLE MODEL # 2385.001 WHITE
MS-1	MOP SINK	1/2"	1/2"	3"	2"		3"	ZURN 24" X 24" Z1996-24, COMPLETE W/ WALL MOUNTED FAUCET EXPOSED YOKE WALL MOUNT UTILITY FAUCET WITH TOP BRACE AMER. STD. 8344.012.002, COMPLETE W/ RUBBER HOSE, S.S. WALL GUARD, MOP AND MOP HOLDER
FD	FLOOR DRAIN			2",3"	2"	WITH TRAP PRIMER	2",3"	ZURN
FS	FLOOR SINK			3"	2"	WITH TRAP PRIMER	3"	ZURN Z-1901-33
WH-1	TANKLESS GAS WATER HEATER	3/4"	3/4"		4"	2- REQD, INSTALL PER MANUF'R RECOMMENDATION		RINNAI TANKLESS INDOOR, GAS MODEL # R94LSI-VB2735FFUD-US
WH-2 & WH-3	TANKLESS GAS WATER HEATER	3/4"	3/4"		4"	1- REQD, INSTALL PER MANUF'R RECOMMENDATION		RINNAI TANKLESS INDOOR, GAS MODEL # R94LSI-VB2735FFUD-US
НВ	HOSE BIB	3/4"						WOOD FORD MODEL 65 W/ VACCUM BREAKER
GT	GREASE TRAP 1500 GAL.			4"	2"	INSTALL AS PER DETAIL SEE SHT. P8		PARK EQUIPMENT COMPANY MODEL # GT-1500
SW	SAMPLE WELL			4"		INSTALL AS PER DETAIL SEE SHT. P8		PARK EQUIPMENT COMPANY
SK	3 COMPARTMENT SINK	3/4"	3/4"	1-1/2"	1-1/2"	DRAIN TO FLOOR SINK		SEE SHEET A1.3
HS-1	HAND SINK	1/2"	1/2"	1-1/2"	1-1/2"	INSTALL PER ADA.		SEE SHEET A1.3
IM	ICE MAKER	1/2"				PROVIDE FILTERED WATER		BY OWNER

PROVIDE FILTERED WATER

PROVIDE FILTERED WATER

SEE NOTE "2"

SIZE

SPEC. & MODEL

SODA MACHINE

COFFEE MAKER

TRAP PRIMER

THERMOSTATIC

MIXING VALVES

I. SEE SHEETS P1 AND SHEET A1.3 FOR ADDITIONAL KITCHEN **EQUIPMENT FOR PLUMBING REQUIREMENTS**

PLANS

1/2"

PLANS

PLUMBING FIXTURE SCHEDULE

DESCRIPTION C.W. H.W. SAN. VENT.

ROVIDE THE FOLLOWING SIZE BRANCH

ONNECTION TO THE DISTRIBUTION MAIN

UNLESS OTHERWISE SPECIFIED

2. TEMPERED WATER REQUIRED FOR RESTROOM LAVATORIES AND HAND SINKS. TEMPERATURE RANGE: 85-110 DEGREES. TEMPERED WATER LIMITING DEVICE SHALL CONFORM TO ASSE 1070 AND SHALL LIMIT THE TEMPERED WATER TO A MAXIMUM OF 110°F.

PLUMBING W	ASTE	AND) WA	ATER	CAI	_CULA ⁻	TION		
FIXTURE TYPE	QTY	D.F.U. (EA)	TOTAL D.F.U.	HOT S.F.U. (EA)	COLD S.F.U. (EA)	COMBINED S.F.U. (EA)	TOTAL S.F.U. (HOT)	TOTAL S.F.U. (COLD)	TOTAL SERVICE S.F.U.
PUBLIC LAVATORY	2	2.0	4.0	1.50	1.50	2.00	3.00	3.00	6.00
SERVICE SINK (MOP BASIN)	2	3.0	3.0	2.25	2.25	3.00	2.25	2.25	4.50
FLOOR DRAIN	14	2.0	2.0	0.00	0.00	0.00	0.00	0.00	0.00
FLOOR SINK	3	2.0	2.0	0.00	0.00	0.00	0.00	0.00	0.00
PUBLIC WATER CLOSET (1.6 GPF FLUSH TANK)	3	4.0	8.0	0.00	5.00	5.00	0.00	10.0	15.0
PUBLIC WATER CLOSET URINALS	1	2.0	4.0	0.00	1.5	1.5	0.00	1.5	1.5
SPECIALTY KITCHEN EQUIP.					-	7			
SINK (HAND) (1-1/2" IW)	2	2.0	4.0	1.50	1.50	2.00	3	3	4.0
SINK (PREP / VEGGIE) (2" IW)	0	3.0	3.0	1.50	1.50	2.00	1.5	1.5	0.00
SINK (3 COMPARTMENT) (2" IW)	1	3.0	3.0	3.00	3.00	4.00	3	3	4.0
ICE MACHINE (3/4" IW)	1	0.5	0.5	0.00	1.00	1.00	0	1	1.0
COFFEE MAKER (3/4" IW)	1	0.5	0.5	0.00	0.50	0.50	0	0.5	0.5
SODA MACHINE (3/4" IW)	1	0.5	0.5	0.00	0.50	0.50	0	0.5	0.5
TOTAL UNITS:	31		31.5				11.25	23.25	37.00
									<u> </u>

Y OWNER

BY OWNER

PRECISION PLUMBING PRODUCT PI-500

POWER SERIES LFG480 CONFORMS TO ASSE 1070

SCALE: NO SCALE


DRAWN:

CHECKED:

DATE: JAN 2018

NEW LAWRENCE GROCERY

902 E. BAYSHORE, LEON, TEXAS 77539

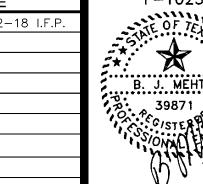







3-01-17 REVISED AS NOTED PER CITY COMMENTS $1\ 2\ 2\ 0\quad B\ I\ a\ I\ o\ c\ k\quad \#\ 2\ 3\ 0\qquad P\ h\ :\ (\ 7\ 1\ 3\)\ 4\ 6\ 5\ -\ 0\ 0\ 0\ 9$


18-02-003

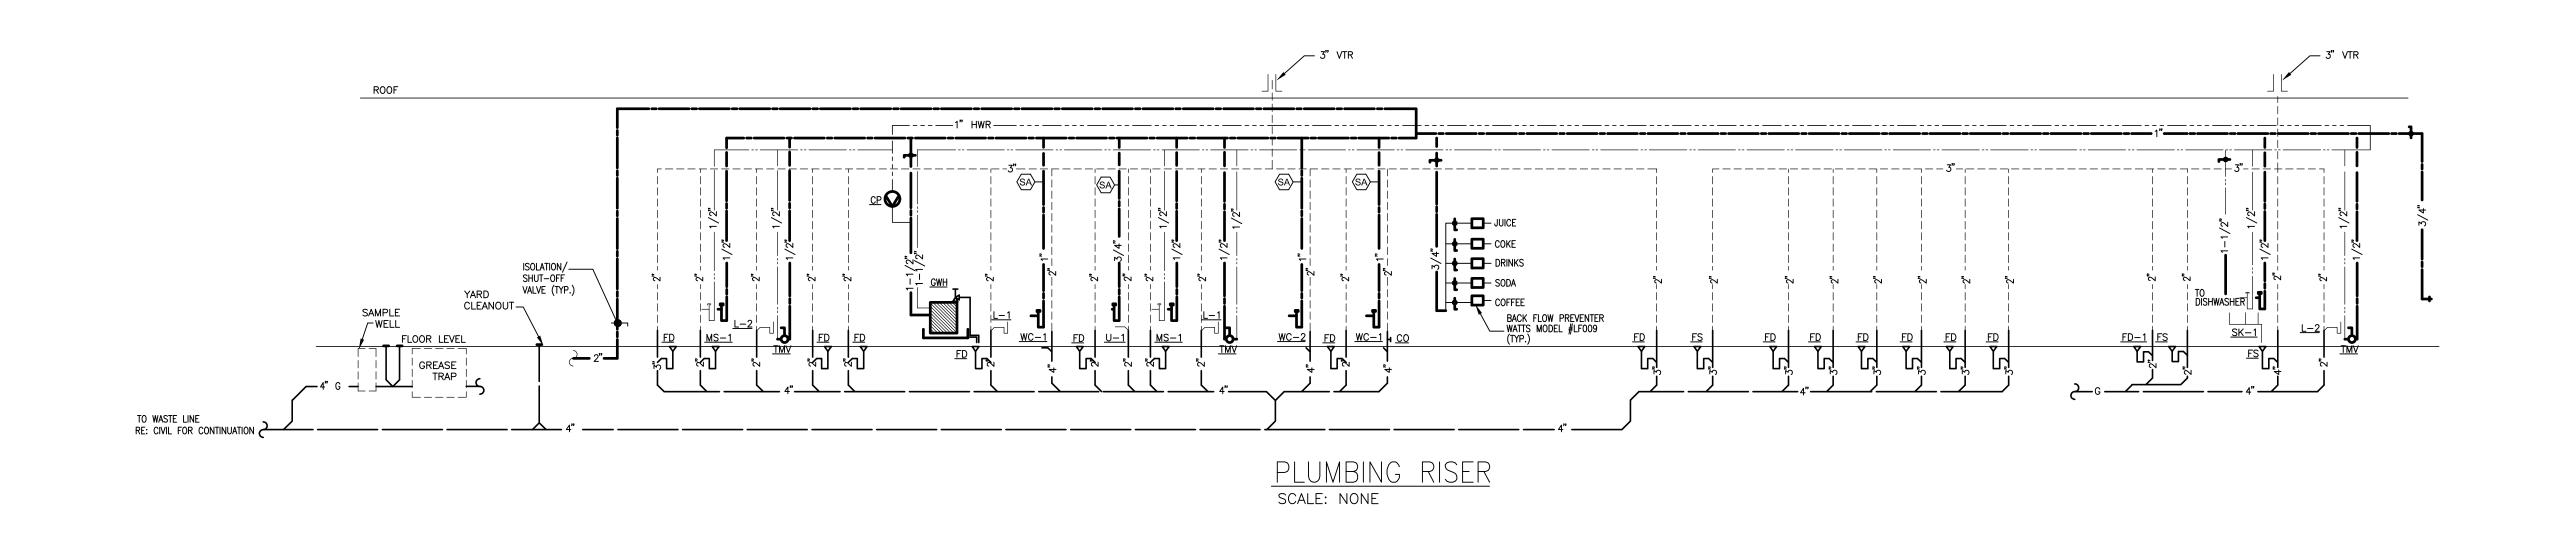

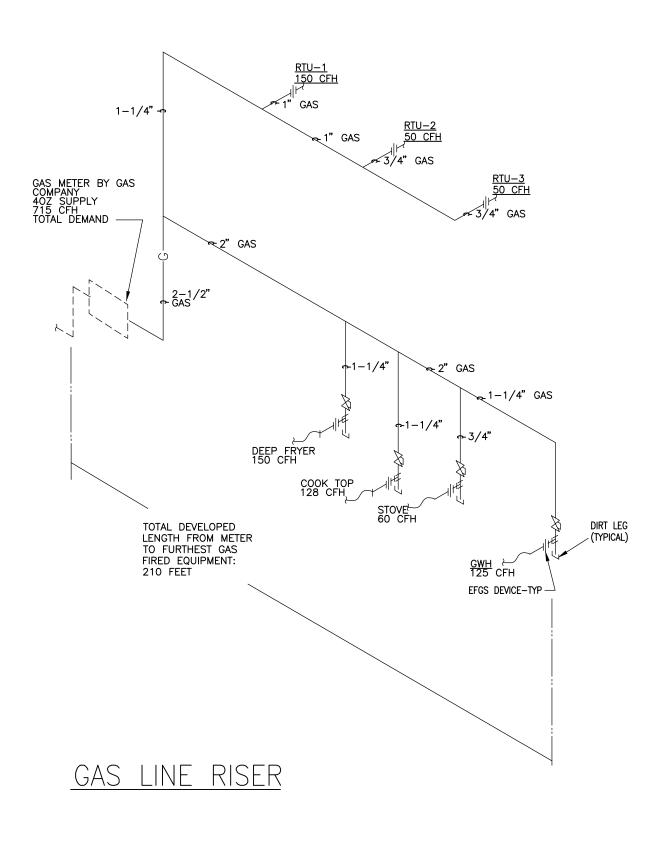

NEW LAWRENCE GROCERY

902 E. BAYSHORE, LEON, TEXAS 77539

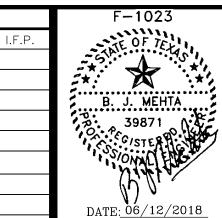








SCALE: AS NOTED


SHEET NO.


18-02-003

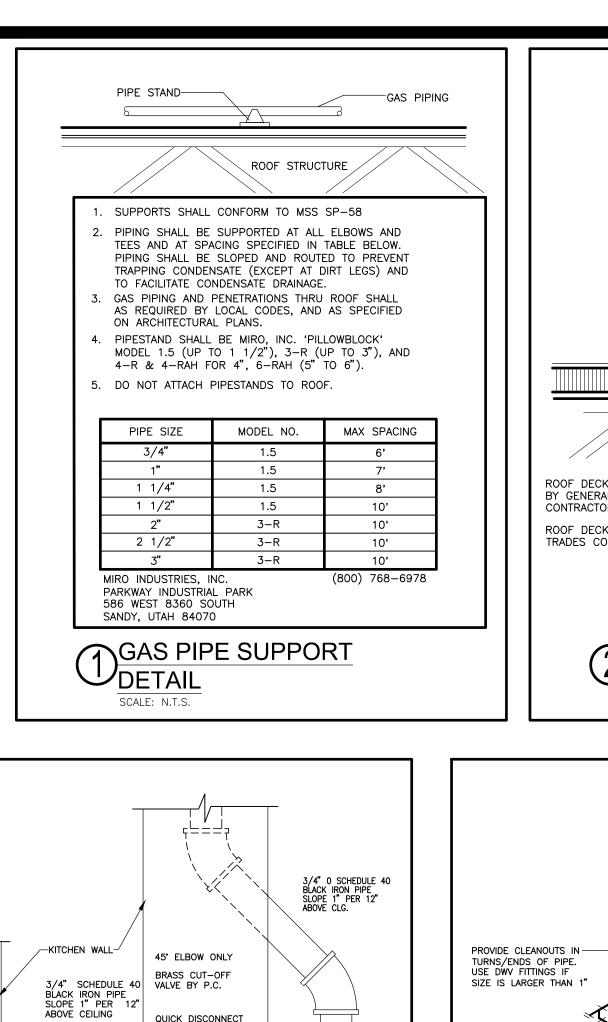


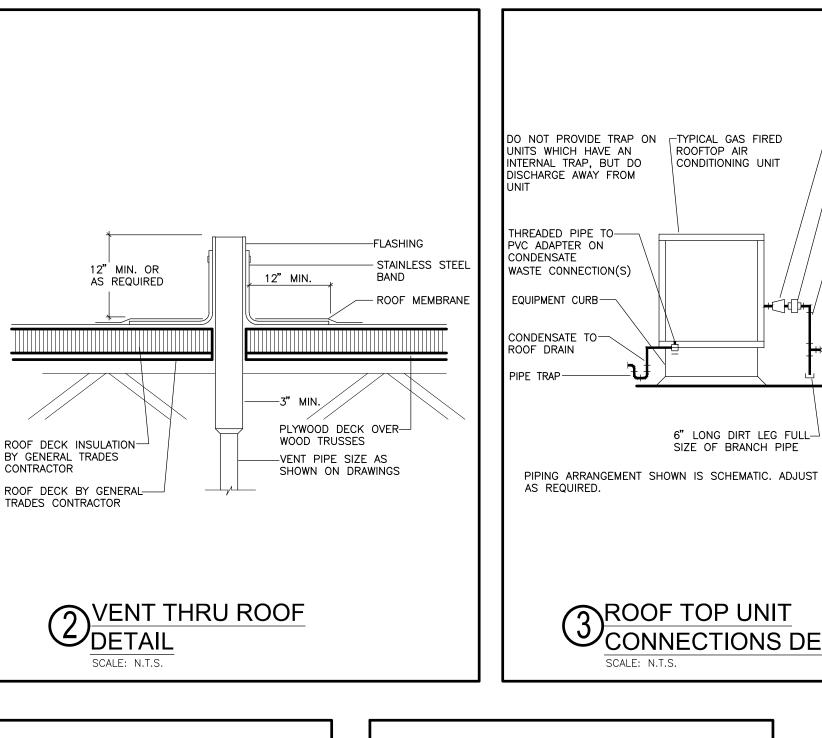


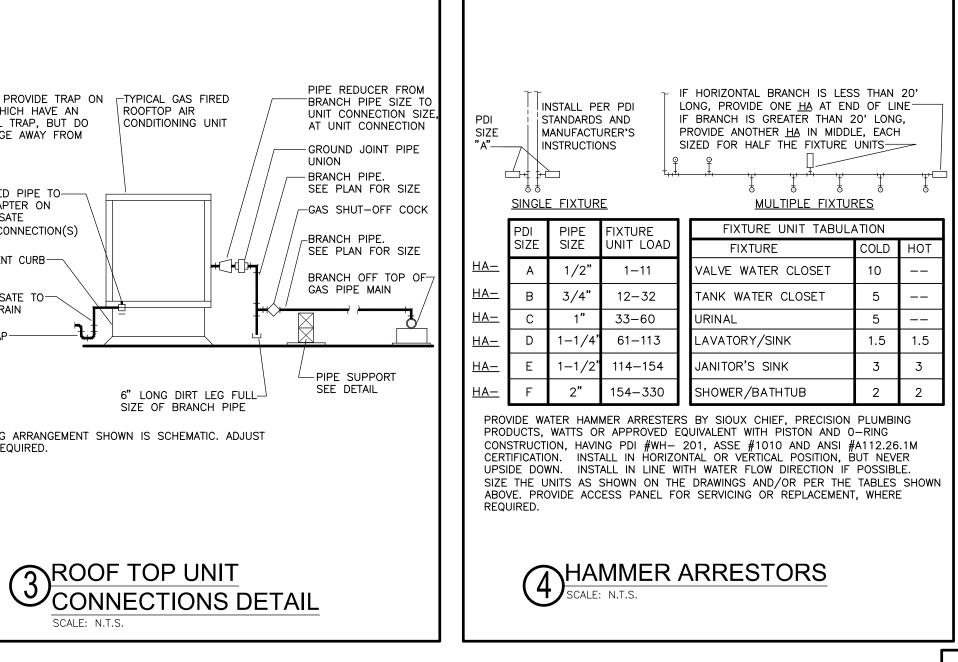


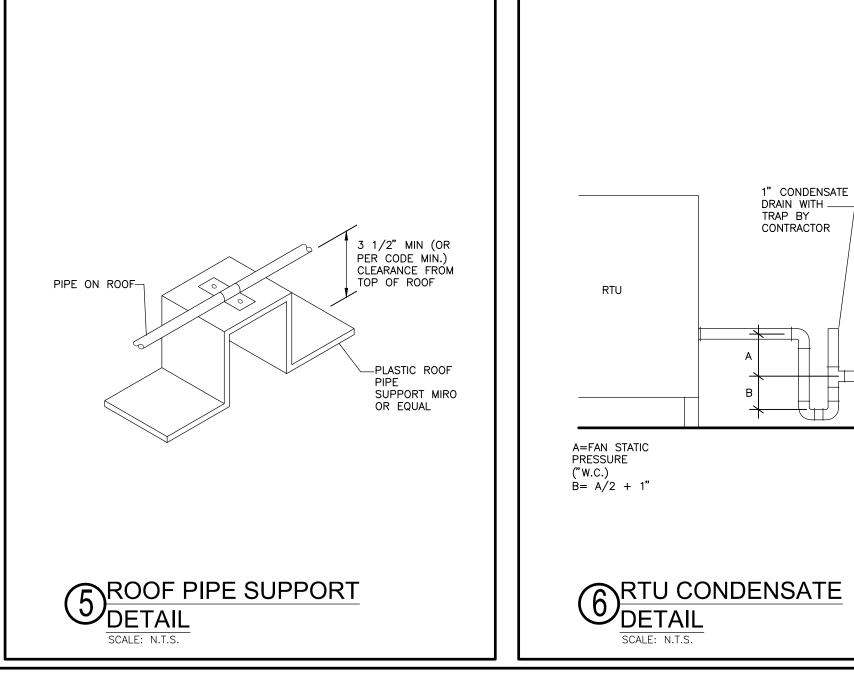


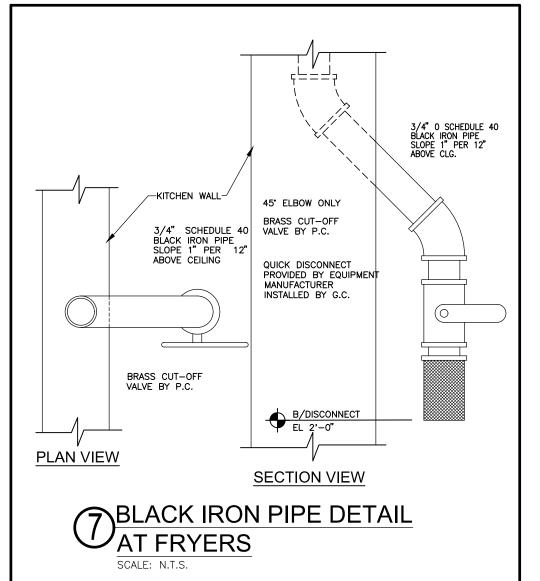


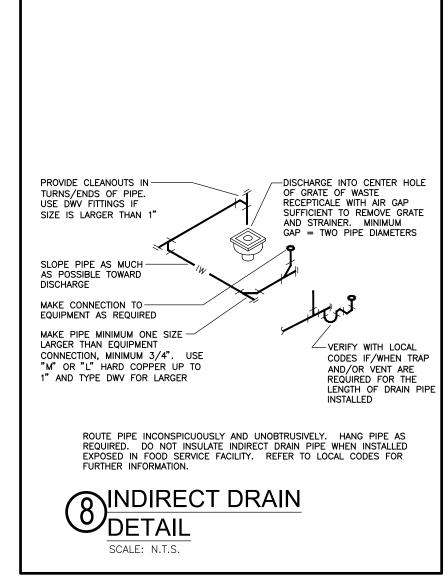


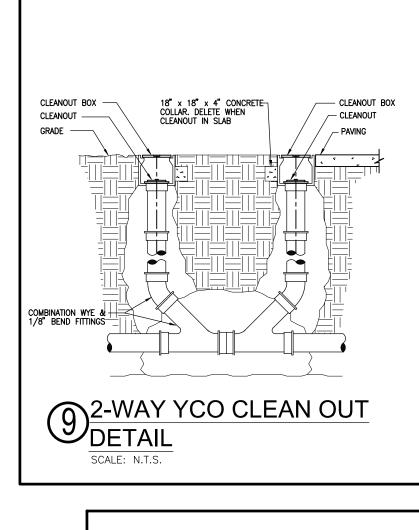


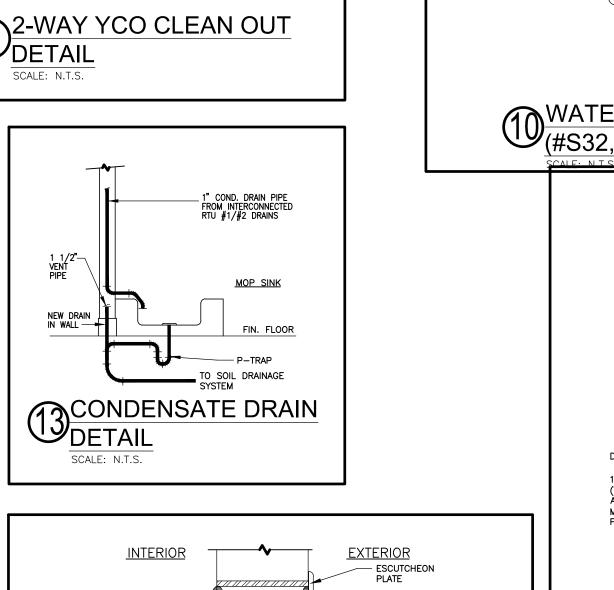


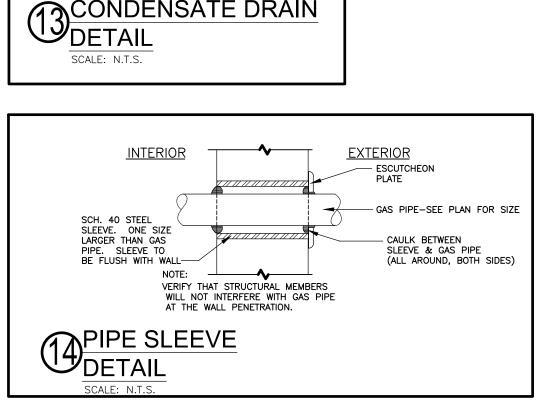


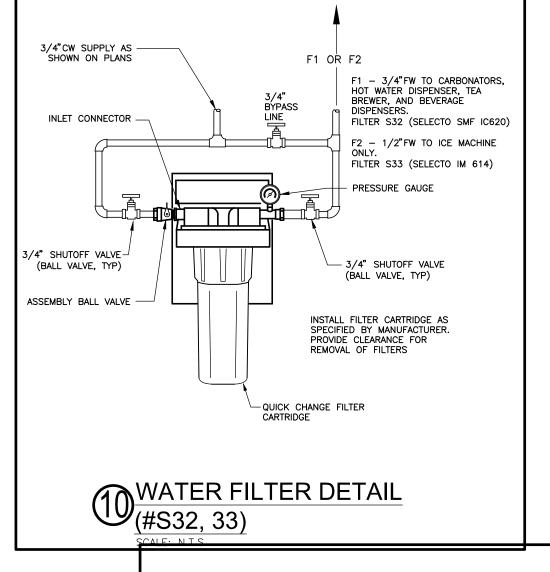


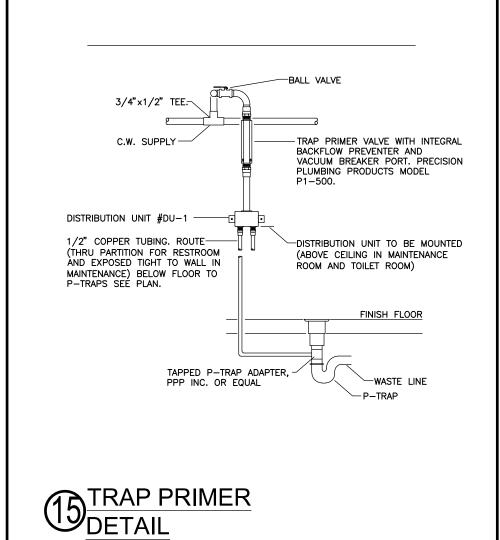


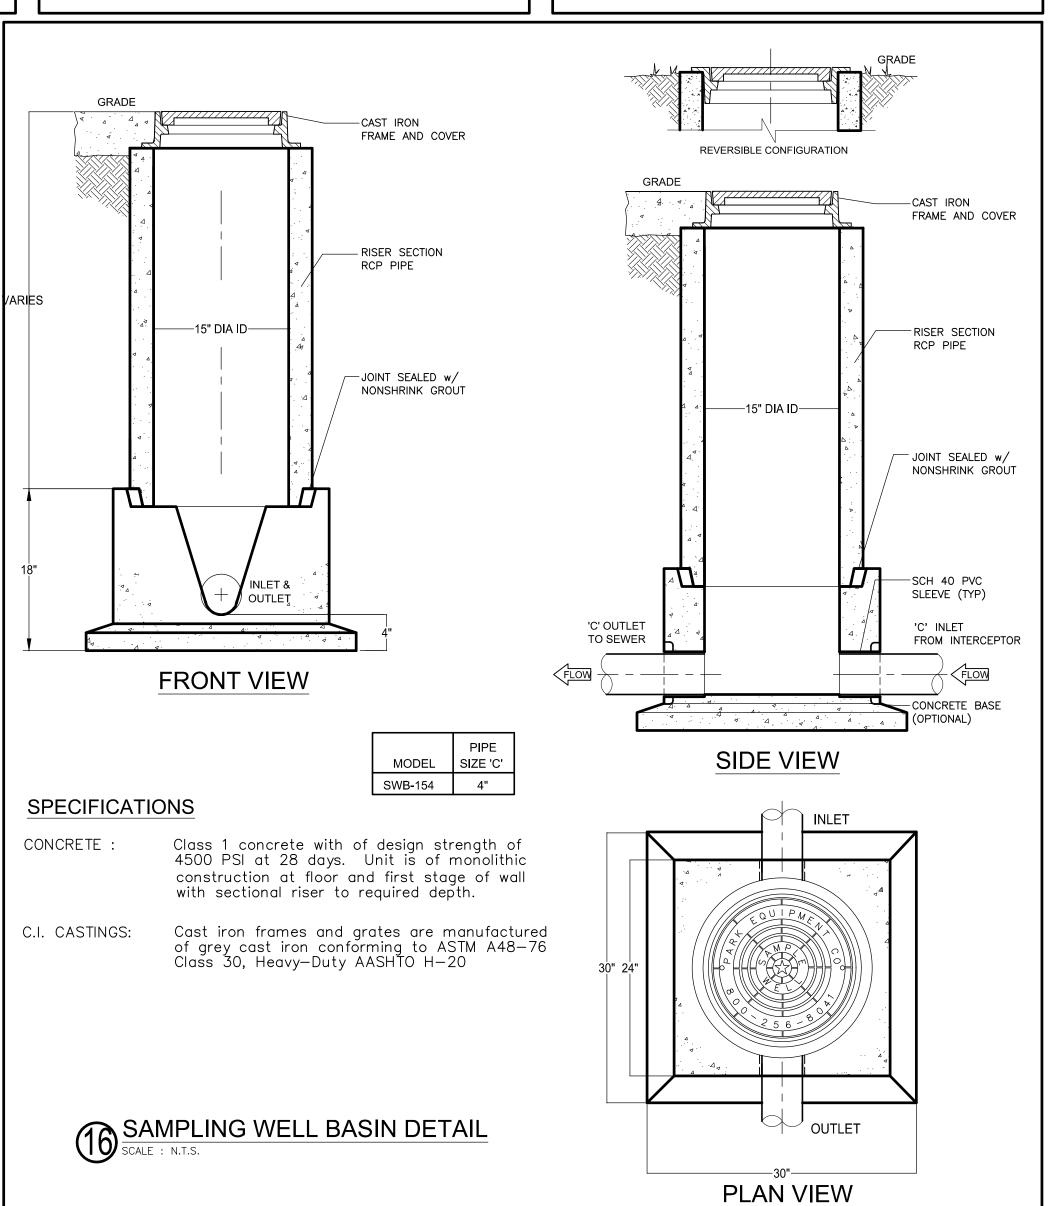

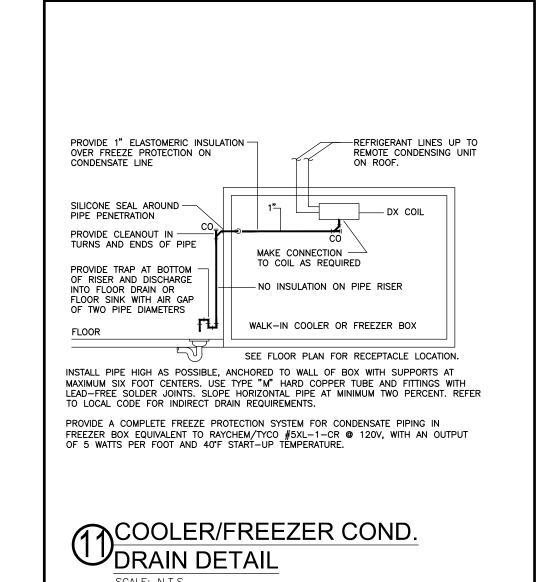

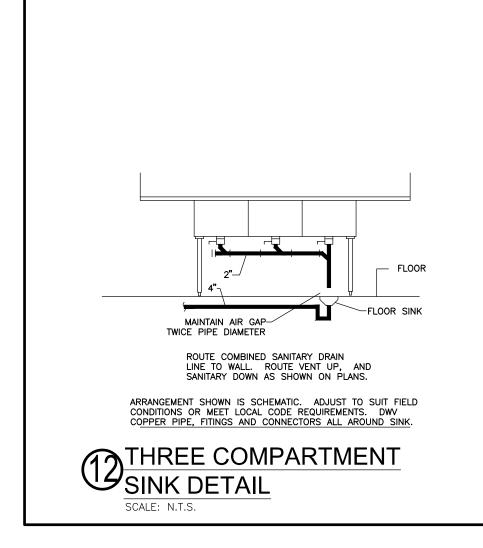


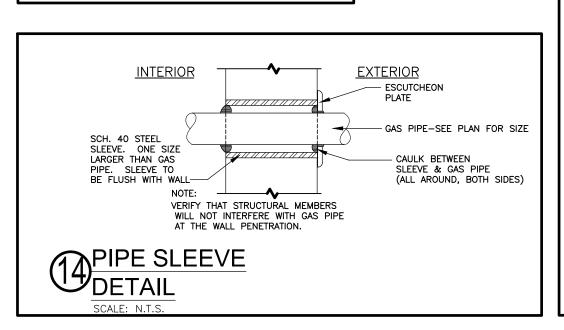

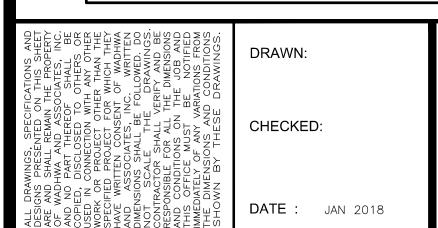

NEW LAWRENCE GROCERY


902 E. BAYSHORE EON, TEXAS 77539

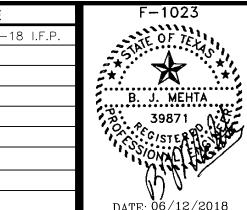









SCALE: AS NOTED 18-02-003 SHEET NO.

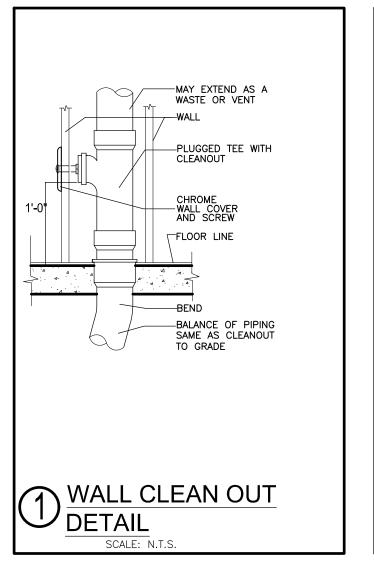


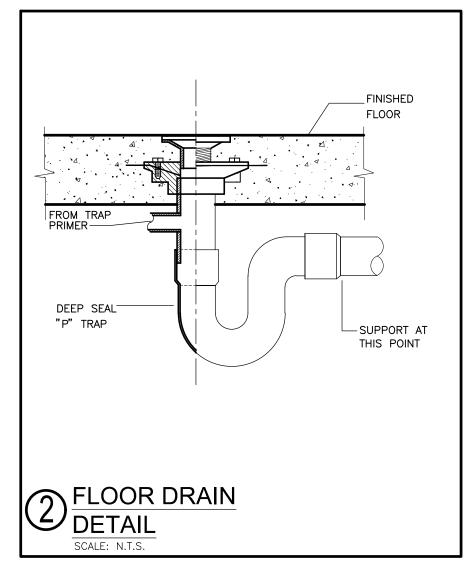


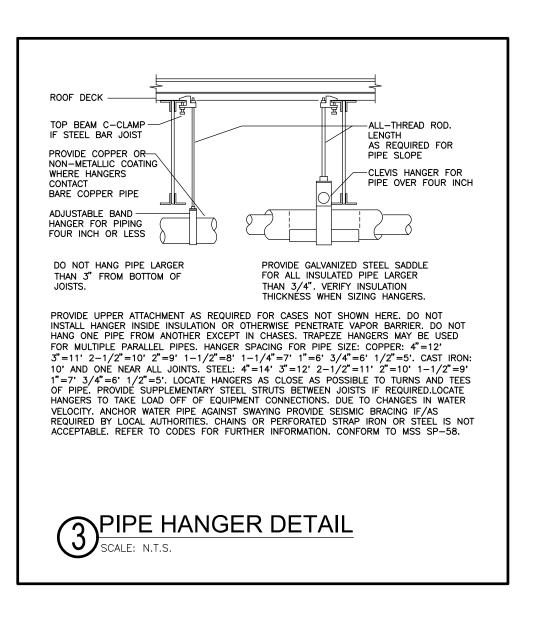


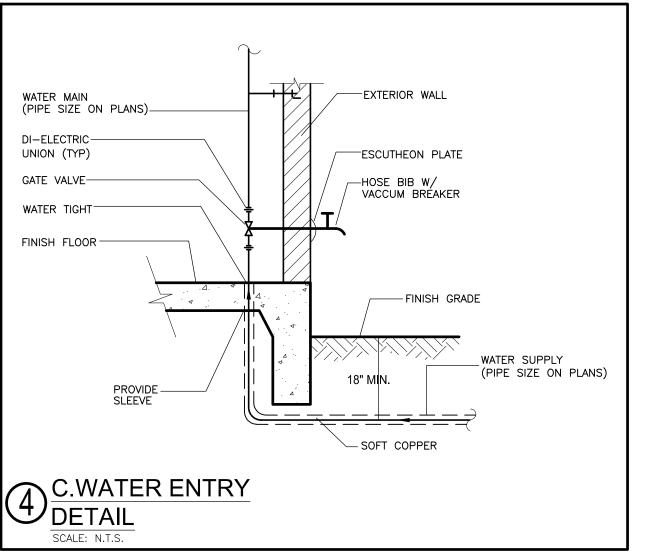


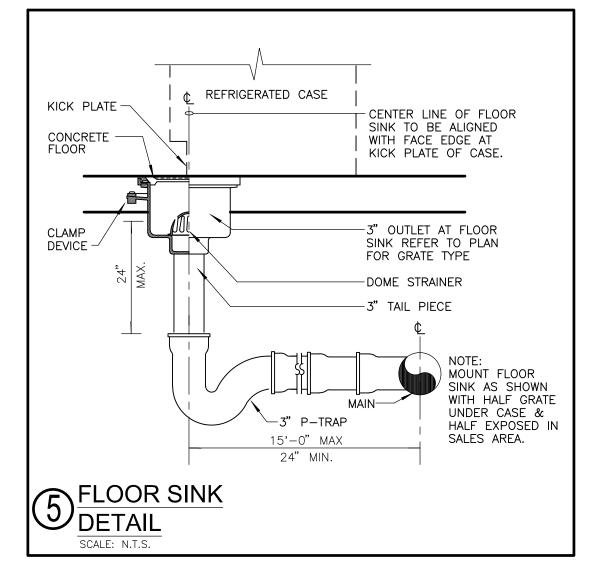


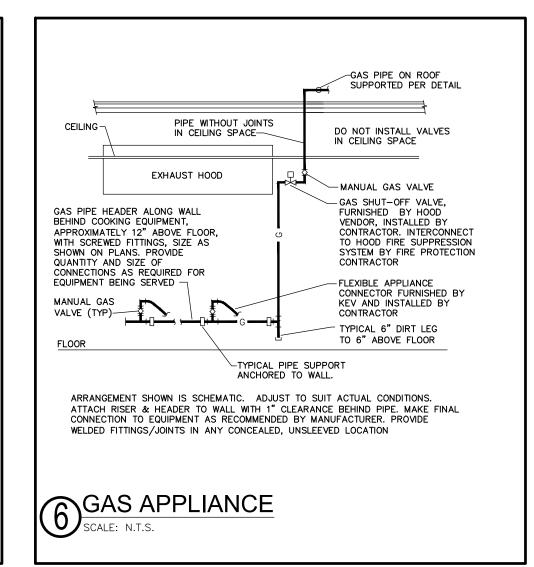


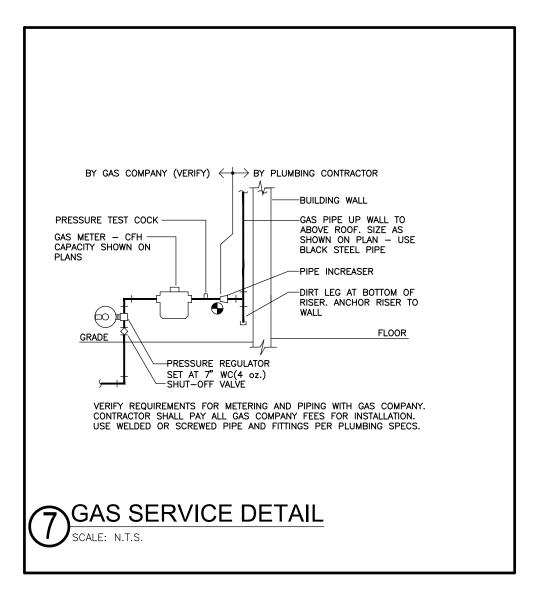

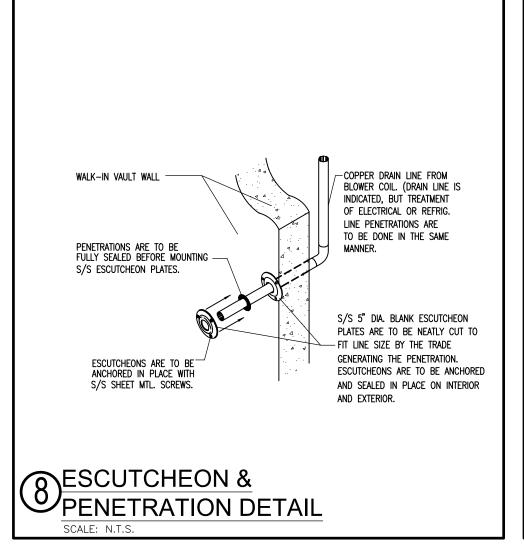

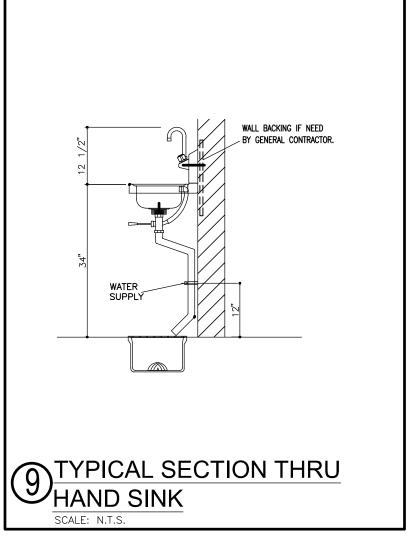

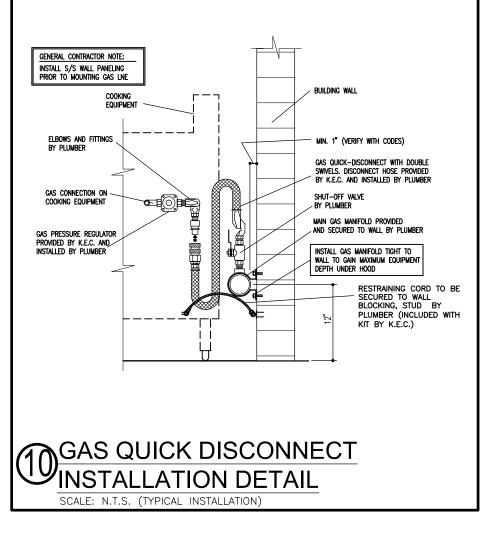


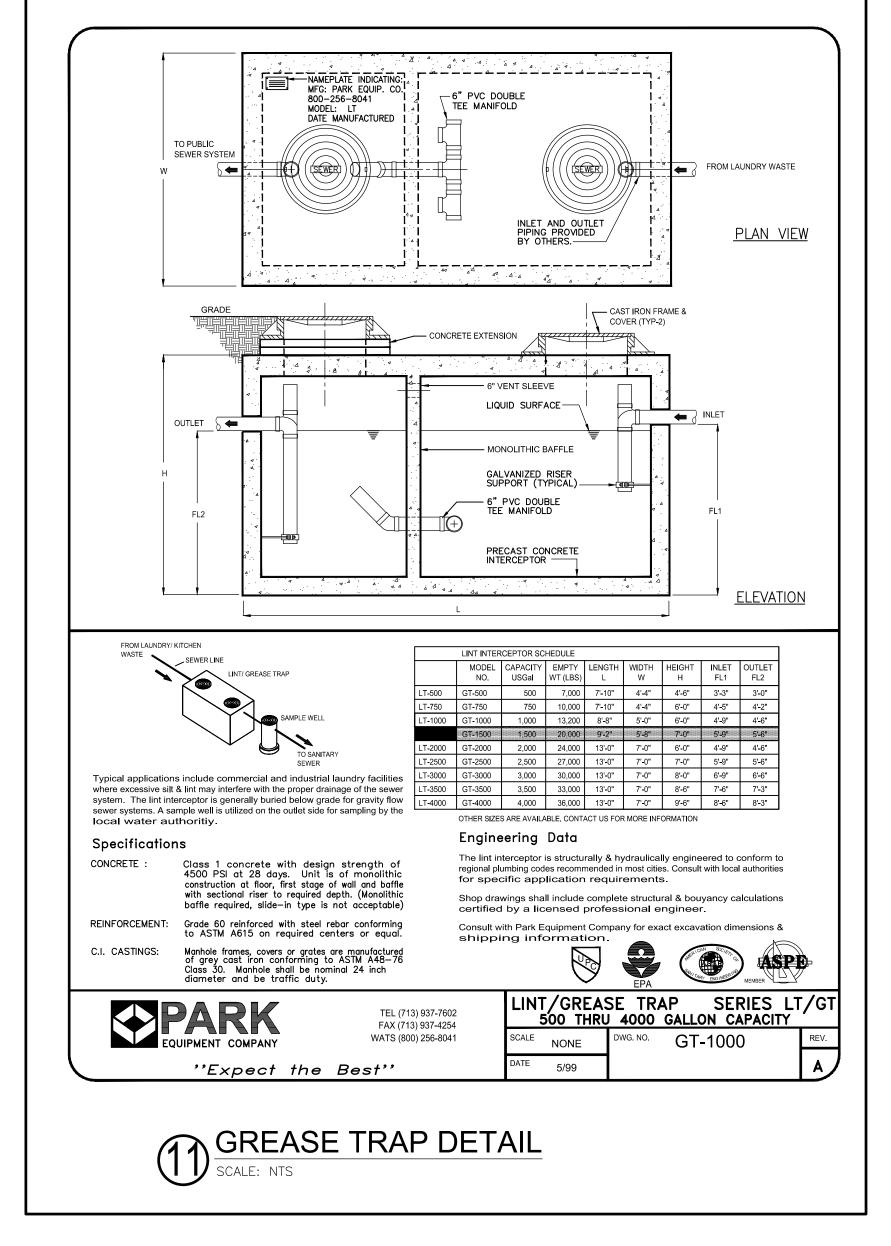

DRAWN: CHECKED: **DATE**: JAN 2018

NEW LAWRENCE GROCERY


902 E. BAYSHORE, LEON, TEXAS 77539

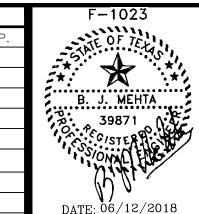





SCALE: AS NOTED 18-02-003 SHEET NO.

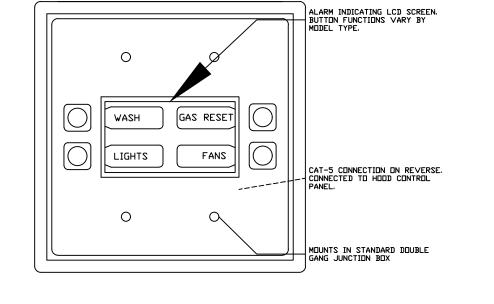



EXHAUST FAN INFORMATION - Job#3402514

FAN UNIT MODEL #

DU85HFA

FAN UNIT MODEL #

A1-G10

EXHAUST

MUA FAN INFORMATION - Job#3402514

1 KEF-1

2 KMUA-1

FAN OPTIONS

2 KMUA-1

TAG

FAN ACCESSORIES

TAG

1 KEF-1 YES

CURB ASSEMBLIES

TAG

KEF-1

KMUA-1

2 KMUA-1

I NO. | _ON .

1 | # 1 |

2 | # 2 |

CFM

2200

BLOWER HOUSING

KEF-1 1 - ECM Wiring Package-Exhaust - Manual or 0-10VDC Reference Speed Control (NIDEC

GREASE GRAVITY WALL SIDE GRAVITY MOTORIZED WALL

WEIGHT

36 LBS

29 LBS

CUP | DAMPER | MOUNT | DISCHARGE | DAMPER | DAMPER | MOUNT

ESP.

1.000

OPTION (Qty. - Descr.)

1 - ECM Wiring Package-Supply - Manual or 0-10VDC Reference Speed Control (NIDEC

SUPPLY

ITEM

Curb

Curb

RPM | H.P. | B.H.P. | Ø | VOLT | FLA


1474 | 1.000 | 0.6320 | 1 | 115 | 10.2


ESP.

0.600

MIN DESIGN CFM CFM

1760

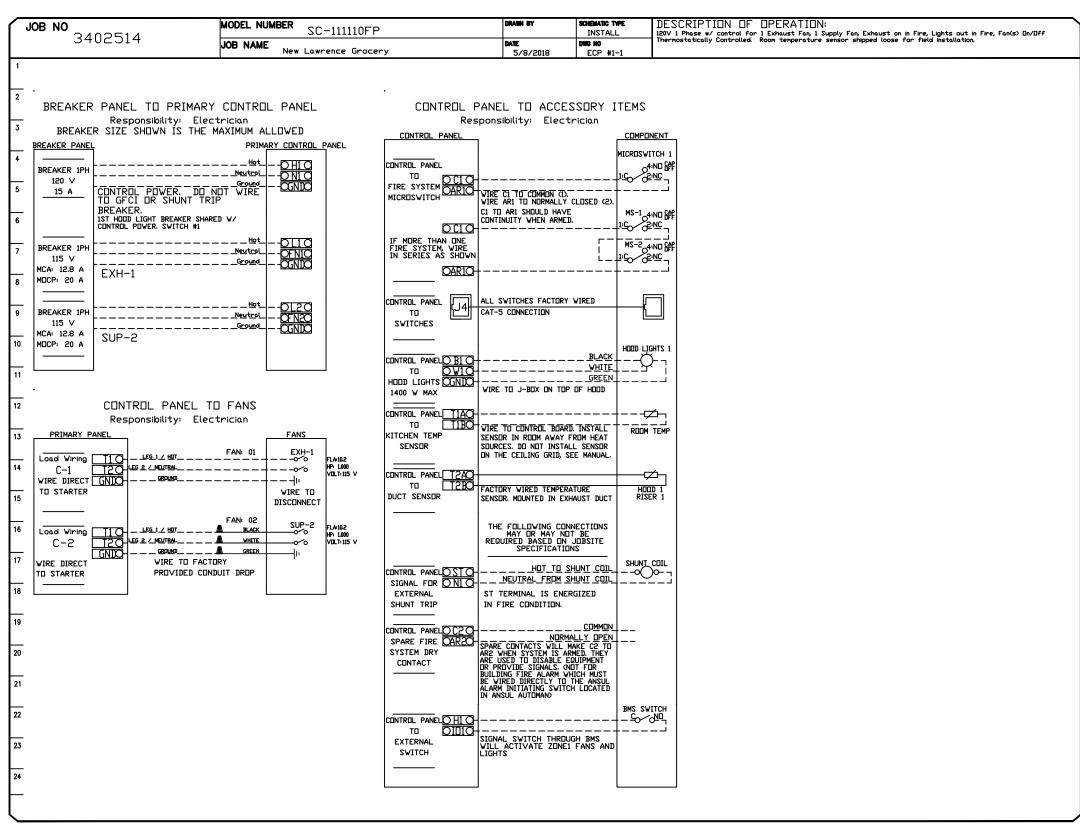

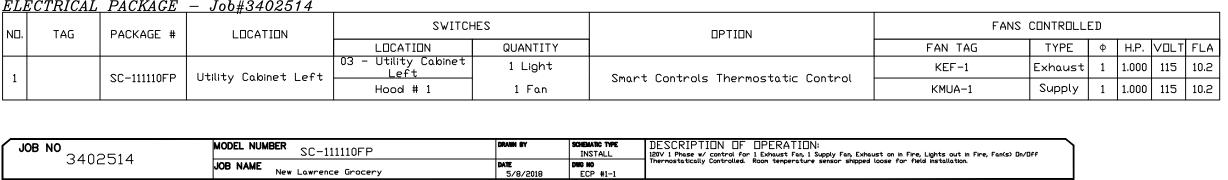

LE.	CTRICAL	PACKAGE	- Job#3402514									
	TAG	PACKAGE #	" LOCATION	SWITCH	ES		FANS CONTROLLED					
	THO			LOCATION	QUANTITY		FAN TAG	TYPE	ф	H.P.	VOLT	FLA
		SC-111110FP	Utility Cabinet Left	03 - Utility Cabinet Left	1 Light	Smart Controls Thermostatic Control	KEF-1	Exhaust	1	1.000	115	10.2
		2C-111110FF		Hood # 1	1 Fan	Smart controls Thermostatic Control	KMUA-1	Supply	1	1.000	115	10.2
		•	l	<u> </u>				•			ı	

DISCHARGE VELOCITY

696 FPM

RPM H.P. B.H.P. Ø VOLT FLA WEIGHT (LBS.)

970 | 1.000 |0.6980|

SIZE

23.000"W x 23.000"L x 20.000"H Vented Hinged

21.000"W × 21.000"L × 16.000"H


WEIGHT (LBS.)

92


115 | 10.2 | 196

SONES

18.2

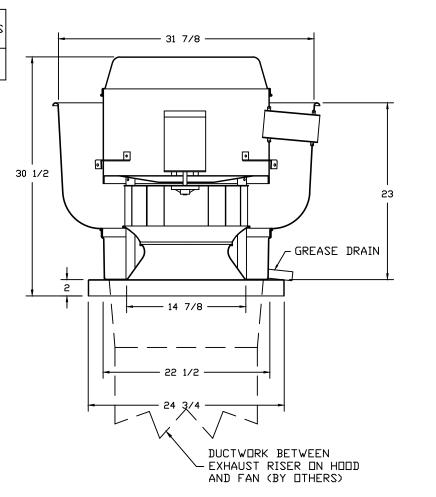


FAN #1 DU85HFA - EXHAUST FAN (KEF-1)

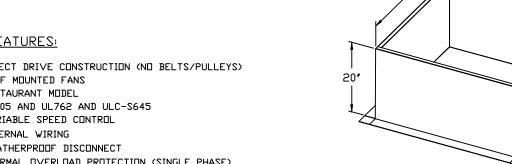


- FEATURES: - DIRECT DRIVE CONSTRUCTION (NO BELTS/PULLEYS) - ROOF MOUNTED FANS
- RESTAURANT MODEL - UL705 AND UL762 AND ULC-S645 - VARIABLE SPEED CONTROL
- INTERNAL WIRING


AN UNSAFE CONDITION.


- WEATHERPROOF DISCONNECT
- THERMAL OVERLOAD PROTECTION (SINGLE PHASE) - HIGH HEAT OPERATION 300°F (149°C) - GREASE CLASSIFICATION TESTING
- NORMAL TEMPERATURE TEST EXHAUST FAN MUST OPERATE CONTINUOUSLY WHILE EXHAUSTING AIR AT 300°F (149°C) UNTIL ALL FAN PARTS HAVE REACHED THERMAL EQUILIBRIUM, AND WITHOUT ANY DETERIORATING EFFECTS TO THE FAN WHICH WOULD CAUSE UNSAFE OPERATION.
- ABNORMAL FLARE-UP TEST EXHAUST FAN MUST OPERATE CONTINUOUSLY WHILE EXHAUSTING BURNING GREASE VAPORS AT 600°F (316°C) FOR A PERIOD OF 15 MINUTES WITHOUT THE FAN BECOMING DAMAGED TO ANY EXTENT THAT COULD CAUSE

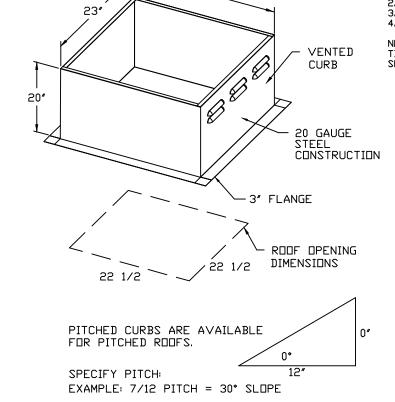

<u>OPTIONS</u> GREASE BOX ECM WIRING PACKAGE-EXHAUST - MANUAL OR 0-10VDC REFERENCE SPEED CONTROL

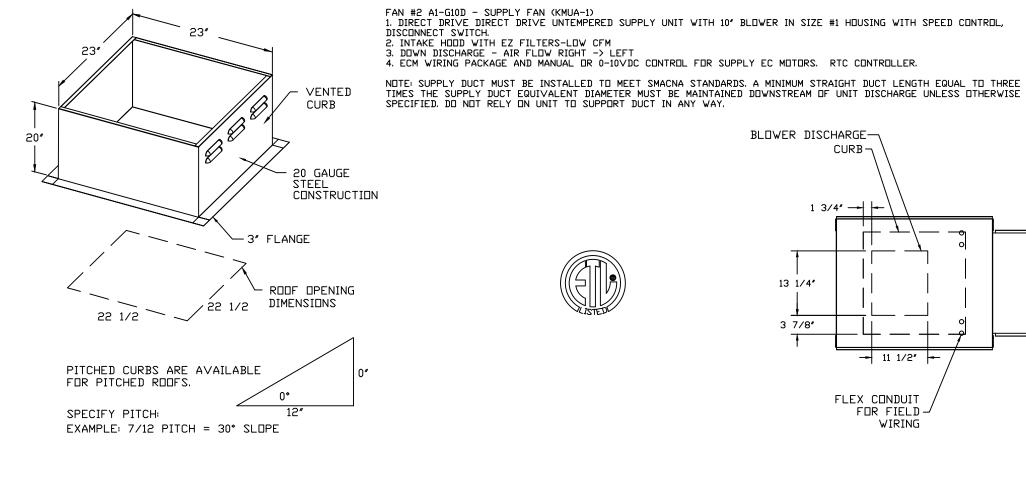

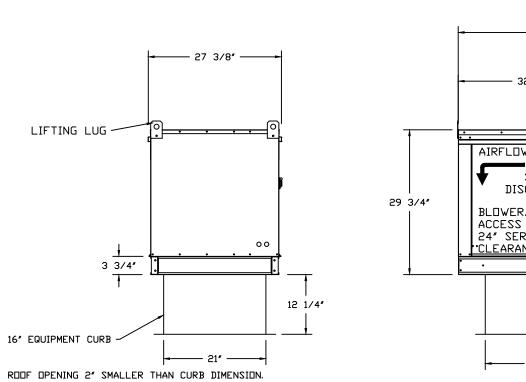

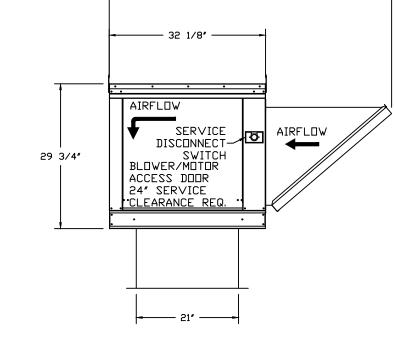

BLOWER DISCHARGE-

13 1/4"

3 7/8"

CURB ¬

1 3/4" --- |--

FLEX CONDUIT

WIRING

PITCHED CURBS ARE AVAILABLE FOR PITCHED ROOFS. SPECIFY PITCH: EXAMPLE: 7/12 PITCH = 30° SLOPE

JOB NO 3402514 TYPE FACTORY DATE FACTORY 5/8/2018 DWG NO ECP #1-2

14 × 18 × 6 Box/

MOTOR POWER CIRCUIT 14 AWG C-1 1 PH OLIOBK LI II 115 V ONIOWH L2 II2 20 A L3 T3 13

FACTORY WIRING SCHEMATIC CIRCUIT BOARDS UNLESS SPECIFIED OTHERWISE, ALL FACTORY AC WIRING 16 AWG. ALL FACTORY DC WIRING 18 AWG. DCV Rev. 2.08.00 HMI Rev. 2.08.00 COMPONENT LIST
LABEL DESCRIPTION
ST-X Starter
Phywries
DL-X Dverload
Phywries
C-X Contactor
Phywries
PS-1 Power Sup. 24VIC
RA-X 120V Relay DPDT
PW-34.110.0184.0 24VDC Light Relay PN:34.110.0188.0 Duct Thermostat PN:A/CP-PD-T4'-EXPL **₩** $AR1 \longrightarrow BK \longrightarrow 7$ RA-1 $8 \longrightarrow WH \longrightarrow N1$ LEGEND

- - FIELD WIRING

FACTURY WIRING
BK- BLACK YW- YELLOW
BL- BLUE GY- GREY
BR- BROWN RR- PURPLE
DR- DR-MAC RD- RED
WH- WHITE GR- GREEN
DR-ML- DR-ML STRIPE
BL/RD- BL/RD STRIPE
RD/GN- RD/GN STRIPE
WH/BL- WH/BL STRIPE DRY CONTACTS (SHOWN DE-ENERGIZED)

14 AWG RA-1-1
ON/OFF
OZZONO WITH FIRE MAKE UP AIR INTERLOCK. JUMPER EDPM03 New Lawrence Gro...


DRAWNO TITLE
SC-111110FP
DESCRIPTION OF OPERATION
120V 1 Phase w/ control
for 1 Exhaust Fan, 1
Supply Fan, Exhaust on in
Fire, Lights out in Fire,
Fan(s) Un/Uff
Thermostatically
Controlled. Room
temperature sensor
shipped loose for field
installation.

REVISIONS DESCRIPTION DATE:

 \mathbb{A}_{M}

re, 75(902 E. CKINSDI

DATE: 5/8/2018 DWG.#: 3402514 **DRAWN** Keyzo-46 SCALE: 3/4" = 1'-0" **MASTER DRAWING**

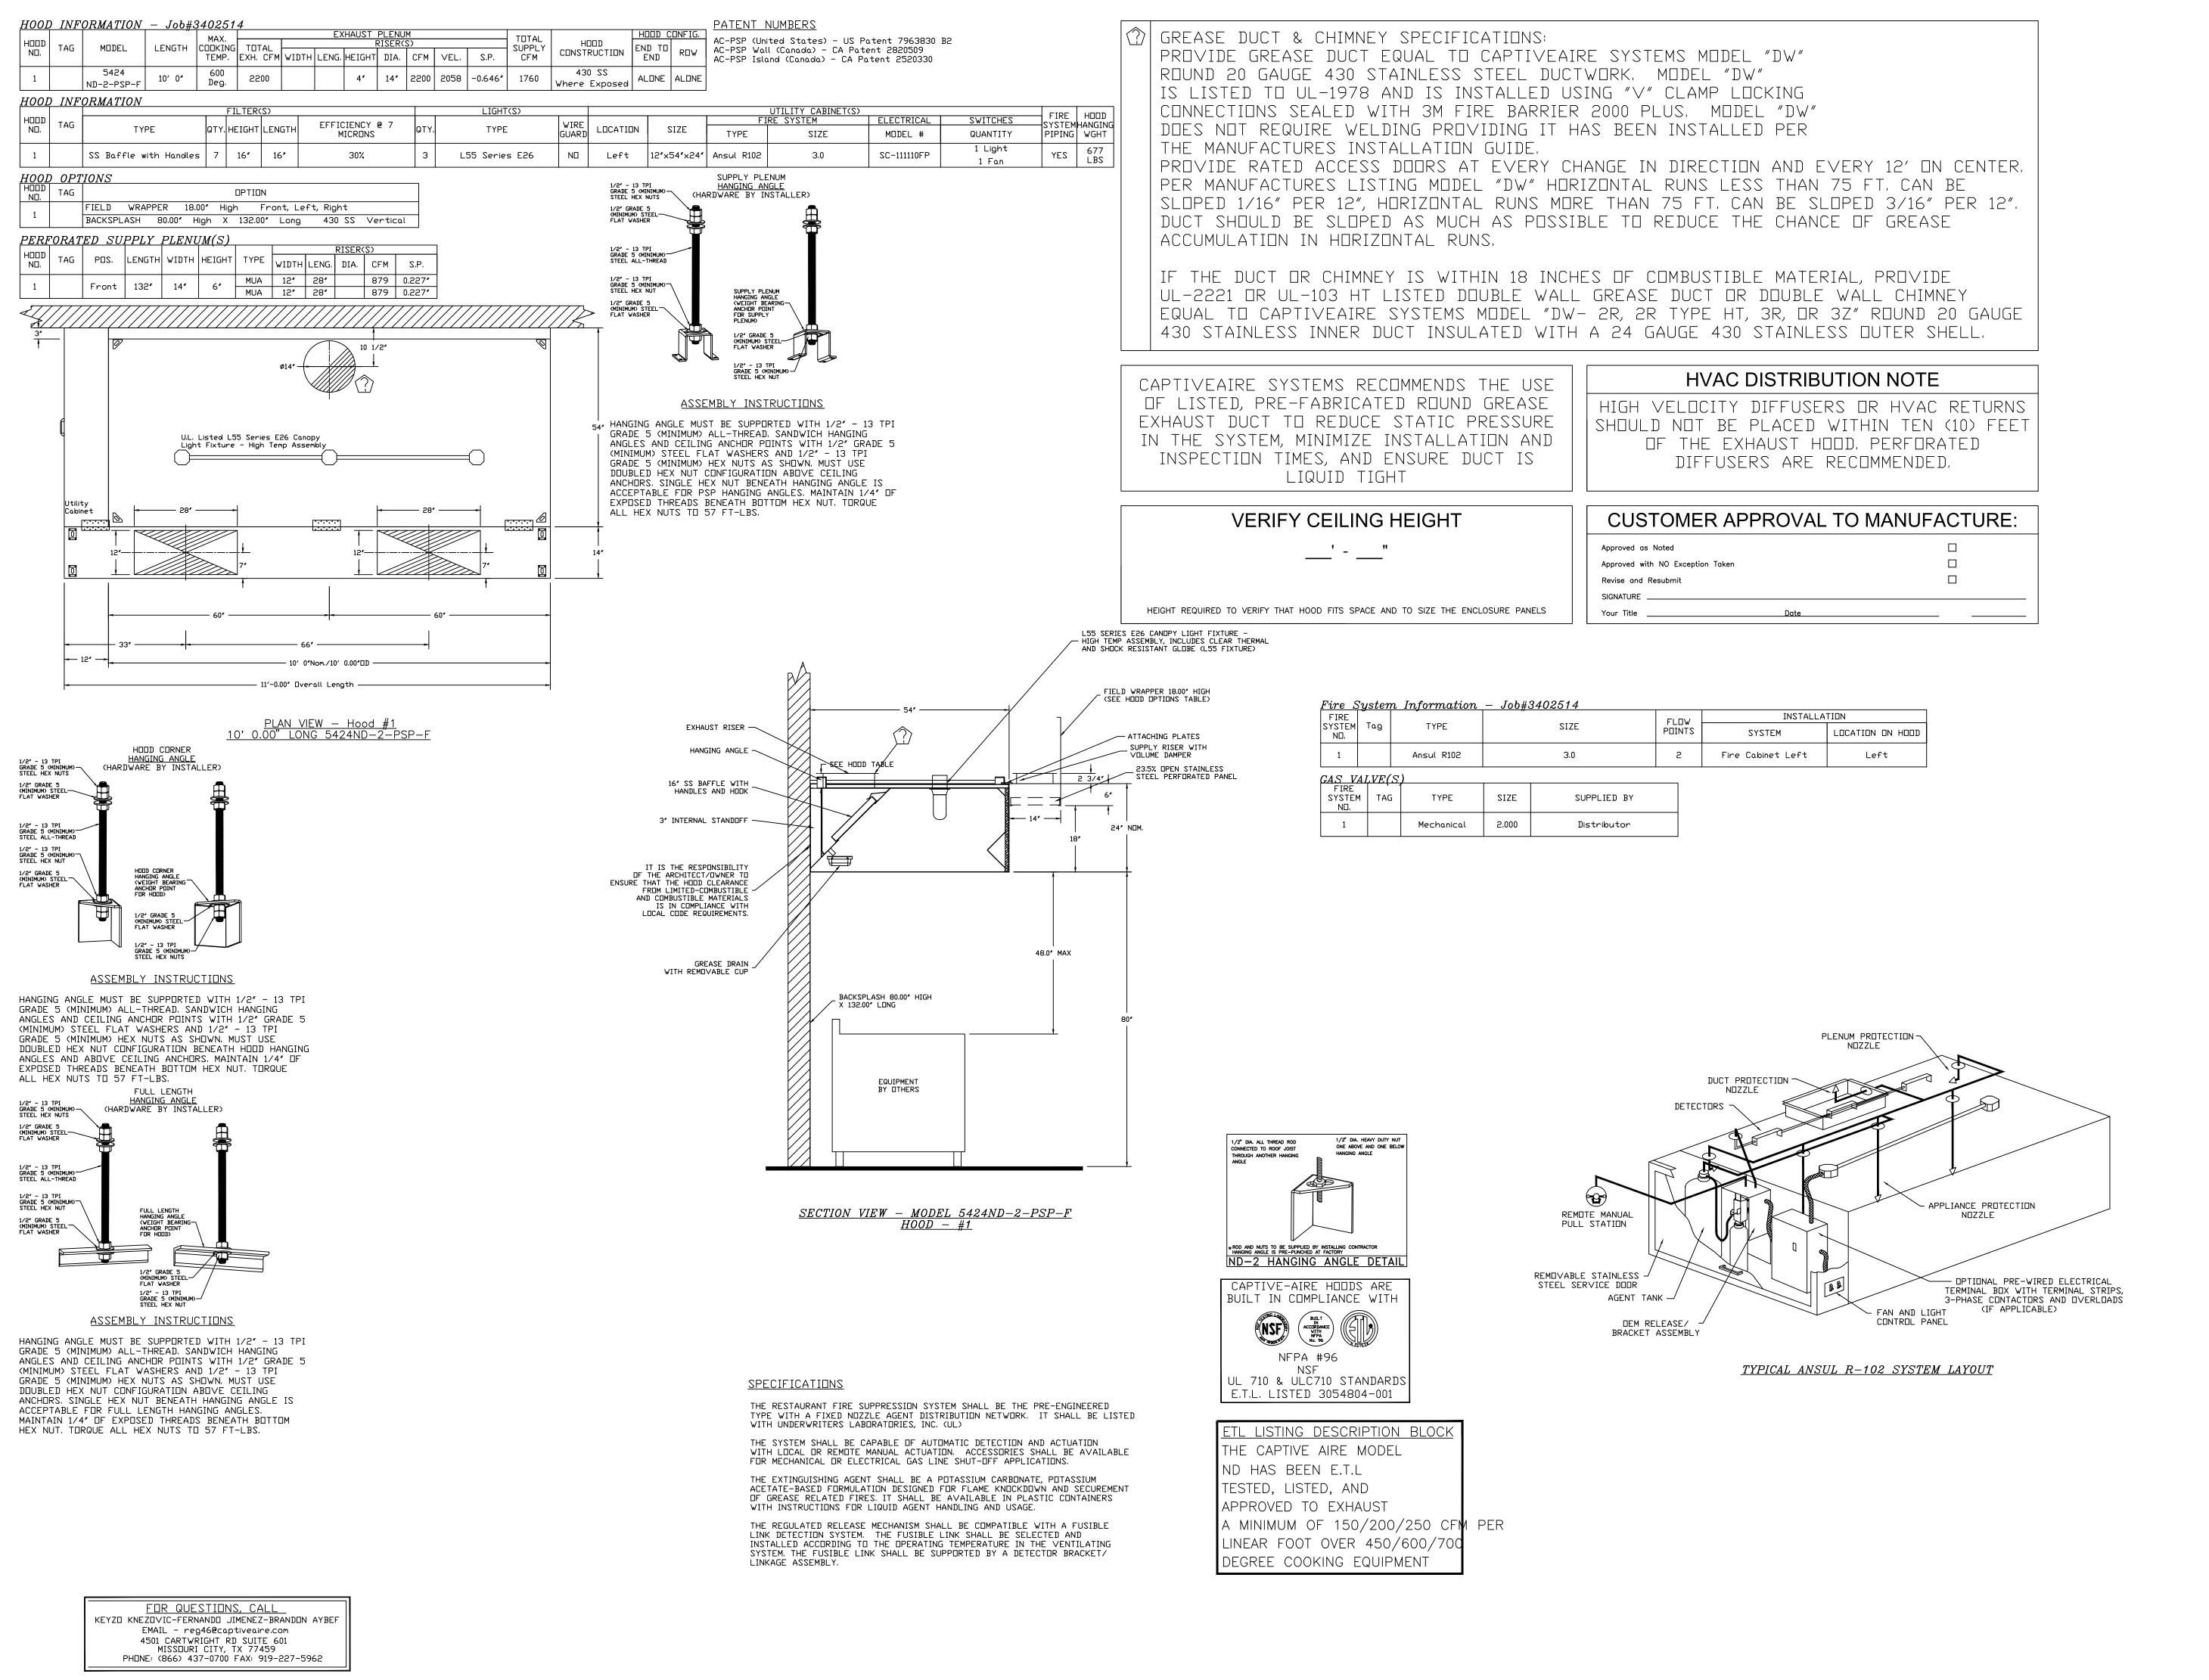

REVISIONS

DESCRIPTION DATE:

A

Office www.captiveaire.com

Houston Office

New Lawrence Groc 902 E. Bayshore, CKINSON, TX, 77539

DATE: 5/8/2018

DWG.#:

3402514

SCALE: 3/4" = 1'-0"

MASTER DRAWING