

Small, Serene, Simply Garnett.

City Commission Meeting

AGENDA

June 14, 2022, 6:00 P.M.

1. Call to Order of the Regularly Scheduled City Commission Meeting (6:00 p.m.)

- A. Pledge of Allegiance
- B. Invocation, Reuben Esh/Sam Stoltzfus, Beacon of Truth

II. Employee of the Month

III. Public Hearing for the Redevelopment/TIF District

- A. Motion to Enter
- B. Introductions/Citizens to be Heard (Five-Minute Limit Per Person)
- C. Adjournment

IV. Citizens to be Heard (Five-Minute Time Limit Per Person)

V. Governing Body Comments

- A. Student Representative Hayden Newton
- B. Commissioner Cole
- C. Commissioner Sheahan
- D. Mayor Gwin

VI. Consent Agenda

- A. Approval of Minutes from May 24, 2022 Regular City Commission Meeting
- B. Approval of Semi-Monthly Bills and Payroll in the amount of \$361,543.14

VII. Regular Business

- Consideration of the TODS Grant Program.
- Consideration of Ordinance 4237 Amending Title 7, Chapter 3, Section 3 (C) and Section 4 of the Municipal Code.

VIII. Discussion Items

- Maple Street Project 98% Plans
- Landbank work meeting
- LibertyFest Gate Schedule
- 34.5KV Reclosure
- Sales Tax Discussion
- Budget Workshop dates

IX. Informational Items

A. "Dead Giveaway" live theatre performances, hosted by The Chamber Players Community Theatre, will be June 10-18.



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- B. Libertyfest Community Fireworks Display, hosted by the City of Garnett, will be Saturday, July 2nd with a tentative rain date of Saturday, July 9th.
- C. Summer Sidewalk Sales, hosted by Morning Mingle, will be July 22-23.
- D. Sprint Track Night Race, hosted by the KC Karting Association, will be held at the Lake Garnett Sprint Track on July 23.
- X. Citizens to be Heard on Landbank (Five-Minute Time Limit Per Person)
- XI. Adjournment



The Governing Body of the City of Garnett met in regular session on May 24, 2022, at 6:00 p.m. with the following individuals present; Greg A. Gwin, Mayor; Jody Cole and Jason Sheahan, City Commissioners; Terry J. Solander, City Attorney; and Travis Wilson, City Manager. Student Representative Hayden Newton and Trish Brewer, City Clerk were absent.

CALL TO ORDER

Mayor Gwin called the meeting to order at 6:00 p.m.

The Pledge of Allegiance was recited, followed by David Shrum, First United Methodist Church giving the invocation.

CITIZENS TO BE HEARD NOT PERTAINING TO LANDBANK

Lori Hicks spoke about her concerns about fireworks being shot off within 1,000 feet of the hospital and the affect it has on the patients and residents of the hospital.

Kenneth Hicks stated fifteen (15) years ago an officer told them they had to stop firing fireworks at the location where Dr. Hale's office currently is and expressed concerns of them being fired after hours.

Melanie Modlin stated she spoke with the Hospital Assistant Administrator about fireworks.

Don Moyer stated he has watched several fireworks shows that have gone on in the past.

Mark Magner spoke about freedom and celebration.

Wesley Keller spoke about the Molon Labe Truth events held on the courthouse lawn.

GOVERNING BODY COMMENTS

Student Representative Hayden Newton was absent.

Commissioner Cole appreciated McClure Engineering's report. She also stated the ACDA Board did not meet this month.

Mayor Pro-Tempore Sheahan – had no comments.

Mayor Gwin – had no comments.

CONSENT AGENDA

• Approval of Minutes from the May 10, 2022, Regular City Commission Meeting. No questions. Commissioner Sheahan made a motion to approve the minutes from the May 10, 2022, Regular City Commission Meeting as written. Commissioner Cole seconded the motion. Motion passed (3 Aye / 0 Nay)

• Approval of Semi-Monthly Bills and Payroll in the amount of \$160,887.00. Mayor Gwin made a motion to approve the Semi-Monthly Bills and Payroll in the amount of \$160,887.00. Commissioner Cole seconded the motion. Motion passed (3 Aye / 0 Nay)

REGULAR BUSINESS

- Consideration of Special Event Request from Melanie Modlin. After discussion, Commissioner Sheahan made a motion to approve the Special Event Request. Commissioner Cole seconded the motion. Motion passed (3 Aye / 0 Nay)
- Consideration of Ordinance 4235 Rezoning in Bronston Heights Addition. After discussion, Commissioner Sheahan made a motion to adopt Ordinance 4235. Commissioner Cole seconded the motion. Motion passed (3 Aye / 0 Nay)
- Consideration of Conditional Use Permit for Parkwood Day School. After discussion, Commissioner Sheahan made a motion to approve the Conditional Use Permit for Parkwood Day School conditional on State licensing. Commissioner Cole seconded the motion. Motion passed (3 Aye / 0 Nay)
- **KMEA Q & A.** Members of KMEA gave a recap of the presentation they gave back in March and answered follow up questions from the City Commissioners.

Commissioner Sheahan made a motion to take a five (5) minute recess. Mayor Gwin seconded the motion. Motion passed (3 Aye / 0 Nay)

Mayor Gwin called the meeting back to order at 7:55 p.m.

CITIZENS TO BE HEARD ON LANDBANK

Harold DeForest spoke about K.S.A. 79-2803 (a) and how it outlines the sale of property.

Mark Powls read the elected official's oath of office. He also spoke on issues of property rights and property taxes.

Wesley Keller spoke about nullification of taxes and explained how it would eliminate the strain on homeowners and business owners. He also stated it will also drive economic growth.

Cheryl Urquhart spoke about the last tax sale and would like to see the process of the tax sale and information on the properties be made clearer and more ironed out. She stated by doing these things, the properties in the tax sale would get bought.

Paula Scott stated she reviewed everything that has been discussed about the landbank since 2019. She gave statistics on Garnett's housing and poverty demographics from the 2020 Census.

REGULAR BUSINESS PART II

• Consideration of Ordinance 4236 Establishing a Landbank. After discussion, Commissioner Cole made a motion to Establish a Landbank. Commissioner Sheahan seconded the motion. Motion passed (2 Aye / 1 Nay)

Minutes – May 24, 2022 Page 3

DISCUSSION ITEMS

City Manager Wilson gave an update on McClure Engineering.

City Manager Wilson gave an update on LibertyFest

City Manager Wilson gave an update on West 5th Property.

INFORMATIONAL ITEMS

- A. Garnett Remembers Patriotic Banners Celebration of Service Cruise Night, Town Square and Courthouse Lawn, hosted by Garnett Tourism will be held on May 26th.
- B. The Avenue of Flags, hosted by Garnett Parks & Recreation, will be May 27-30 at the Garnett Municipal Cemetery.
- C. Memorial Day Service, hosted by the American Legion Post 48/VFW Post 6397 will be held on May 30th at the Garnett Municipal Cemetery.
- D. The 6th Annual Southland Cruisers Car, Bike, & Truck Show, hosted by the Southland Cruisers Car Club, will be held on the Town Square on June 4th.
- E. Hot Wheels and Hot Deals, hosted by Morning Mingle, will be June 4th.
- F. The Kart Road Races, hosted by the Garnett Enduro Kart Club, will held at the Lake Garnett Road Course on June 4-5.
- G. "Dead Giveaway" live theatre performances, hosted by The Chamber Players Community Theatre, will be June 10-18.
- H. Libertyfest Community Fireworks Display, hosted by the City of Garnett, will be Saturday, July 2nd with a tentative rain date of Saturday, July 9th.

ADJOURNMENT

• With no further business before The Governing Body, Mayor Gwin made a motion to adjourn the meeting. Commissioner Sheahan seconded the motion.

Motion passed (3 Aye / 0 Nay)

Meeting adjourned at 9:16 p.m.	
•	Mayor
Attest:	
City Clerk	

Garnett Tourism Advisory Committee Meeting Minutes June 7, 2022

The Garnett Tourism Advisory Committee met on Tuesday, June 7, 2022, in the Commission Room at City Hall. The meeting was called to order at 4:30 p.m. with the following members present: Tom Emerson, Jr., Chairman, Paula Wallace, Vice-Chair, and committee members Krystal Baugher, Michaela Read, and Nicole Stevenson. Also present were Susan Wettstein, Director of Community Development and Tourism and Kris Hix, Administrative Assistant. Committee members Laurel Ladewig and Helen Norman were absent.

Approval of Minutes

A motion was made by Tom Emerson, Jr. and seconded by Nicole Stevenson to approve the minutes of April 5, 2022 as written. The motion passed unanimously (5-0).

Financial Report

The Transient Guest Tax Fund cash balance as of May 31, 2022, is \$75,957.52. This includes the May disbursement from the State of \$3,523.02. Of the \$25,000 budgeted for Local TGT Grant Fund, \$22,850.50 has been granted leaving a balance of \$2,149.50 available. The balance of In-House Marketing as of May 31 is \$6,400 and Programs at \$2,500 as budgeted.

Old Business

Tourist-Oriented Directional Sign (TODS) Program:

Director Susan Wettstein presented the proposed application for the program. Funding for this grant program would be taken from the In-House Marketing line item until such time an increase in the budget for the Programs line item can be considered. The ideal budget for the program would be \$4,000. This is a first-time, one-time only, fifty-percent (50%) up to \$375 per "location structure" grant opportunity. Susan asked committee members for suggestions on changes or additions to be made to the application. A couple of typos were addressed. Susan asked if the Committee was in favor of granting for one (1) sign/location structure or the maximum of three (3) per applicant. The consensus was to allow this grant funding for the applicant to have signage at all three proposed locations (N. Highway 59, N. Highway 169, and S. Highway 169) should they desire with a maximum reimbursement of up to \$375 per highway structure. She asked if an annual grant deadline of October 1 could be established so that reimbursement could perhaps be made in the same year the application is accepted for budget purposes. The consensus was "yes". Upon no further discussion a motion was made by Nicole Stevenson and seconded by Krystal Baugher to recommend this grant program be approved by the City Commission. The motion passed unanimously (5-0).

New Business

Transient Guest Tax Request (Non-Marketing), Hope Anthem Garnett, Faith and Blue Event: Hope Anthem Church of Garnett submitted a TGT request in the amount of \$2336.80, which would include 16 tables, a popcorn machine, four-burner cooking griddle, and bounce house to be utilized at this event. The committee discussed what the Non-Marketing Application is, and how it is used. The committee reviewed the submitted application and began discussions on if this event application qualified under the criteria. Discussion included that the remaining TGT funds available for local grants this year total \$2,149.50, which is less than the amount requested on the application. There is yet one more 2022 New Event Contest winner planning to request TGT funds. It was noted that during the discussion last year with the Commission that the 2022 New Event Contest winners were awarded a minimum of \$1,000 in approved TGT funds. It was difficult to request and use those funds by the end of 2021 and therefore, additional funds could be requested from the Commissioners in 2022, if necessary, by a budget amendment or otherwise. The committee discussed whether the event would bring visitors to town; that the application states "This event should draw many local people and help with community involvement." The committee agreed the tables could be considered beneficial to the event organizers, who also put on the Easter Festival (Egg Hunt) and the Fall Festival (Halloween) events, which draw visitors from around the county for multiple events, including this new Faith and Blue event. Chairman Tom Emerson, Jr. made a motion to table this application so that Director Susan Wettstein can provide direction to Hope Anthem on what information is required for a completed form. The motion was seconded by Nicole Stevenson. The motion passed unanimously (5-0).

Staff Reports

Director Susan Wettstein provided weekly staff reports.

Other

Director Susan Wettstein shared advisory committee information and Chairman Tom Emerson, Jr., Vice-Chair Paula Wallace, and Committee Member Nicole Stevenson terms would expire December 31, 2022. Director Susan Wettstein stated she would also reach out to committee member Laurel Ladewig about her continued involvement.

Adjournment

With no other business to come before the committee, Chairman Tom Emerson, Jr. made a motion to adjourn the meeting. Krystal Baugher seconded the motion. The motion passed unanimously (5-0). The meeting adjourned at 5:20 p.m.

The next meeting will be held on July 5, 2022.

Minutes respectfully submitted by Kris Hix, Administrative Assistant.



Request for Funding through Transient Guest Tax Revenue Tourist Oriented Directional Signage (TODS) Grant Program

Please read the following information thoroughly before completing the application.

Definition of Transient Guest Tax:

A tax collected by lodging establishments from their overnight guests that is remitted to the Kansas Department of Revenue on behalf of the city. Ninety-eight percent (98%) of the tax is returned to the city for use in promoting tourism. The remaining 2% is kept by KDOR to offset the cost of administering the tax. The current transient guest tax rate as set forth by city charter ordinance is: 6%.

Purpose of Funds:

The purpose of transient guest tax funds is to promote tourism and bring visitors to Garnett and Anderson County. This grant program encourages Gas, Food, Lodging, Campground/RV Parks, and Attractions businesses to participate in the Tourist Oriented Directional Sign Program (TODS) on designated sign structures located, or to be located, as vehicles approach the Garnett city limits on U.S. Highway 59 and U.S. Highway 169. The more businesses featured on these signs, the more likely for travelers to stop in Garnett.

This grant program is a reimbursable grant allowing half of the initial signage expenses equaling the first year's participation expense up to and including one (1) sign and (1) directional sign, up to a total of three (3) structure locations, as approved by the Kansas Department of Tourism, Kansas, Kansas Logos and the Kansas Department of Transportation. Transient Guest Tax Funds will reimburse those costs as follows:

- \$240 toward the approximate \$480 annual sign fee;
- \$75 toward the approximate \$150 setup fee;
- \$60 toward the approximate \$120 directional sign fee.

Total reimbursement not to exceed \$375 of the approximate \$750 fees per structure location.

Requirements:

1. Please review the Kansas Tourism Signage Application Kit attached to this application, specifically pages 6-8 and application pages 22-27. Note: Garnett Community Development and Tourism is the designated Destination Management Organization (DMO).

- 2. If doing business as a Gas, Food, Lodging or Campground/RV Park, please contact Kansas Logos, 785.272.1771. If an Attraction, please contact Kansas Tourism Signage Manager, 785.296.4654 for instructions before submitting application.
- 3. Complete the attached application for reimbursement fund through the City of Garnett Tourist Oriented Directional Signage Grant Program and include a copy of the TODS application you plan to submit through Kansas Logos or Kansas Tourism. You may drop off the documents at City Hall or send to Garnett Tourism, 131 W. 5th Avenue, P.O. Box H, Garnett, KS, 66032, or email tourism@garnettks.net. Please note, application for this grant must be made prior to submission of application to state entity to be sure funds for this grant year are still available.
- 4. Grant funding requests will only be considered for first-time applicants, on a first come, first serve basis until funding is no longer available.
- 5. Approval process will go through the Garnett Tourism Committee with funds for this grant coming from the Transient Guest Tax Programs Fund.
- 6. Submit the TODS application through Kansas Logos or if an Attraction, through the Kansas Tourism.
- 7. The grant application period begins January 1 to October 1 annually.

If approved, the following documentation is required:

- 1. A copy of supporting documents (invoice and proof of payment) must be turned into Garnett City Hall for reimbursement and a check for the amount requested will be issued.
 - PLEASE NOTE: Reimbursement is for approved expenses outlined in this application. Please review *Purpose of Funds*.

Timeline: It may take up to 30 days for approval by the Garnett Tourism Committee. The timeline for approval by state entities and project installation 12+ weeks if existing sign structure is in place, and up to 8 months if new sign structure is to be constructed.

Questions? Please contact Garnett Tourism, Garnett City Hall, 785.448.5496, Extension 7.



-Official Use-
Date Received
Tourism Y/N
Report Received

Request Form / Application for Funding through Transient Guest Tax Revenue Tourist Oriented Directional Signage (TODS) Grant Program

Date of Application:	
Name of Business:	
Tax Number or EIN:	
Representative: (Contact Person)	
Address:	
City/State/Zip:	
Contact Person's Business Telephone: E-mail Address: Website and social media addresses:	
Doing Business as: A Gas/Convenience Store Food Establishment Lodging Campground/RV Park Attraction – Please specify:	
Placement Preference: Please indicate the TODS structure you wi U.S. Highway 59 North (On limits, southbound side of hi	the north side of Garnett, outside city
U.S. Highway 59 South (South (South)	uth of roundabout, northbound side of
U.S. Highway 169 North (Or city limits, southbound side You may choose to participate in more tha	• • • • • • • • • • • • • • • • • • • •

Please che	ck this Checklist:
	I have reviewed the Kansas Tourism Signage Application Kit attached.
	I have called to verify I meet the qualifications to participate in the TODS Program. If doing business as a Gas, Food, Lodging or Campground/RV Park, please contact Kansas Logos, 785.272.1771. If an Attraction, please contact Kansas Tourism Signage Manager, 785.296.4654.
	I have completed the City of Garnett Tourist Oriented Directional Signage Grant Application
	I have completed and attached to the City of Garnett's grant application the TODS Application I plan to submit to the State entity (Kansas Logos or Kansas Tourism).
	I understand that this is a reimbursement grant. I must pay all costs associated with my TODS Application and submit proof of invoice and payment to the City of Garnett in order for reimbursement up to \$375 per structure location, maximum of three (3). Once reimbursement documentation is received payment will be processed and mailed within 30 days.
	for making application to this program and for your efforts to bring ur community.
Sincerely,	
The Garnet	t Tourism Committee



Tourism Signage Application Kit







Contents

Application Form	22-27
Contacts	21
Application Process	20
Definition of Terms	16-19
Frequently Asked Questions	15
Other Signage Opportunities	13-14
Attraction Logo Signage	11-12
Supplemental Guide Signs	9-10
Tourist Oriented Directional Signage (TODS) 5-8
Attraction Criteria & Grid	4
What is the Tourism Signage Program?	3

What is the Tourism Signage Program?

The Tourism Signage Program was developed to increase awareness for travelers and residents of tourism operations and attractions. The Tourism Signage Program also ensures that road signage for tourism attractions is consistent with road safety and other road and traffic objectives, and provides effective guidance in directing tourists and visitors to tourism facilities.

This application kit was developed to provide Kansas businesses, attractions, tourist destinations and other specific points of interest with a single source of reference if they desire to have their location identified on a road sign along the state controlled and maintained roadway system to provide the motorist with directional guidance and information about their location.

Why is tourism signing important?

Tourism signs complement standard directional signs to assist safe and efficient travel for visitors seeking particular destinations or areas of interest. These signs help to promote tourism, ensuring that visitors can travel safely to locate and enjoy all that the State of Kansas has to offer. Effective tourism signs can mean the difference between visitors stopping to explore a town or attraction or just driving through. Tourism signs inform road users of tourism attractions and also increase the frequency and quantity of tourist visits.

Tourism signs are not just for promotional purposes—they are used to help visitors who are already aware of the attraction through brochures and advertising and also for those travelers who may not be aware of an attraction. These signs will be used to physically locate the tourism attraction that can provide the tourist with a meaningful experience.

What types of tourism signs are available?

Kansas offers three (3) tourism sign opportunities – Tourist Oriented Directional Signs (TODS), Supplemental Guide Signs, and Attraction Logo Signs. To see which type you may qualify for see page 4.

- Tourist Oriented Directional Signs (TODS) are available along two-lane and four-lane rural roadways with intersections for tourist-oriented attractions, gas, food, lodging and camping services.
- Supplemental Guide Signs are available along four-lane roadways with interchanges or intersections and two-lane roadways with interchanges if designated as a national/international attraction.
- Attraction Logo Signs are available along interchanges on interstates, freeways, expressway interchanges and bypass interchanges.

EXAMPLES OF ELIGIBLE ATTRACTIONS:

Agri-Tourism*
Agribusiness
Farmers Market
Nurseries/Greenhouses

Orchards Winery

Arts/Cultural Gallery

Kansas-Made Art/Craft

Center Museum Theatre

Historical

Historic Areas Historic Building Historic Cemetery Historic District Historic Mansion Historic Memorials Historic Museum Historic Site Outdoor

Boat Landings/Marinas

Campgrounds
Hunting Facilities
Natural Attraction
Natural Resource
Park - National
Park - Municipal

Park - Privately Owned Park - Regional

Recreational Area Retreat Centers/Camps

Retail Tourism
Antique Businesses
Bed and Breakfast (1)

Brewery Distillery

Restaurants (2)

Science/Nature Aquarium Arboretum Botanical Garden

Zoo

Sports/Entertainment
Amphitheater
Amusement Park

Concert Hall Equestrian Center

Fairground Golf Course Race Track Theme Park

Water Oriented Business

- *Must be a registered Agri-Tourism operation through Kansas Tourism.
- (1) Shall be a member of the Kansas Bed & Breakfast Association (KBBA)
- (2) Shall not be a franchise or part of a national chain

NON-ELIGIBLE ATTRACTIONS

The exclusion only relates to qualification under these categories. These facilities may participate if qualifying under another acceptable category.

Business/Commercial

Adult Entertainment

Facilities

Funeral Homes

Industrial Parks or Plants

Media Facilities Movie Theaters Office Parks Radio Stations Television Stations Truck Terminals

Governmental

Local Jails

Local Police/Sheriff Offices

Post Offices

Medical

Drug Rehabilitation Facilities Extended Care Facilities

Fraternal Homes

Hospitals

Humane Facilities

Infirmaries

Mental Facilities Nursing Homes Retirement Homes Treatment Centers Veterans Facilities Miscellaneous Animal Shelters

Cemeteries

Mobile Home Parks

Subdivisions

Veterinary Facilities

Religious

Cathedrals Chapels Churches

Mosques Shrines

Synagogues Temples

Other Religious Sites

TT Rev 3/2022 Page | 4

Attraction Criteria

The type of signage you qualify for will be determined by national, statewide, or local importance. To find out which category your attraction fits in, your attraction must meet the minimum criteria listed below.

A - Local

- At least one-third of the visitors come from beyond 25 miles of the attraction.
- Annual attendance is 2,000 or greater. (If you do not meet this minimum requirement, please state the reason on your application.)

B - State/Regional

- At least one-third of the visitors come from beyond 100 miles of the attraction.
- Annual attendance is 10,000 or greater.

C - National/International

(For this category you must show proof of national/international designation from a legitimate source)

- At least one-third of the visitors come from beyond 200 miles of the attraction.
- Annual attendance is 25,000 or greater and registered as a national park/site/area.

Following is a matrix to help determine which type of tourism sign you could qualify for. Specific signing policies and eligibility criteria required for each type of sign is discussed on the following pages.

	TODS	Supplemental Guide Signs	Attraction Logo Signs
2-Lane Intersections	A, B, C		
4-Lane Intersections	A, B, C	А, В, С	
4-Lane Interchanges		В, С	А, В, С
2-Lane Interchanges		С	А, В, С

^{*}For definitions of terms please see page 18.

Tourist Oriented Directional Signs – TODS



What are Tourist Oriented Directional Signs?

Tourist Oriented Directional Signs (TODS) are official blue guide signs posted at rural intersections on two-lane or four-lane conventional roadways for tourist-oriented attractions, gas, food, lodging and camping services. The business may be located either within or outside of a municipality while the TODS shall be installed at rural intersections on conventional roadways outside of the limits of a municipality.

Gas, food, lodging and camping businesses must complete an application and be approved by Kansas Logos, Inc., to participate in the TODS Program. The eligibility criteria for gas, food, lodging and camping services can be found on the Kansas Logos, Inc. website at www.kansas.interstatelogos.com, along with application information.

Tourist Oriented Attractions must complete an application (Page 22) and be approved by Kansas Tourism to participate in the TODS program.

Upon approval of your attraction or service, all participants are required to contract with Kansas Logos, Inc., a private contractor for the Kansas Department of Transportation (KDOT), and pay an annual fee which includes the installation and maintenance of the TODS.

TODS Criteria for Tourist Oriented Attractions

- Shall have a minimum annual attendance of at least 2,000 visitors. (If you do not meet this minimum requirement, please state the reason on your application.)
- Shall be of significance to tourists and derive a major portion of income or visitors from motorists not residing in the area of the facility during the normal business season.
- Shall be categorized as Agri-Tourism, Arts/Cultural, Historical, Outdoor, Science/Nature, Sports/Entertainment, or Retail Tourism.
- Shall provide sufficient staff to allow for a significant experience for the traveling tourist.
- Shall be in operation during at least an eight (8) consecutive week period each year, a minimum of six (6) hours, five (5) days a week of which one day should be a Saturday or Sunday, excluding holidays.
- Shall be listed on the www.Travelks.com/travel-industry/ website, and are encouraged to participate in other Kansas Tourism Co-Op Opportunities found here: https://www.travelks.com/travel-industry/marketing-and-pr/marketing-opportunities.
- Shall submit an annual attendance report to Kansas Tourism.
- Shall submit a letter of support by the local Destination Management Organization (DMO), i.e. Convention & Visitors Bureau, Chamber of Commerce, or Economic Development Office.
- Shall have the name of the business prominently displayed on the premises in such a manner that it is readily visible to motorists from the public highway on which the facility is located.
- Shall provide modern restroom facilities, drinking water and public access to a telephone for emergency purposes.
- Shall provide for parking on site or have available parking for 10 vehicles or whatever is suitable for the specific attraction within two (2) blocks of the attraction. Bus parking must also be available.
- Shall provide clearly for display any general admission charges at the place of entry to the attraction.

- Shall be licensed and approved by the appropriate state and/or local agencies regulating the particular type of business or activity.
- Shall comply with all applicable laws concerning the provision of public accommodations without regard to age, race, religion, color, sex, national origin, or accessibility by the physically handicapped.
- Shall agree to abide by all rules, regulations, policies, procedures and criteria associated with the program. If it is determined that the attraction no longer meets the criteria established by the Kansas Division of Tourism, the signs will be removed.

TODS Policies

- Tourist Oriented Attraction shall be located within fifteen (15) miles of the nearest two-lane or four-lane conventional roadway intersection as measured from sign placement to the nearest edge of the business' driveway.
- Driveways will not be signed for.
- TODS assemblies may only be installed within public right of way maintained by the KDOT at rural two-lane and four-lane intersections.
- TODS shall have up to four panels for the purpose of displaying the business identification of and directional information for eligible facilities. Each panel shall be rectangular in shape and shall have a white legend and border on a blue background. The message "TOURIST ACTIVITIES" shall be placed above all panels.
- When there are more businesses eligible for signing within the mileage limit than number of spaces permitted on TODS, those businesses nearest the intersection will be given first priority for signing in the order of Tourist Oriented Attractions, Gas, Food, Lodging and Camping.
- The content of the legend on each panel shall be limited to two (2) lines of text for business identification, and directional information for not more than one eligible business, service, or activity facility. The legends shall not include promotional advertising.
- Seasonal businesses may participate in the TODS program, if the opening season is for a minimum consecutive 8 week period. The seasonal month(s) shall be the 2nd line of legend on the TODS business panel.
- Trailblazing signage, if required, would need to be approved by the proper local jurisdiction.
- The location of other traffic control devices shall take precedence over the location of TODS.

TODS Fee Structure

The applicant will be responsible for paying a base annual fee if approved for participation. This fee can be paid by monthly bank draft (ACH) at no additional cost to the business. These fees include installation and maintenance of the TODS panels.

Base Annual TODS and Advance TODS Fee

- \$480.00 per business panel, per direction
- \$240.00 per business panel, per direction for non-profit businesses

Base Annual Trailblazer Fee

- \$120.00 per Trailblazer panel
- \$60.00 per Trailblazer panel for non-profit businesses

Fabrication Fee

• \$150.00 one-time fee, per business panel, for the life of the business panel

Kansas Logos, Inc. and KDOT have established a unified billing date for all businesses and will charge a prorated initial annual fee amount based on the date of installation through June 30 of each year. All businesses are on a July 1 billing cycle.

Supplemental Guide Signs



What are Supplemental Guide Signs?

Supplemental Guide Signs are official brown guide signs available along four-lane roadways with interchanges or intersections and two-lane roadways with interchanges if designated as a national/international attraction.

The signs are for tourism attractions that fit in one of the following categories: Agri-Tourism, Arts/Cultural, Historical, Outdoor, Science/Nature, or Sports/Entertainment. *This does not include retail establishments or other community recreational services, i.e. golf courses, theaters, bowling alleys, shopping centers, etc.*

Criteria for Supplemental Guide Signs

- Shall have a minimum annual attendance of at least 2,000 visitors. (If you do not meet this minimum requirement, please state the reason on your application.)
- Shall be of significance to tourists and derive a major portion of income or visitors from motorists not residing in the area of the facility during the normal business season.
- Shall be open to the general public for at least one year.
- Shall be categorized as Agri-Tourism, Arts/Cultural, Historical, Outdoor, Science/Nature, or Sports/Entertainment.
- Shall provide sufficient staff to allow for a significant experience for the traveling tourist.
- Shall be in operation for a continuous twelve (12) months, a minimum of six (6) hours, five (5) days a week of which one day should be a Saturday or Sunday, excluding certain holidays.
- Shall be listed on the www.TravelKS.com website, and are encouraged to participate in other Kansas Tourism Co-Op Opportunities found here: https://www.travelks.com/travelindustry/marketing-and-pr/marketing-opportunities.
- Shall submit an annual attendance report to Kansas Tourism.
- Shall submit a letter of support by the local Destination Management Organization (DMO),
 i.e. Convention & Visitors Bureau, Chamber of Commerce, or Economic Development
 Office
- Shall have the name of the business prominently displayed on the premises in such a manner that it is readily visible to motorists from the public highway on which the facility is located.
- Shall provide modern restroom facilities, drinking water and public access to a telephone for emergency purposes.
- Shall provide for parking on site or have available parking for 10 vehicles or whatever is suitable for the specific attraction within two (2) blocks of the attraction. Bus parking must also be available.
- Shall provide clearly for display any general admission charges at the place of entry to the attraction.
- Shall be licensed and approved by the appropriate state and/or local agencies regulating the particular type of business or activity.

- Shall comply with all applicable laws concerning the provision of public accommodations
 without regard to age, race, religion, color, sex, national origin, or accessibility by the
 physically handicapped.
- Shall agree to abide by all rules, regulations, policies, procedures and criteria associated with the program. If it is determined that the attraction no longer meets the criteria established by the Kansas Division of Tourism, the signs will be removed.

If you are unable to meet the above criteria, your application may be considered for the Attraction Logo Signs or the TODS signs.

Supplemental Guide Sign Policies

Only one travel attraction supplemental guide sign with two destinations per direction at an interchange is allowed. If the signing at an interchange is already at capacity, then no additional signing will be accepted.

If your attraction qualifies for supplemental guide signs, please refer to page 4 to determine which type of category you fall within. Following are the policies for each category:

Local

- Signed at one point on the state highway system.
- Signs must be within 30 miles of the attraction.
- No more than one set of signs allowed.
- Freeway (including interstates) and expressway interchange signing is not available.
- No highway trailblazing.

State/Regional

- Signed at up to two points on the state highway system.
- Signs must be within 60 miles of the attraction.
- When applicable, trailblazing is permitted from freeway/expressway to conventional highway only.

National/International

- Signed at up to three locations on the state highway system.
- Signs must be within 90 miles of the attraction.
- When applicable, trailblazing is permitted from freeway/expressway to freeway/expressway.
- If registered as a national park/site/area, the national logo may be used on the sign.

Supplemental Guide Sign Fee Structure

Attraction signing will be installed at the expense of KDOT at points on the State Highway System (SHS) only if approved by the district's budget. If there are not sufficient funds in the district of where the signs are being placed then the attraction may either pay for the signs or wait until the next fiscal year to see if funds are available.

Any off-system trail-blazing will be the responsibility of the attraction and local jurisdictions and must be installed before the highway signing is installed. (We do not want to send travelers off of the highway if there is not sufficient signing to find their destination once they leave the highway.)

Attraction Logo Signs



What are the Attraction Logo Signs?

Attraction Logo Signs are an eligible service category of the Logo Sign Program. Logo Signs are located at controlled access interchanges along Kansas' interstates, freeways, expressway interchanges and bypass interchanges.

Attractions must complete an application (page 22) and be approved by Kansas Tourism to participate in the Logo Sign program. After availability of sign space and approval of your attraction to participate has been verified, all participants will

be required to contract with Kansas Logos, Inc., a private contractor for KDOT, and pay an annual fee which includes the installation of your logo sign. Kansas Logos, Inc. will provide design assistance at no cost to the business, and a list of logo fabricators for production of the logo sign panels can be provided. Logo sign specifications may be found at www.kansas.interstatelogos.com.

Criteria for Attraction Logo Signs

- Shall have a minimum annual attendance of at least 2,000 visitors. (If you do not meet this minimum requirement, please state the reason on your application.)
- Shall be of significance to tourists and derive a major portion of income or visitors from motorists not residing in the area of the facility during the normal business season.
- Shall be categorized as Agri-Tourism, Arts/Cultural, Historical, Outdoor, Science/Nature, Sports/Entertainment, or Retail Tourism.
- Shall provide sufficient staff to allow for a significant experience for the traveling tourist.
- Shall be in operation during at least an eight (8) consecutive week period each year, a minimum of six (6) hours, five (5) days a week of which one day should be a Saturday or Sunday, excluding holidays.
- Shall be listed on the www.TravelKS.com website, and are encouraged to participate in other Kansas Tourism Co-Op Opportunities found here: https://www.travelks.com/travel-industry/marketing-and-pr/marketing-opportunities.
- Shall submit an annual attendance report to Kansas Division of Tourism.
- Shall submit a letter of support by the local Destination Management Organization (DMO), i.e. Convention & Visitors Bureau, Chamber of Commerce, or Economic Development Office.
- Shall have the name of the business prominently displayed on the premises in such a manner that it is readily visible to motorists from the public highway on which the facility is located.
- Shall provide modern restroom facilities, drinking water and public access to a telephone for emergency purposes.
- Shall provide for parking on site or have available parking for 10 vehicles or whatever is suitable for the specific attraction within two (2) blocks of the attraction. Bus parking must also be available.
- Shall provide clearly for display any general admission charges at the place of entry to the attraction.
- Shall be licensed and approved by the appropriate state and/or local agencies regulating the particular type of business or activity.

- Shall comply with all applicable laws concerning the provision of public accommodations without regard to age, race, religion, color, sex, national origin, or accessibility by the physically handicapped.
- Shall agree to abide by all rules, regulations, policies, procedures and criteria associated with the program. If it is determined that the attraction no longer meets the criteria established by the Kansas Division of Tourism, the signs will be removed.

Attraction Logo Signage Policies

- Attraction shall be located within fifteen (15) miles of the exit.
- Must have at least two qualified businesses to build a sign.
- Logo signs shall have up to six panels for the purpose of displaying the business identification of and directional information for eligible facilities.
- If limited space is available for displaying logo signs, priority will be given to eligible services in the following order; Gas, Food, Lodging, Camping, Attractions.
- The location of other traffic control devices shall take precedence over the location of logo signs.

Attraction Logo Fee Structure

Upon approval of your attraction, all participants are required to contract with Kansas Logos, Inc., a private contractor for the Kansas Department of Transportation, and pay an annual fee based on the traffic count at your interchange. This fee can be paid by monthly bank draft (ACH) at no additional cost to the business. These fees include installation and maintenance of the logo panels. Logo plate production cost varies based on the number of colors in the logo and the quantity of logo signs ordered.

Kansas Logos, Inc. and KDOT have established a unified billing date for all businesses and will charge a prorated initial annual fee amount based on the date of installation through June 30 of each year. All businesses are on a July 1 billing cycle.

Traffic Count	Mainline Annual Fee Per Direction	Ramp Annual Fee Per Direction	Total Annual Fee Per Direction	Monthly Fee Per Direction	Daily Fee Per Direction
0-19,999	\$900.00	\$100.00	\$1,000.00	\$83.33	\$2.74
20,000- 49,999	\$1,400.00	\$100.00	\$1,500.00	\$125.00	\$4.11
50,000- 99,999	\$1,800.00	\$100.00	\$1,900.00	\$158.33	\$5.21
100,000 and above	\$2,300.00	\$100.00	\$2,400.00	\$200.00	\$6.58

Other Signage Opportunities

State/Federal Highways (inside city limits)

- Along conventional highways (not freeways or expressways) inside the city limits, the city may furnish, install, and maintain their own tourism attraction signage.
 - Any signs installed by the city must be in accordance with the standards and guidelines contained in the MUTCD.
 - o If the highway is maintained by KDOT, the city is required to obtain a permit from the local KDOT area office in order to install the signs. Contact your local district office. A list of these offices can be found here: http://www.ksdot.org/burTrafficEng/KTC/Contacts/KDOTOffices.asp
 - o If the city maintains the highway, then they may install the signs according to the MUTCD and are not required to obtain a permit.
 - Cities can fabricate the signs themselves, purchase them from a private highway sign manufacturer (ask for standard retroreflective highway traffic signs), or purchase them from the Kansas Correctional Industries (KCI). KCI can be reached at (913) 727-3249.

Billboards and Outdoor Advertising

 Certain criteria and regulations must be met for billboards and/or outdoor advertising to be erected. Contact KDOT for more information at (785) 296-3501 or visit http://www.ksdot.org/burrow/beaut/

Historic/Commemorative Trails

 Historic or Commemorative Trails must be enacted by the United States Congress or the Kansas Legislature to be eligible for signage along a road or highway. Contact KDOT for more information at (785) 296-3618.

Kansas Byway

• To be designated as a byway, the road or highway must be scenic, historical, recreational, natural, cultural, or archaeological in character. Contact Kansas Tourism for more information at (785) 296-1847.

Kiosk Signage

• Kiosks must either be a part of a national or state historic trail or auto tour route established by the U.S. Congress or Kansas State Legislature or located at specific historic sites approved by the Kansas State Historical Society (KSHS) to qualify for signage. Contact KDOT for more information at (785) 296-3618.

Logo Signage

 Gas, Food, Lodging, Camping, and Attraction signs along interstates, freeways, expressway interchanges and bypass interchanges. Contact Kansas Logos, Inc., for more information at 1-800-449-4420.

Recreational Lakes, Parks, Reservoirs (City & County)

• Contact KDOT for more information at (785) 296-3618.

Recreational Lakes, Parks, Reservoirs (State and Federal)

 Contact Kansas Tourism for more information at (785) 296-8951.

TT Rev3/2022 Page | 13

Stadiums, Arenas, Convention Centers, and Auditoriums

• Contact KDOT for more information at (785) 296-3618.

Travel Information Centers

• Community-owned travel information centers wanting signage must be approved and meet criteria to become an information center. Contact the Kansas Tourism for more information at (785) 899-6695.

TT Rev3/2022 Page | 14

Frequently Asked Questions

1. Are we eligible for signing?

• All tourism attractions that cater to tourists are eligible to apply for tourism signage. The facility must fill out the application form and meet the criteria set for these signs.

2. When and how can we apply?

• Applications are available from the Kansas Division of Tourism or you may visit the website www.TravelKS.com/industry to download an application.

3. Who pays for the signs?

- If your attraction has been approved as a supplemental guide sign, signing will be installed at the expense of KDOT at points on the State Highway System only if there are sufficient funds available in that district budget.
- If your attraction is approved as a TODS or Attraction Logo Sign, the applicant is responsible for the cost of the fabrication and the annual fee.
- Inside the city limits, the city may furnish, install, and maintain their own tourism signage.

4. Why have I been refused signing, but others have signs at the location I chose?

- Your facility may not have met the criteria for a tourism attraction.
- If the signing at an interchange is already at capacity, then no additional signing will be accepted.

5. What is the estimated time period of erecting a Supplemental Guide sign?

- After it is determined that signs can be installed, signing plans and sign layouts must first be developed. Next, the appropriate signs must be fabricated and delivered to the local KDOT Maintenance Shop. Local KDOT forces will install the signs as soon as their schedule permits.
- KDOT recognizes the importance of tourism signage and will work as hard as they can, but the entire process can take up to one year depending on existing workload and/or sign type.

6. I was denied signage through the Tourism Signage Program. Are there any other types of signs that I would qualify for?

- You may qualify for billboard and outdoor advertising. Contact KDOT at (785) 296-3501.
- You may qualify for signage located within city limits. Contact your local city offices for more information.

7. How will the signs be maintained?

- Maintenance for supplemental guide signs will be performed by KDOT.
- Maintenance of the TODS & Attraction Logo structures and panels will be performed by Kansas Logos or its subcontractors.

8. Can Gas, Food, Lodging and Camping establishments participate in the TODS Program?

Yes, but Tourist-Oriented Attractions will be given first priority. For criteria for gas, food, lodging, and camping please visit www.kansas.interstatelogos.com.

9. Can seasonal businesses participate in the TODS program?

 Yes, the month(s) of operation shall be included on the TODS business panel. No specific dates will be allowed. Business must be open a minimum of 8 consecutive weeks per year.

Definition of Terms

For the purpose of this policy, the following terms are defined:

<u>Agri-Tourism Attraction</u> The crossroads of tourism and agriculture: when the public visits working farms, ranches or wineries to buy products, enjoy entertainment, participate in activities, shop in a country store, eat a meal or make overnight stays.

ADA Refers to American with Disabilities Act.

<u>Amphitheaters</u> An arena having tiered seating for spectators that is used for a variety of events, public or private.

Amusement Park A commercially operated park enterprise, which supplies refreshments and various forms and devices of entertainment.

Antique Business An establishment where a majority of the items for sale could be considered being in the style or fashion of former times.

Aguarium An establishment where aquatic collections of living organisms are kept and displayed.

<u>Arboretums</u> Facilities used for the cultivation of a variety of woody plants for scientific, educational or ornamental purposes.

Arenas An enclosed area used for the presentation of sports events, among other things.

Art/Craft Centers An exhibit, display, or retail facility for Kansas fine arts or handcrafted products that is open to the public.

Arts/Cultural Attraction Must have significance in portraying Kansas' culture and heritage at the state and national level, i.e. drama, theater, galleries, museums.

Attractions The major portion of whose income or visitors are derived from motorists not residing in the immediate area of the activity and which do not require reservations. An attraction must be of cultural, historic, natural/environmental, recreational, or educational significance to tourists.

<u>Auditoriums</u> A large building or room set aside to accommodate an audience for the presentation of meetings or performances.

Bed and Breakfast Any establishment having no more than fifteen bedrooms; offering to the public, for compensation, transitory lodging or sleeping accommodations; and offering at least one cooked meal per day, which may but need not be breakfast, to each person to whom overnight lodging is provided. The facility shall be a member of the Kansas Bed & Breakfast Association and shall clearly describe itself as a "Bed and Breakfast" in all marketing materials.

Brewery A plant that produces malt liquors and offers tours of the production process.

Cemeteries Signs are allowed for National Cemeteries only.

<u>Civic Centers</u> A center used by members of the locality for social, cultural, or community activities.

Coliseums A large arena with seating for spectators that is used for the presentation of sports events or other entertainment.

Concert Halls A large arena with seating for spectators that is used for the presentation of musical events.

Conventional Highway Any State or US highway other than a freeway or expressway.

<u>Cultural Center</u> A center for performing arts, exhibits, concerts, etc., and which has an occupancy capacity of at least 250 people.

<u>Distillery</u> An establishment that distills alcoholic beverages and offers tours of the production facilities.

DMO Refers to Destination Management Organization. The principal organization of the given city, community or region that is organized to represent a specific destination for the purpose of travel and tourism development and is defined and authorized by its incorporated local government entity as the representative organization exercising this function.

Equestrian Center A facility, marketing itself as an "equestrian center", dedicated to the public education and recreational enjoyment of horses through a variety of features such as riding lessons, training facilities and clinics.

Expressway A divided highway for through traffic with partial access control, which includes both interchanges and intersections.

Facility Tour Location A facility such as a factory, institution or a plant which conducts tours at least four times daily on a regularly scheduled year-round basis.

Fairgrounds A commercially-operated tract of land where fairs or exhibitions are held, and which has permanent buildings included but not limited to livestock exhibition pens, exhibition halls, bandstands, etc.

<u>Farmers' Markets</u> Shall be operated under contractual arrangements with the Department of Agriculture and Consumer Services by local government, local cooperatives, or private individuals.

<u>Freeway/Interstate</u> A divided highway to which the only means of ingress and egress is by interchange ramps.

Galleries A permanent building or hall in which artistic works, such as paintings, poetry, or statues, are displayed for show.

Gambling Facilities An establishment on which lawful gambling is authorized, licensed, and regulated by the State of Kansas.

General Motorist Service Signs A blue and white sign providing motorists with directional information and/or identification of motorist services located along or near state highways.

Golf Course An establishment offering rounds of golf on an area of land laid out for exclusively for golf, with a series of nine (9) or eighteen (18) holes, each including tee, fairway, and putting greens.

Historical Building & Sites Shall be listed on the National Register of Historic Places and/or played a significant historic role in Kansas, the nation or world and be open to the public. *NOTE: If supplemental guide signs are installed for a historic district, separate signs for individual historic sites within the historic district shall not be allowed.*

Historic Districts Shall be listed on the National Register of Historic Places and/or played a significant historic role in Kansas, the nation or world; at least one facility, establishment or business located within the district shall be open to the public for business at least 6 hours a day, 5 days a week in order to provide personal assistance and visitor information to the traveler; the historic significance of the district must be interpreted for the traveler - this may include a self-guided brochure, interpretive signage/kiosks, audio recordings or guided tours, etc.; the area must have a local DMO. *NOTE:* If supplemental guide signs are installed for a specific historic site or sites within a historic district, separate signs for the historic district shall not be allowed.

Interchange A junction of two or more highways by a system of grade separated levels that permit traffic to pass from one to another without the crossing of traffic streams.

Intersection Two or more highways that intersect at the same grade level requiring the establishment of right-of-way via stop signs, yield signs, or traffic signals.

KCI Refers to Kansas Correctional Industries.

KDOT Refers to the Kansas Department of Transportation.

KDT Refers to the Kansas Division of Tourism within the Department of Commerce, Tourism Division.

KLI Refers to the Kansas Logos, Inc.

<u>Leaend</u> The exact text on a sign.

Supplemental Guide Sign Official brown guide signs approaching interchanges on freeways and expressways, and intersections on expressways and two-lane conventional highways.

MUTCD Refers to the Manual on Uniform Traffic Control Devices.

Municipal Parks Parks that are open to the public and maintained by the local government.

<u>Museum</u> An organization and permanent nonprofit institution, essentially educational or aesthetic in purpose, with professional staff, which owns and utilizes tangible objects, cares for them and exhibits them to the public on some regular schedule. Museums shall be members of or accredited by the Kansas State Historical Society and/or Kansas Museums Association.

National Parks Parks that are maintained by the United States Park Service.

Natural Attraction A naturally occurring anomaly, such as a cavern or rock structure, among others, that is maintained and marketed as a natural attraction.

Nursery/Greenhouse An establishment that grows, or offers for sale, plants, trees, or associated items.

<u>Outdoor Attraction</u> An area of outstanding interest to the general public, i.e., state or national parks, lakes, rivers.

Pavilions An ornamental roofed facility used for sporting events or other amusements.

<u>Privately-Owned Research/Experimental Facilities</u> Shall have a staffed visitor center open to the public at least six (6) hours a day, five (5) days a week.

Race Tracks An indoor or outdoor arena with seating for spectators that is used primarily for the presentation of racing events.

Regional Parks A park that is open to the public and maintained by a local or state government or private entity, that serves a general geographic region.

<u>Science/Nature Attraction</u> An area of outstanding interest to the general public, i.e., children's museums, zoos, botanical gardens, grasslands, wildlife refuges.

Scenic Site A natural or man-made picturesque view of outstanding interest to the general public.

SHS Refers to the State Highway System.

Sports/Entertainment Attraction A recreational and entertainment complex that supplies refreshments and multiple activities of entertainment and recreation, i.e., sports, speedways, amusement parks, casinos, rodeos, dog tracks.

Stadiums An enclosed area used for the presentation of sporting events, among other things.

State Parks A park that is open to the public and maintained primarily by a state government agency.

Spur Routes A short highway route that connects a city to a main highway route but does not continue into or through the city.

Theme Parks A commercially operated enterprise offering rides, games, or other forms of entertainment.

Travel Information Centers Shall be approved by Kansas Tourism and written approval shall be provided to KDOT prior to the installation of signs.

Tourism Attraction Signage Official signing that is located within the right-of-way of a state or federal highway that gives specific directional information regarding activities or sites of significant interest to the traveling public.

TODS Refers to Tourist Oriented Directional Signs. Official signing which is located within the right-of-way of a state or federal highway, and which gives specific directional information regarding activities or sites of significant interest to the traveling public.

<u>Trailblazing</u> Informational signs designed to provide the traveling public with route guidance in following a trail to a particular tourism attraction after leaving a major highway or road.

<u>Water Oriented Business</u> Shall include canoe liveries, raft liveries, marinas, water parks, wave pools and other similar businesses providing access to or facilities for waterborne recreational activities.

Winery A licensed business making wine, offers tours to the public on a regular basis and provides an educational format informing visitors about wine and wine processing.

Zoological/Botanical Facility A collection of unique living animals or plants kept for exhibit to the public. Zoos shall be members of or accredited by the American Zoo and Aquarium Association or other similar organizations.

Application Process

- 1. For Supplemental Guide Signs, Tourist Oriented Attraction TODS, and Attraction Logo Signs: Contact Kansas Tourism, to obtain an application. You may also visit the website www.TravelKS.com/industry to download an application.
- 2. Return the completed application to the Kansas Tourism (KT). KT will review the application and a site visit will be completed. If the application is approved for eligibility, KT will forward the eligibility approval to KDOT or Kansas Logos, Inc (KLI) to review the proposed signing locations and feasibility will be determined. Our intent is to complete the eligibility process within 90 days of receiving the completed application.
- 3. After it is determined that signs can be installed, the applicant will be contacted with an approval letter. KDOT/KLI will then contact the applicant so signing plans and sign layouts can be developed and fabricated. Local KDOT forces or KLI or its subcontractors will install the signs as soon as their schedule permits.
- 4. KT, KDOT, and KLI recognize the importance of tourism signage and will work as hard as they can, but the entire process can take up to one year depending on existing workload and/or sign type.
- 5. If the application is denied, the tourism attraction will be contacted with an explanation of why the application was denied. Kansas Tourism may reject any application that is incomplete or does not comply with the tourism attraction signage criteria and/or policies. It is possible for an attraction to receive approval for eligibility from the Kansas Tourism, but not to receive signing based on existing signing conditions.
- 6. For Gas, Food, Lodging and Camping TODS: Contact Kansas Logos, Inc. to obtain an application. You may also visit the website www.kansas.interstatelogos.com.

Contacts

Kansas Tourism

Lisa Hecker Byways & Signage Manager 1000 SW Jackson St, Ste 100 Topeka, KS 66612 Phone: (785) 296-4654 lisa.hecker@ks.gov www.TravelKS.com

Kansas Department of Transportation

Bureau of Transportation Safety & Technology Brian Gower – Chief of Transportation Safety and Technology 700 S.W. Harrison, 6th Floor Topeka, KS 66603-3754 Phone: (785) 296-7431

Fax: (785) 296-3619 brian.gower@ks.gov www.ksdot.org

Kansas Logos, Inc.

Tana Mock – General Manager 2231 Wanamaker Rd., Suite 200 Topeka, KS 66614

Phone: (785)272-1771 Toll: (800)449-4420 Fax: (785)272-0188

tmock@interstatelogos.com www.kansas.interstatelogos.com

Kansas Tourism

1000 SW Jackson St, Ste 100 TOPEKA, KS 66612 Tel: (785) 296-2009

Fax: (785) 296-6988

TOURISM ATTRACTION SIGNAGE APPLICATION

ATTRACTION:			
CONTACT NAME:			
TITLE:			
MAILING ADDRESS:			
CITY, STATE, ZIP:			
LOCATION ADDRESS:			
TELEPHONE:			
FAX:			
EMAIL:			
WEBSITE:			
ATTRACTION INFO	RMATION		
Select one or more cat	egories appropriate f	or the attraction:	
Agri-Tou Arts/Cult Historica Outdoor Science/N Sports/Er Retail To Other	cural ature tertainment		

1.

	What is your primary source of business? If you have more than one, please list significance in order by percentages.
	Please describe what a visitor will experience at your attraction (attach page if needed):
- - - -	
\	When was the opening date for your attraction?
\	What months of the year is the attraction open to the public?
	What are the hours of operation?
_	VISITATION & MARKETING
С	Daily average attendance:
Ν	Number of visitors per year:
	Of that figure, please list the total number of:
	International Visitors: Out-of-State Visitors: Out-of-County Visitors: Community/County Visitors:
I	How do you obtain your visitation numbers?
-	

List all other major attractions within a 30-mile radius. Please include the city, the proximity, and the location from your attraction. (Add page if needed.)
List the tourism organizations, alliances, groups, etc. that your attraction is involved with or a member of:
What are your regional/state cooperating efforts?
Is the attraction listed in the Kansas Travel Guide?
Is the attraction listed on the TravelKS.com website? YES NO If no, please describe why:
Is your promotional literature distributed at the Kansas Travel Information Centers? YES NO If no, please describe why:
Attach a copy of your overall marketing plan that has been developed/outlined for promoting the attraction. Enclose brochures, pictures, tour information, and other promotional information.

	ACCESSIBILITY & CAPACITY
1.	Number of parking spaces for visitors:
2.	Please check where parking is available: On-site or adjacent to attraction Within one walking block Within two walking blocks More than two walking blocks
3.	Is motorcoach parking available? YES NO If no, please describe why:
4.	Are public modern restrooms available? YES NO If no, please describe why:
5.	Are public telephones available? YES NO If no, please describe why:
6.	Is there a gift shop available? ☐ YES ☐ NO
7.	Is there food/beverage service available? ☐ YES ☐ NO
8.	Please list the attraction's location, in miles, from state highways and interstates/freeways (Please attach a map with the facility location):
	MISCELLANEOUS INFORMATION
1.	Please check if the attraction is: Not-For-Profit State-Owned For-Profit

2.	Is there an admission fee and is it clearly on display upon entry?
3.	What hours are your attraction staffed?
	If it is not staffed, please explain why:
4.	Do you have interpretive information available at your attraction?
5.	Does the attraction meet ADA requirements?
i.	Have you attached a letter of support from your local DMO? ☐ YES ☐ NO If no, please describe why:
	PLACEMENT
L.	Are there currently any tourism attraction signs in place for this facility?
2.	Are trailblazing signs currently in place that direct the tourist to your attraction once off the main highway?

3.	Is the name of your business prominently displayed on the premises in such a manner that it is readily visible to motorists from the public highway on which the facility is located?
4.	Please list and attach a map or sketch with your desired sign locations:
5.	How do you prefer your attraction to be listed on the sign?
correct docum	best of my knowledge and belief, the information in this application is true and and the governing body of the Applicant Organization has duly authorized this ent.
Title:	Date:

Return Completed Application To:

Lisa Hecker Kansas Tourism 1000 SW Jackson St, Ste 100 Topeka, KS 66612 lisa.hecker@ks.gov

ORDINANCE	NO.	

AN ORDINANCE AMENDING TITLE 7, CHAPTER 3, SECTION 3 (C) AND SECTION 4 OF THE MUNICIPAL CODE, REGULATING THE EXPLODING AND FIRING OF FIREWORKS; REPEALING EXISTING TITLE, CHAPTER AND SECTIONS.

BE IT ORDAINED BY THE GOVERNING BODY OF THE CITY OF GARNETT, KANSAS:

SECTION 1: Title 7, Chapter 3, Section 3(C) of the Municipal Code of Garnett, Kansas, is hereby amended to read as follows:

7-3-3: EXPLODING; FIRING ON DESIGNATED DAYS AND AT DESIGNATED TIMES: It shall be unlawful and any person or persons to use, fire off, explode or cause to be exploded within the city:

* * *

- (C) Any fireworks or explosives described in section 7-3-1 of this chapter within the north city park on the date, including the "rain date" if applicable, scheduled for the community fireworks display in commemoration of the Independence Day holiday, said display commonly called "Liberty Fest", between the hours of six o'clock (6:00) P.M. and eleven o'clock (11:00) P.M. of said day.
- SECTION 2: Title 7, Chapter 3, Section 4 of the Municipal Code of Garnett, Kansas, is hereby amended to read as follows:
 - EXPLODING, FIRING; LOCATION RESTRICTIONS: It shall be unlawful for any person or persons to use, fire off, explode, or cause to be exploded in the city, any of the fireworks or explosives described in section 7-3-1 of this chapter at any time: (1) at, toward, or under any car or motor vehicle, whether the same is moving or standing still; (2) from any car or motor vehicle, whether moving or standing still; or (3) within one hundred (100) feet of any gasoline pump, gasoline filling station, gasoline bulk station, or any building or area in which gasoline or volatile liquids are sold in quantities in excess of one gallon, except in stores where cleaners, paints, oils, and other volatile materials are handled in sealed containers only; provided, however, the shaking, mixing or adding colorant to paint which is essentially free from volatile substances, often commonly called water-based paint or finish, is likewise excepted.

Ord	linanc	e: P	age 2
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City Clerk

SECTION 3: Title 7, Char the same presently exist, are	pter 3, Section 3A and Section 4, as hereby repealed.
	ce shall take effect and be in force d publication in an official news- Kansas.
PASSED this day of	June, 2022.
ATTEST:	Mayor

STATE OF KANSAS

DEPARTMENT OF TRANSPORTATION

PLAN OF PROPOSED MAPLE STREET (US-59 HWY) ROAD

IMPROVEMENTS FEDERAL AID PROJECT ANDERSON COUNTY CITY OF GARNETT, KANSAS

E PARK RD NE 1800 RD

KDOT PROJECT NO. 59-2 KA-5422-01 AID PROJECT NO. ACNHP-A542(201)

STATE

KANSAS

PROJECT NO.

59-2 KA-5422-01

YEAR | SHEET NO.

2022

GRADING SURFACING (CONCRETE & ASPHALT) SEEDING SIGNING AND PAVEMENT MARKING

NOT TO SCALE

BG CONSULTANTS, INC. (DOT - LOCAL PROJECTS

DESIGN DESIGNATION

INDEX OF SHEETS

SUBGRADING DETAIL SHEET

INLET AND MANHOLE DETAILS

4-7. PLAN AND PROFILE SHEETS

INTERSECTION DETAILS

STORM SEWER PROFILES

PROJECT SURFACING

FOUNDATION TREATMENT, COMPACTION &

MISCELLANEOUS STORM SEWER DETAILS

TEMPORARY EROSION AND POLLUTION CONTROL

SCHEDULE OF INLETS AND MANHOLES

SUMMARY OF QUANTITIES SHEET

1. TITLE SHEET

2. TYPICAL SECTIONS

10-14. PAVEMENT DETAILS

37-41. PAVEMENT MARKING 42-52. PERMANENT SIGNING TRAFFIC CONTROL

64.-69. CROSS SECTIONS

AADT (2022)	7,600
AADT (2042)	8,900
DHV	10%
D	60/40
T	8.8%
V	35 mph
C of A	None
Clear Zone	16 ft.

COUNTY LINE

CITY LIMITS.

PROPERTY LINE

HIGHWAY FENCE

EXISTING FENCE

CONSTRUCTION LIMITS.

RIGHT OF WAY LINE


TRAVELED WAY.

RAILROADS.

GUARDRAIL

STATE OR NATIONAL LINE

TOWNSHIP, SECTION or GRANT LINE

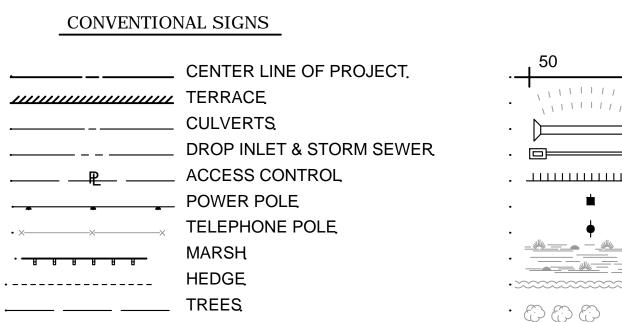



STA. 179+18.00 MAPLE STREET BEGIN

W 11TH AVE

NW 1700 RD

PROJ. NO. 59-2 KA-5422-01

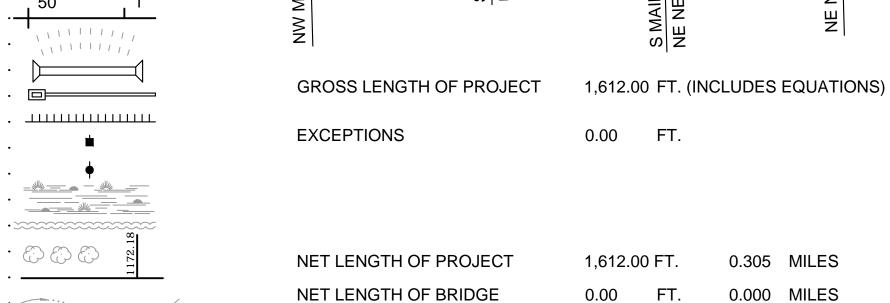

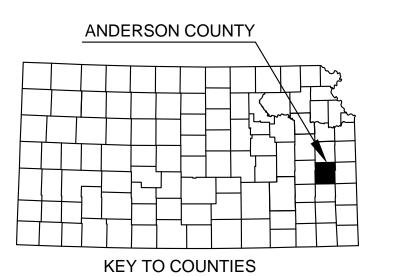

BG CONSULTANTS RECOM. FOR APPROVAL-DATE

LOCAL PUBLIC OFFICIAL

NOTE: TRAFFIC SHALL BE CARRIED THRU STAGED CONSTRUCTION. SEE SH. NO. 53 FOR CONSTRUCTION SEQUENCE DETAILS. **Approved** State Transportation Engineer Chief, Bureau of Road Design KANSAS DEPARTMENT OF TRANSPORTATION

Ne 1850 Rd STA. 195+30.00 MAPLE STREET END PROJ. NO. 59-2 KA-5422-01 K-31 HWY W PARK RD W 4TH AVE

Ne 1750 R E 4TH AVE NW 1750 RD Municipal Airport

₩ Easy Ave W 9Th Ave W 97 h Ave NE 1700 RD CITY OF **GARNETT** POPULATION:

3,264 32

> PROJECT IS LOCATED IN SECTION 25, T20S, R19E & **SECTION 30, T20S, R20E**

> > PLANS PREPARED BY: (BG #19-1514L)

PROFILE ELEVATION STREAM or CREEK

NET LENGTH OF ROAD

1,612.00 FT.

0.305 MILES

★★ OVERBREAKAGE IN LIMESTONE OR SANDSTONE ROCK SHALL BE BROUGHT TO WITHIN 8" OF THE SUBGRADE LINE WITH CRUSHED STONE, SHOT ROCK, AND/OR ROCK RUBBLE, PROPERLY COMPACTED, AND THEN BROUGHT TO THE SUBGRADE LINE WITH CRUSHED STONE MEETING THE REQUIREMENTS FOR "CRUSHED STONE FOR BACKFILL" IN ACCORDANCE WITH THE KDOT STANDARD SPECIFICATIONS. LAYERS OF EARTH OR SHALE WILL NOT BE PERMITTED FOR BACKFILL UP TO THE

BOTTOM OF THE CRUSHED STONE. OVERBREAKAGE IN SHALE OR IN ROCK WHERE

SHALE IS EXPOSED SHALL BE BACKFILLED WITH LOW PERMEABILITY SOILS AS LISTED ON THIS SHEET. ALL MATERIALS, EQUIPMENT, LABOR, AND INCIDENTALS NECESSARY FOR THIS WORK SHALL NOT BE PAID FOR DIRECTLY, BUT SHALL BE

STATE PROJECT NO. YEAR SHEET NO. TOTAL SHEETS


KANSAS 59-2 KA-5422-01 2022 2 69


BG CONSULTANTS
ENGINEERS - ARCHITECTS - SURVEYORS

- ♦ FOR PAVEMENT WIDTH AND TAPER LOCATIONS, SEE PLAN SHEETS.
- Ø FOR WIDTHS AND SLOPES, SEE CROSS SECTIONS.

SUBSIDIARY TO OTHER ITEMS OF THE CONTRACT.

₩₩ IN CUT AREAS, COMPACTION OF THIS LAYER SHALL BE CONSIDERED SIMILAR TO FOUNDATION TREATMENT AND SHALL BE SUBSIDIARY.

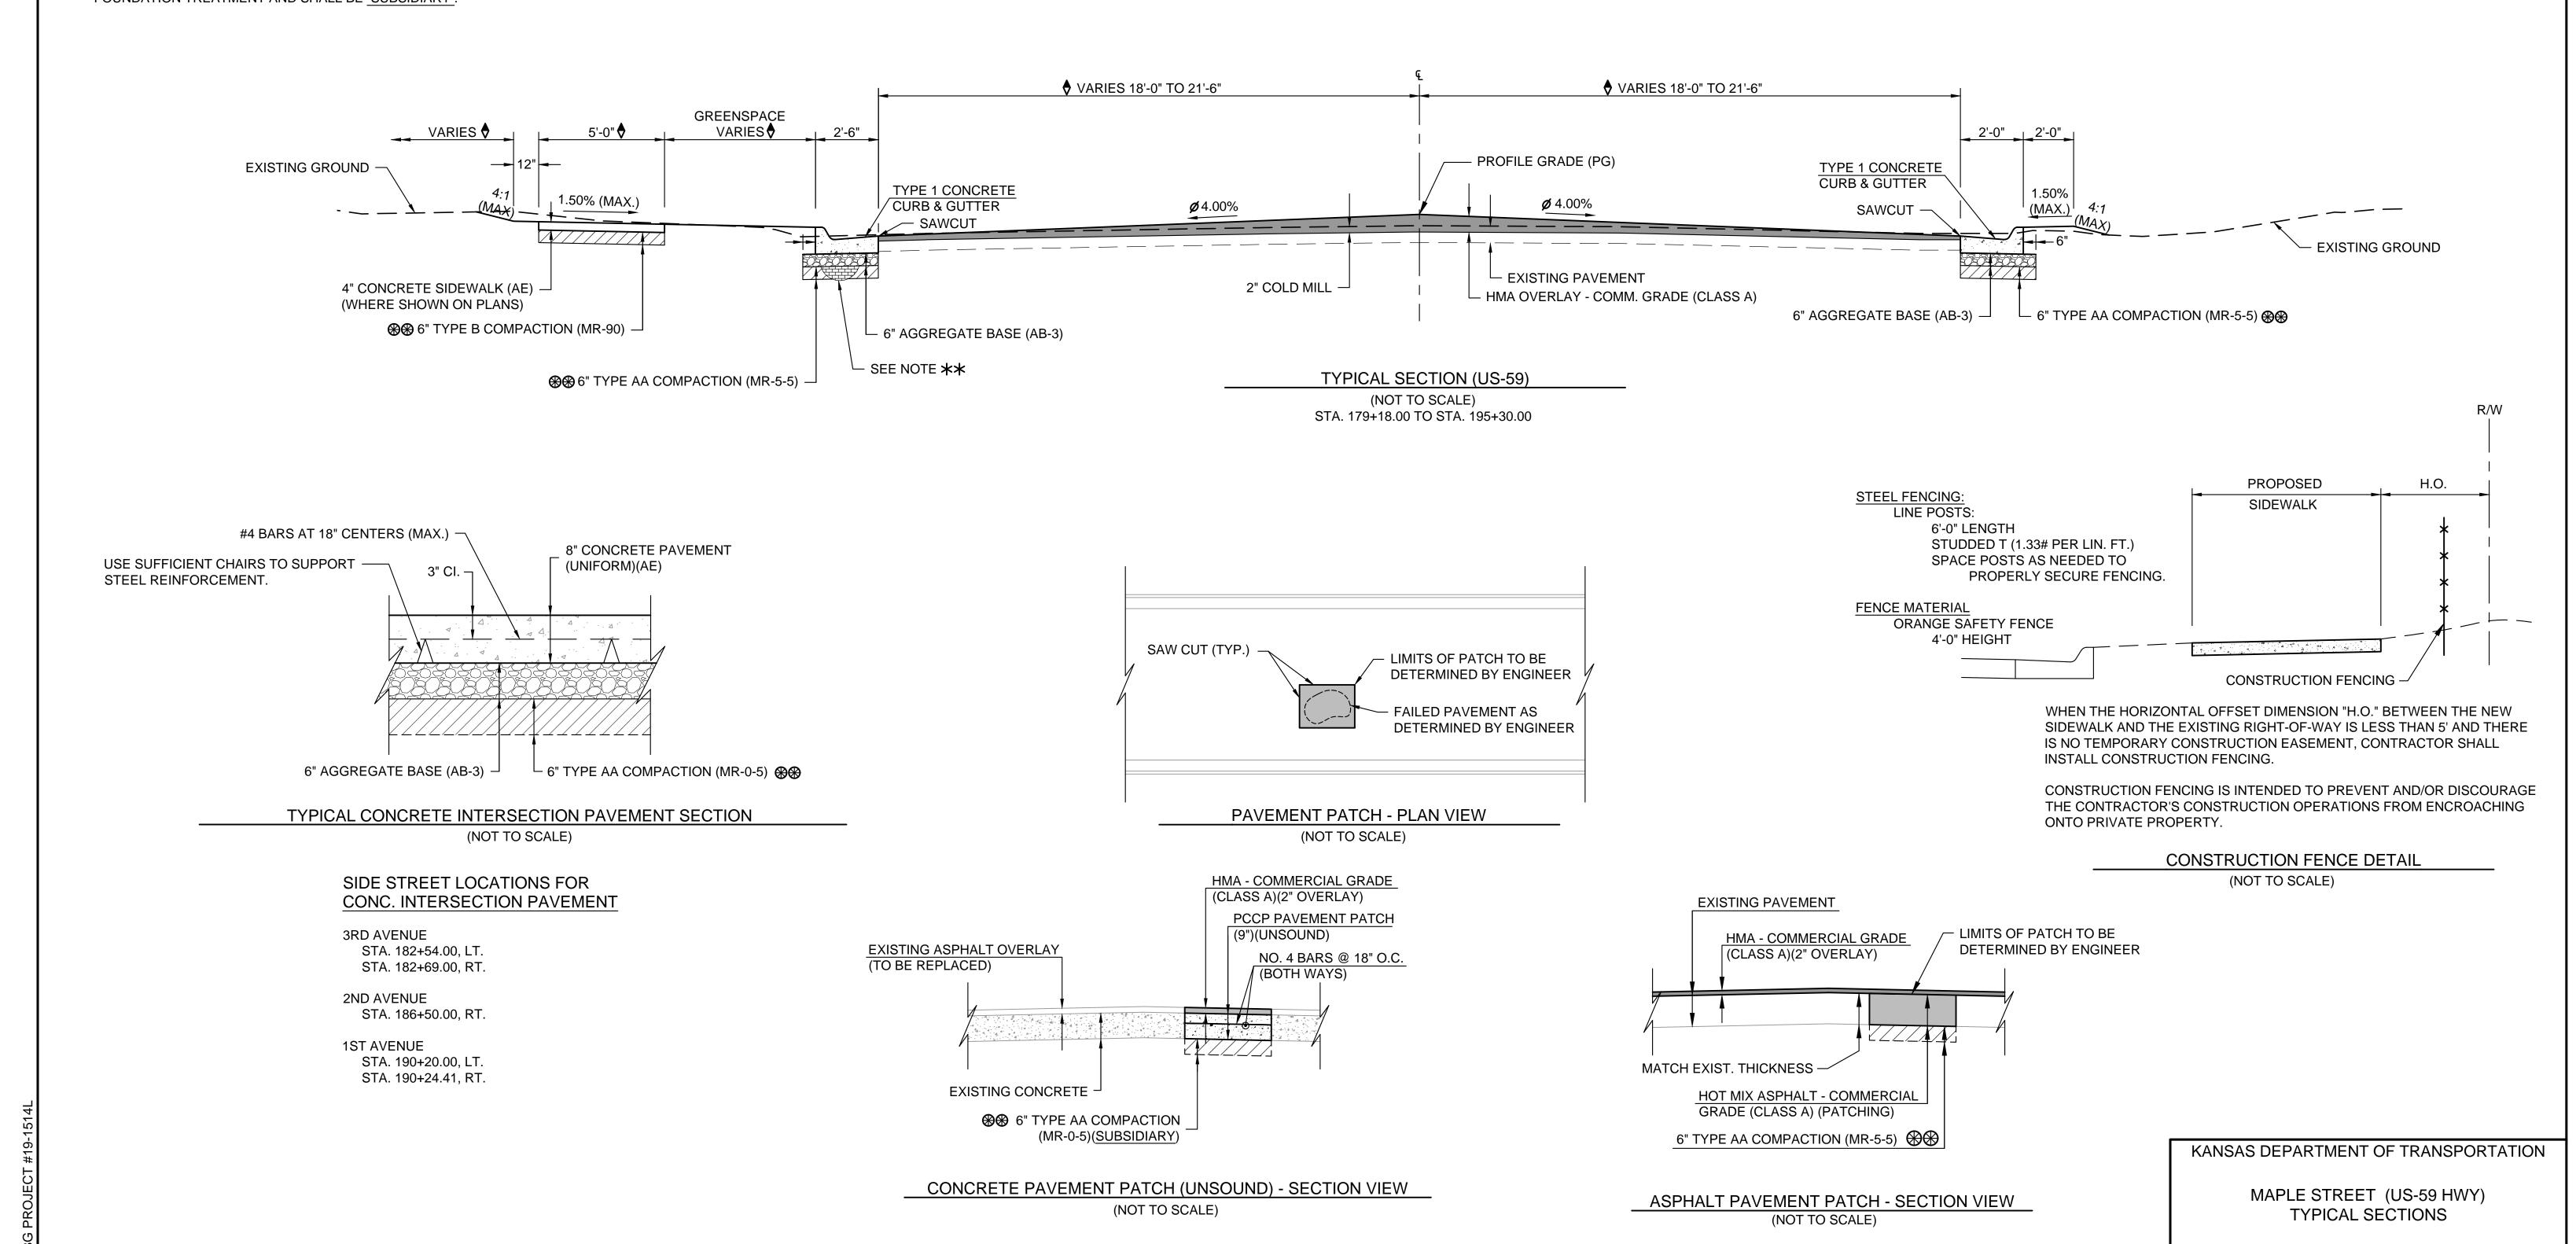

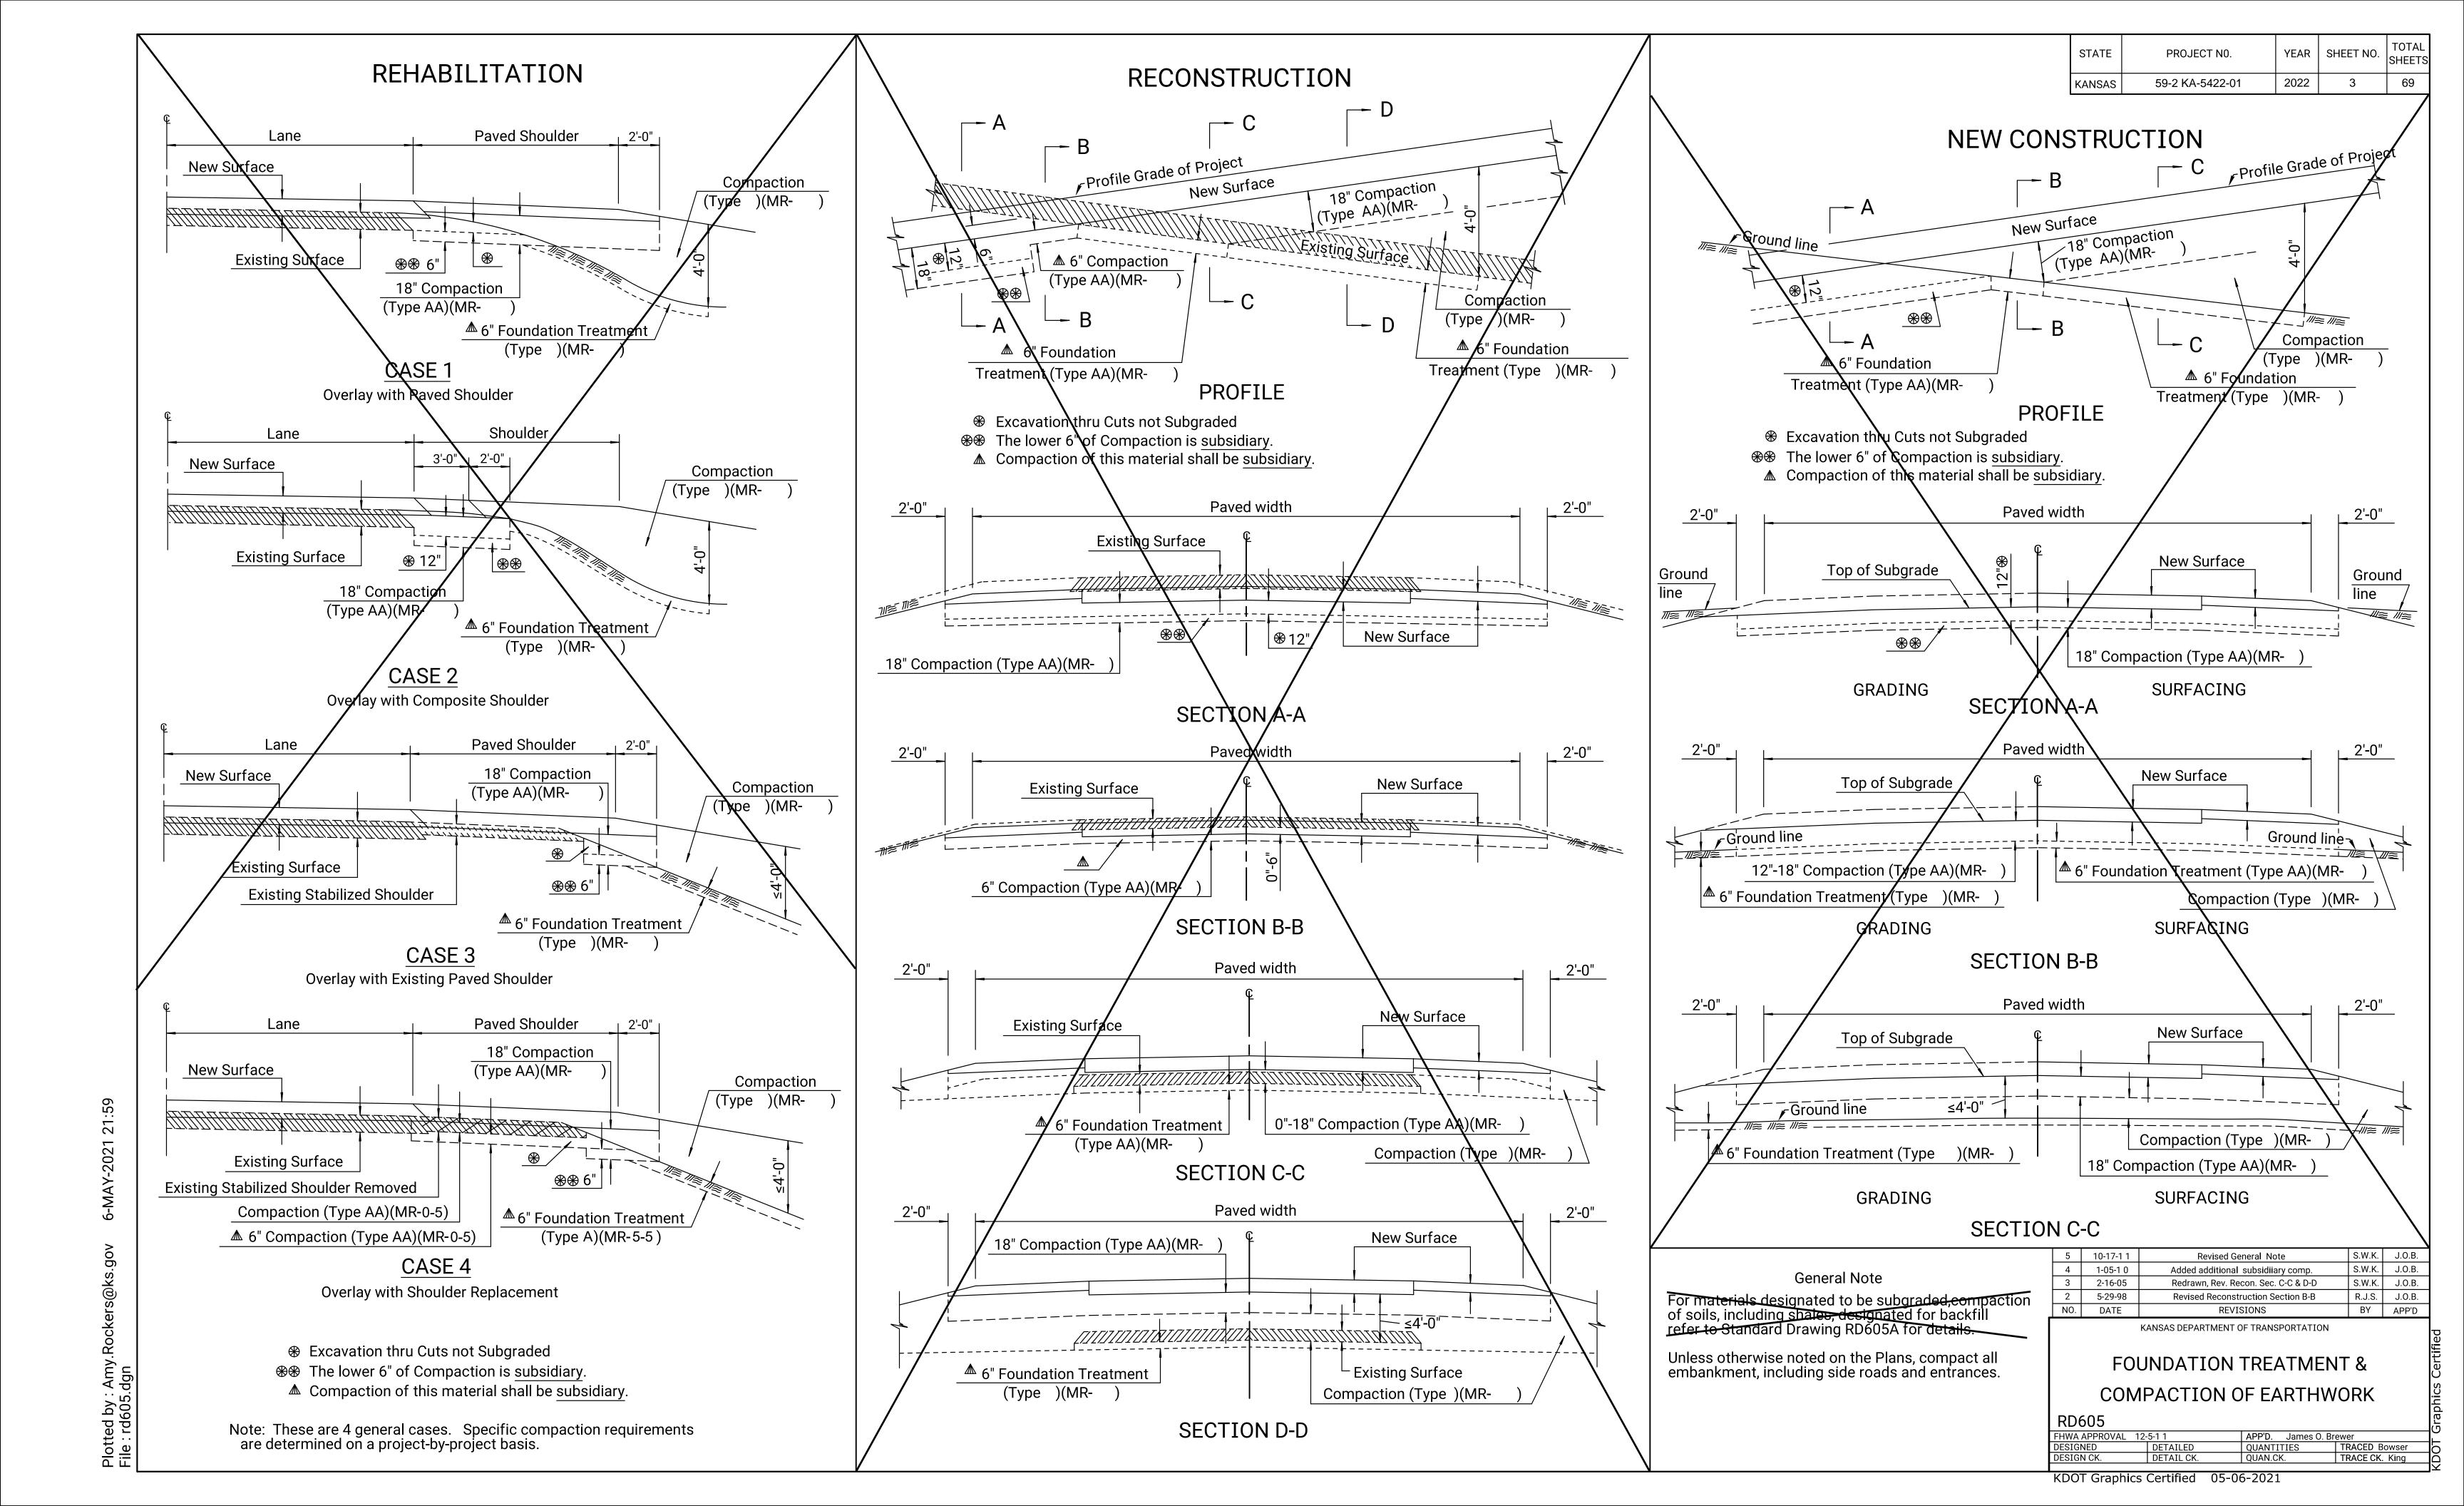

GENERAL NOTES THE GEOLOGICAL INFORMATION SHOWN ON THESE PLANS IS FROM STUDIES MADE IN THE FIELD AND REPRESENTS THE BEST INFORMATION AVAILABLE TO THE ENGINEER.

BE RESPONSIBLE FOR VERIFYING, IDENTIFYING AND MAKING THEIR OWN DETERMINATIONS OF SUBSURFACE CONDITIONS. NO DIRECT PAYMENT WILL BE MADE FOR ABANDONED UTILITY REMOVAL. SUCH WORK SHALL BE CONSIDERED SUBSIDIARY.

THE CONTRACTOR SHALL CALL 1-800-DIG-SAFE PRIOR TO ANY PROJECT EXCAVATION AND SHALL NOTIFY THE APPROPRIATE UTILITY COMPANIES FOR LOCATION OF EXISTING UTILITIES AND COORDINATE ANY NECESSARY RELOCATION AND/OR TEMPORARY SUPPORTS. ANY DAMAGE TO UTILITY LINES CAUSED BY THE CONTRACTOR'S CONSTRUCTION OPERATIONS SHALL BE REPAIRED AT THE CONTRACTOR'S EXPENSE.

THE CONTRACTOR SHALL CONFINE CONSTRUCTION CONNECTING THE UNDERDRAINS TO THE EXISTING INLETS. OPERATIONS TO WITHIN THE RIGHTS-OF-WAY, EASEMENTS OR CITY PROPERTY AS SHOWN ON THE PLANS, IT SHALL BE THE CONTRACTOR'S RESPONSIBILITY TO REPLACE LOT PINS CONTRACTOR.

CONSTRUCTION. ANY DAMAGE TO ADJACENT SURFACING, PLACE. PAVEMENT MARKINGS, CURB OR OTHER OBJECTS WITHIN OR OUT OF THE RIGHT-OF-WAY SHALL BE REPAIRED AT THE CONTRACTOR'S EXPENSE.

TREES MARKED WITH AN "X" ARE TO BE REMOVED. ALL OTHER TREES SHALL NOT BE DISTURBED WITHOUT THE APPROVAL OF THE ENGINEER

MAINTENANCE OF DRAINAGE SHALL BE THE THE CONTRACTOR RESPONSIBILITY OF THE CONTRACTOR.

SITES PROVIDED BY THE CONTRACTOR. THESE SITES SHALL BE APPROVED BY THE ENGINEER AS TO THE MANHOLE DIMENSIONS ARE INSIDE DIMENSIONS. SUITABILITY, APPEARANCE, AND SITE LOCATION LOCATIONS THAT, IN THE OPINION OF THE ENGINEER, WILL LEAVE AN UNSIGHTLY APPEARANCE WILL NOT BE APPROVED.

ALL ASPHALT AND CONCRETE TO BE REMOVED SHALL BE NEATLY SAW CUT. SAW CUTS SHALL BE FULL DEPTH AND SHALL BE SUBSIDIARY TO RELATED BID ITEMS. PAVEMENT REMOVAL AND REPLACEMENT LIMITS SHALL BE AS SHOWN ON THE PLANS. IF THE CONTRACTOR EXCEEDS THOSE LIMITS WITHOUT THE APPROVAL OF THE OWNER, IT SHALL BE AT THE CONTRACTOR'S EXPENSE.

ALL DISPOSAL SITES MUST BE APPROVED BY THE KANSAS DEPARTMENT OF HEALTH AND ENVIRONMENT. MATERIALS EITHER STOCKPILED OR DISPOSED OF IN A FLOOD PLAIN WOULD REQUIRE A KANSAS DEPARTMENT OF AGRICULTURE PERMIT. ANY MATERIAL DUMPED IN WATERS OF THE UNITED STATES OR WETLANDS IS SUBJECT TO U.S. CORPS OF ENGINEERS PERMITTING REGULATIONS.


ALL LABOR, MATERIALS AND EQUIPMENT NECESSARY TO MAKE CONNECTIONS TO EXISTING PIPE OR EXISTING SMALL STRUCTURES SHALL NOT BE PAID FOR DIRECTLY, BUT SHALL BE CONSIDERED SUBSIDIARY TO THE COST OF PIPE INSTALLATION, THIS INCLUDES BUT IS NOT LIMITED TO

THE CONTRACTOR SHALL NOTIFY ALL LANDOWNERS IN WRITING AT LEAST TWO (2) WEEKS PRIOR TO ANY OR BOUNDARY MARKERS DISTURBED BY THE CONSTRUCTION ACTIVITIES WHICH WOULD TAKE PLACE ADJACENT TO THEIR PROPERTY. INDIVIDUAL DETAILS NOTICES OF ACCESS RESTRICTIONS SHALL BE HAND THE CONTRACTOR IS ENCOURAGED TO VIDEO PRIOR TO DELIVERED 48 HOURS PRIOR TO RESTRICTIONS PUT IN

> THE CONTRACTOR SHALL NOTIFY POLICE, FIRE, EMERGENCY PREPAREDNESS DEPARTMENTS, ETC. PRIOR TO BLOCKING OR RESTRICTING TRAFFIC ON ANY STREET


> MILLINGS: ALL MATERIALS REMOVED BY MILLING OPERATIONS SHALL BECOME THE PROPERTY OF THE CONTRACTOR AND SHALL BE REMOVED FROM THE SITE BY

STATION INFORMATION FOR STORM SEWER STRUCTURES EXCAVATION SHOWN TO BE WASTED SHALL BE WASTED ON SHOWN IN THESE PLANS IS TO THE CENTER OF THE PROPOSED STRUCTURE. ALL STORM SEWER INLET AND

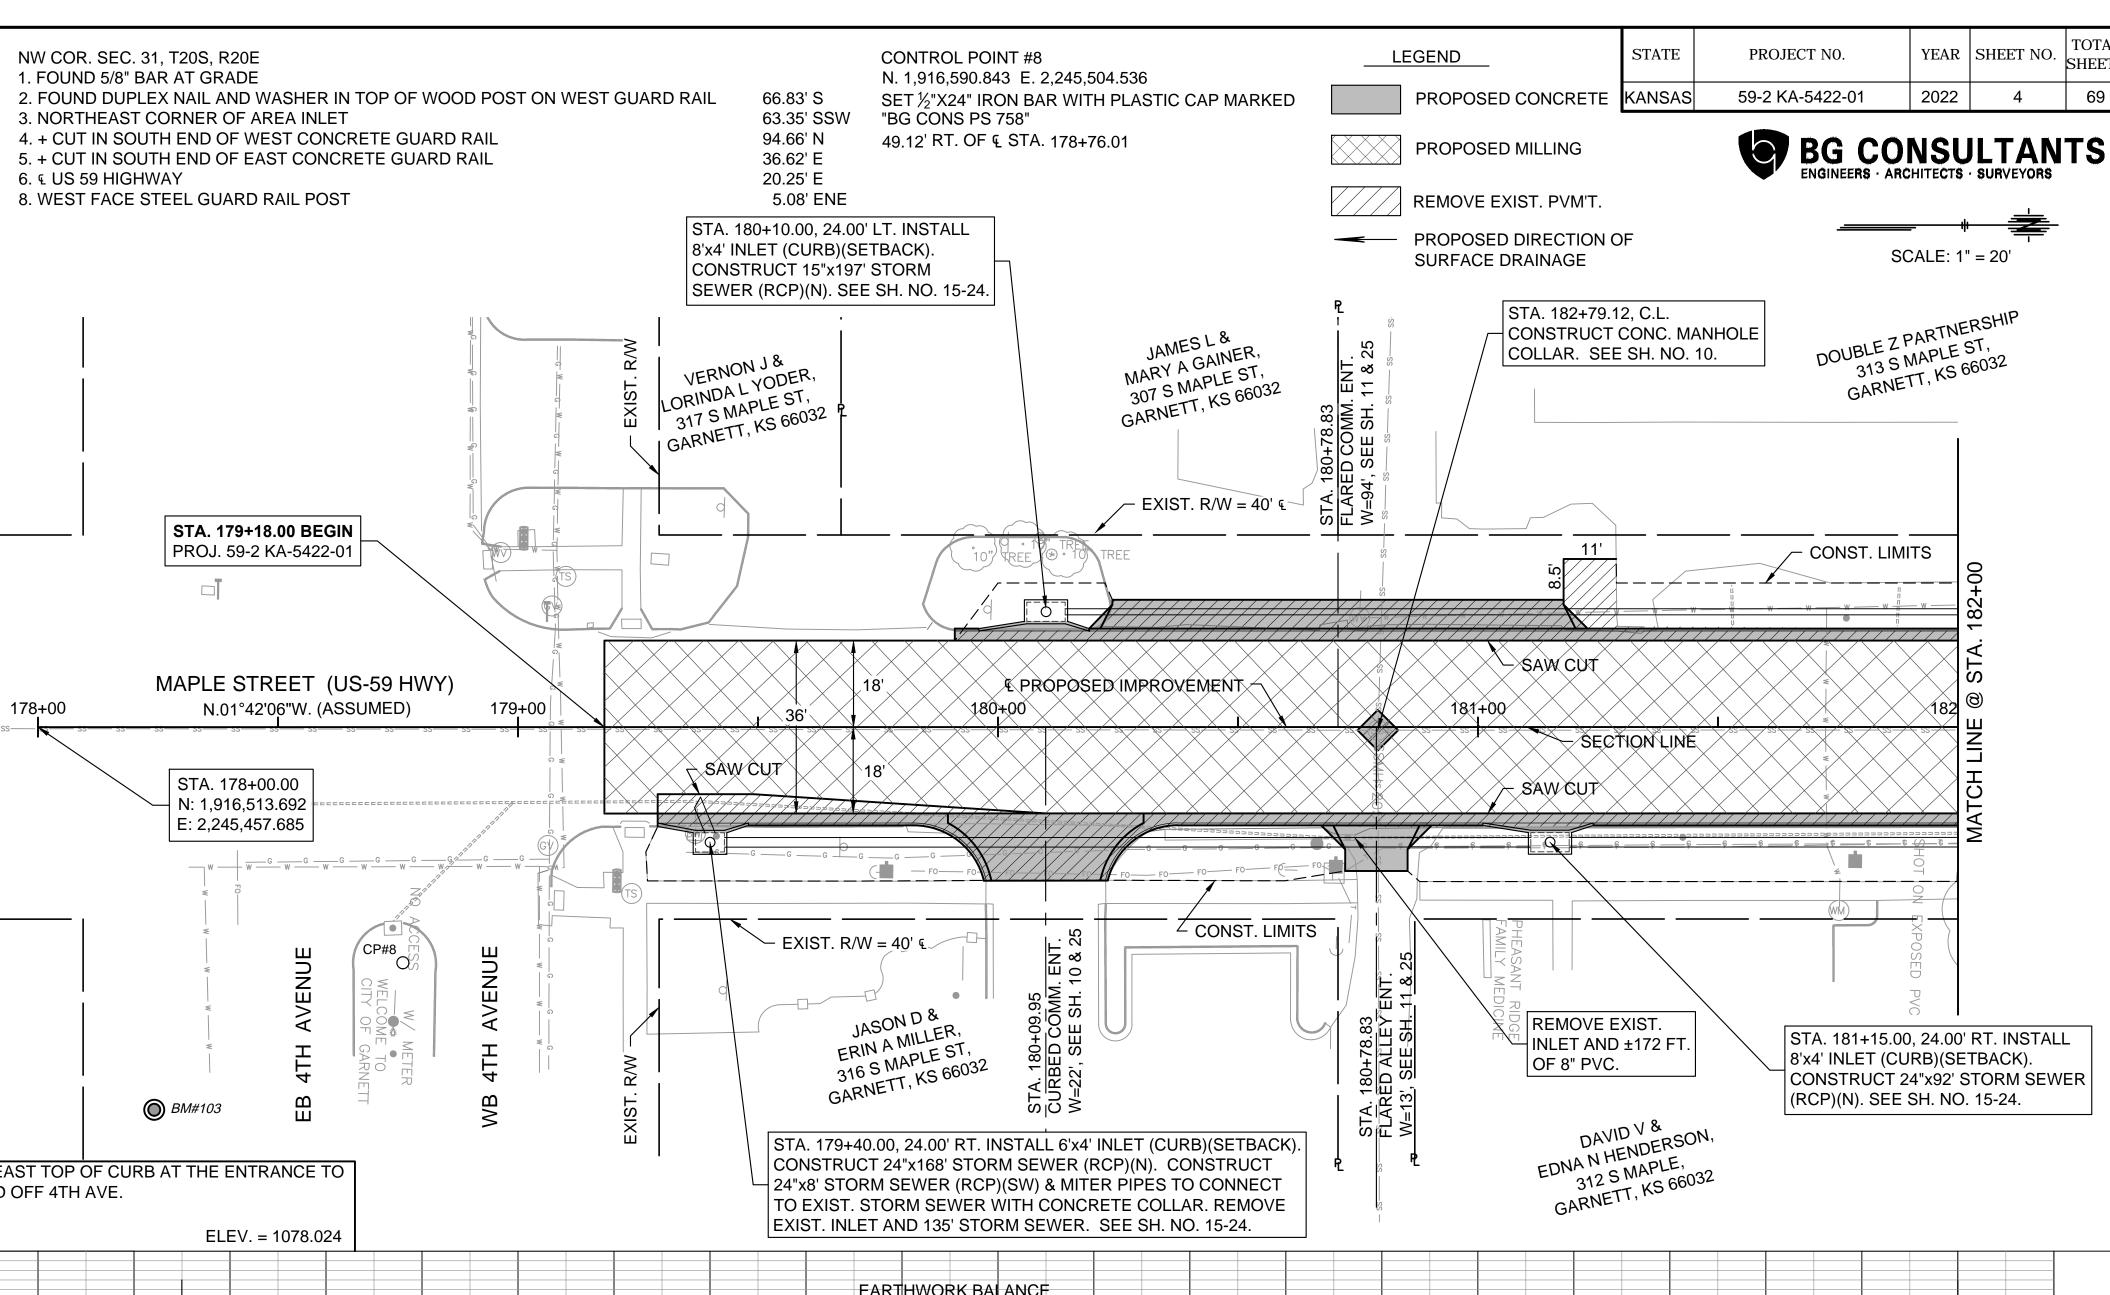

180+00

181+00

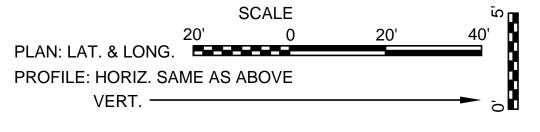

PROJECT SURVEY CONTROL HORZ. DATUM: OPUS STATIC OBSERVATION AT CP#1

(APRIL 16, 2020) NORTHING: 1.948.549.167 STATE PLANE GRID EASTING: 2,384,897.493 STATE PLANE GRID COMBINED FACTOR FROM OPUS REPORT: .99991105

THIS DATA WAS USED TO COMPUTE PROJECT COORDINATES

VERT. DATUM: SEA LEVEL DATUM OF NAVD 88 **OPUS STATIC OBSERVATION AT CP#1 ELEVATION: 152.294**


UTILITY OWNERS


- WATER: CITY OF GARNETT, KS ATTN: ERIC MILLS 785-448-5496
- SANITARY SEWER CITY OF GARNETT, KS ATTN: ERIC MILLS
- NATURAL GAS: CITY OF GARNETT, KS ATTN: ERIC MILLS 785-448-5496

785-448-5496


ELECTRICITY: CITY OF GARNETT, KS ATTN: ERIC MILLS 785-448-5496


- TELEPHONE: CENTURYLINK
- CABLE TV: ATTN:

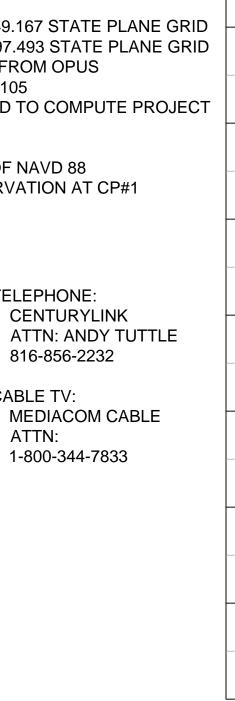


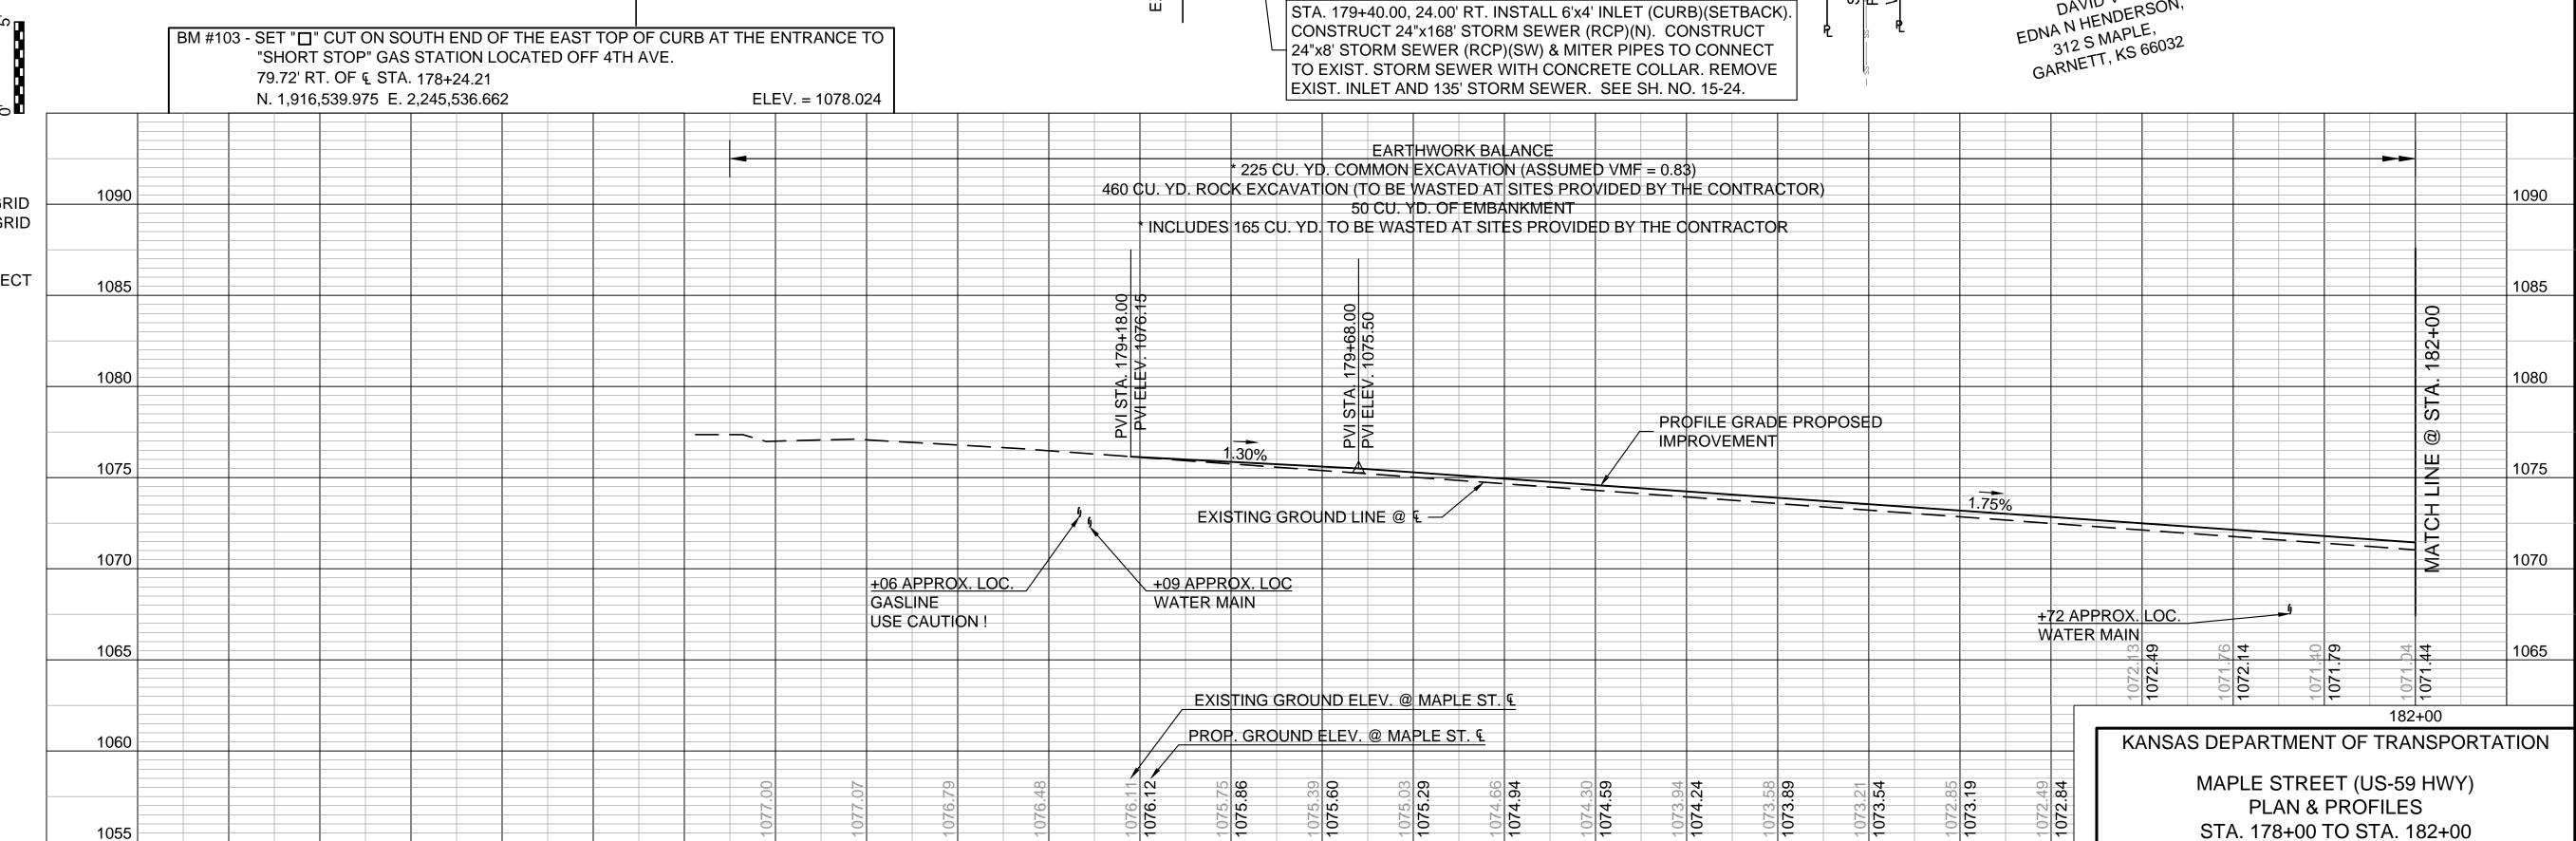

179+00

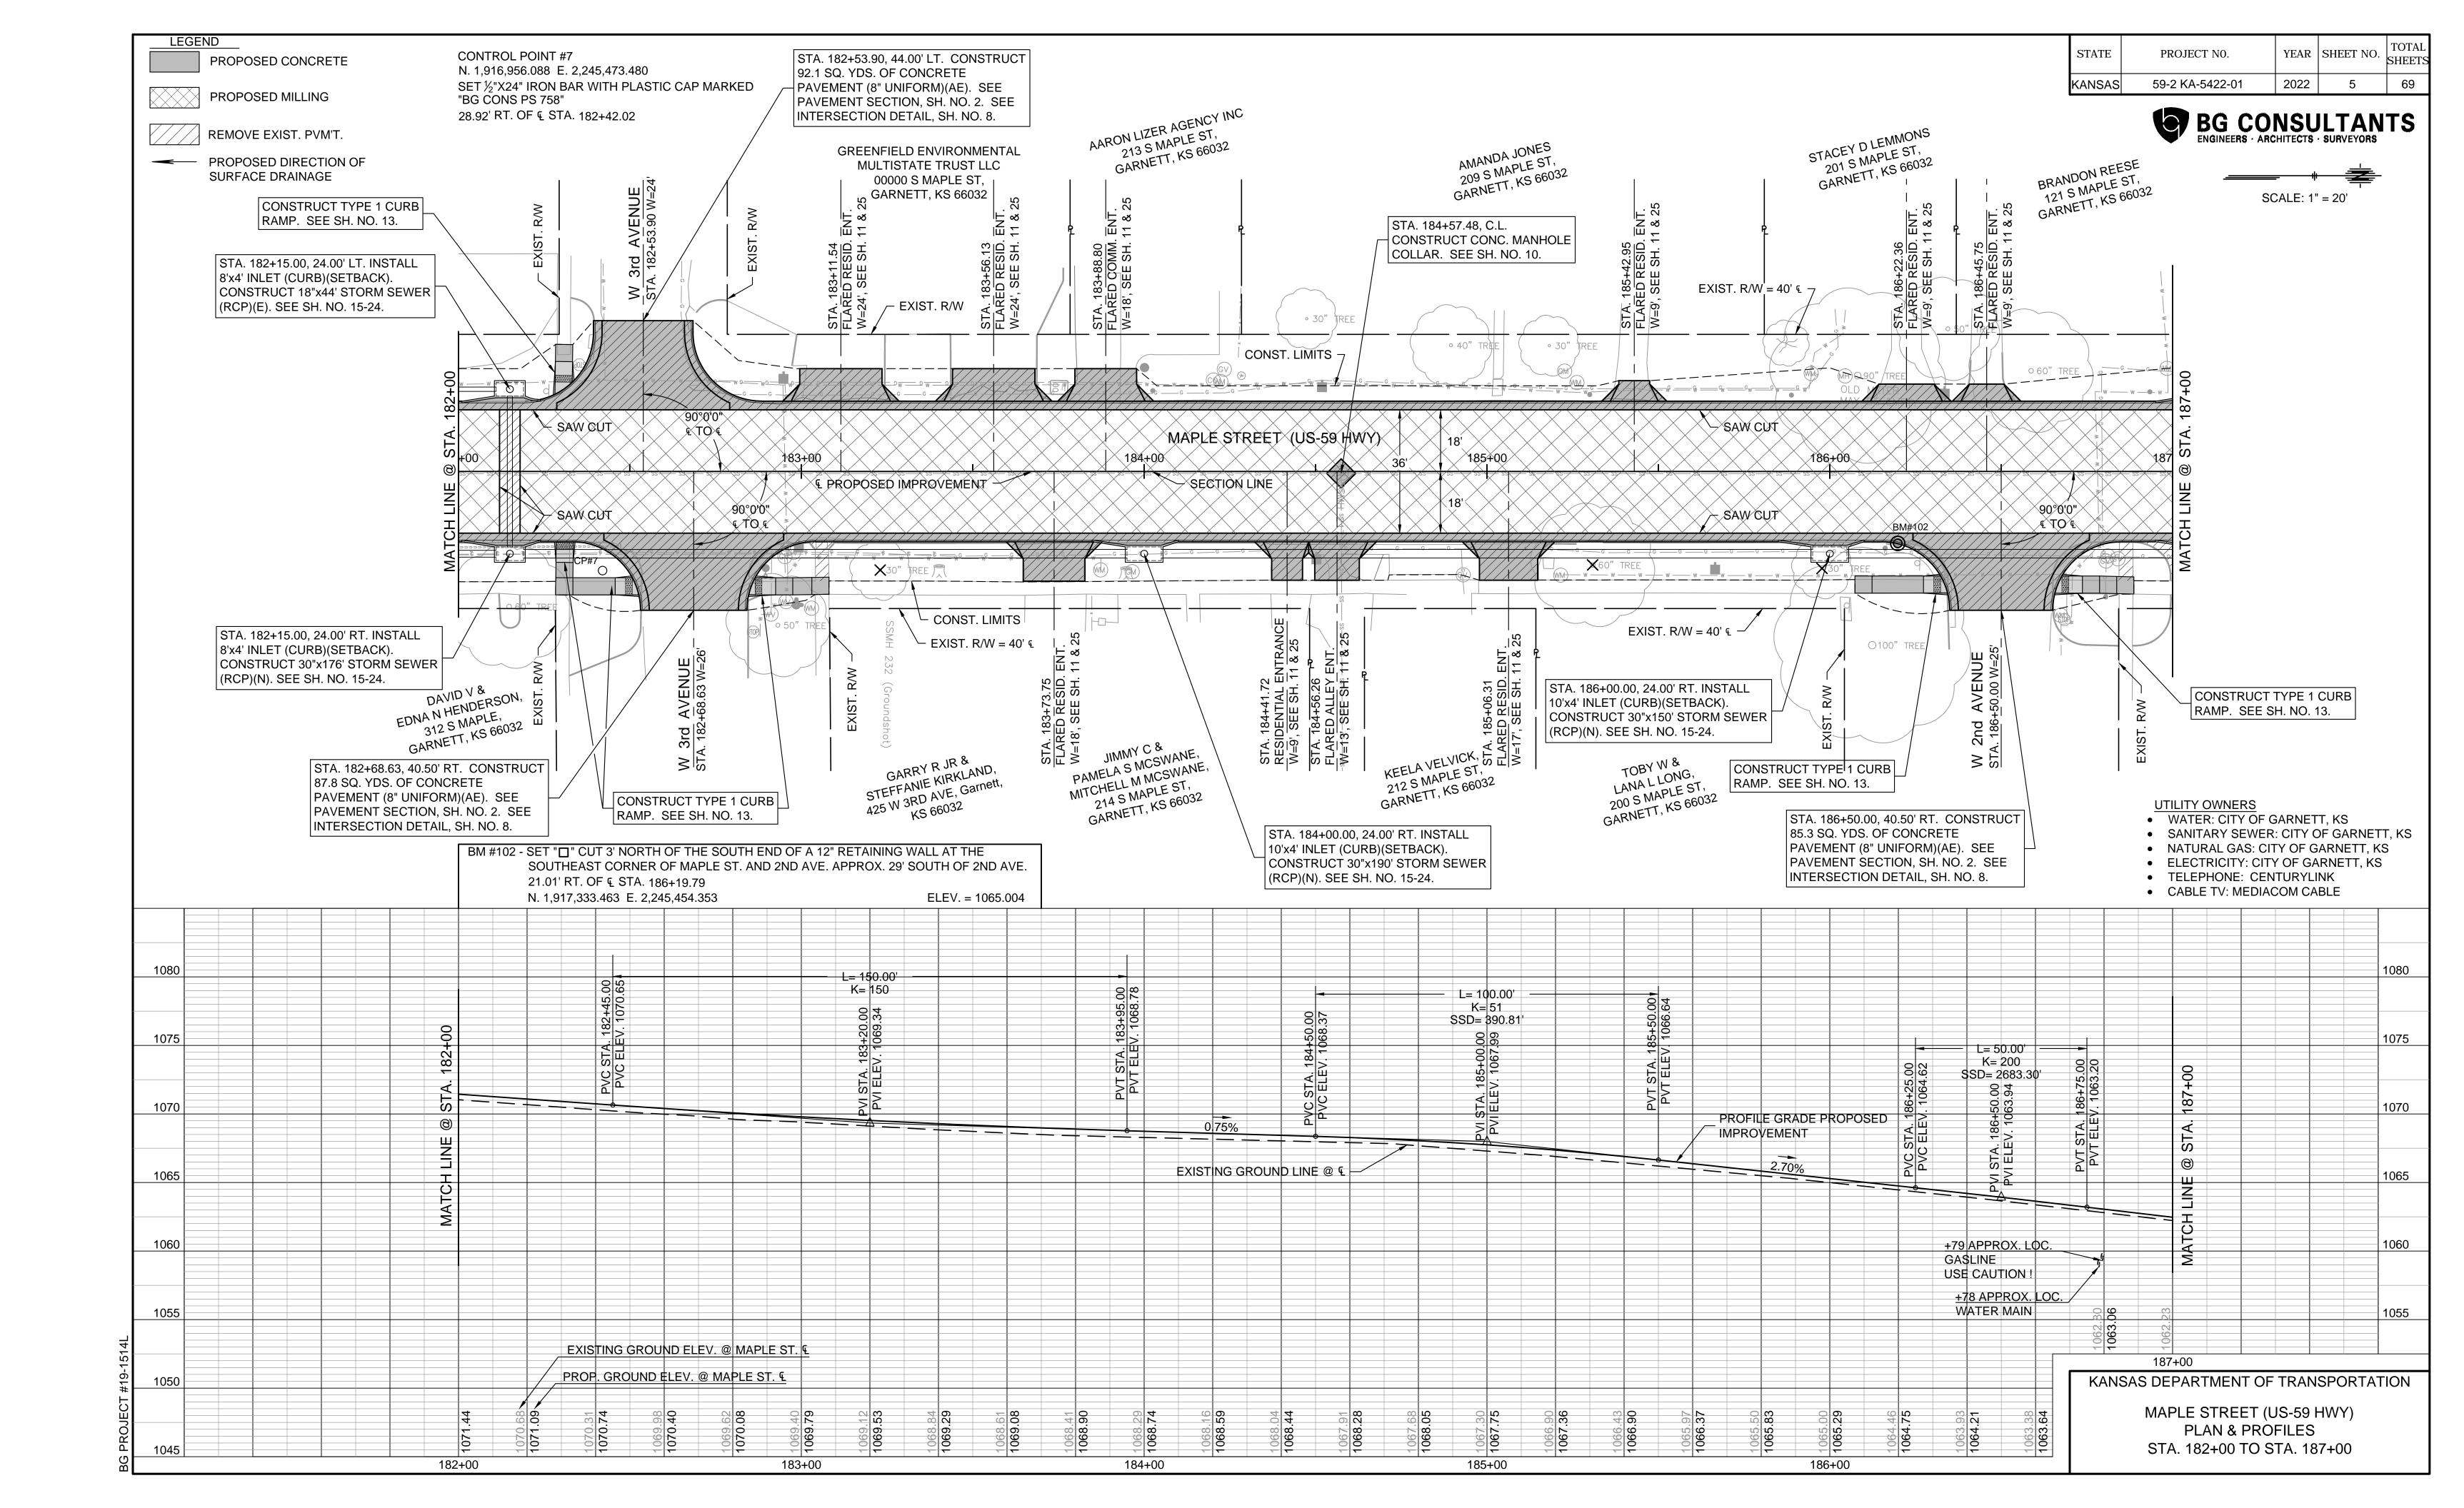

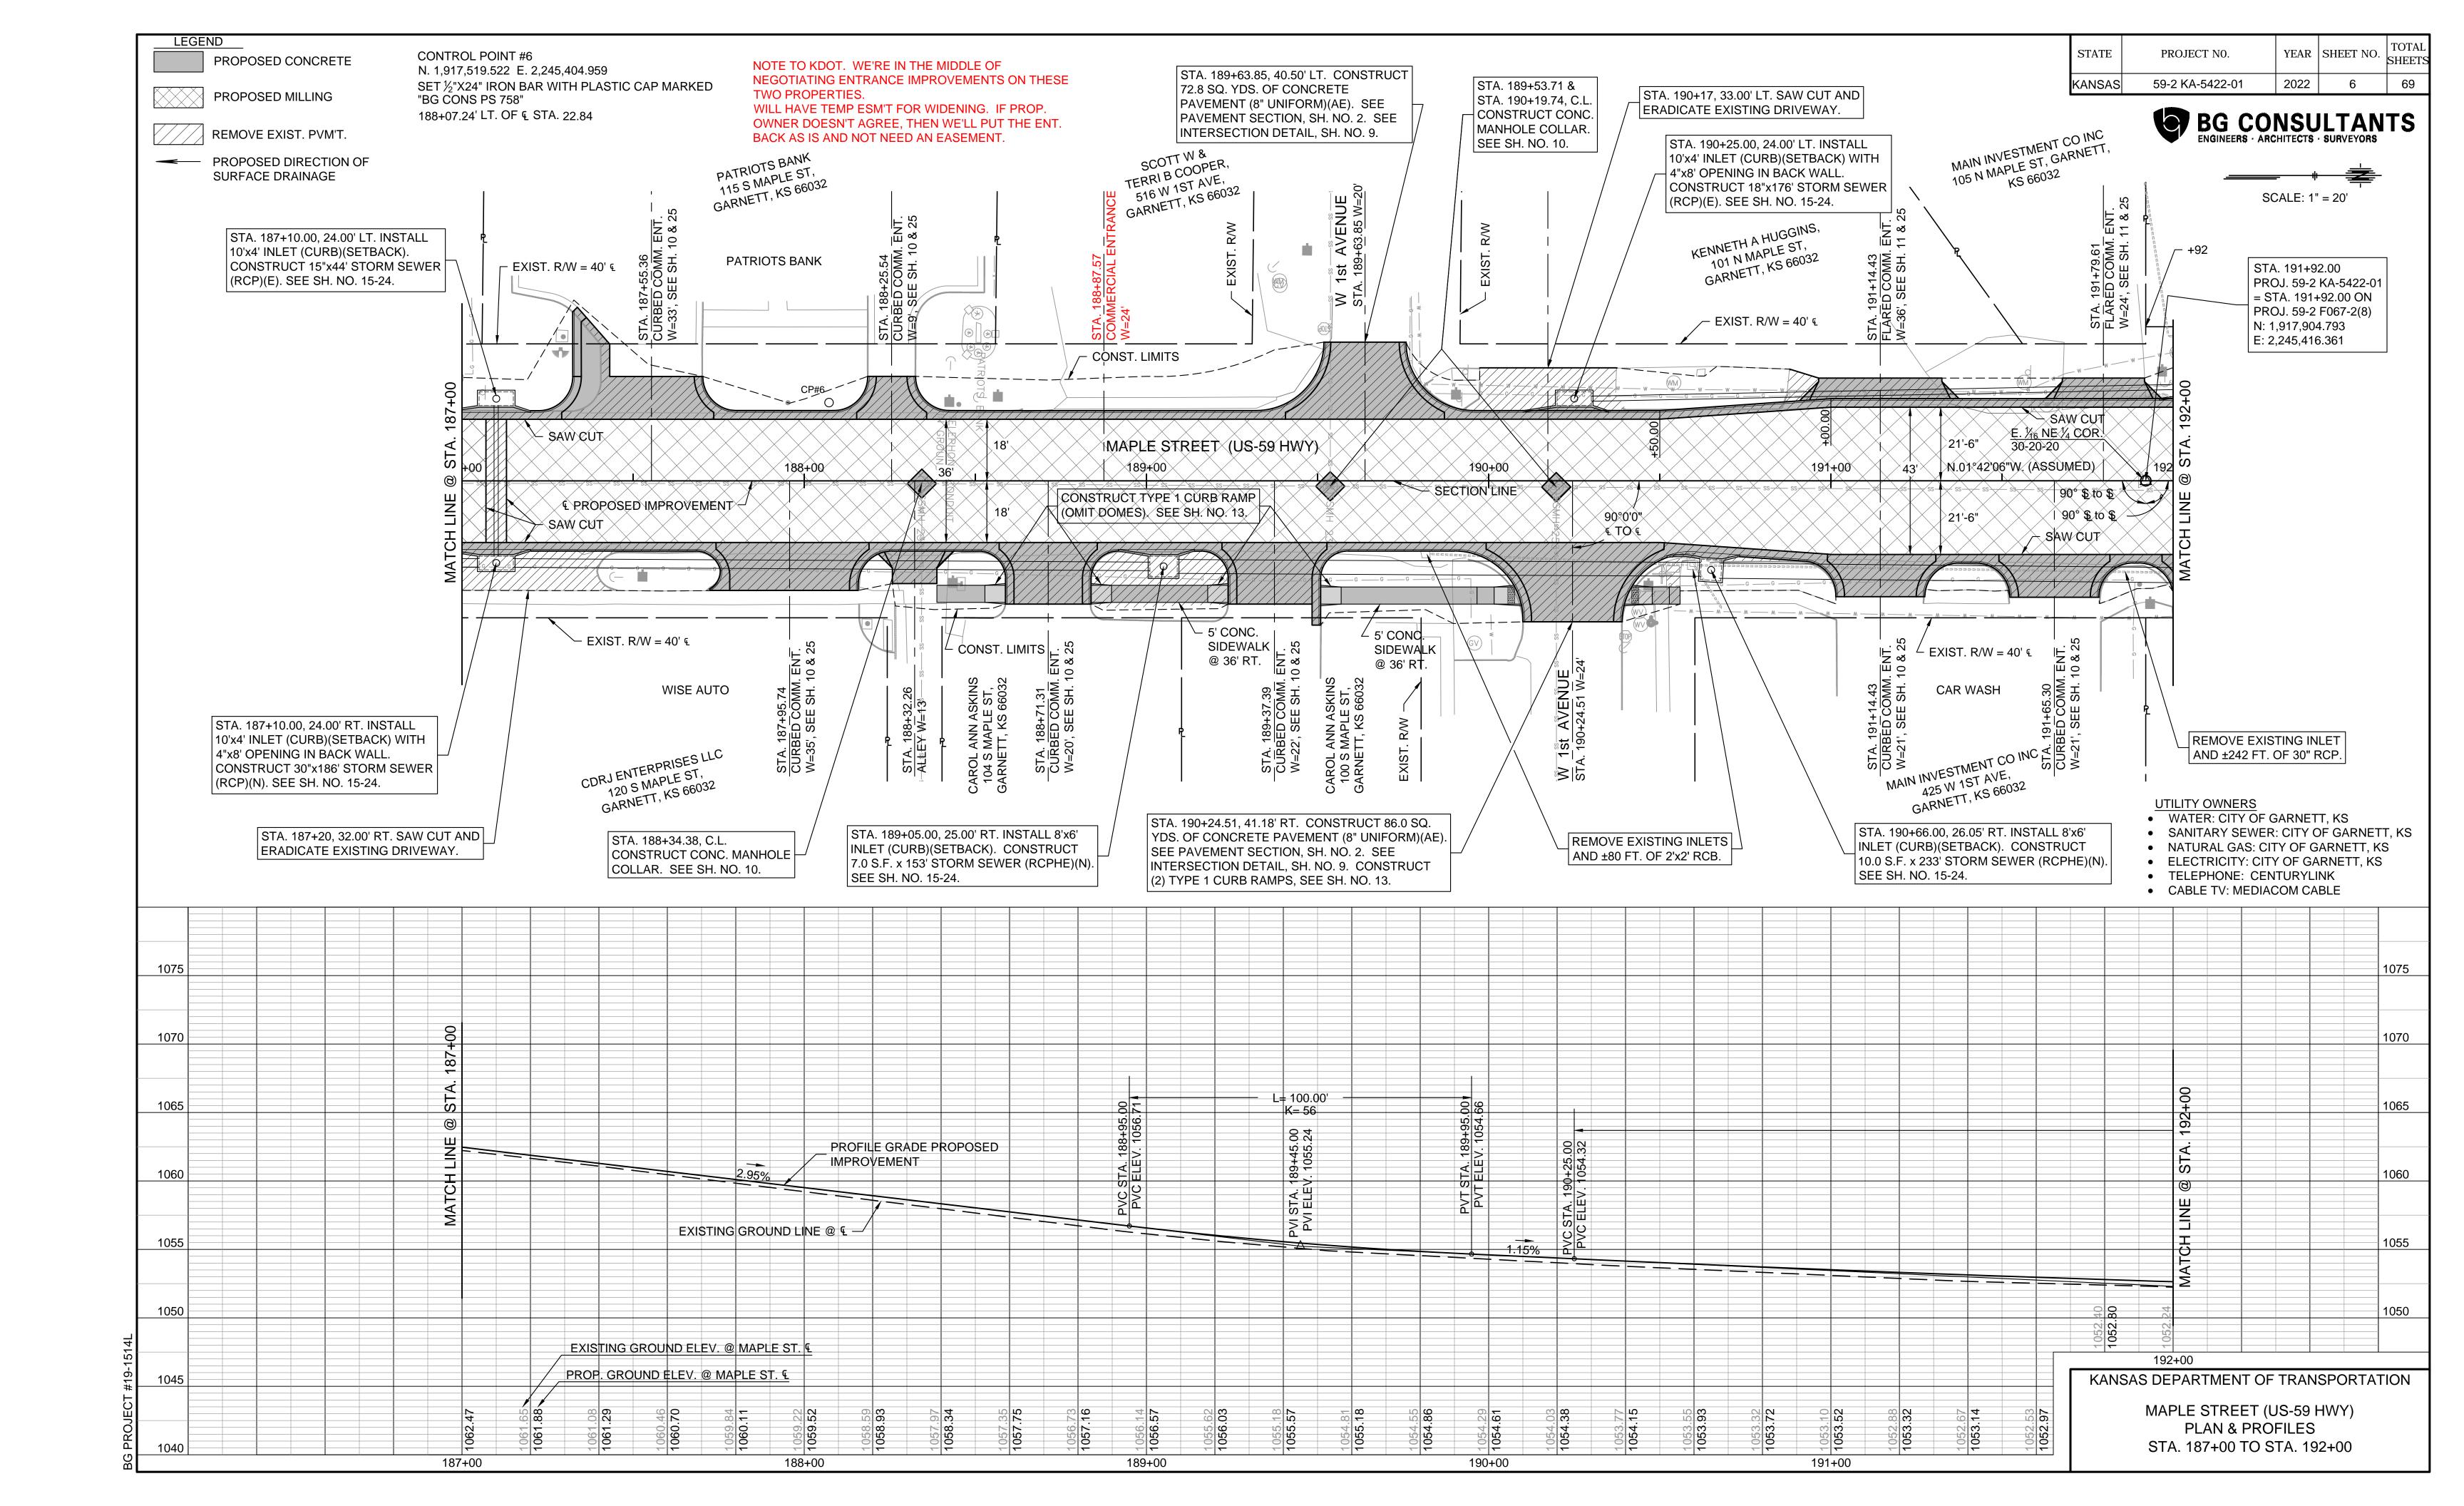

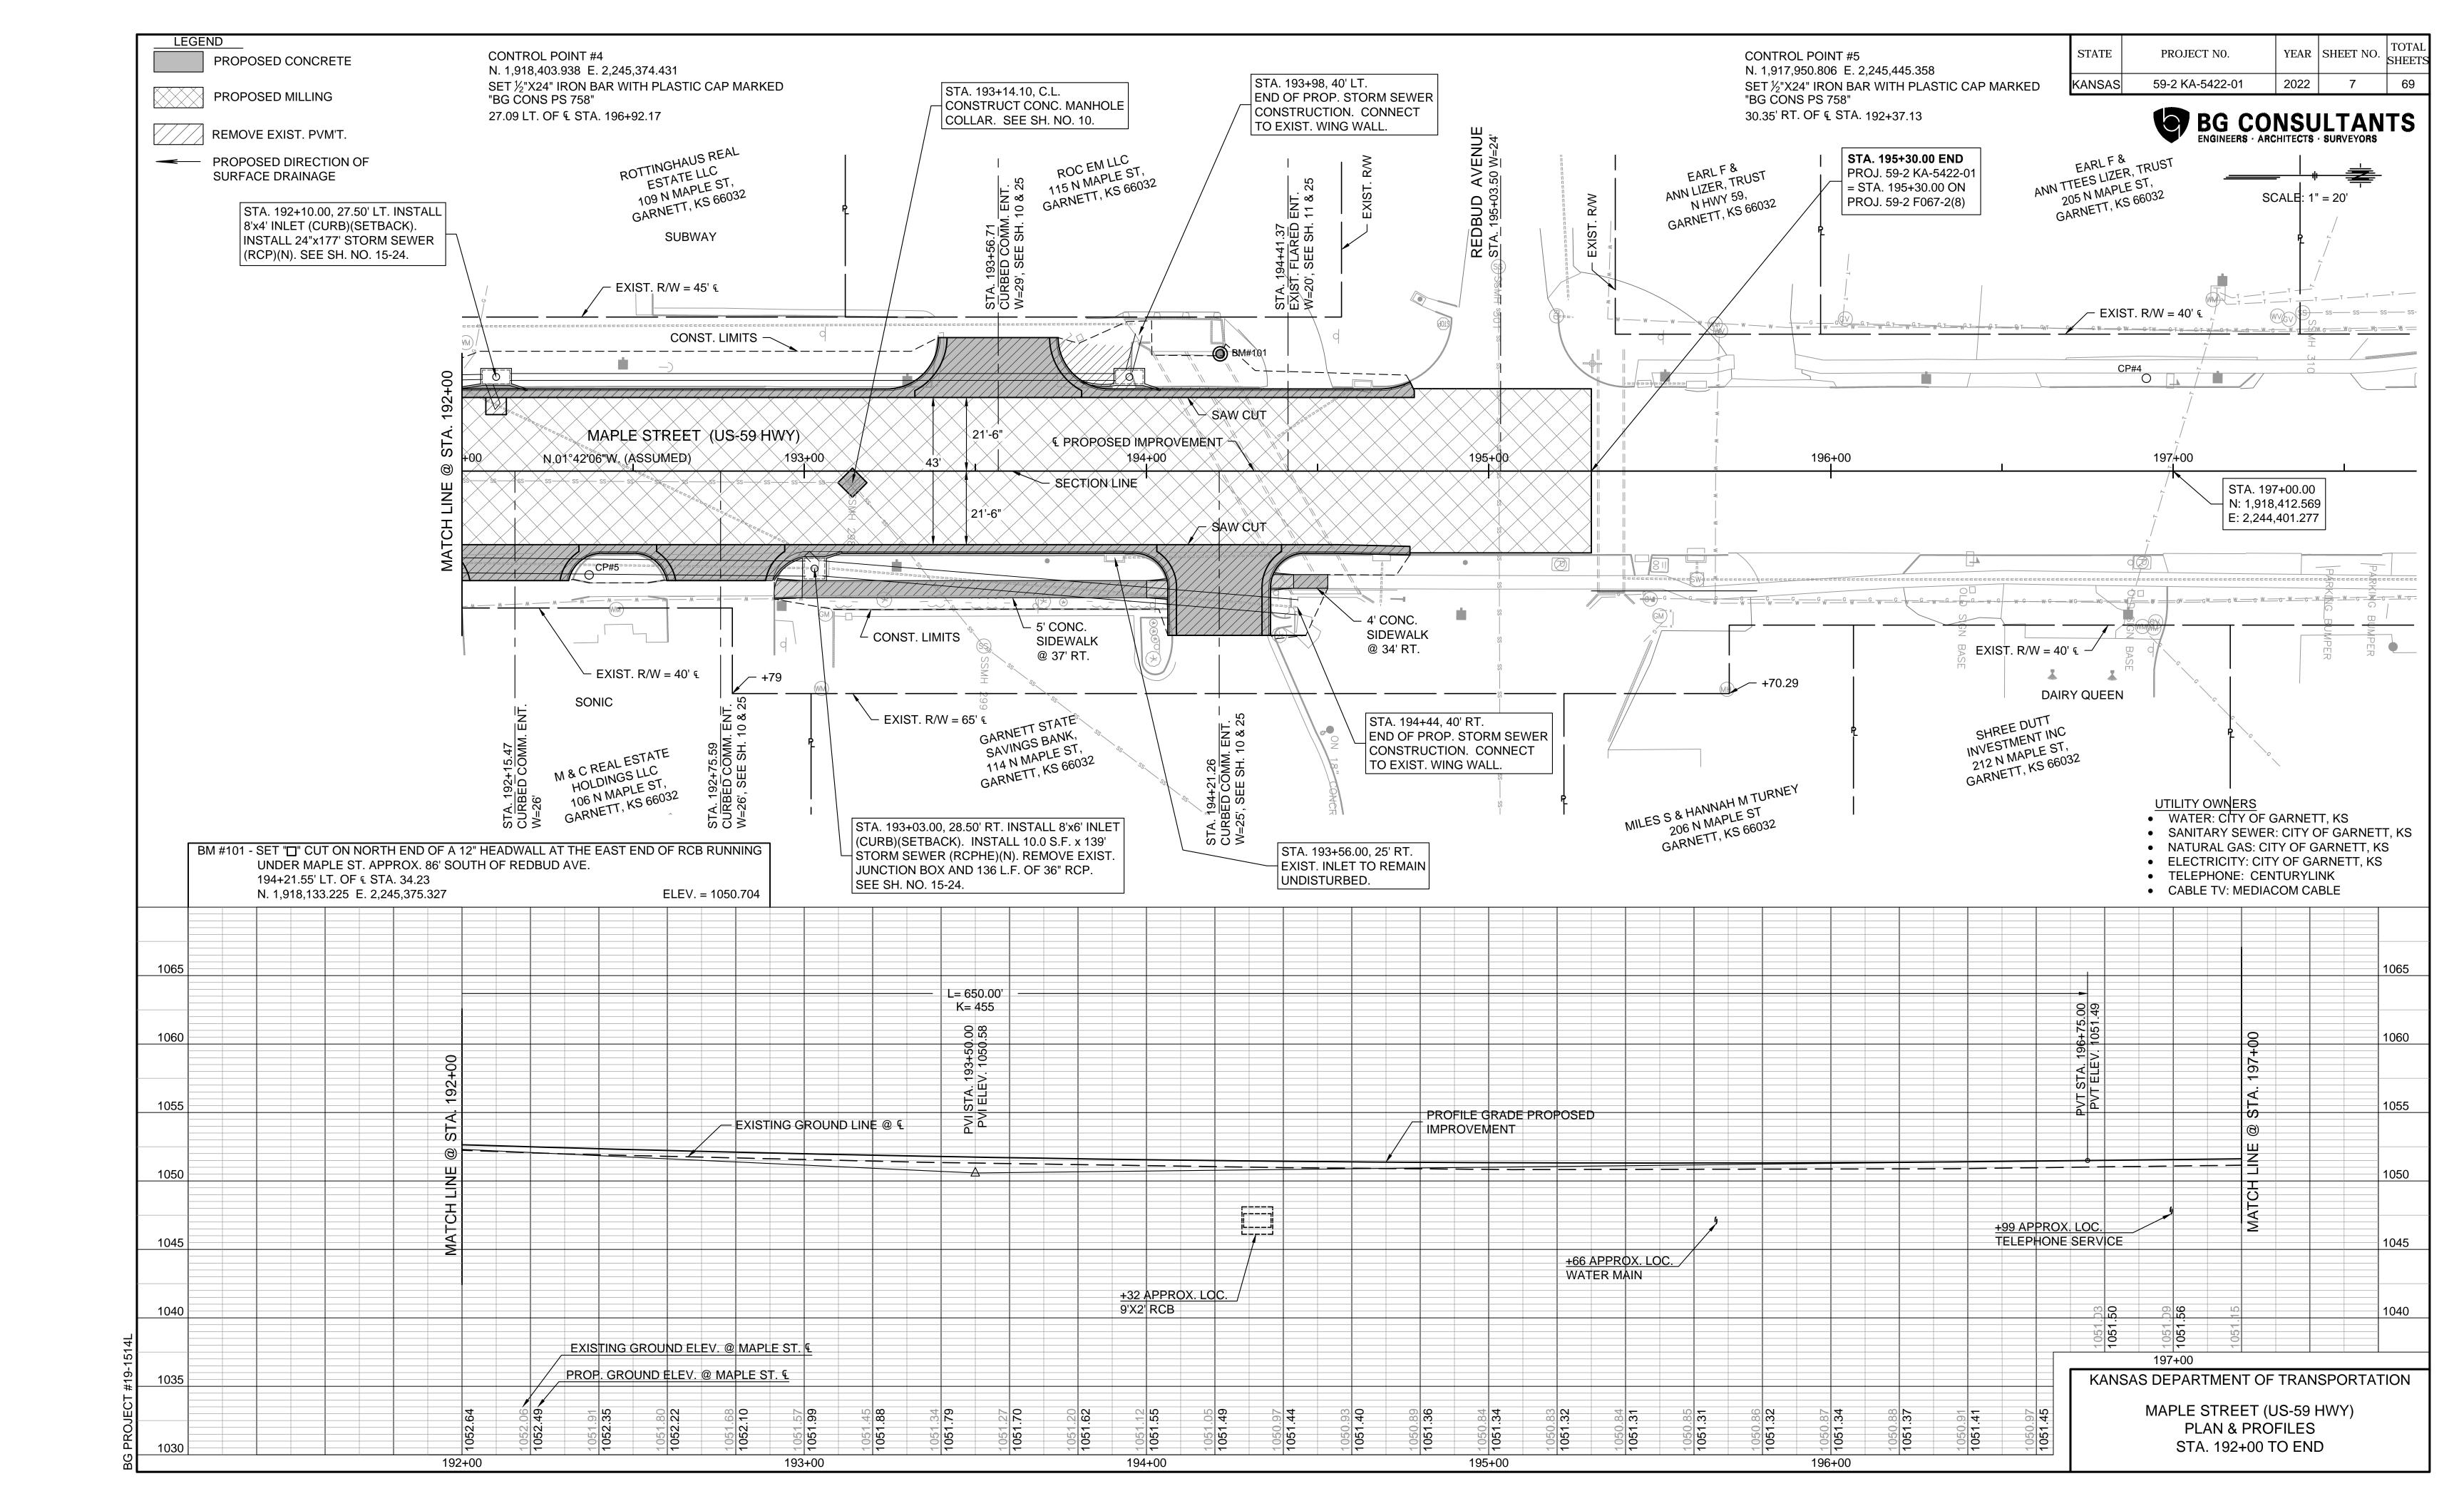

GENERAL NOTES

ALL TOP OF CURB ELEVATIONS ON THIS SHEET ARE FOR "CURB AND GUTTER - TYPE I".
THE CONTRACTOR SHALL BE RESPONSIBLE FOR ADJUSTING THE HEIGHT OF THE CURB AT
LOCATIONS WHERE "CURB AND GUTTER - TYPE II" OR OTHER TYPES OF CURB AND GUTTER
ARE TO BE CONSTRUCTED.

= LEVEL AREA IN THE SIDEWALK/SIDEWALK RAMP ALIGNMENT WHICH SHALL BE SLOPED TO MAINTAIN POSITIVE DRAINAGE, BUT IN NO CASE SHALL THE SLOPE EXCEED 2.00% MEASURED IN ANY DIRECTION. SEE THE ACCESS RAMP CONSTRUCTION DETAILS FOR MORE INFORMATION.

WHERE NEW CONCRETE SIDEWALK ABUTS EXISTING SIDEWALKS, THE TIE-IN LOCATION SHALL BE FLUSH. NO VERTICAL DISCONTINUITIES WILL BE ALLOWED.

FIELD VERIFY THAT THAT A COUNTER SLOPE OF 5% OR FLATTER IS USED AT THE BASE OF CURB RAMPS (PER RD725) AND THAT INDICATED DRAINAGE PATTERNS ARE MAINTAINED.

LEGEND

PROPOSED DIRECTION OF SURFACE DRAINAGE

- 10' - PROPOSED CONTRACTION JOINT & JOINT LENGTH


ECR END OF CURB RETURN

QP QUARTER-POINT OF CURB RETURN
MP MID-POINT OF CURB RETURN

T/C TOP OF CURB (TYPE CG1 CURB AND GUTTER)
T/P TOP OF PAVEMENT

T/R TOP OF PAVEME

TOP OF SIDEWALK
PROPOSED CONCRETE

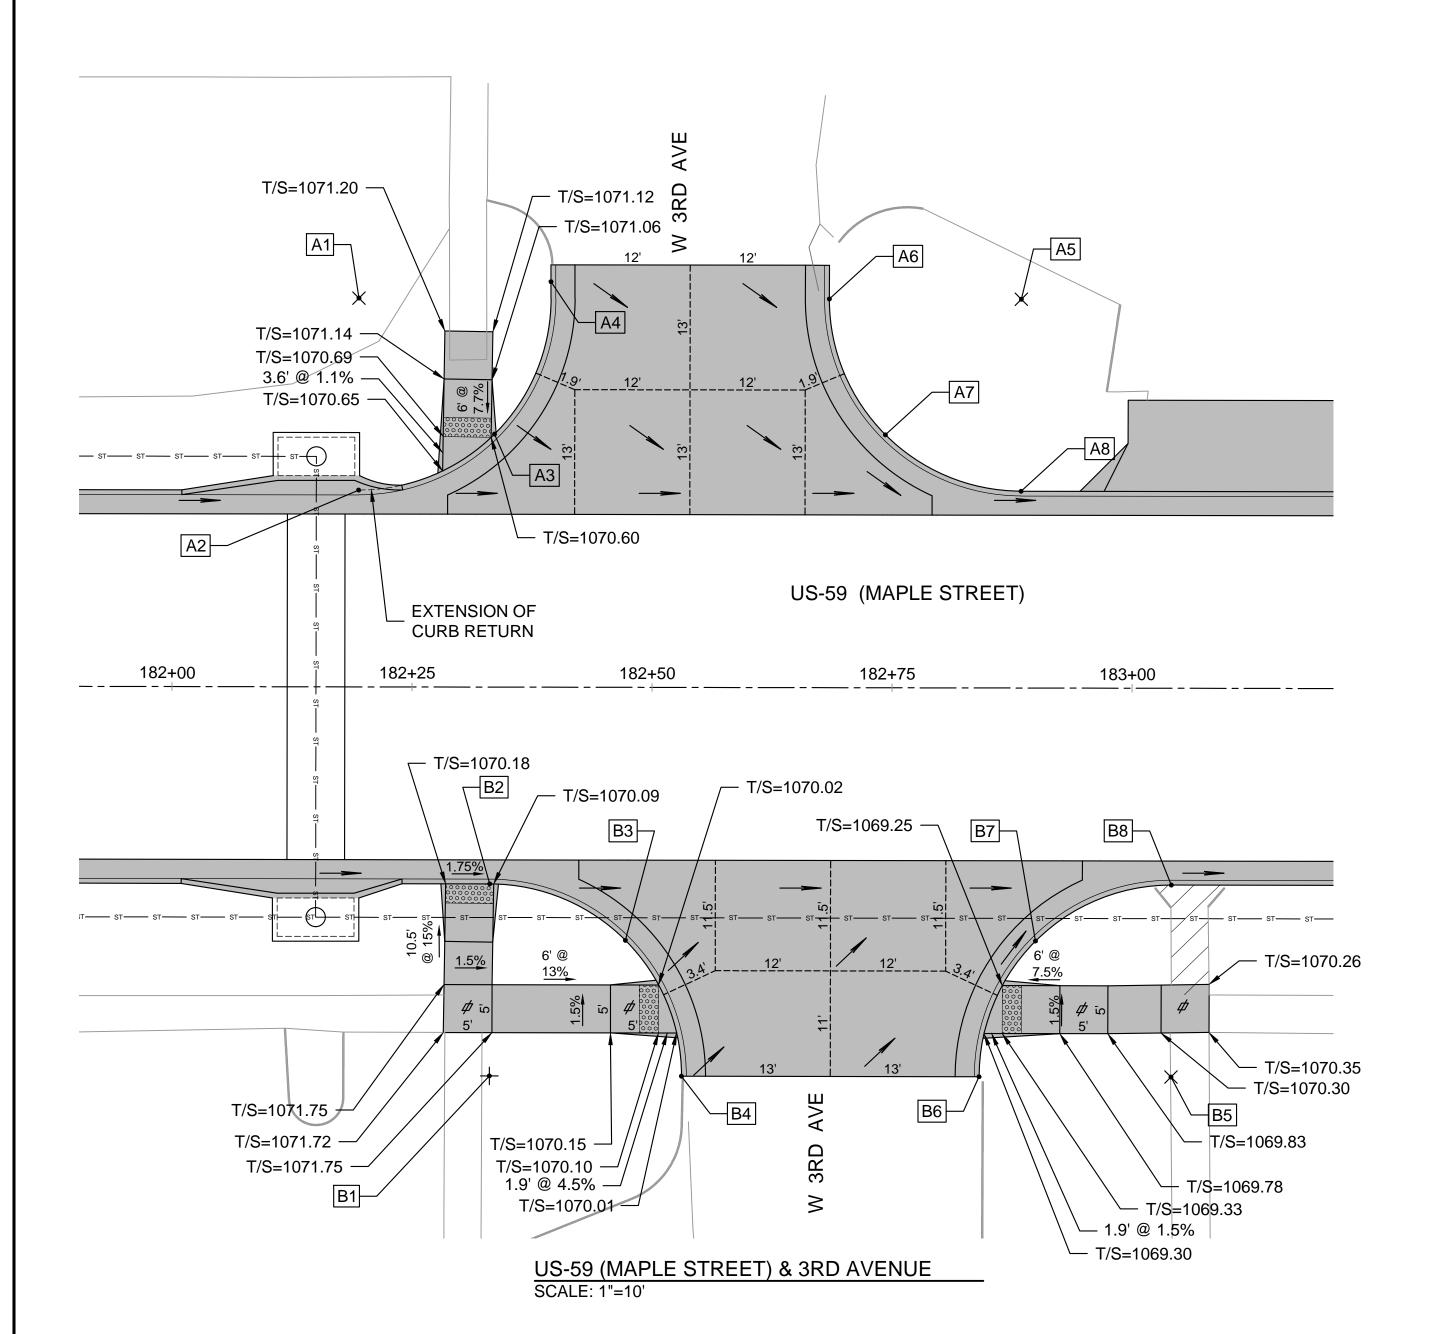


POINT	STATION	SIDE	NORTHING	EASTING	T/C ELEV.	REMARKS
A1	182+19.40	40.50' Lt.	1,916,931.424	2,245,404.758	N/A	Radius Point
A2	182+19.40	20.50' Lt.	1,916,932.018	2,245,424.749	1,070.73	ECR
A3	182+33.55	26.36' Lt.	1,916,945.980	2,245,418.474	1,071.00	MP
A4	182+39.40	40.50' Lt.	1,916,951.415	2,245,404.164	1,071.25	ECR
A5	182+88.40	40.50' Lt.	1,917,000.394	2,245,402.709	N/A	Radius Point
A6	182+68.40	40.50' Lt.	1,916,980.402	2,245,403.303	1,071.19	ECR
A7	182+74.26	26.36' Lt.	1,916,986.678	2,245,417.265	1,070.50	MP
A8	182+88.40	20.50' Lt.	1,917,000.988	2,245,422.701	1,069.59	ECR


POINT	STATION	SIDE	NORTHING	EASTING	T/C ELEV.	REMARKS
B1	182+33.13	40.50' Rt.	1,916,947.550	2,245,485.315	N/A	Radius Point
B2	182+33.13	20.50' Rt.	1,916,946.956	2,245,465.324	1,070.49	ECR
В3	182+47.27	26.36' Rt.	1,916,961.266	2,245,470.759	1,070.45	MP
B4	182+53.13	40.50' Rt.	1,916,967.541	2,245,484.721	1,070.35	ECR
B5	183+04.13	40.50' Rt.	1,917,018.518	2,245,483.207	N/A	Radius Point
B6	182+84.13	40.50' Rt.	1,916,998.527	2,245,483.801	1,069.75	ECR
B7	182+89.99	26.36' Rt.	1,917,003.963	2,245,469.491	1,069.60	MP
B8	183+04.13	20.50' Rt.	2,245,469.491	2,245,463.216	1,069.37	ECR

STATE	PROJECT NO.	YEAR	SHEET NO.	TOTAL SHEETS
KANSAS	59-2 KA-5422-01	2022	8	69



POINT	STATION	SIDE	NORTHING	EASTING	T/C ELEV.	REMARKS
C1	186+15.00	40.50' Rt.	1,917,329.250	2,245,473.976	N/A	Radius Point
C2	186+15.00	20.50' Rt.	1,917,328.656	2,245,453.985	1,064.52	ECR
C3	186+29.14	26.36' Rt.	1,917,342.966	2,245,459.420	1,064.28	MP
C4	186+35.00	40.50' Rt.	1,917,349.241	2,245,473.382	1,063.86	ECR
C5	186+85.00	40.50' Rt.	1,917,399.219	2,245,471.898	N/A	Radius Point
C6	186+65.00	40.50' Rt.	1,917,379.228	2,245,472.491	1,063.74	ECR
C7	186+70.86	26.36' Rt.	1,917,384.663	2,245,458.182	1,063.64	MP
C8	186+85.00	20.50' Rt.	1,917,398.625	2,245,451.906	1,062.54	ECR

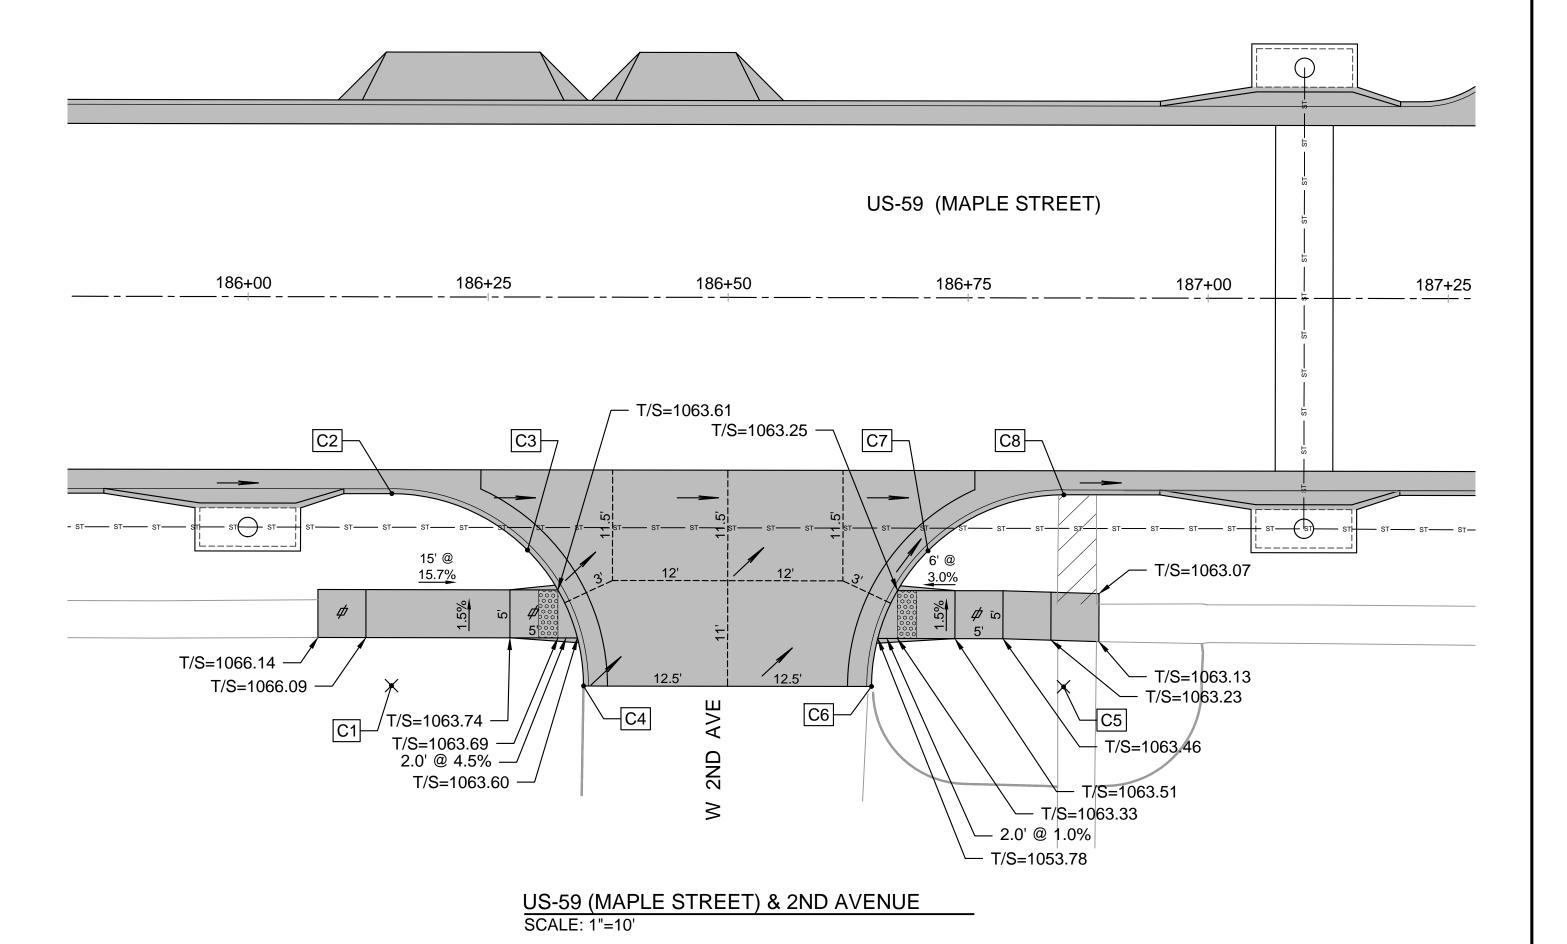

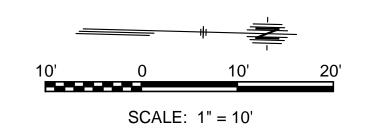

KANSAS DEPARTMENT OF TRANSPORTATION

INTERSECTION DETAILS

GENERAL NOTES

189+25

ALL TOP OF CURB ELEVATIONS ON THIS SHEET ARE FOR "CURB AND GUTTER - TYPE I".
THE CONTRACTOR SHALL BE RESPONSIBLE FOR ADJUSTING THE HEIGHT OF THE CURB AT LOCATIONS WHERE "CURB AND GUTTER - TYPE II" OR OTHER TYPES OF CURB AND GUTTER ARE TO BE CONSTRUCTED.

= LEVEL AREA IN THE SIDEWALK/SIDEWALK RAMP ALIGNMENT WHICH SHALL BE SLOPED TO MAINTAIN POSITIVE DRAINAGE, BUT IN NO CASE SHALL THE SLOPE EXCEED 2.00% MEASURED IN ANY DIRECTION. SEE THE ACCESS RAMP CONSTRUCTION DETAILS FOR MORE INFORMATION.

WHERE NEW CONCRETE SIDEWALK ABUTS EXISTING SIDEWALKS, THE TIE-IN LOCATION SHALL BE FLUSH. NO VERTICAL DISCONTINUITIES WILL BE ALLOWED.

FIELD VERIFY THAT THAT A COUNTER SLOPE OF 5% OR FLATTER IS USED AT THE BASE OF CURB RAMPS (PER RD725) AND THAT INDICATED DRAINAGE PATTERNS ARE MAINTAINED.

189+50

SCALE: 1" = 10'

LEGEND

PROPOSED DIRECTION OF SURFACE DRAINAGE

- 10' - PROPOSED CONTRACTION JOINT & JOINT LENGTH

ECR END OF CURB RETURN

QP QUARTER-POINT OF CURB RETURN

MP MID-POINT OF CURB RETURN

T/C TOP OF CURB (TYPE CG1 CURB AND GUTTER)


P TOP OF PAVEMENT

T/R TOP OF RAMP

TOP OF SIDEWALK
PROPOSED CONCRETE

190+25

POINT	STATION	SIDE	NORTHING	EASTING	T/C ELEV.	REMARKS
D1	189+31.85	40.50' Lt.	1,917,643.557	2,245,383.603	N/A	Radius Point
D2	189+31.85	20.50' Lt.	1,917,644.151	2,245,403.595	1,055.38	ECR
D3	189+45.99	26.36' Lt.	1,917,658.113	2,245,397.319	1,055.40	MP
D4	189+51.85	40.50' Lt.	1,917,663.548	2,245,383.010	1,055.66	ECR
D5	189+95.85	40.50' Lt.	1,917,707.529	2,245,381.703	N/A	Radius Point
D6	189+75.85	40.50' Lt.	1,917,687.537	2,245,382.297	1,055.00	ECR
D7	189+81.71	26.36' Lt.	1,917,693.813	2,245,396.259	1,054.70	MP
D8	189+95.85	20.50' Lt.	1,917,708.122	2,245,401.694	1,054.28	ECR

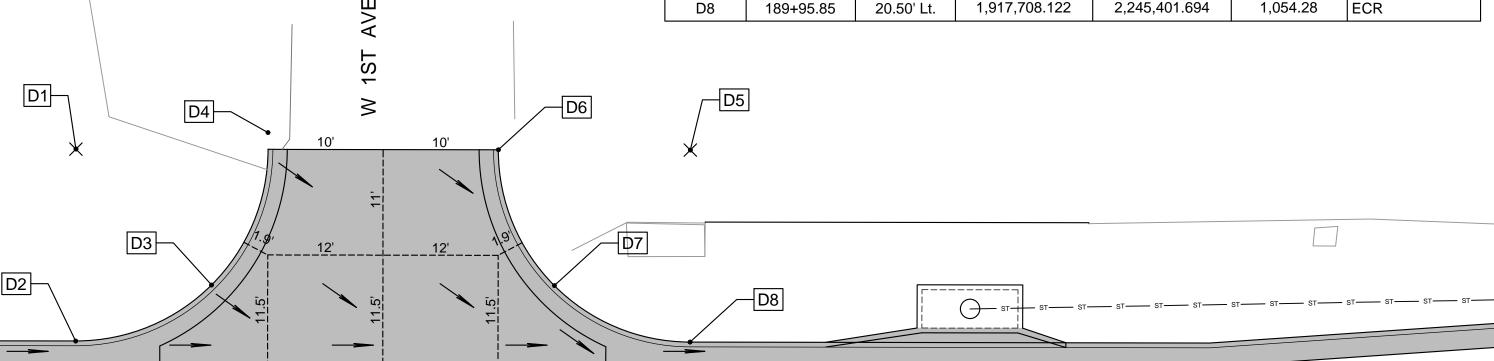


190+00

US-59 (MAPLE STREET)

190+50

190+75

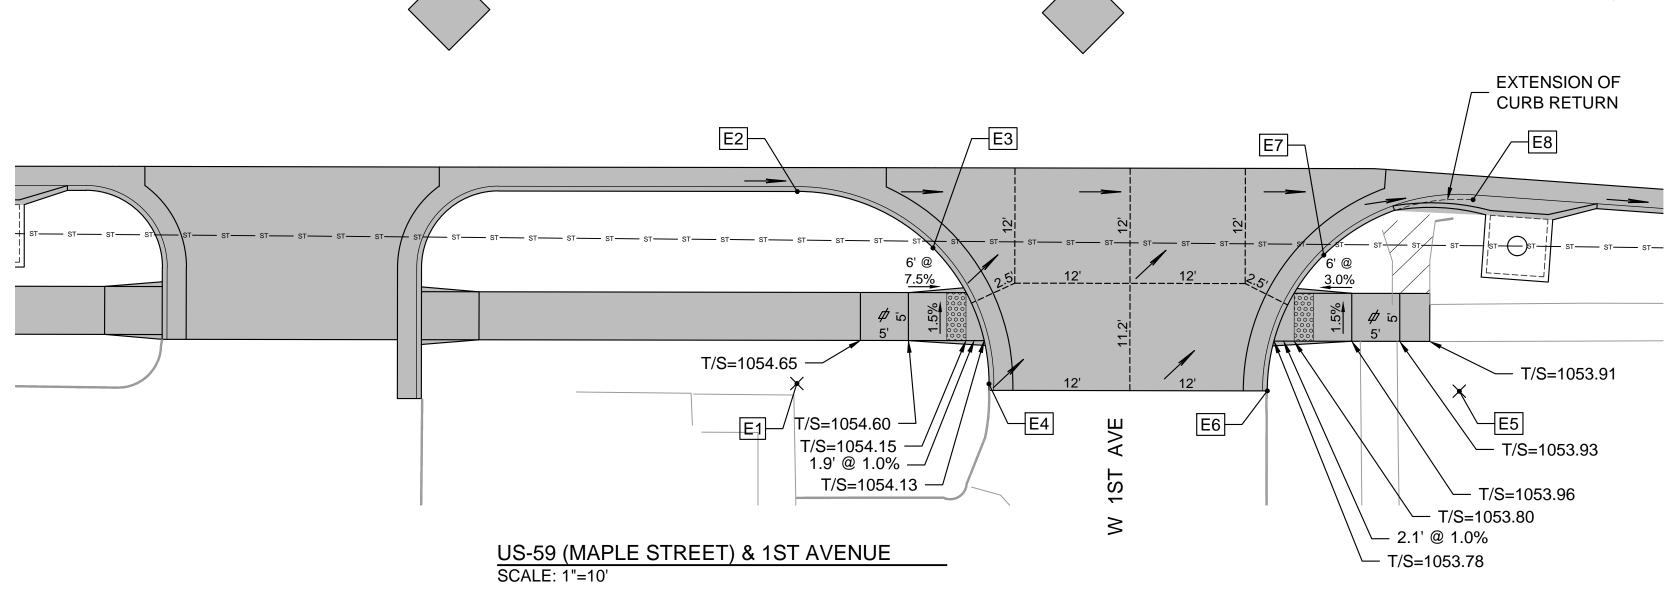

189+75

POINT	STATION	SIDE	NORTHING	EASTING	T/C ELEV.	REMARKS
E1	189+90.01	40.50' Rt.	1,917,704.091	2,245,462.841	N/A	Radius Point
E2	189+90.01	20.50' Rt.	1,917,703.497	2,245,442.850	1,054.35	ECR
E3	190+04.15	26.36' Rt.	1,917,717.807	2,245,448.285	1,054.40	MP
E4	190+10.01	40.50' Rt.	1,917,724.082	2,245,462.247	1,054.60	ECR
E5	190+59.01	40.50' Rt.	1,917,773.081	2,245,461.471	N/A	Radius Point
E6	190+39.01	40.50' Rt.	1,917,753.090	2,245,462.065	1,054.30	ECR
E7	190+45.37	26.36' Rt.	1,917,759.013	2,245,447.255	1,054.00	MP
E8	190+60.40	20.50' Rt.	1,917,773.884	2,245,441.487	1,053.56	ECR

59-2 KA-5422-01 2022 9 69

BG CONSULTANTS
ENGINEERS ARCHITECTS ISLIBVEYORS

STATE

KANSAS

PROJECT NO.

YEAR SHEET NO. SHEETS


KANSAS DEPARTMENT OF TRANSPORTATION


INTERSECTION DETAILS

STATE PROJECT NO. YEAR SHEET NO. TOTAL SHEETS

KANSAS 59-2 KA-5422-01 2022 10 69




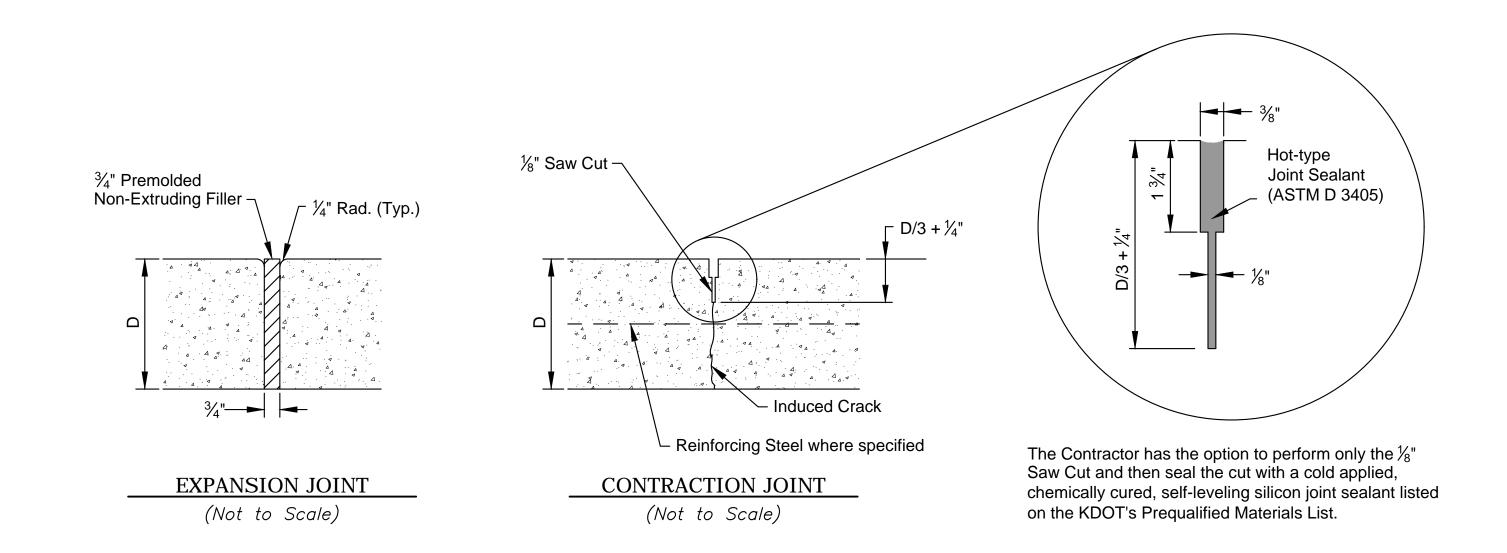

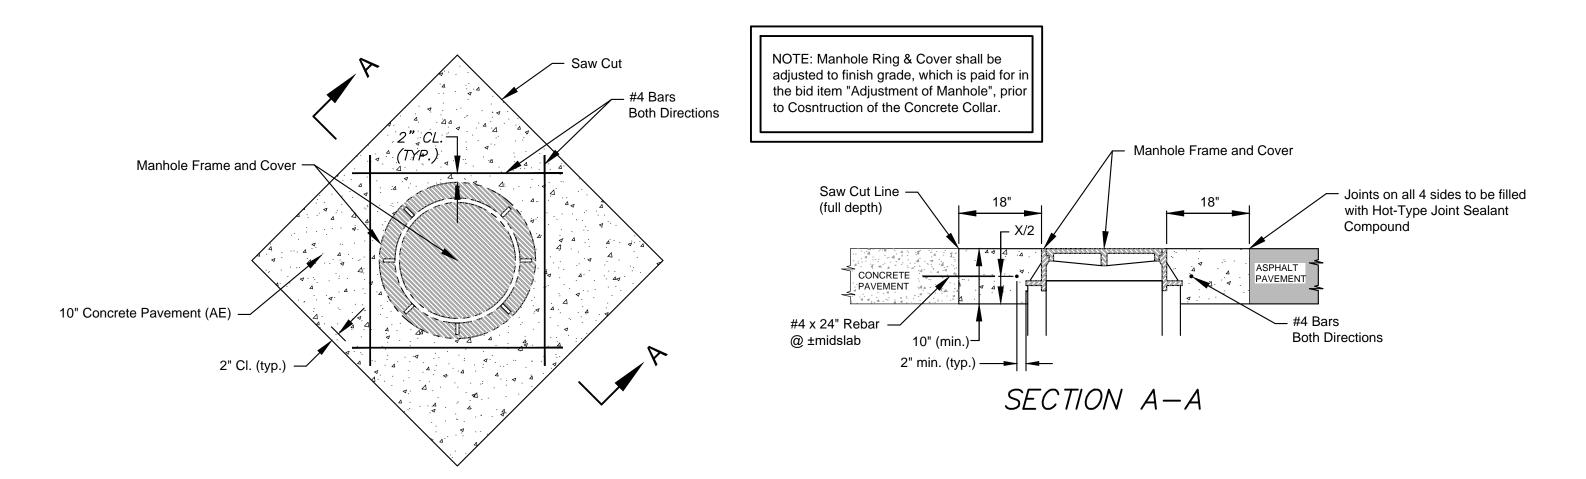

CONCRETE MANHOLE COLLAR DETAIL (NOT TO SCALE)

NOTE: Contractor has the option to use High-Early strength concrete pavement for Concrete Manhole Collar(s) at no additional expense to the Owner (KDOT).

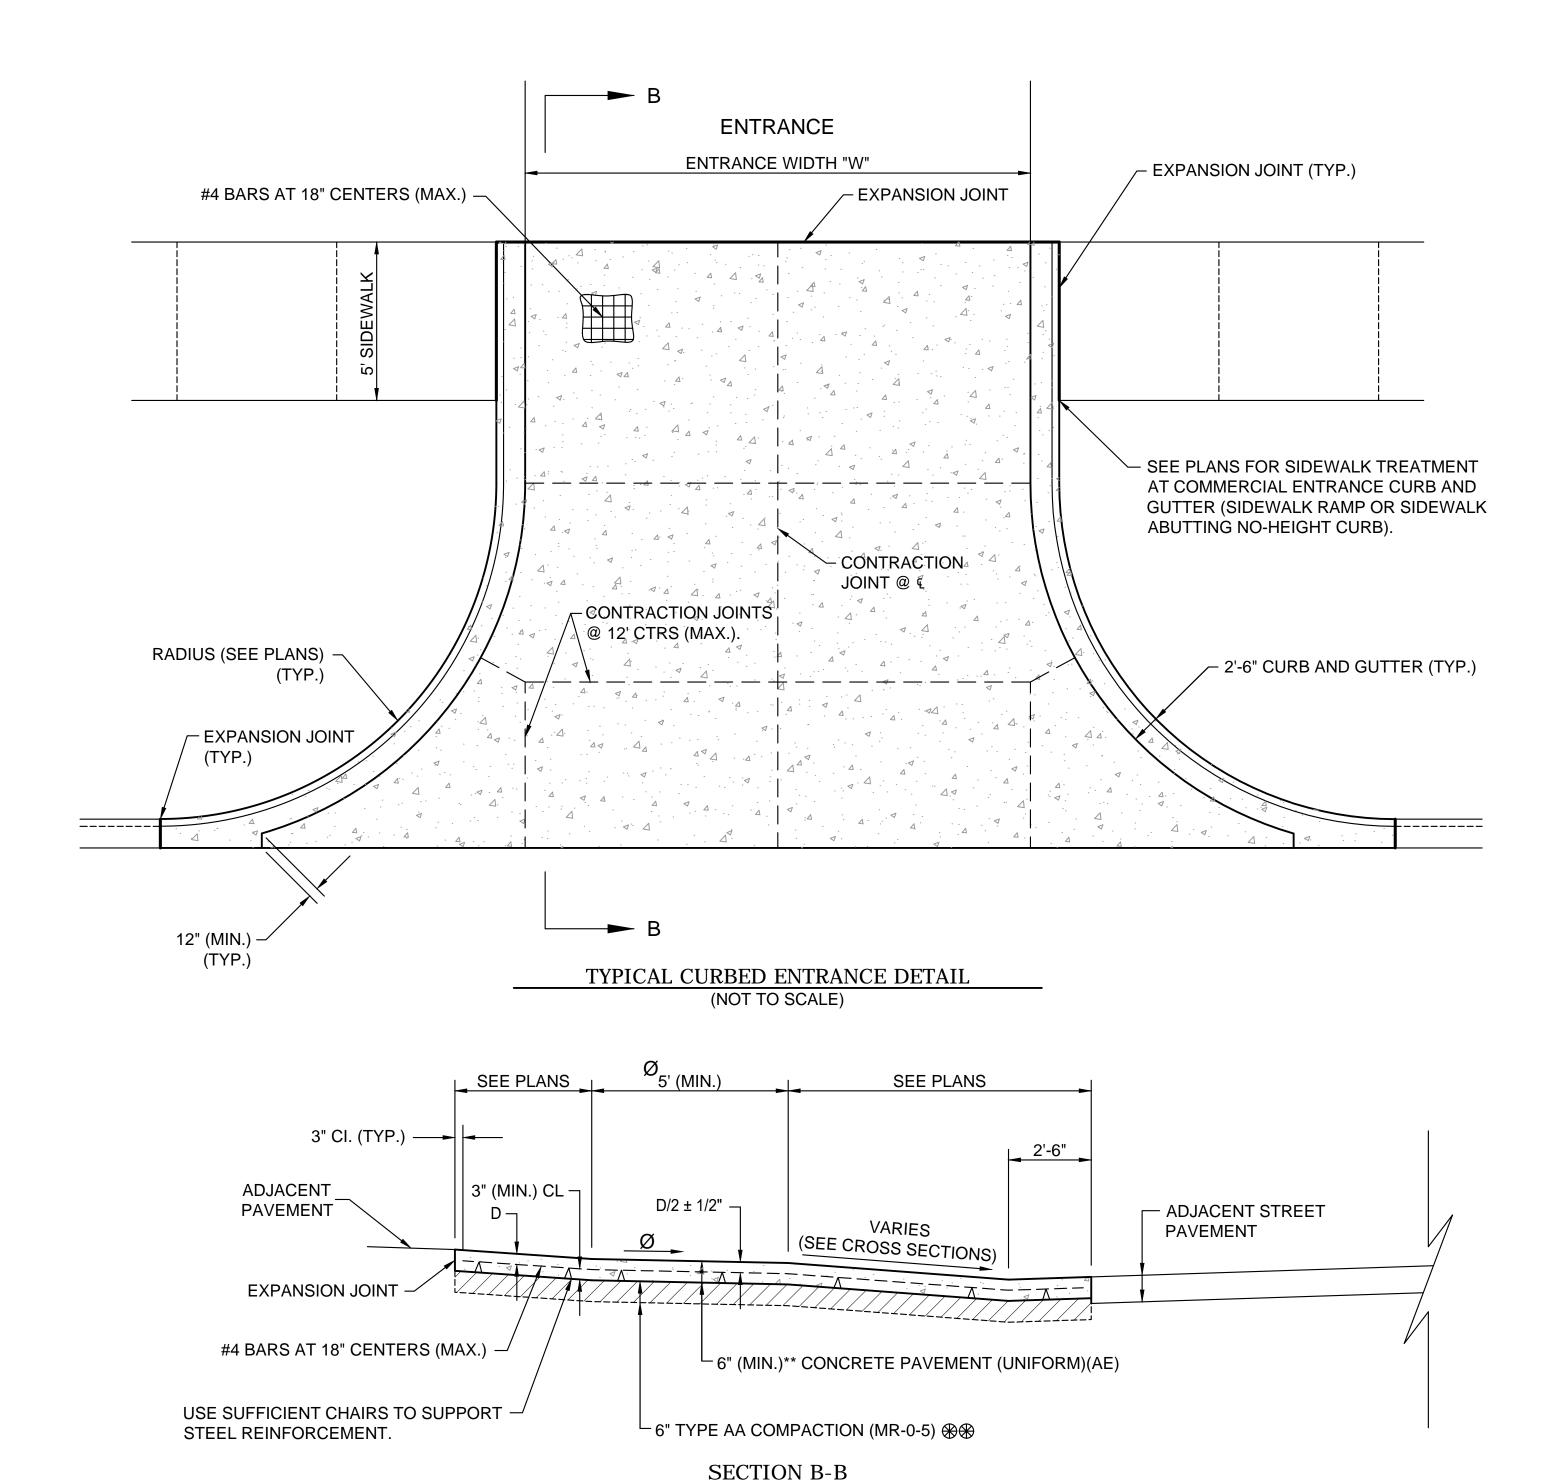


** 6" FOR RESIDENTIAL ENTRANCES 8" FOR ALLEY AND COMMERCIAL ENTRANCES

(NOT TO SCALE)

** IN CUT AREAS, COMPACTION OF THIS LAYER SHALL BE CONSIDERED SIMILAR TO FOUNDATION TREATMENT AND SHALL BE SUBSIDIARY.

KANSAS DEPARTMENT OF TRANSPORTATION

CURBED ENTRANCE DETAILS AND MISCELLANEOUS PAVEMENT DETAILS

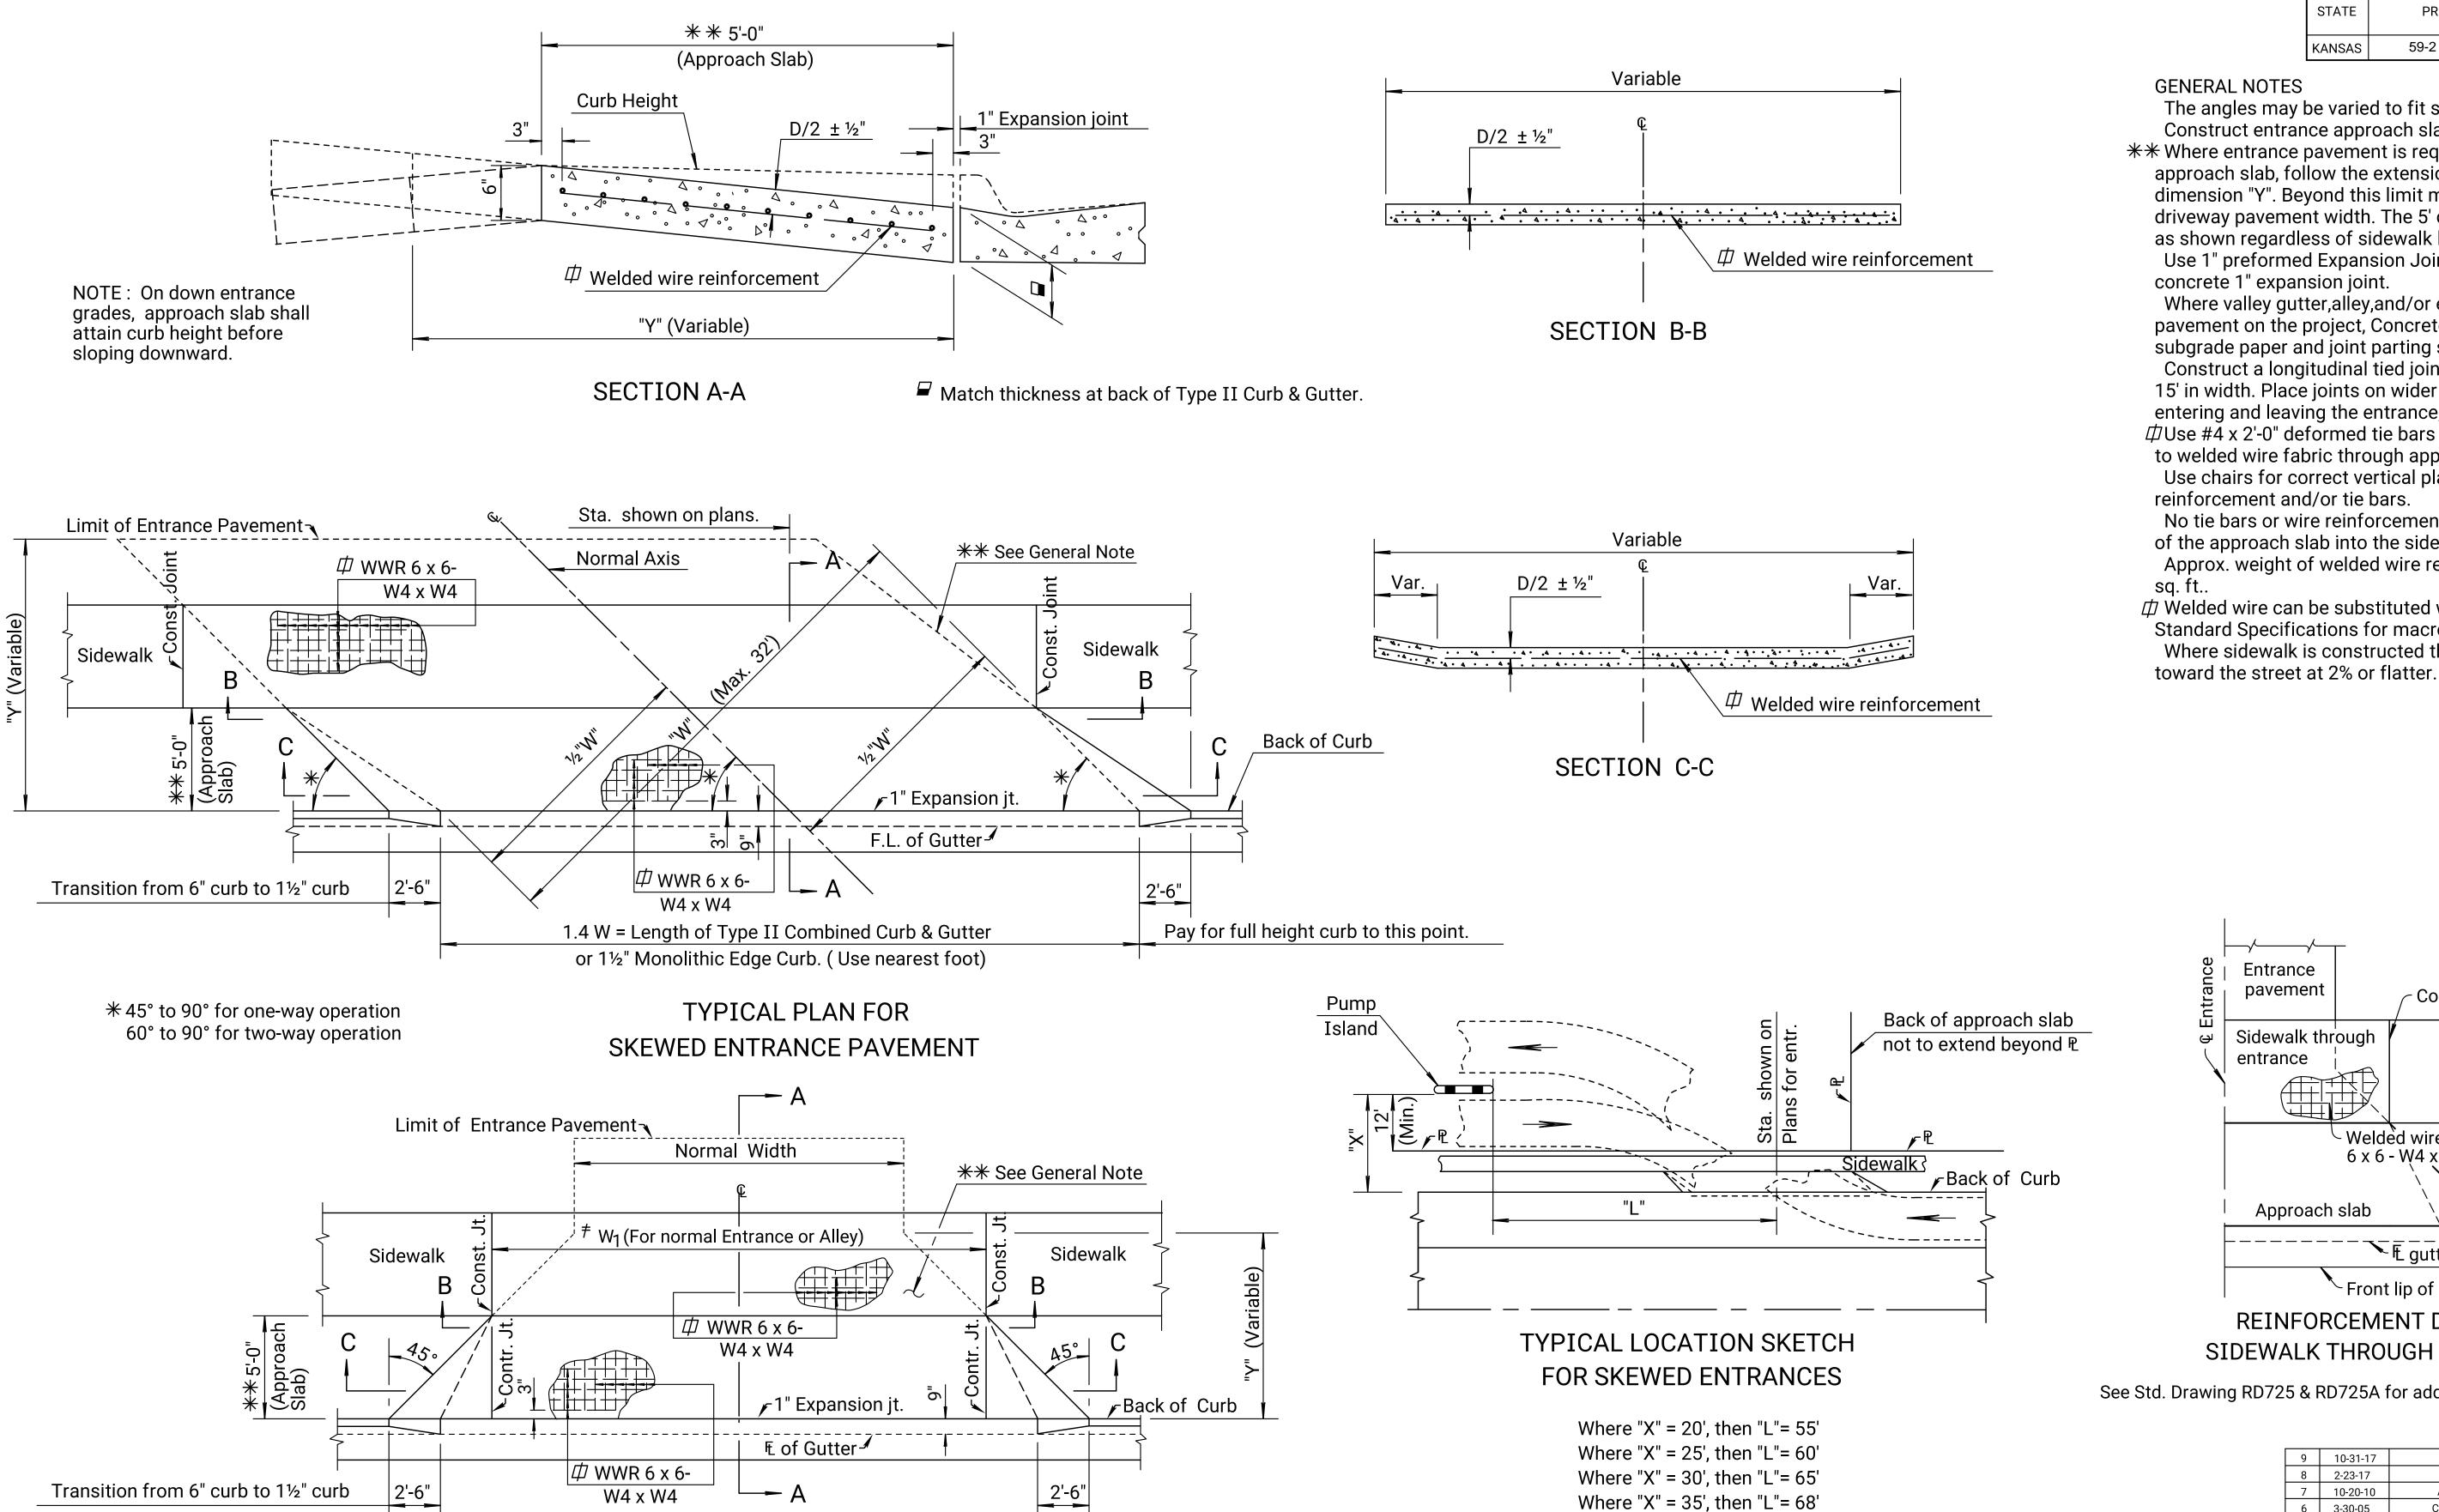

YEAR SHEET NO. SHEETS STATE PROJECT NO. 2022 11 59-2 KA-5422-01 KANSAS

GENERAL NOTES

The angles may be varied to fit special conditions. Construct entrance approach slab unless otherwise shown.

** Where entrance pavement is required to extend beyond the 5' approach slab, follow the extension lines shown to the limit of dimension "Y". Beyond this limit match normal alley or entrance driveway pavement width. The 5' concrete approach slab is shaped as shown regardless of sidewalk location.

Use 1" preformed Expansion Joint Filler (Type B or C) for concrete 1" expansion joint.

Where valley gutter, alley, and/or entrance pavement is the only pavement on the project, Concrete Grade 3.0 (AE) may be used, subgrade paper and joint parting strips are not required.

Construct a longitudinal tied joint at W/2 on slabs greater than 15' in width. Place joints on wider slabs to help guide vehicles entering and leaving the entrance, minimum joint spacing is 6 feet. ФUse #4 x 2'-0" deformed tie bars @ 12" spacing as an alternate to welded wire fabric through approach slab joints.

Use chairs for correct vertical placement of welded wire reinforcement and/or tie bars.

No tie bars or wire reinforcement should extend through the joint of the approach slab into the sidewalk or alley.

Approx. weight of welded wire reinforcement = 58 lbs. per 100

☐ Welded wire can be substituted with a macro fiber. See KDOT Standard Specifications for macro fiber and dosage requirements. Where sidewalk is constructed through an entrance slope sidewalk

> © | Entrance pavement Construction joint Sidewalk through Normal sidewalk - Welded wire reinforcement 6 x 6 - W4 x W4 - Back of curb Approach slab E gutter Front lip of gutter REINFORCEMENT DIAGRAM

SIDEWALK THROUGH ENTRANCE

See Std. Drawing RD725 & RD725A for additional sidewalk details.

9	10 21 17	Joint Filler T	una C Addad	A L D	S.W.K.	1			
- -	10-31-17	<u> </u>		A.L.R.		ł			
8	2-23-17	Rev. Ge	en. Note	T.T.R.	S.W.K.				
7	10-20-10	Add. macro fibe	er opt., General note	S.W.K.	J.O.B.	1			
6	3-30-05	Changed Class t	o Grade conc., mesh	S.W.K.	J.O.B.				
NO. DATE REVISIONS BY APP'D									
RD726 FHWA APPROVAL 3-5-18 APP'D. SCOTT W. KING DESIGNED DETAILED QUANTITIES TRACED									
RDZ FHWA Z DESIGN	726 APPROVAL	3-5-18 DETAILED	APP'D. SCOTT W. QUANTITIES	KING TRACED		ľ			
RD7	726 APPROVAL	3-5-18	APP'D. SCOTT W. QUANTITIES	KING		ľ			

NORMAL ENTRANCE PAVEMENT

Pay for full height

curb to this point.

"W" + 5' = Length of Type II Combined Curb &

Gutter or 1½" Monolithic Edge Curb

TYPICAL PLAN FOR


* Note: Value of "W" for Normal entrance.


16' min. for Alley.


40' max.

13' min. for Private entrance.

Where "X" = 40', then "L"= 70'

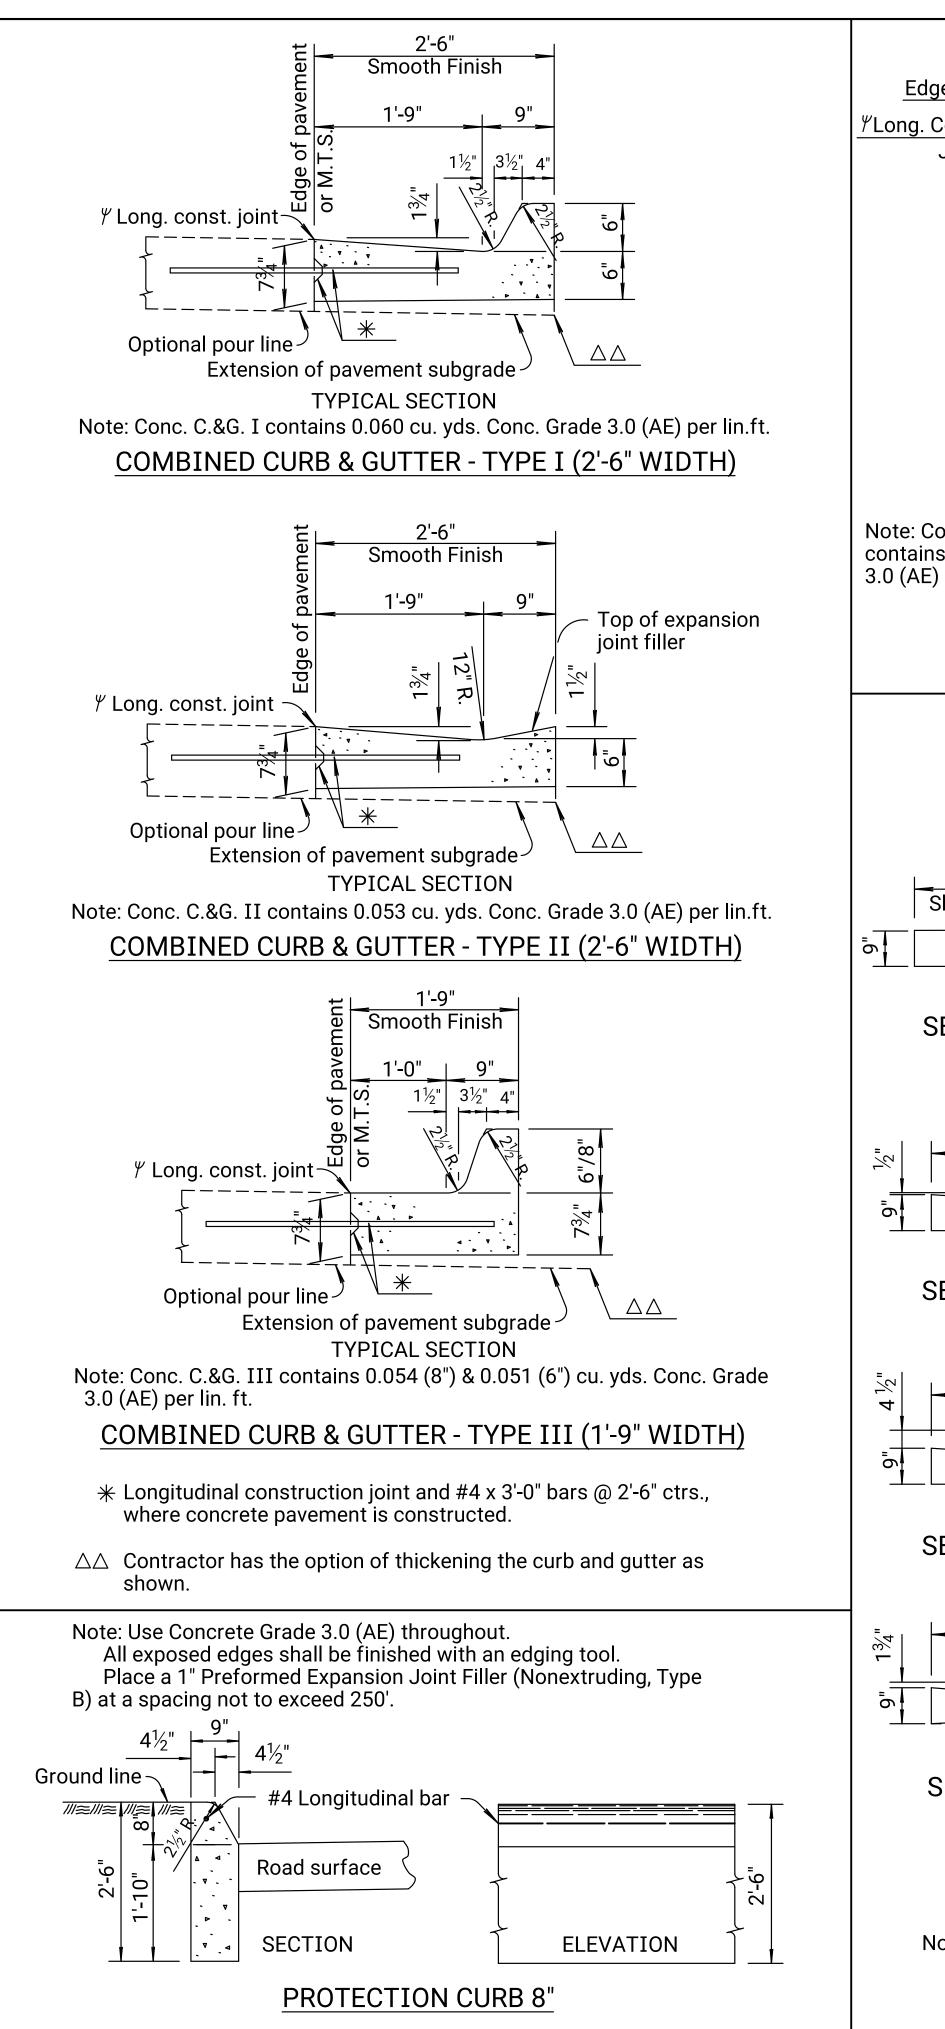

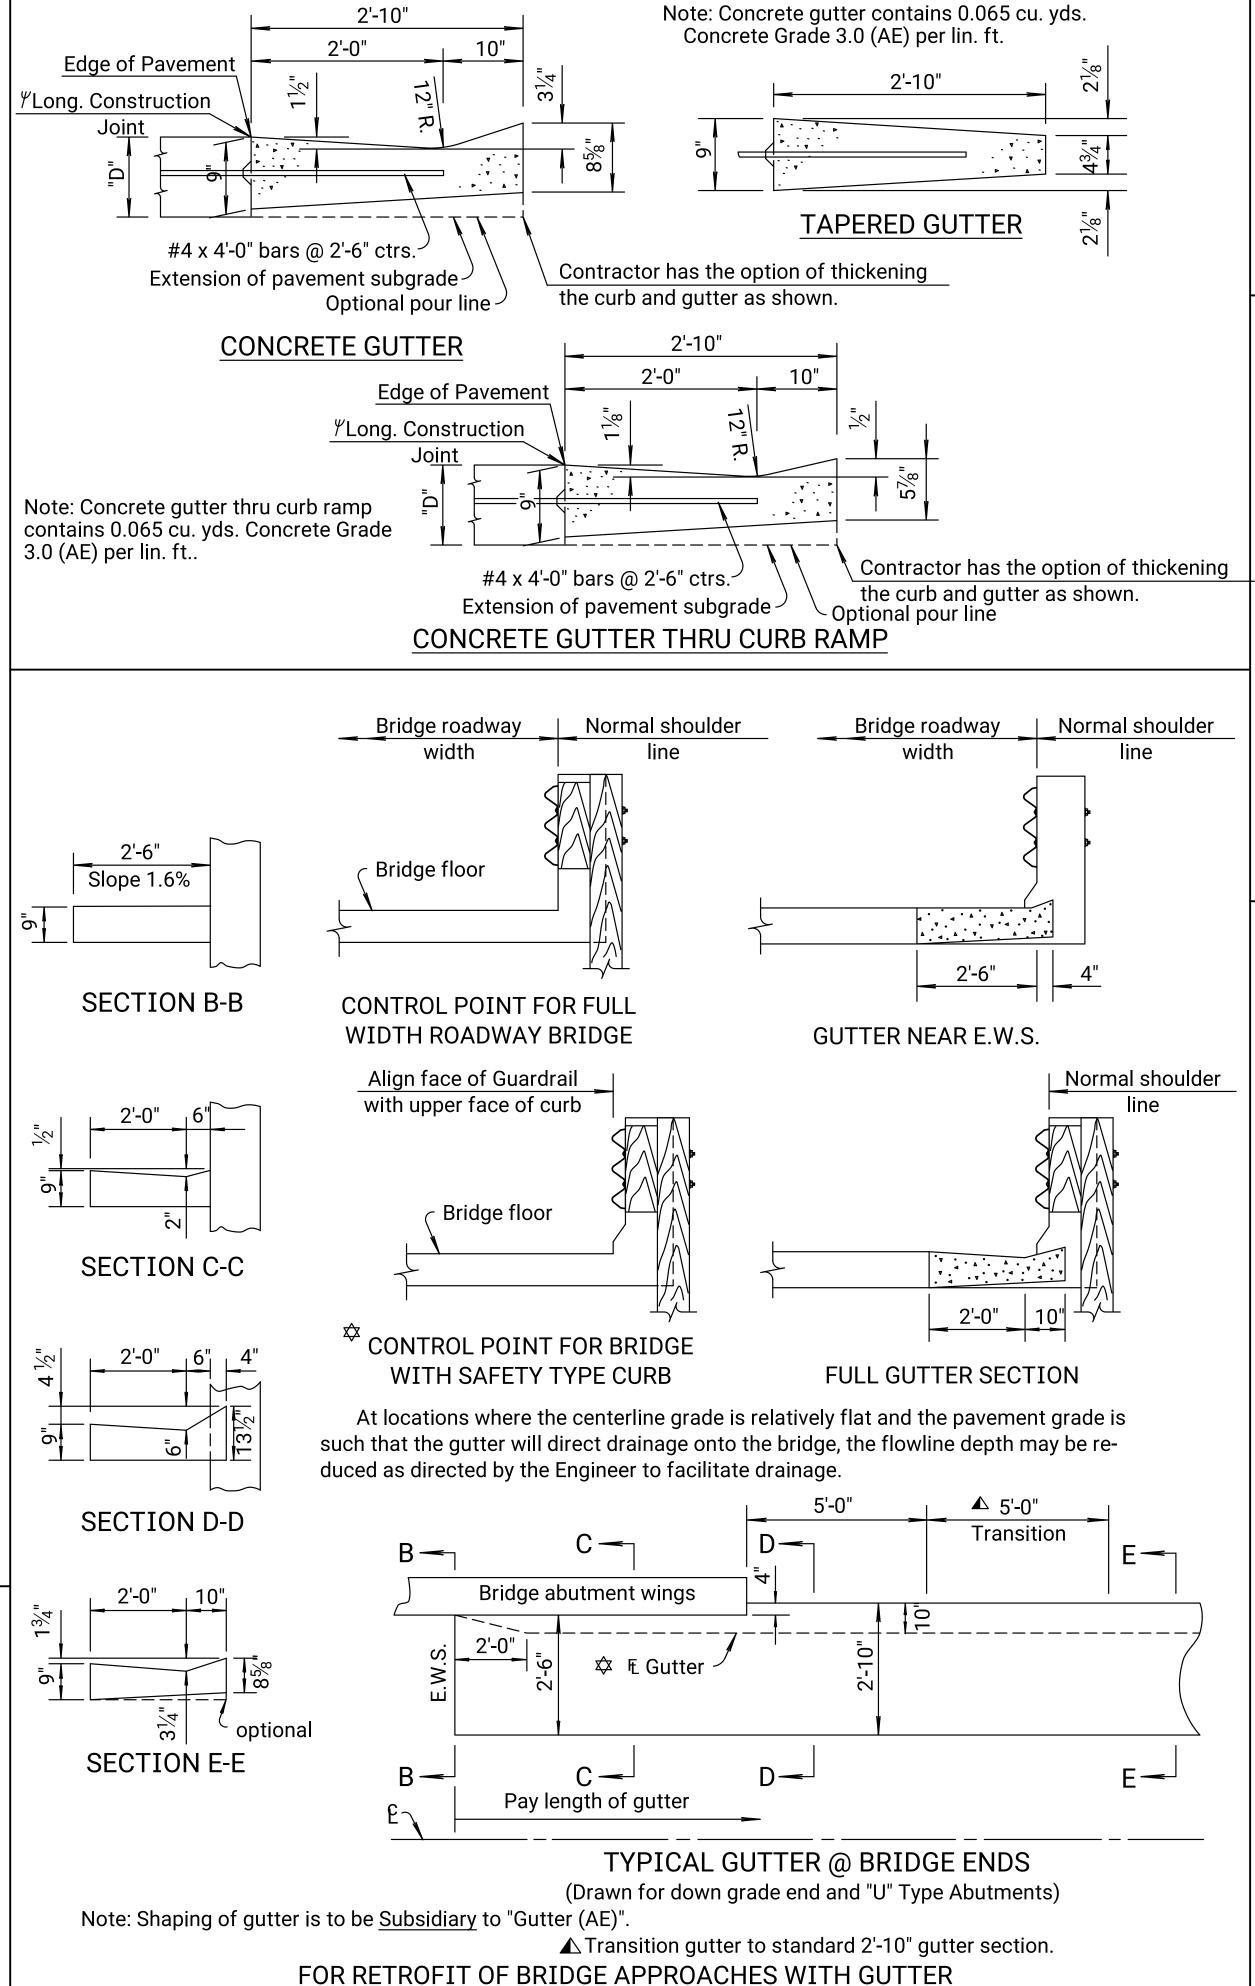

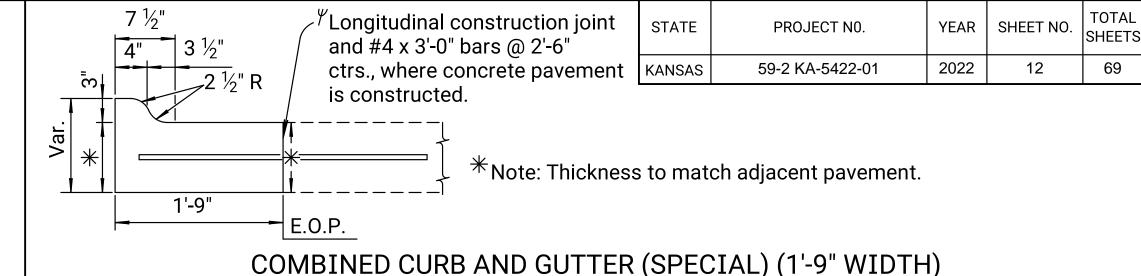

GENERAL NOTE

Combined curb and gutter or gutter adjoining concrete pavement may, at the contractor's option, be constructed either monolithically or separately, using either the mix used in the concrete pavement or Concrete Grade 3.0 (AE). The combined curb and gutter or gutter shall have the same section as shown on the plans. If constructed monolithically, the longitudinal joint and tie bars shall be omitted from the combined curb and gutter or gutter. Pavement Joints shall be continued through curb or gutter and no other planes of weakness will be required. Joints in the combined curb and gutter or gutter are to be filled with the same material as used for the pavement joints.

Expansion joints in the combined curb and gutter are to be placed opposite expansion joints in the pavement

Where combined curb and gutter or gutter does not abut concrete pavement or concrete base course, omit tie bars and place a 1" Preformed Expansion Joint Filler (Type B) cut to the dimensions of the combined curb and gutter or gutter, at a spacing not to exceed 250' and at the ends of curb returns. Planes of weakness shall be constructed at 10'-0" intervals.


A 4' length of transition from normal gutter section to the tapered gutter section shall be used at the ends of each run of gutter except where the gutter abuts a curb, such as at the end of a bridge. Inlets shall be located so as not to fall within this transition section.

Where pressure relief joint is placed across the pavement, and gutter or curb and gutter is continued on for more than 10', use 4"x4" membrane sealant installed with bonding adhesive through gutter section, shaped to fit gutter or curb and gutter. See Std. Drawing RD712.

For expansion joint treatment where combined curb and gutter or gutter abuts a bridge wing on a U-type abutment see bridge drawings.

Longitudinal joints shall be sawed and sealed with joint sealant, see Standard Specifications.

 γ If constructed monolithically, the longitudinal joint is not required.

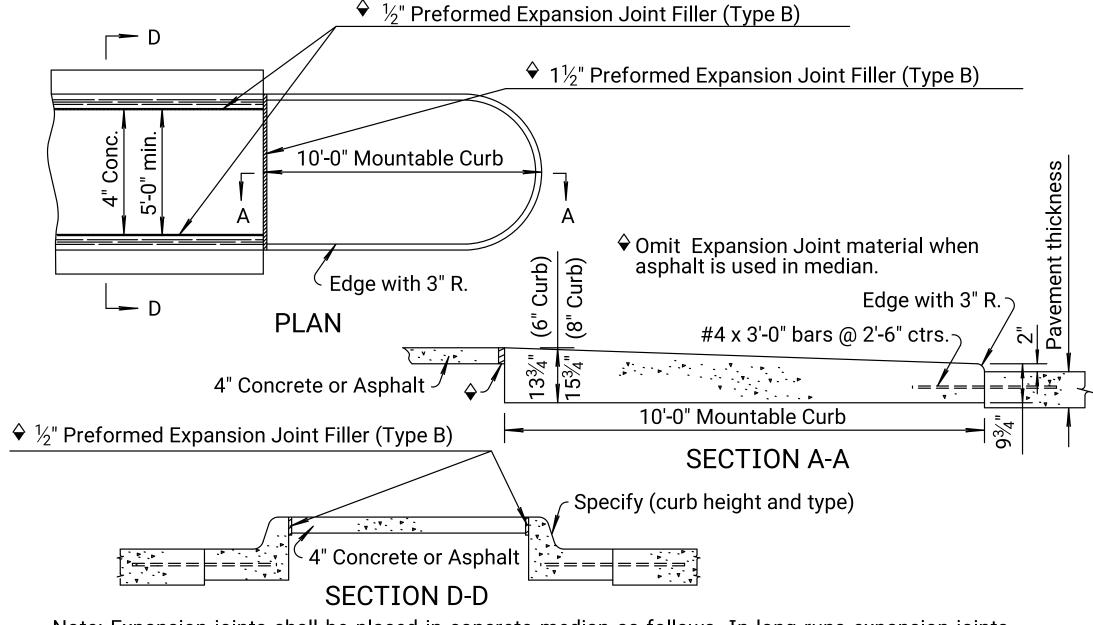

Note: Expansion joints shall be placed in concrete median as follows. In long runs expansion joints Expansion joints in the median shall match expansion joints in the curb and gutter with a maximum spacing of 125'. Plane of weakness in the median shall match plane of weakness in curb and gutter.

TYPICAL NOSE DETAILS FOR RAISED MEDIANS

20 19	2-23-17 1-29-13	Det., Conc. Gutter Thru Curb Ramp Added Detail, Comb. C&G (Sp.)	T.T.R. S.W.K.	S.W.K. J.O.B.					
18	8-13-12	Revised General Note	S.W.K.	J.O.B.					
17	7-2-09	Rev. nose details, jt. sealant & retro.	S.W.K.	J.O.B.					
NO.	DATE	REVISIONS	BY	APP'D					
KANSAS DEPARTMENT OF TRANSPORTATION									
CURB, GUTTER									
		AND							

APP'D. SCOTT W. KING


TRACED TRACE CK.


RD635 FHWA APPROVAL

KDOT Graphics Certified 08-22-2019

Note: Additional Concrete Grade 3.0 (AE) needed to complete median nose shall be subsidiary to the bid item "Combined Curb & Gutter".



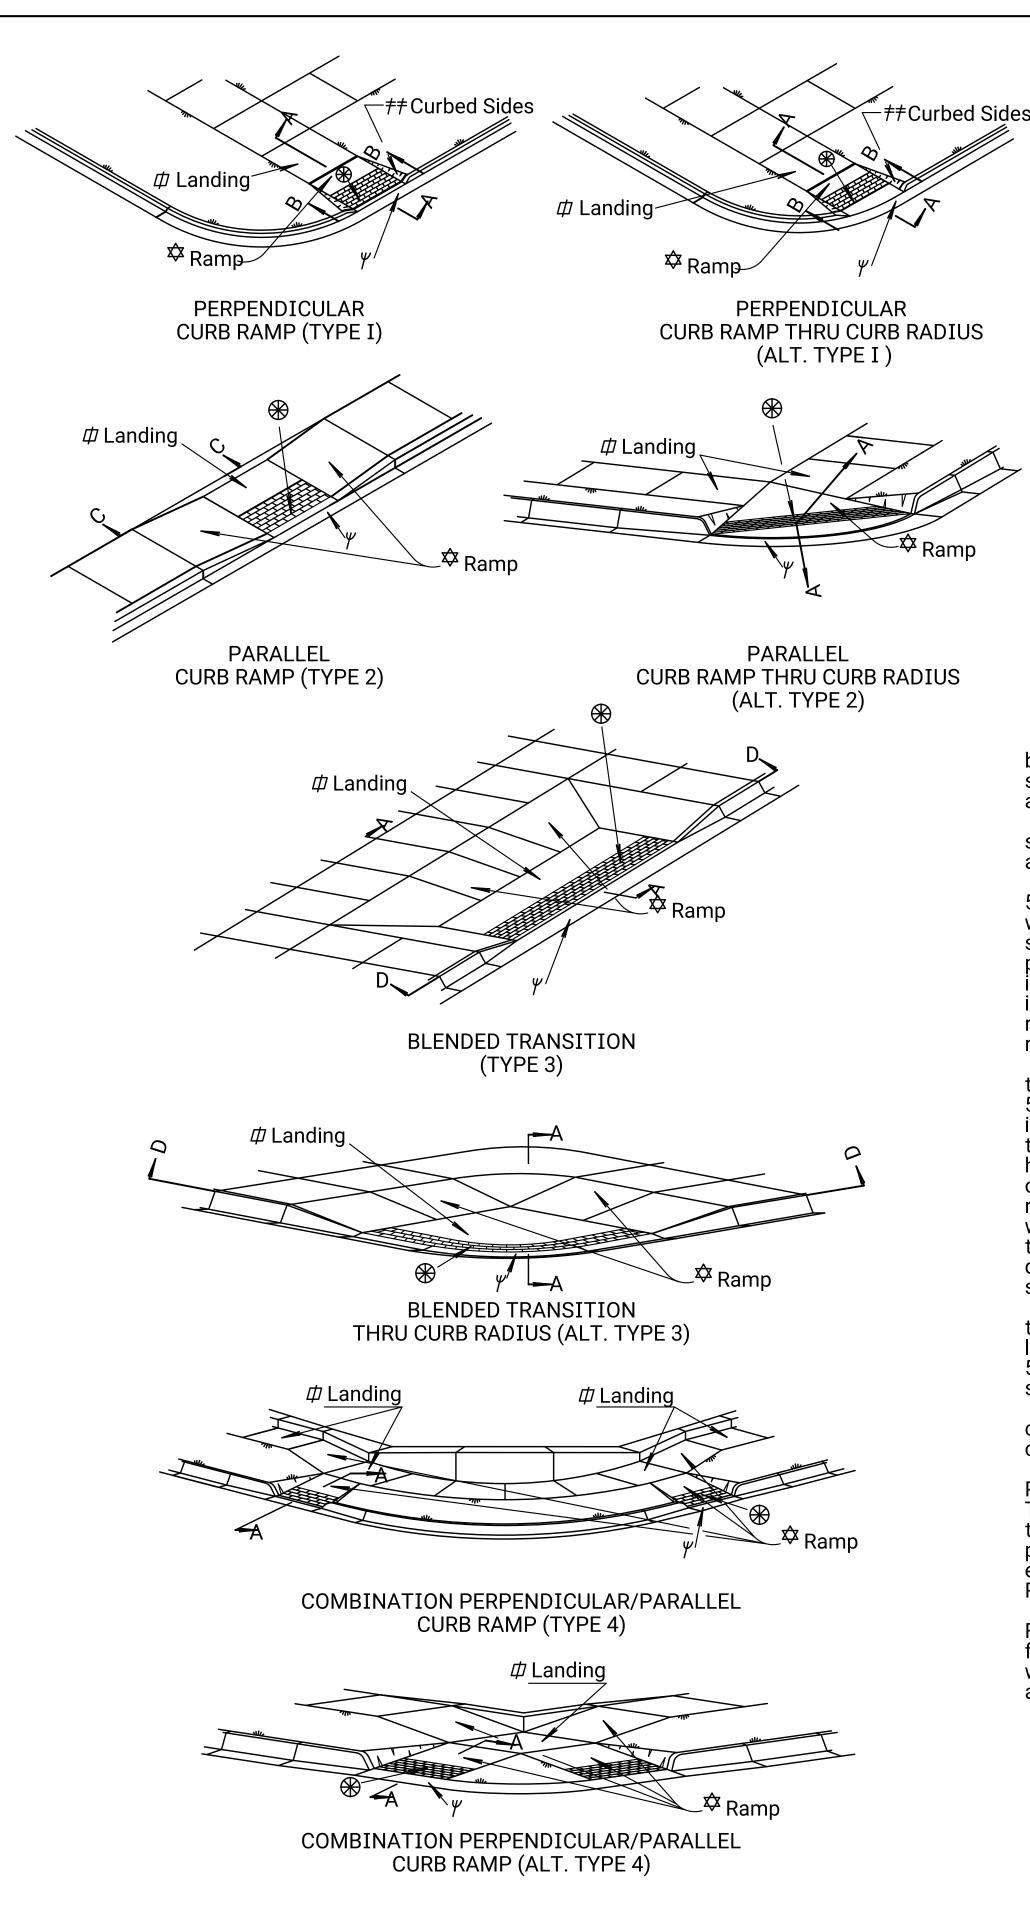

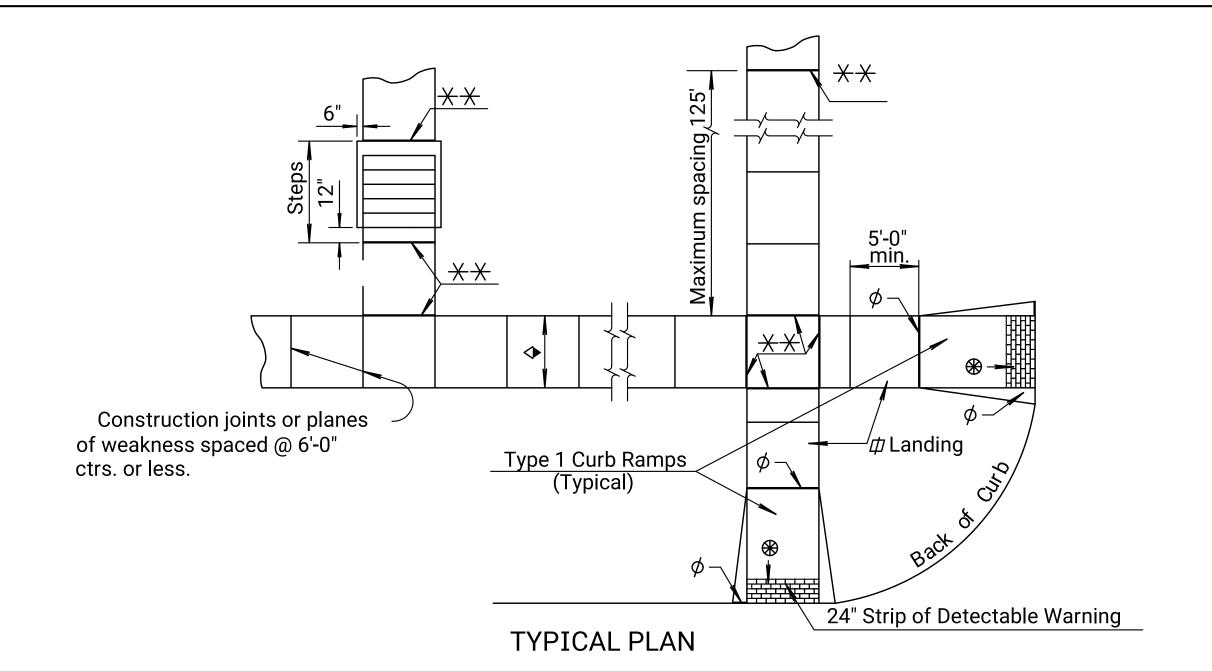

\$\phi\$ Expansion Joint (\frac{3}{4}" Redwood board) placed at either back of curb line, at sidewalk back of curb line, or at sidewalk line. Alternate expansion joint material may be used as approved by the Engineer.

X Expansion joint (3/4" Redwood board) located as shown. Alternate expansion joint material may be used as approved by the Engineer.

The minimum width of newly constructed sidewalk is 5'-0". Where existing conditions prohibit the use of 5'-0" wide sidewalk, 4'-0" wide sidewalk may be used. Where sidewalk width is less than 5'-0" construct 5'-0" x 5'-0" passing spaces located at 200' intervals (max) as shown in the Passing Space Detail. In general, where new sidewalk is constructed parallel or adjacent to a roadway the sidewalk running slopes will match the grade of the adjacent roadway.


New construction ramp running slopes are 5% (min) to 8.3% (max). Ramp slopes for blended transitions are 5% or flatter. The maximum allowable ramp cross slope is 2% or flatter. Match the ramp width to the width of the approach sidewalk. Curb ramp lengths will vary with curb height. Curb ramp lengths are 5'-0" (min) to 15'-0" (max). All other ramp lengths are 5'-0" (min) to 30'-0" (max). Where roadway grades are relatively flat and curb ramp lengths will exceed 15'-0", ramps may be constructed in succession to tie into existing sidewalk. Maintain ramp slopes and dimensions as previously stated and install a landing between successive ramp runs.


☐ Use a landing slope of 2% or flatter. Landings are the same width as ramps and adjacent sidewalk with a length measured in the direction of the street crossing of 5'-0" (min). Landings are not required where the ramp running slope is 5% or flatter.

γUse a counter slope of 5% or flatter at the base of curb ramps. Refer to Standard Drawing RD725A for additional curb and gutter details.

Detectable warning installation is typical and required on Perpendicular Ramps (Type 1), Parallel Ramps (Type 2), Blended Transitions (Type 3), median ramp crossings with widths greater than or equal to 6'-0", and other locations as shown in the plans. Install detectable warnings parallel to pedestrian travel except where otherwise shown in the plans. See Standard Drawing RD725A for additional details.


Use flared sides in place of curbed sides as shown in Flared Side Alt. when not located adjacent to landscaping, street furniture, chains, fencing, or railing. Curbed sides are not permitted within the pedestrian access route. See PROWAG for pedestrian access route definition.

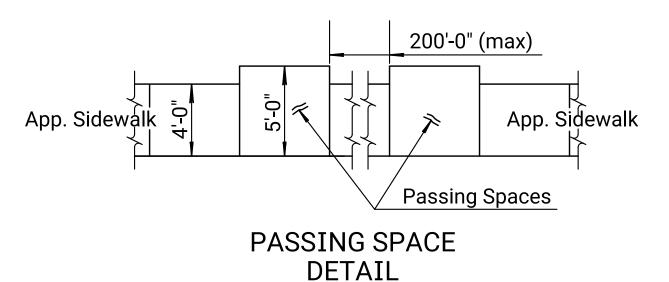


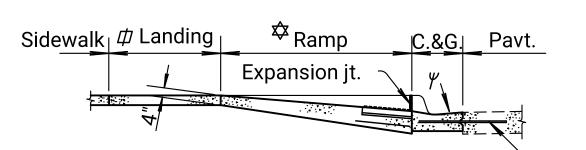


SECTION A-A

Reinforcement as in adjacent curb & gutter.

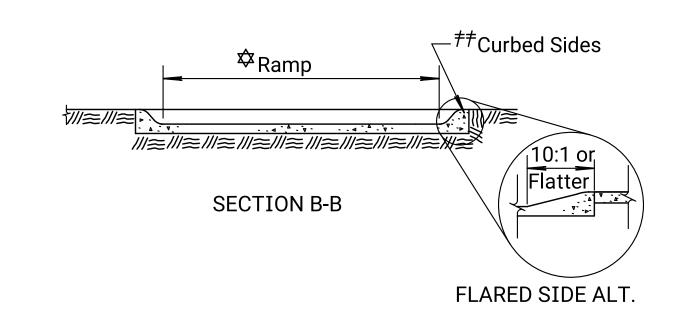

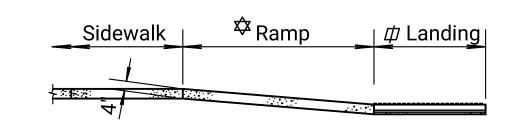

SECTION C-C

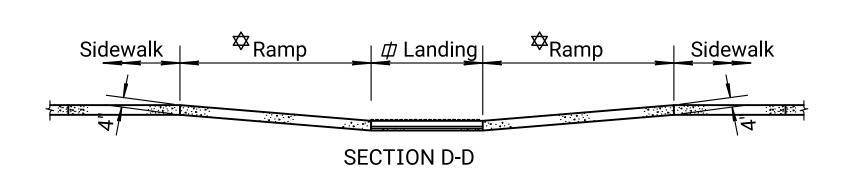

GENERAL NOTES

PROJECT NO.

59-2 KA-5422-01

STATE

KANSAS

YEAR | SHEET NO.

13

2022

Construct sidewalk and ramps in accordance with the current Public Rights of Way Accessibility Guidelines (PROWAG).

The details depicted here may not be appropriate for all locations. Construct to meet this criteria on all roadway alteration projects as defined by the Department of Justice/Department of Transportation Joint Technical Assistance on ADA Title II Requirements. For an existing sidewalk facility where the sidewalk will be replaced, replace sidewalk in accordance with PROWAG.

Details shown on this sheet apply to newly constructed and existing sidewalk and ramps where roadway alteration projects take place. See KDOT's Standard Specifications for additional information.

Provide ramps at all corners of street intersections where there is an existing or proposed sidewalk and curb. Provide curb ramps at mid-block walk locations for hospitals, medical centers, and athletic stadiums.

Locate ramps as shown on the plans or as directed by the Engineer.

Do not place drainage structures in line with ramps except where existing drainage structures are being utilized in the new construction. Ramp locations should take precedence over the location of drainage structures. Where existing manhole access lids are located on ramps within the area of the detectable warnings and the manhole lid cannot be removed or relocated; install a lid with a detectable warning surface in accordance with PROWAG. Limit drainage across ramps where practicable.

Construct ramps with uniform grade free of sags and short grade changes.

Place ¾" Redwood expansion joints flush with the surface at a maximum spacing of 125'. Place ¾" Redwood expansion joints at sidewalk junctions, see plan details. Where sidewalk abuts a curb place ¾" Redwood board expansion joint flush with the surface.

Place ½" premolded (Type B or C) joint filler where sidewalk is parallel and adjacent to

A Place sidewalk shown to be constructed in back of an entrance 6" thick with welded wire mesh reinforcement. Gauge and spacing of wires are the same as entrance pavement (See Reinforcement Diagram). The bid item will be "Sidewalk Construciton" either with or without air entrainment. Macro fiber reinforcement may be substituted for welded wire. See KDOT's Standard Specifications for additional information. Slope sidewalk toward the street at 2% or flatter. Slope or depress sidewalk where necessary to fit alleys and entrances, see plans for details.

Contractor may opt to use Concrete Grade 3.0 (AE) throughout for construction of steps, but all work and materials are paid for under the bid item "Grade 3.0 Conc. (Misc.)". All work and materials needed to construct sidewalk will be paid for under the bid item

"Sidewalk Construction".


All work and materials needed to construct ramps will be paid for under the bid item
"Sidewalk Ramps"

See Standard Drawing RD725A for additional information.

Ramps shall be present at each end of a crosswalk.

For handrails with steps see Standard Drawing RD725B for details.

For handrails with ramps see Standard Drawing RD725C for details. For alley and entrance pavement see Standard Drawing RD726 for details.

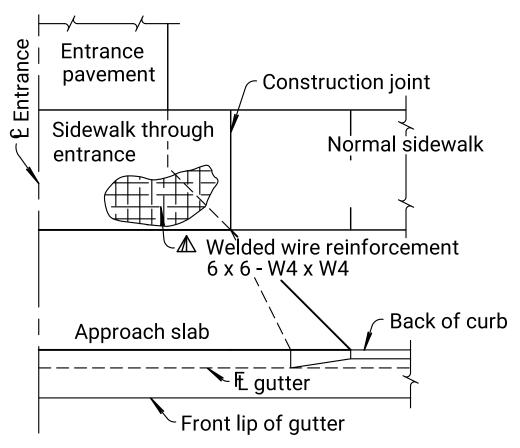

REINFORCEMENT DIAGRAM
SIDEWALK THROUGH ENTRANCE


						ı
13	10-31-17	Joint Filler Type C Adde	d	A.L.R.	S.W.K.	
12	2-23-17	Rev. Ramp Typ., Gen. No	ote, & Details	T.T.R.	S.W.K.	
11	10-17-1 1	Revised General Note		S.W.K.	J.O.B.	
10	5-23-1 1	Revised notes		S.W.K.	J.O.B.	
NO.	DATE	REVIS	SIONS	BY	APP'D	
			K, RAMPS,			aphics Certified
RD	725					Gra
FHWA .	APPROVAL	3-5-2018	APP'D. SCOTT '	W. KING		
DESIG	NED	DETAILED	QUANTITIES	TRACED		l'O


QUAN.CK. 725

TRACE CK.

KDOT Graphics Certified 03-26-2018

DETAIL CK.

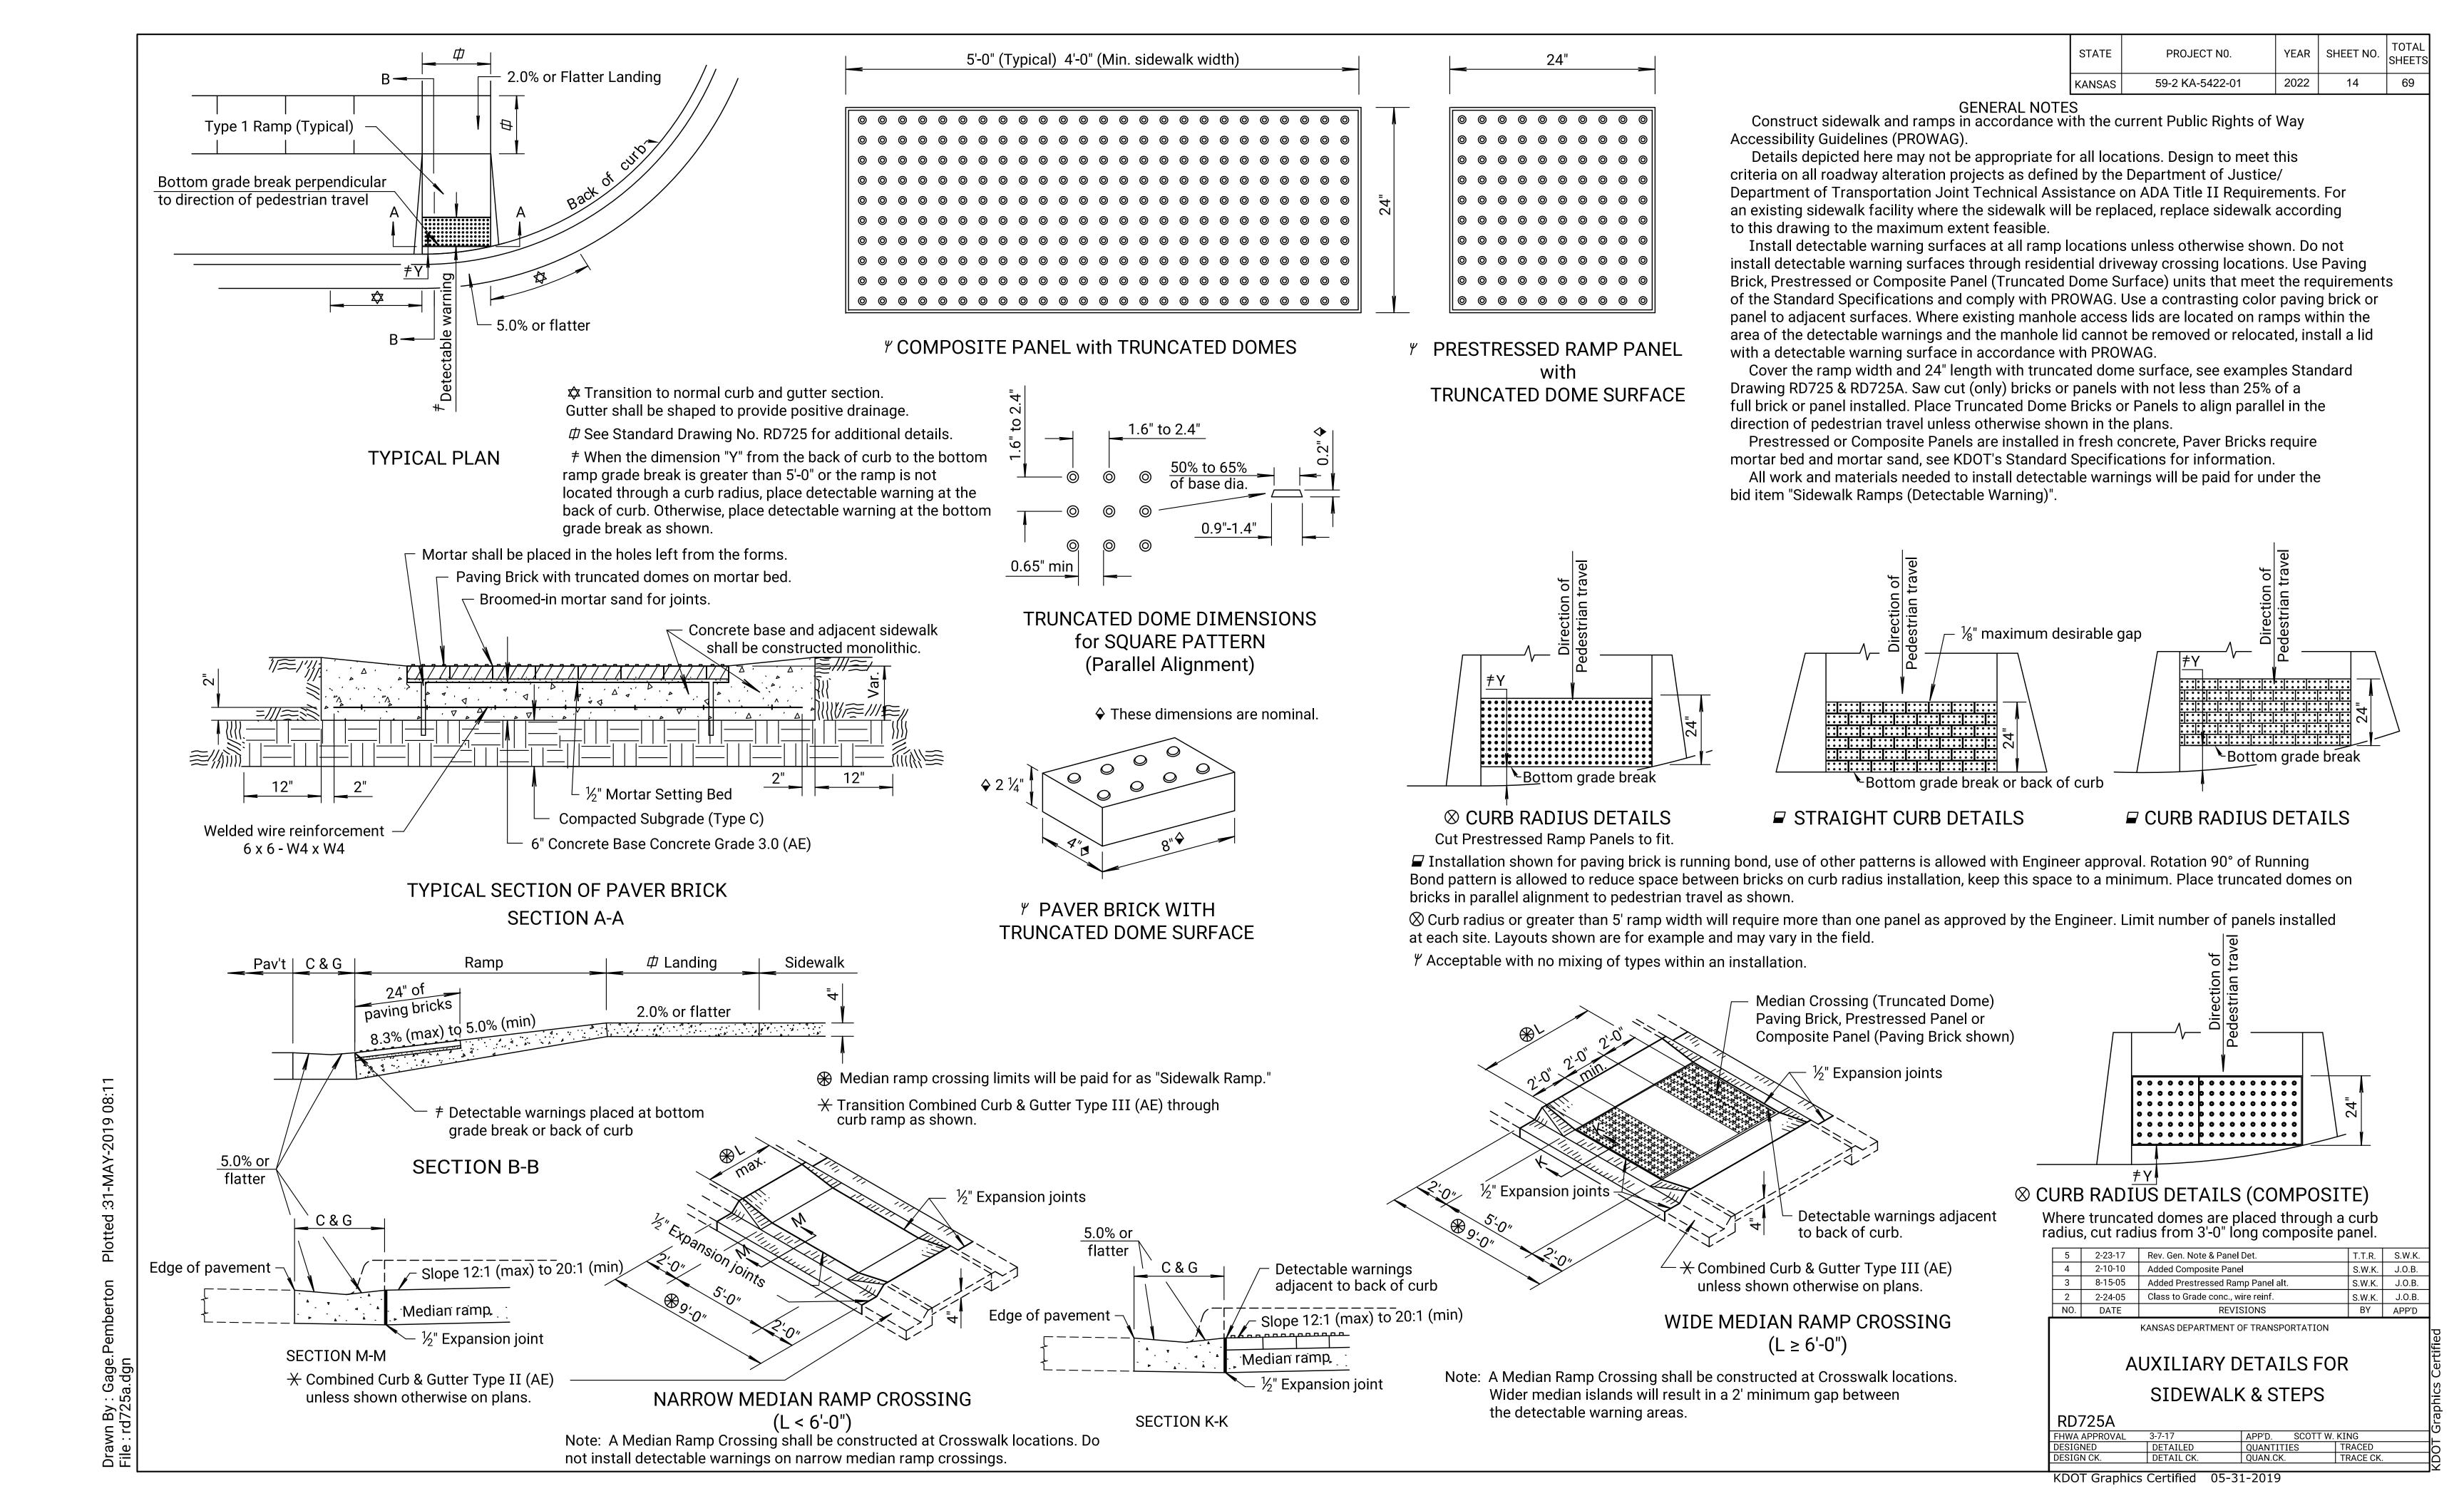

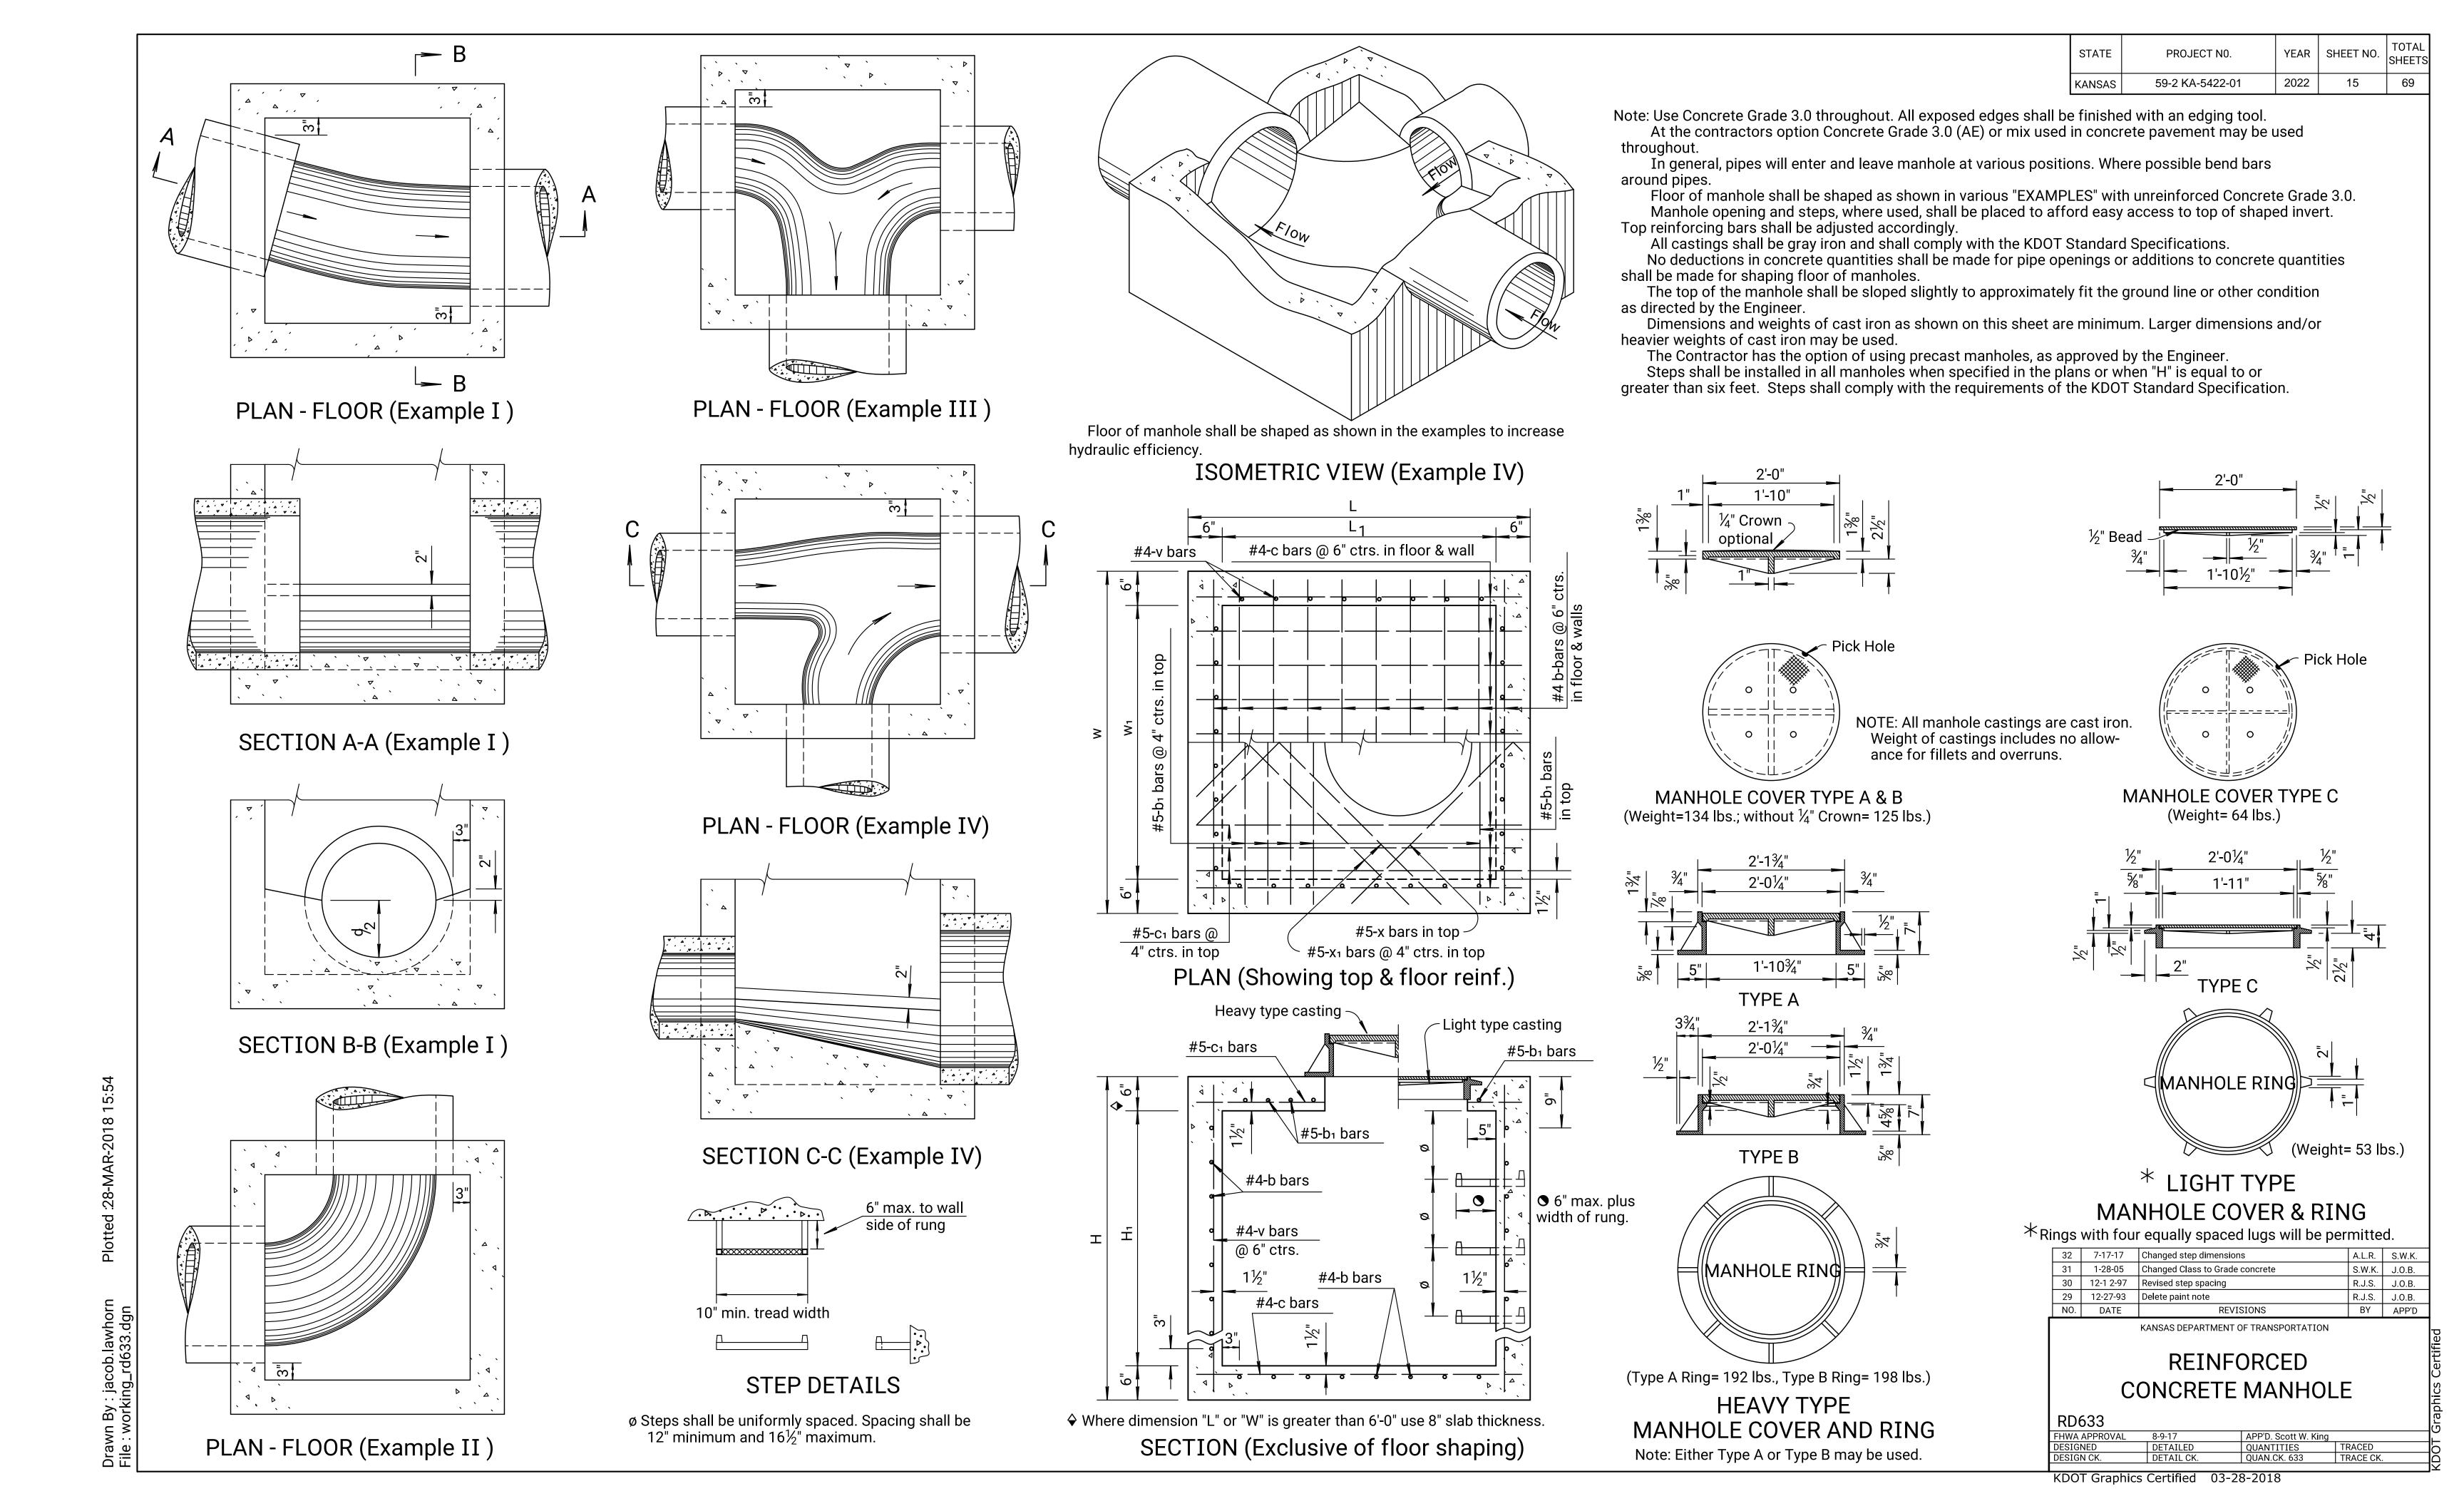

GENERAL NOTES:

Outside Edge of Concrete Footing

No. 4 Bars placed at 45 degree angle

Expansion Joint ____

(See Curb Standards)

Curb and Gutter

Steel Inlet Frame (10" Throat)

10' Transition upstream side
10' Transition both sides for sump inlet

- Inside Wall

-Locating Point (Inside

Face of Front Wall


€ of Box)

- The first dimension listed in the Construction Notes is the "L" dimension. The second dimension is the "W" dimension. It's listed on the project plans are listed at the inside face of the wall.
- 2. Floor of Inlet shall be shaped with invert to provide smooth flow.
- 3. Locate MH ring and cover over outlet.
- 4. Steps shall be spaced at 1'-4" O.C. vertically.
- 5. Bevel all exposed edges with 3/4" chamfer or 1/2" tooled edge.
- On-grade inlets shall conform to the street grade and sump inlets shall be level.
- 7. The sums of "L" & "W" shall not exceed 14" without special design. (See project plans for details.)
- 8. Ring & Cover to be Neenah R-1537, Clay & Bailey #2020, Deeter #2016, or approved equal. (Casting may vary by municipality, refer to plans & contract documents.)

 STATE
 PROJECT NO.
 YEAR
 SHEET NO.
 TOTAL SHEETS

 KANSAS
 59-2 KA-5422-01
 2022
 16
 69



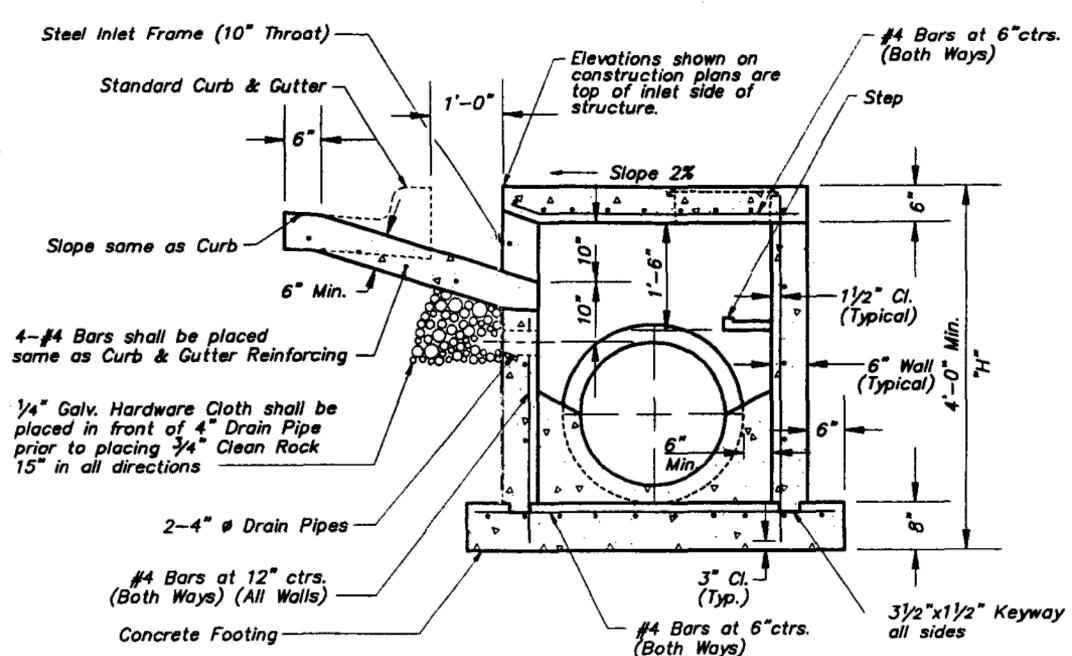

SECTION A-A

<u>PLAN</u>

4'-0" Min.

.....

Contraction

Joint ___

1"x1"x18" Recessed Lifting


Expansion Joint

(See Curb Standards)


5' Transition

Downstream side

Slot (typ)

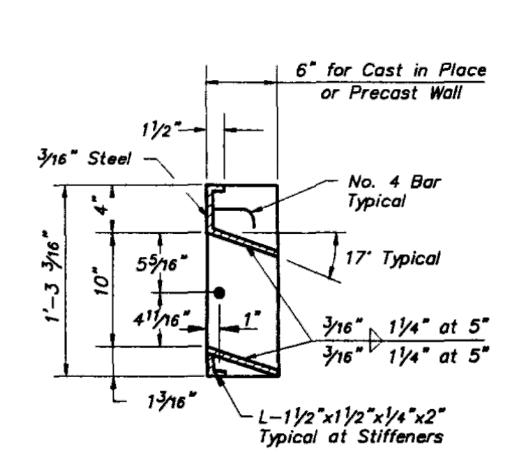



SECTION B-B

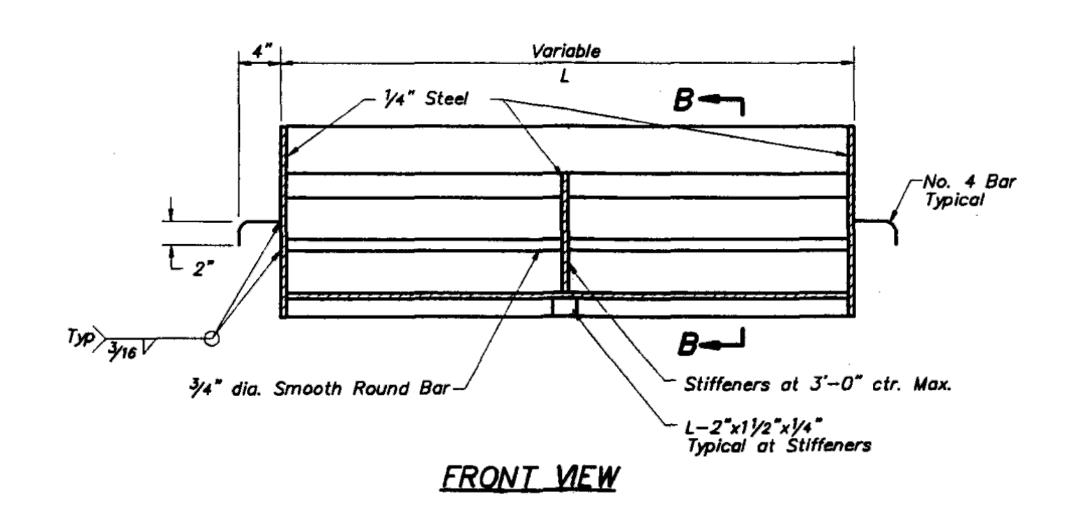

Notes:

- All welds shall be preformed in accordance with appropriate AWS Specifications & Procedures.
- 2. All welds on exposed surfaces shall be dressed so as to provide a pleasing finished appearance.
- The entire frame shall be painted a single coat of CHEM-PRIME #37-77 primer (Red) or equal.

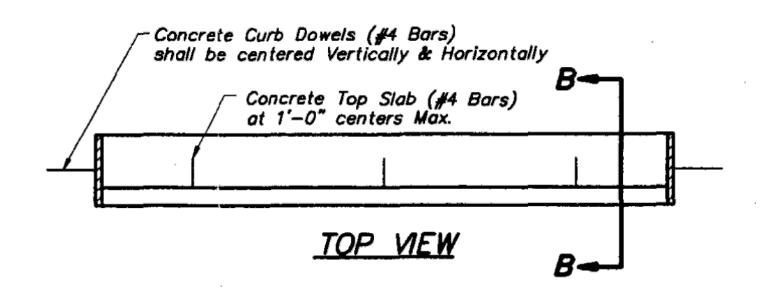


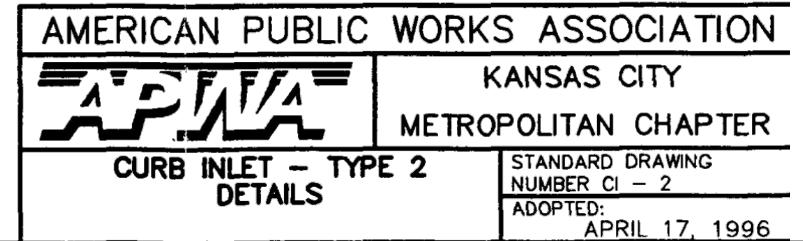

KANSAS DEPARTMENT OF TRANSPORTATION

SETBACK CURB INLET DETAILS



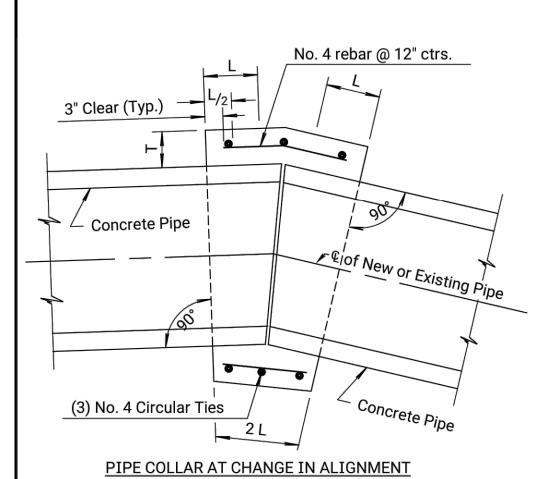

General Notes:

Pipe collar shall be used to join pipes of different diameters or materials or where change in alignment or grade exceeds that

TYPE A COLLAR

allowed for ordinary joints.

All concrete shall be Concrete Grade 3.0. All reinforcing steel shall be Grade 60 and shall have a minimum of 2" of cover.


The diameter of the circular ties shall be the outside diameter of the larger pipe plus "T".

The maximum allowable distance between the ends of the pipes at any point is 2".

All labor, materials and incidentals required to construct the pipe collar Type A, B or C shall not be paid for directly but shall be subsidiary to the individual pipe bid items.


Aluminum or aluminized pipes or end sections shall be coated with an asphaltic paint when in contact with fresh concrete in accordance with the Standard Specifications.

Pipe ends shall be trimmed such that the maximum distance between pipes at any point is 2".

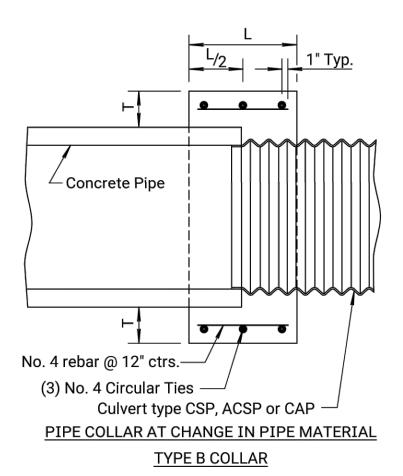


CONCRETE PIPE COLLAR										
Pipe Dia.	L	Т								
18"	1'-0"	6"								
24"	1'-0"	6"								
36"	1'-6"	8"								
48"	1'-6"	10"								
60"	1'-9"	11"								

PIPE COLLARS

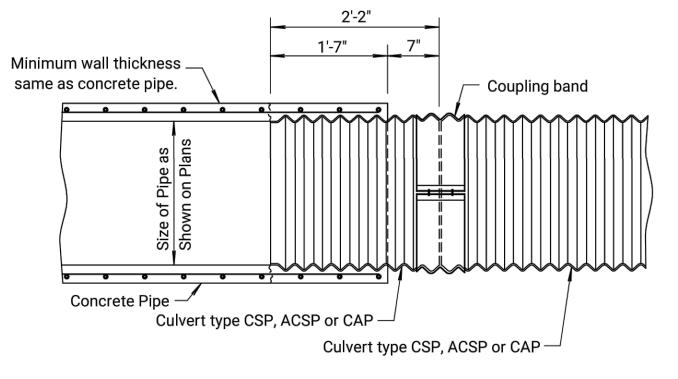

(CONCRETE PIPE CONNECTED TO CORRUGATED METAL PIPE) TYPE C COLLAR ▲

A section of concrete pipe (6'-0" min.) is cast 1'-7" short with the re-steel protruding. Tack weld the re-steel to the 2'-2" section of CMP and finish casting the remaining 1'-7" of RCP around the CMP. This is an approved connection provided it is fabricated as an integral part of a section of concrete pipe.

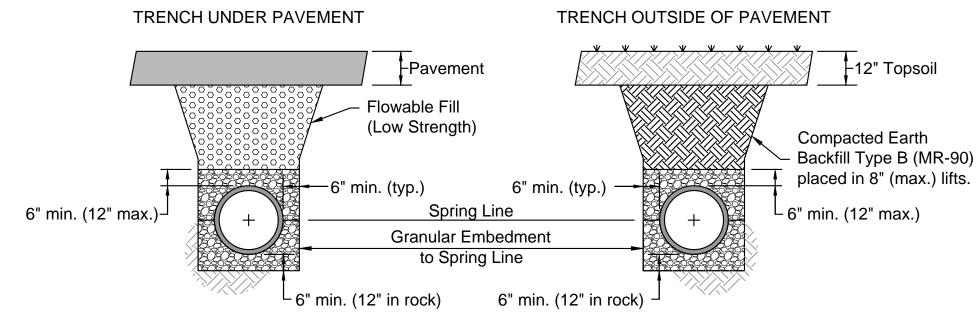

TYPICAL STORM SEWER TRENCH SECTIONS

Not to Scale

KANSAS DEPARTMENT OF TRANSPORTATION

MISCELLANEOUS STORM SEWER DETAILS

YEAR SHEET NO. SHEET! STATE PROJECT NO. ___LEGEND KANSAS 59-2 KA-5422-01 PLAN: Lat. & Long. 2022 18 Flowable Fill (in Profile) PROFILE: Horiz. same as above BG CONSULTANTS
ENGINEERS - ARCHITECTS - SURVEYORS STORM LINE RIGHT (4th AVE TO RCB @ ±STA. 194+31) 1080 EXISTING GROUND -1075 — ₱ROP. CURB E↓EVATION 1070 168.0 LIN. FT. x 24" RCP @ 1.85% F.L. = 1071.00 92.0 LIN. FT. x 24" RCP @ 1.90% 1065 176.0 LIN. FT. x 30" RCP @ 1.50% 190.0 LIN FT. x 30" RCP @ 1.75% 1060 F.L. = 1062.81 F.L. = 1062.91 1055 150' 175' 200' 225' 300' 525' STORM LINE RIGHT (4th AVE TO RCB @ ±STA. 194+31) 1075 SETBACK CURB INLET (1 STA. 187+10.00, 24.00' RT TOP ELEV. = 1061.80 SETBACK CURB INLET (8'x6') STA. 189+05.00, 24.50' RT. TOP ELEV. = 1056.06 1070 1065 EXISTING GROUND -190.0 LIN FT. x 30" - PROP. CURB ELEVATION RCP @ 1.75% 1060 100.0 LIN. FT. x 30" RCP @ 2.00% F.L. = 1059.38 F.L. = 1059.48 -F.L. = 1057.38 186.0 LIN. FT. x 30" RCP @ 3.00% 1055 ← F.L. = 1057.18 152.0 LIN. FT. x 7.0 SQ. FT. RCPHE (45"x29") @ 1.58% 1050 F.L. = 1051.10 -F.L. = 1051.50 550' 575' 600' 625' 650' 675' 700' 725' 750' 775' 800' 825' 850' 875' 900' 925' 950' 975' 1000' 1025' 1050' 1075' 1100' KANSAS DEPARTMENT OF TRANSPORTATION STORM SEWER PROFILES

YEAR SHEET NO. TOTAL SHEETS STATE PROJECT NO. LEGEND KANSAS 59-2 KA-5422-01 2022 19 PLAN: Lat. & Long. Flowable Fill (in Profile) PROFILE: Horiz. same as above BG CONSULTANTS
ENGINEERS - ARCHITECTS - SURVEYORS STORM LINE RIGHT (4th AVE TO RCB @ ±STA. 194+31) 1070 1060 1055 EXISTING GROUND — PROP. CURB ELEVATION 1050 230.0 LIN. FT. x 10.0 SQ. FT. RCPHE (53"x34") @ 0.75% 137.6 LN. FT. x 10.0 SQ. FT. F.L. = 1048.73 F.L. = 1049.10 RCPHE (53"x34") @ 0.33% F.L. = 1047.00 F.L. = 1046.95 1045 F.L. = 1045.00 1040 1035 1100' 1125' 1150' 1200' 1225' 1250' 1275' 1300' 1325' 1350' 1400' 1425' 1500' 1700' STORM LINE <u>LEFT</u> (4th AVE TO 3rd AVE) SETBACK CURB INLET (STA. 180+10.00, 24.00' L TOP ELEV. = 1074.40 SETBACK CURB INLET (8'x4') STA. 182+15.00, 24.00' RT. TOP ELEV. = 1070.81 1080 PROP. CURB ELEVATION 1075 EXISTING GROUND — ___ 1070 197.0 LIN. FT. x 15' RCP @ 1.50% F.L. OUT = 1070.63 44.0 LIN. FT. x 18" RCP @ 2.00% F.L. = 1067.68 F.L. = 1067.43 — 1065 F.L. = 1066.55 F.L. OUT = 1065.55 1060 0' 50' 75' 100' 125' 150' 175' 200' 225' 250' 275' 300' 325' 350' 375' KANSAS DEPARTMENT OF TRANSPORTATION STORM SEWER PROFILES

YEAR SHEET NO. TOTAL SHEETS STATE PROJECT NO. LEGEND PLAN: Lat. & Long. KANSAS 59-2 KA-5422-01 2022 20 Flowable Fill (in Profile) PROFILE: Horiz. same as above BG CONSULTANTS
ENGINEERS - ARCHITECTS - SURVEYORS STORM LINE <u>LEFT</u> (1st AVE TO RCB @ ±STA. 194+31) 1070 SETBACK CURB INLET (8'x4') STA. 192+10.00, 27.50' LT. TOP ELEV. = 1052.06 1060 PROP. CURB ELEVATION 1055 EXISTING GROUND 176.0 LIN. FT. x 18" 1050 RCP @ 0.75% 177.0 LIN. FT. x 24" RCP @ 1.00% F.L. = 1050.69 F.L. = 1049.37 -F.L. = 1048.87 1045 F.L. = 1047.10 -12.0 LIN. FT. x 24" RCP or PE @ 0.50% 1040 1035 175' 200' 225' 300' 525' STORM LINE <u>CROSSING</u> @ STA. 187+10 SETBACK CURB INLET (10'x4') STA. 187+10.00, 24.00' RT. TOP ELEV. = 1061.80 1065 PROP. US-59 __ EXISTING GROUND 1060 44.0 LIN. FT. x 15" RCP @ 1.50% F.L. OUT = 1057.18 F.L. = 1059.09 F.L. = 1058.43 1050 0' 50' 75' 100' 125' 150' 175' 200' 225' 250' 275' 300' 325' 350' 375' 400' 425' 450' 475' 500' 525' 550' KANSAS DEPARTMENT OF TRANSPORTATION STORM SEWER PROFILES

STATE	PROJECT NO.	YEAR	SHEET NO.	TOTAL SHEETS
KANSAS	59-2 KA-5422-01	2022	21	69

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CTATION	CIDE	NAANI	TYPE	DITCH	T		TNELC	SEV	WER DATA	OI	ITELOW DIDES	ELEVA	TIONS FLOOR	DIMENS	SIONS		STO	RM SEW	ER		END	SECT	IONS	S	SEWER EXC.	HT. CONC	PIP	E CLA	SS C	AST STRUC. REINF. CONC. RON STEEL STEEL GD. 3.0 STEPS (LBS.) (LBS.) (CU.YD.)	REMARKS
STATION	SIDE	HOLES	INLETS INLETS	INLETS	RADIUS	SIZE E ELEV.	SIZE	E ELEV.	SIZE E ELEV.	SIZE	JTFLOW PIPES £ ELEV. GRADE	TOP	FLOOR (FT.) (FT	.) (FT.)	15" 18	 " 21" 24		"	15	5" 18" 21			C	OMM. ROCK	HT. CONC FILL AASHT FT. CL. NC	. STEEL	EX(C. (L	BS.) (LBS.) (LBS.) (CU.YD.)	
						+ +																									
						+ +																									
																											1				1
TOTAL			l		1	1	1		<u> </u>		l l	<u> </u>	<u>ı</u>	l	ı																

★ Note: Top Elevation is located as follows:

- Manhole Top of Manhole Ring
 Curb Inlet Top of curb.
 Gutter Inlet Top back of gutter.
 Inlet Manhole, Special Top of Grate.
 Ditch Inlet Top of Concrete at Cover Plate.

3	1-28-05	Changed Class to Grade concrete	S.W.K.	J.O.B.
2	5-21-99	Added top elevation location note	R.J.S.	J.O.B.
1	10-8-90	Detailed on CADD	R.J.S.	J.O.B.
NO.	DATE	REVISIONS	BY	APP'D

KANSAS DEPARTMENT OF TRANSPORTATION

SCHEDULE **INLETS AND MANHOLES**


RD653H

FHWA APPROVAL 06-10-05

DESIGNED DETAILED

DESIGN CK. DETAIL CK. APP'D. James O. Brewer
QUANTITIES TRACED B.N.B.
QUAN.CK. TRACE CK. R.J.S.

KDOT Graphics Certified 03-29-2018

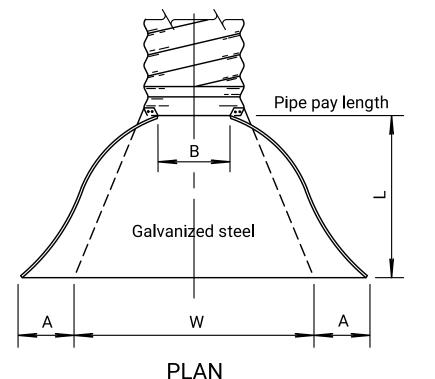

(Illustrated with Type #3 Connection)

Holes @ 12" ctrs. (max.)

FRONT

|Holes @ 12" ctrs. (max.) |

FRONT

Reinforced edge

Available in sizes 12" through 24" only.

Threaded rod Strap bolt Rod holder Flat strap connector Pipe pay length TYPE 1

TYPE 2 Available in sizes 30" and 36" Round and 17"x13" through 57"x38" Pipe-Arches.

Note: Type 3 connection may be furnished instead of Type 1 or Type 2 for smaller round or arch pipe.

Pipe pay length

TYPE 3 Available in sizes 42" through 96" Round and 60"x46" through 81"x59" Pipe-Arches.

Riveted or bolted

Available for all Round and equivalent Pipe-Arch sizes, (Type 1 and Type 2 connections are recommended for the smaller sizes with annular ends).

0000

Pipe pay length

TYPE 5

Pipe to which end section

Dimple band collar

with ¾" bolts.

bolted to end section

is attached.

YEAR | SHEET NO. STATE PROJECT NO. 2022 22 59-2 KA-5422-01 KANSAS

GENERAL NOTE for END SECTIONS

End section material shall follow KDOT Pipe Policy for geographic location. Location shall govern use of CS (Galvanized), ACS (Aluminized) or CA (Aluminum) (Type I) End Section. Pipe material and End Section material shall be the same with no mixing of types per location.

Toe plate extension, when specified, is an accessory and shall be the same gauge and metal as end section. Toe plate shall be punched to match holes in apron lip and attached with furnished 3#8" diameter nuts & bolts.

W + 10" for 12" to 30" diameter pipes inclusive.


W + 20" for 36" to 84" diameter pipes inclusive.

W + 10" for pipe-arches with a rise of 13" to 29" inclusive.

W + 20" for pipe-arches with a rise of 33" to 59" inclusive.

Multiple panel end sections may contain dual gauges of like metal and shall have lap seams which are tightly joined with rivets or bolts. For 60" and larger diameter round pipe end sections and 77"x52" arch pipe end sections, the reinforced edges are supplemented with stiffener angles. The angles are attached with nuts and bolts. Angle reinforcement may be required uder the center panel seams of 73"x55" and larger arch pipe end sections depending on manufacturer.

Other approved designs may be used in lieu of type shown. Connection of end sections by welding will not be permitted.

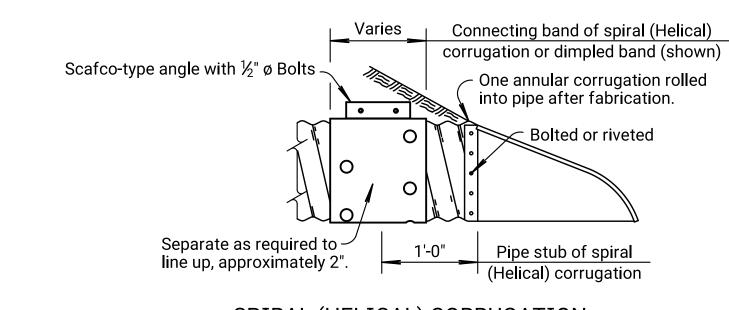

SPIRAL (HELICAL) CORRUGATION


For all sizes of round and arch culvert pipes having Spiral (Helical) corrugations, the end sections and connecting bands shall be as shown above.

Thickness CSP/ACSP	Thickness CAP	Gauge
0.064"	0.060"	16 ga.
0.079"	0.075"	14 ga.
0.109"	0.105"	12 ga.
0.138"	0.135"	10 ga.
0.168"	0.164"	8 ga.

Pipe	CS, ACS or		Dimer	nsions in	Inches		Approx.
Dia.	CA	Α	В	Н	L	W	Slope
(In.)	Gauge	(min.)	(max.)	(min.)	(±2")	(min.)	
12"	16	5	7	6	21	22	2½:1
15"	16	6	8	6	26	28	2½:1
18"	16	7	10	6	31	34	2½:1
21"	16	8	12	6	36	40	2½:1
24"	16	9	13	6	41	46	2½:1
30"	14	11	16	8	51	55	2½:1
36"	14	13	19	9	60	70	2½:1
42"	12	15	25	10	69	82	2½:1
48"	12	17	29	12	78	88	2½: 1
54"	12	17	33	12	84	100	21/4: 1
60"	12/10	17	36	12	87	112	2: 1
66"	12/10	17	39	12	87	118	2: 1
72"	12/10	17	44	12	87	120	2: 1
78"	12/10	17	48	12	87	130	1½:1
84"	12/10	17	52	12	87	136	1½:1
90"	12/10	17	58	12	87	142	1½:1
96"	12/10	17	58	12	87	144	1½:1

Bid	Nom. W.W.	Pipe Arch		sions in	Inches	2¾" x ½'	' Corruga	ations		nsions ir	n Inches	3" x 1" (or 5" x 1"	Corr.	Approx.
Designation Sq. Ft.	Area Sq. Ft.	Span & Rise	CS, ACS or CA Gauge	A (min.)	B (max.)	H (min.)	L (±2")	W (min.)	CS, ACS or CA Gauge	A (min.)	B (max.)	H (min.)	L (±2")	W (min.)	Slope
1.0	1.1	17" x 13"	16	5	9	6	20	28							2½: 1
1.5	1.6	21" x 15"	16	6	11	6	24	34							2½: 1
2.0	2.2	24" x 18"	16	7	12	6	28	40							2½: 1
2.5	2.9	28" x 20"	16	7	16	6	32	46							2½: 1
3.0 or 4.0	4.5	35" x 24"	14	9	16	6	39	58							2½: 1
5.0 or 6.0	6.5	42" x 29"	14	11	18	7	46	73							2½: 1
7.0 or 8.5	8.9	49" x 33"	12	12	21	9	53	82							2½: 1
10.0 or 11.0	11.7	53" x 41"							12	17	26	12	63	88	2: 1
10.0 or 11.0	11.6	57" x 38"	12	16	26	12	62	88							2: 1
12.5 or 14.0	15.6	60" x 46"							12	17	36	12	70	100	2: 1
12.5 or 14.0	14.7	64" x 43"	12	17	30	12	69	100							2: 1
16.5	19.3	66" x 51"							12/10	17	36	12	70	112	1½: 1
16.5	18.1	71" x 47"	12/10	17	36	12	77	112							1½:1
21.0	23.2	73" x 55"							12/10	17	36	12	77	124	1½:1
21.0	21.9	77" x 52"	12/10	17	36	12	77	124							1½: 1
25.0	27.4	81" x 59"							12/10	17	44	12	77	136	1½:1
25.0	26.0	83" x 57"	12/10	17	44	12	77	130							1½:1
32.0	32.1	87" x 63"							12/10	17	44	12	77	136	1½:1
36.0	37.0	95" x 67"							12/10	17	44	12	87	160	1½:1
42.0	42.4	103" x 71"							12/10	17	44	12	87	172	1½:1
47.0	48.0	112" x 75"							12/10	17	44	12	87	172	1½:1

(Information listed in these tables are nominal and may vary by manufacturer.

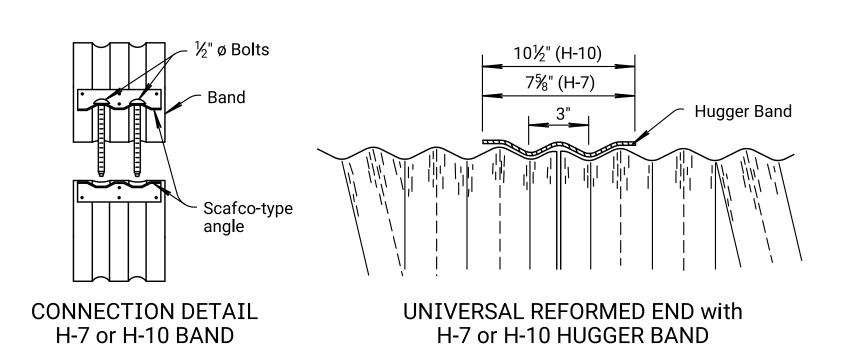

Toe plate (Optional)


(Same gauge as apron)

Reinforced edge

⊤oe plate (Optional)

(Same gauge as apron)


DETAILS FOR H-7 HUGGER BAND (12" thru 36") or H-10 HUGGER BAND (12" thru 120")

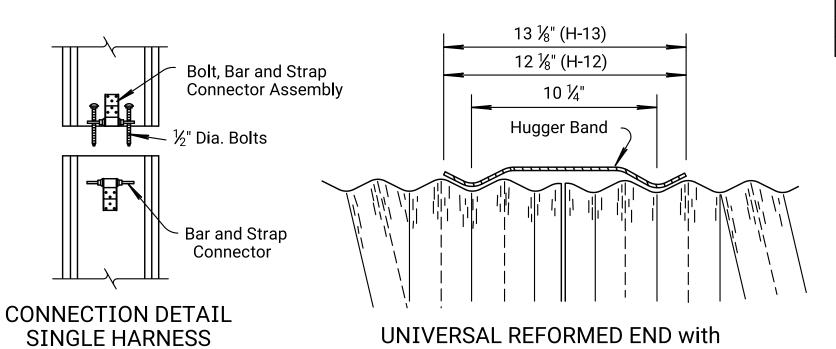

HUGGER BAND

DETAILS FOR H-12	or H-13	HUGGER	BANI

Pipe	Minimum Gauge of Round Pipe								
Dia.	2¾" x ½" Corr.	3" x 1	" Corr.	5" x 1	" Corr.	2¾"x ½" Corr.	3" x 1" Corr.		
Inches	CSP or ACSP	CSP o	r ACSP	CSP o	r ACSP	CAP	CAP		
12"	14					16			
15"	14					16			
18"	14					16			
21"	14					16			
24"	14					16			
30"	14					14			
36"	14					14	16		
42"	14					12	16		
48"	12	14	16	14	16	12	16		
54"	12	14	16	14	16	12	16		
60"	10	14	16	14	16	10	16		
66"	10	14	16	14	16	8	16		
72"	10	14	16	14	16	8	16		
78"	8	14	14	14	14		14		
84"	8	14	14	14	14		12		
90"		14	14	14	14		12		
96"		12	12	12	12		12		
102"		12	12	12	12		10		
108"		12	12	12	12		10		
114"		12	12	12	12		8		
120"		10	10	10	10		8		

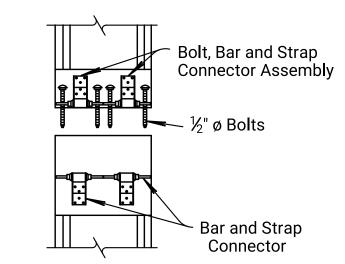

CONNECTION DETAIL

DOUBLE HARNESS

Bid	Dia a Dia anaisa		Equiv.		₩ Minimur	m Gauge of Arch	Pipe	
Designation	Pipe Dimension Span & Rise	Sq. Ft.	Round - Pipe	2¾"x ½" Corr.	3" x 1" Corr.	5" x 1" Corr.	2¾"x ½" Corr.	3" x 1" Corr.
Sq. Ft.			Diameter	CSP or ACSP	CSP or ACSP	CSP or ACSP	CAP	CAP
1.0	17" x 13"	1.1	15"	14			16	
1.5	21" x 15"	1.6	18"	14			16	
2.0	24" x 18"	2.2	21"	14			16	
2.5	28" x 20"	2.9	24"	14			14	
3.0 or 4.0	35" x 24"	4.5	30"	14			14	
5.0 or 6.0	42" x 29"	6.5	36"	14			12	
7.0 or 8.5	49" x 33"	8.9	42"	14			12	
10.0 or 11.0	53" x 41"	11.7	48"		14			
10.0 or 11.0	57" x 38"	11.6	48"	12			10	
12.5 or 14.0	60" x 46"	15.6	54"		14			14
12.5 or 14.0	64" x 43"	14.7	54"	12			10	
16.5	66" x 51"	19.3	60"		14			14
16.5	71" x 47"	18.1	60"	10			8	
21.0	73" x 55"	23.2	66"		14			14
21.0	77" x 52"	21.9	66"	8				
25.0	81" x 59"	27.4	72"		14	12		12
25.0	83" x 57"	26.0	72"	8				
32.0	87" x 63"	32.1	78"		12	12		12
36.0	95" x 67"	37.0	84"		12	12		12
42.0	103" x 71"	42.4	90"		12	12		10
47.0	112" x 75"	48.0	96"		12	12		8
54.0	117" x 79"	54.2	102"		10	10		
60.0	128" x 83"	60.5	108"		10	10		
67.0	137" x 87"	67.4	114"		10	10		
74.0	142" x 91"	74.5	120"		8	8		

GENERAL NOTE for METAL PIPE Culvert "Type" listed may be CSP, ACSP, CAP, RCP, PVCP & PEP within guidelines of KDOT Pipe Policy for geographic location. More than one pipe "Type" may be acceptable for a design location with allowable types listed for each site.

There shall be no payment for gain in pipe length due to fit of pipe at connecting band.

When Hugger Bands are used, the H-7 Hugger Band may be used on circular pipes 36" diameter and smaller or pipe arches 42"x 29" and smaller. The H-10 Hugger Band may be used on 12" thru 120" pipe. The H-12 or H-13 Hugger Band are for pipe sizes larger than 36" diameter or 42"x29" arch pipe.

Pipe gauge listed in the tables on this sheet are minimum for E'=750 p.s.i. soil. Pipe gauge will be determined for each site based on the Design Manual Volume I- Part C Fill Height Tables and shall shall be listed in the Pipe Culvert Summary. Gauges shown on this Standard Drawing are KDOT minimum and may not be industry minimum gauge.

In geographic areas that allow CSP (24" or smaller arched or round pipe) for entrance and side road installation with less than 3,000 AADT, 16 gauge ACSP may be substituted for 14 gauge CSP.


Aluminum or aluminized pipes or end sections shall be coated with an asphaltic paint when in contact with fresh concrete in accordance with the Standard Specifications.

4	9-10-09	Rev. Round and Arch tables, add. Alum.	S.W.K.	J.O.B.
3	1-20-09	Rev. Round Pipe Gauges	S.W.K.	J.O.B.
2	4-1 8-08	Rev. layout, details, tables and notes	S.W.K.	J.O.B.
1	4-27-98	Added pipe corrugation option note	R.J.S.	J.O.B.
NO.	DATE	REVISIONS	BY	APP'D


KANSAS DEPARTMENT OF TRANSPORTATION

METAL END SECTION FOR ROUND & ARCH METAL CULVERTS (TYPE I) & PIPE GAUGE TABLES

RD660 FHWA APPROVAL 12-16-09 APP'D. James O. Brewer TRACED Bowser
TRACE CK. King QUANTITIES

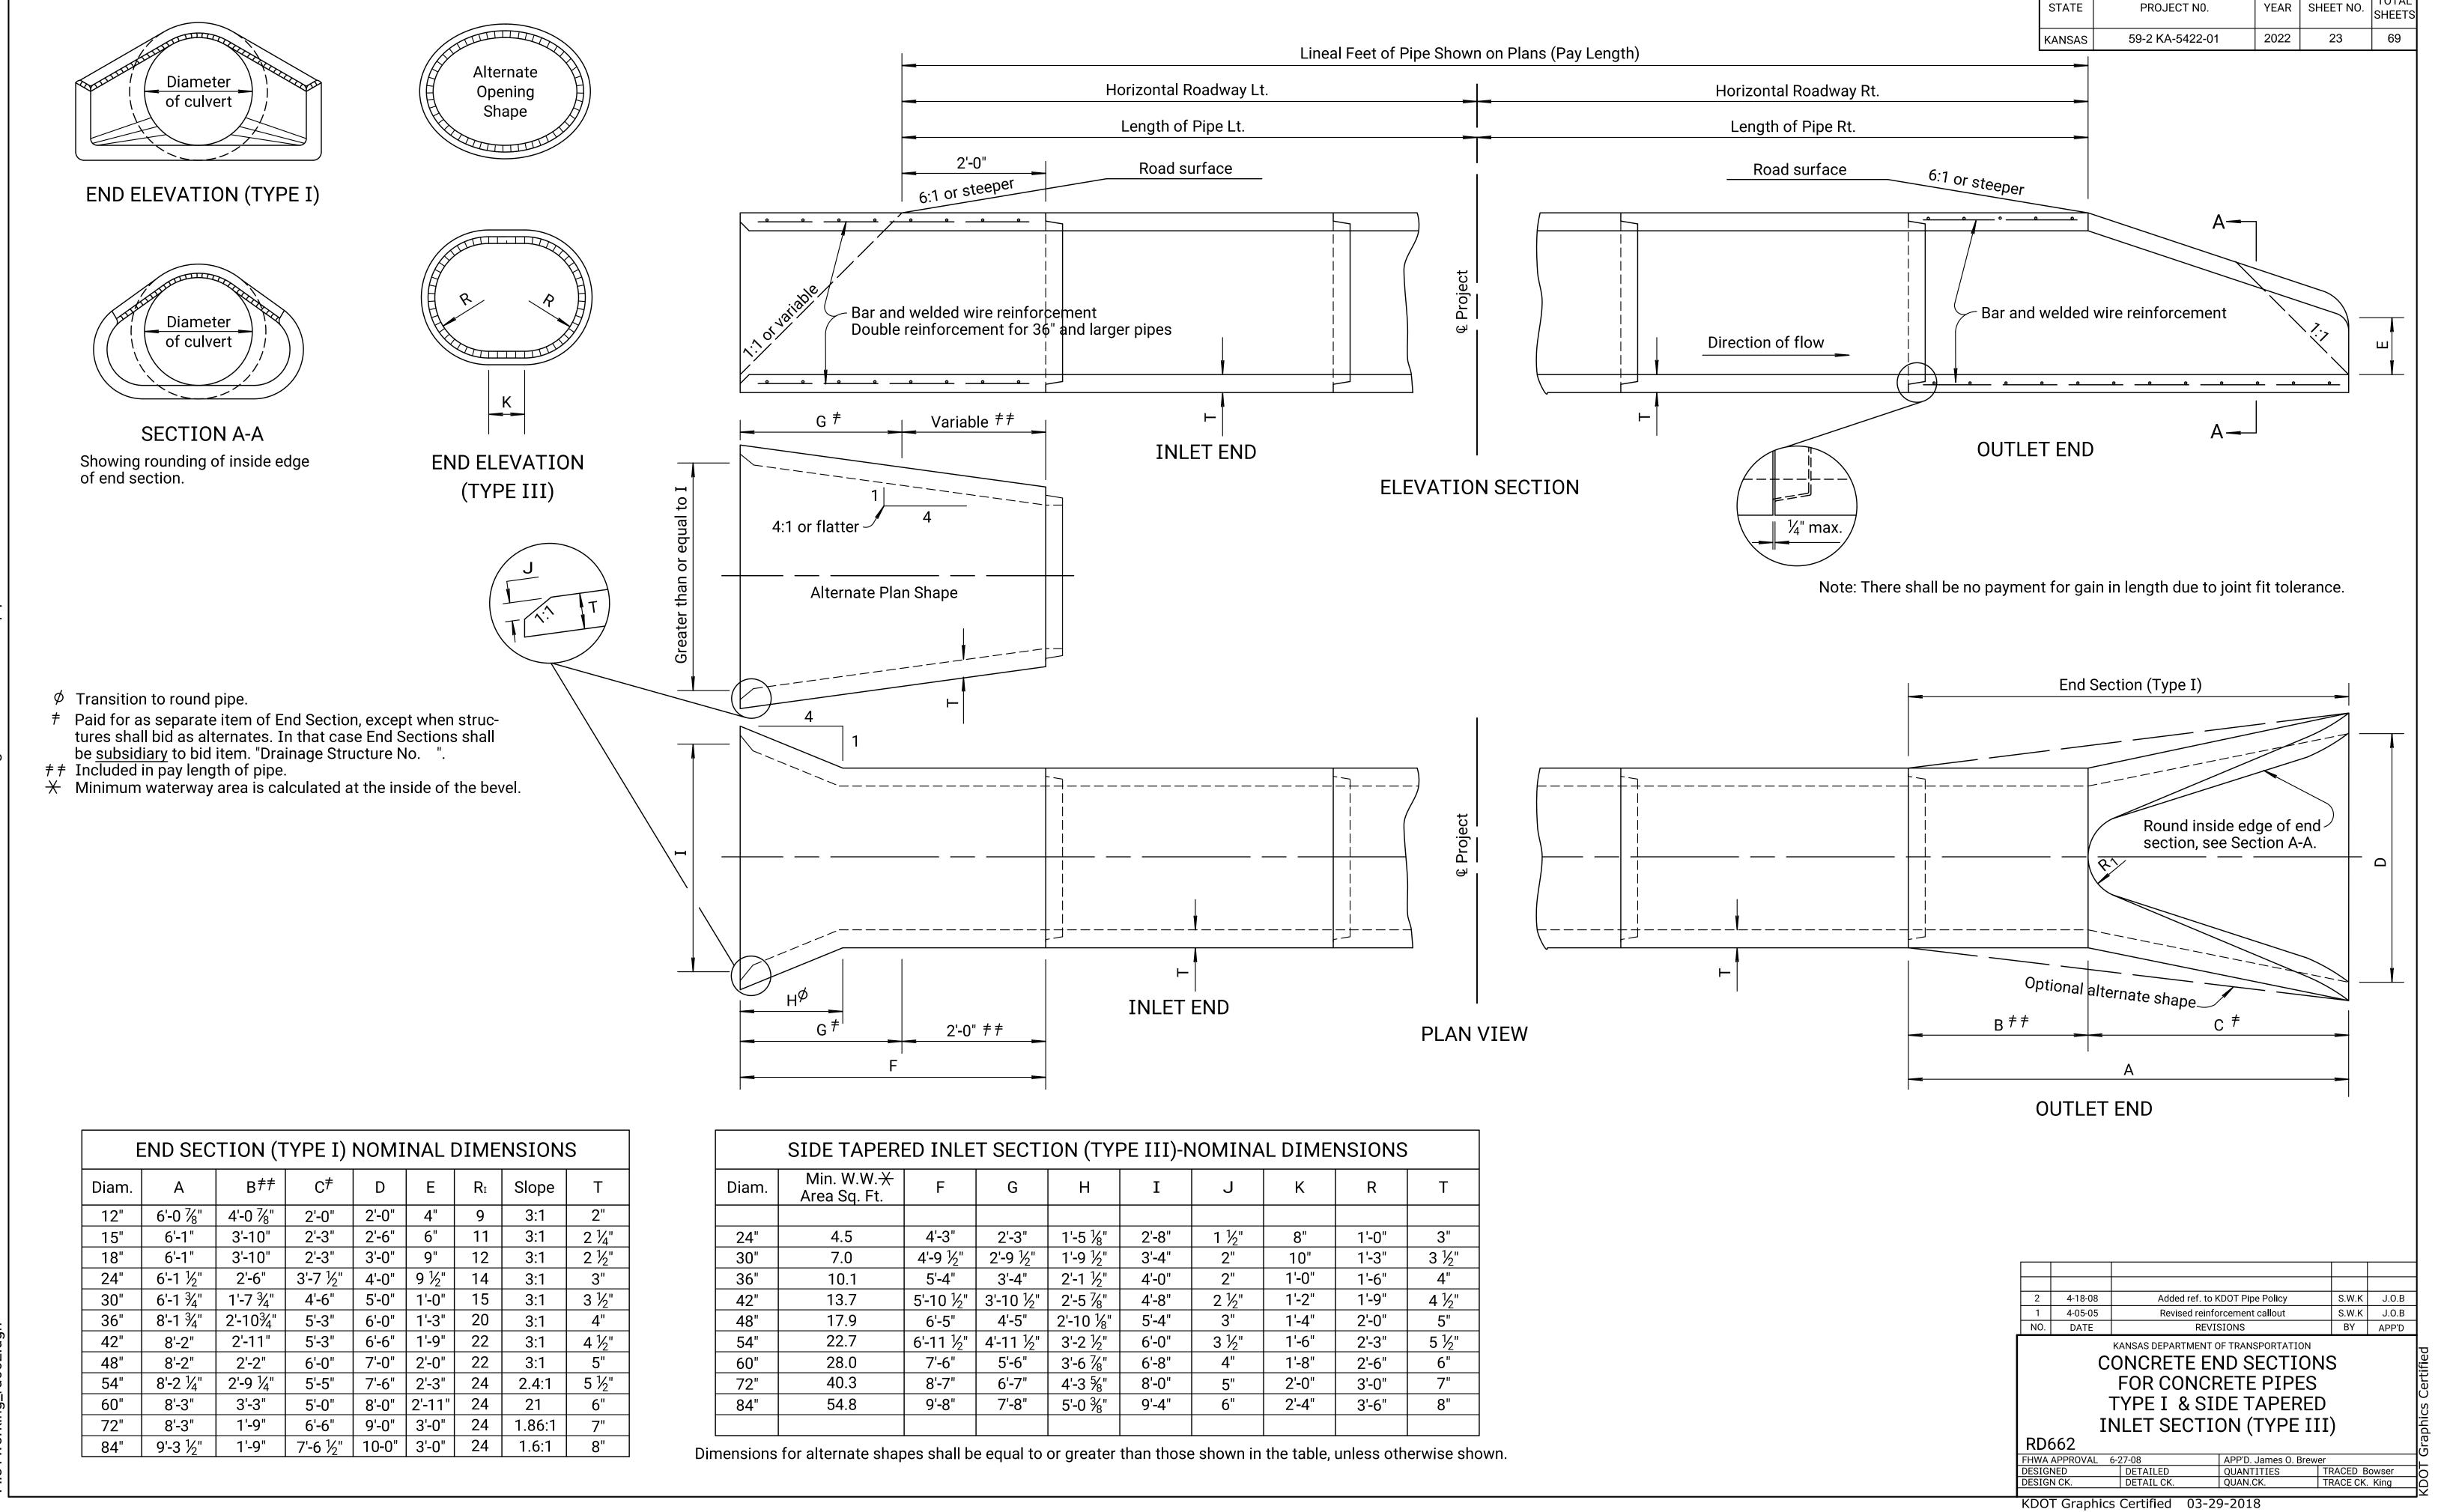



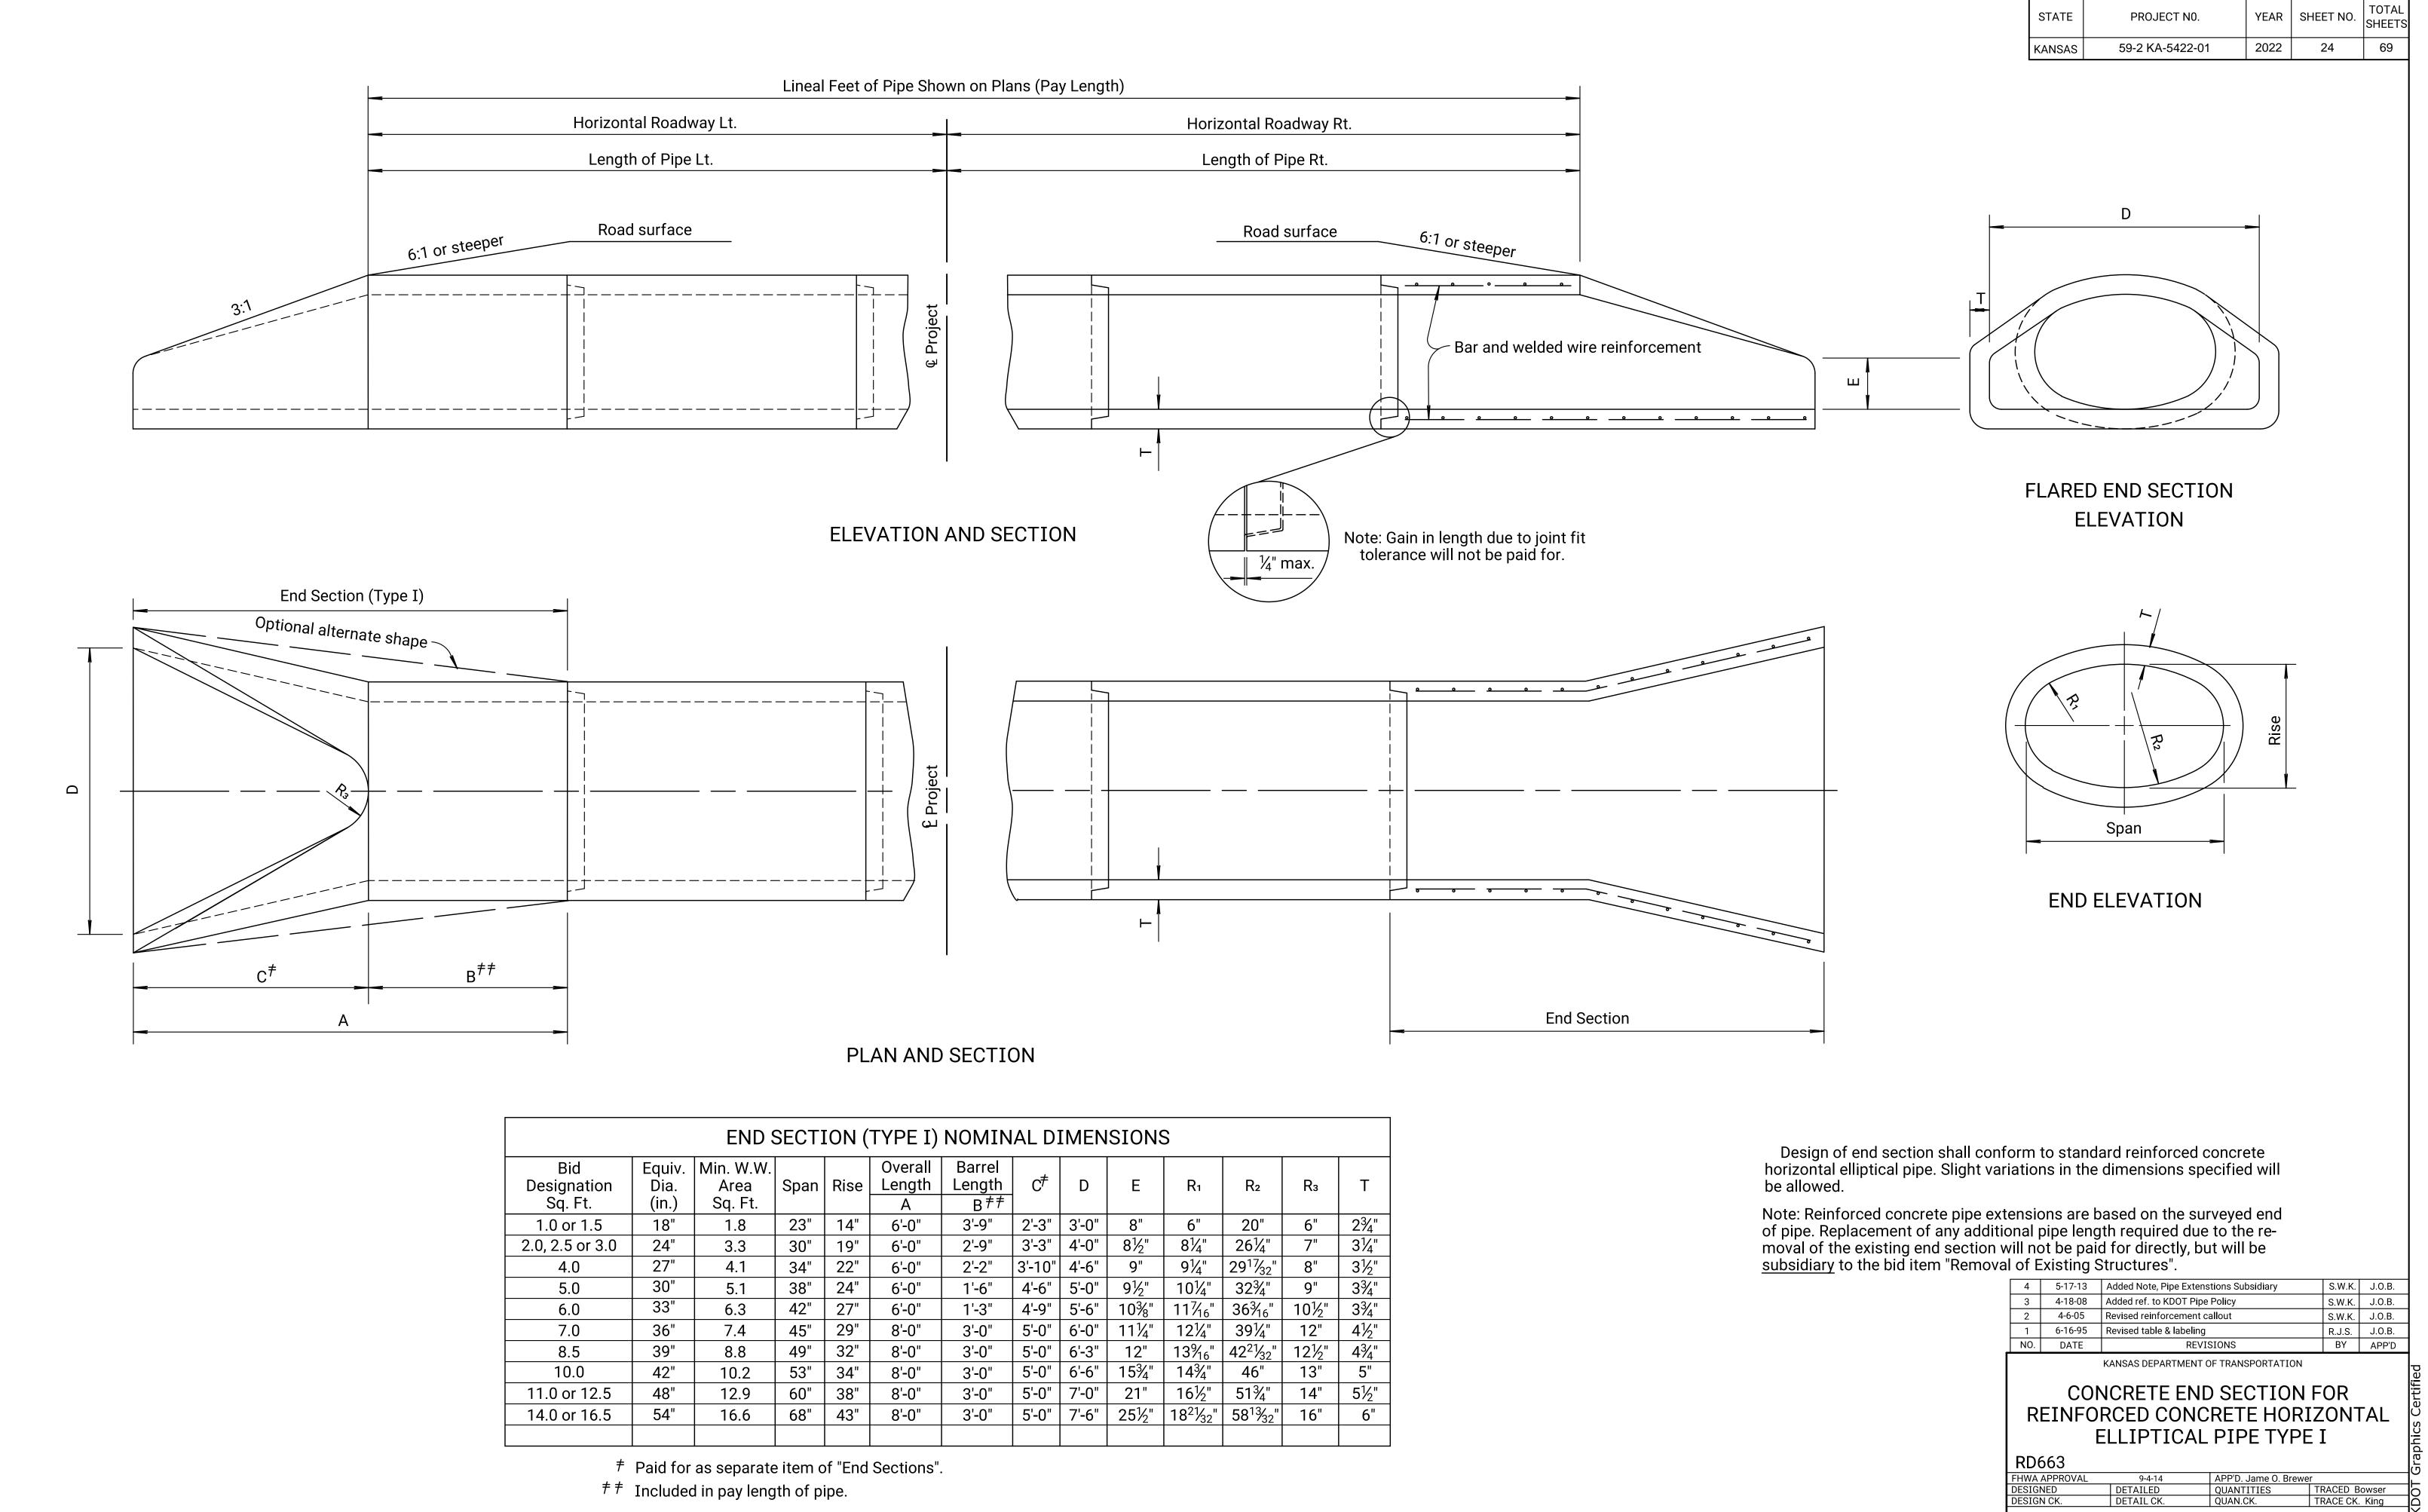

KDOT Graphics Certified 03-29-2018

	CONCRETE PAVEMENT (AE)							
		QL	JANTITY (SQ. YD	<u>, </u>				
LOCATION	OIDE	CONC. PVMT	CONC. PVMT	CONC. PVMT	DEMARKO			
180+09.95	SIDE Rt.	6" UNIFORM	8" UNIFORM	10" UNIFORM	REMARKS Curbed Comm. Ent.			
			47.6					
180+70.83	Lt.	40.5	65.4		Flared Comm. Ent.			
180+78.83	Rt.	16.5			Flared Alley Entrance			
180+79.12	C.L.			4.0	Concrete Manhole Collar			
182+53.90	Lt.		92.1		3rd Avenue Intersection			
182+68.63	Rt.		87.8		3rd Avenue Intersection			
183+11.54	Lt.	28.1			Flared Resid. Ent.			
183+56.13	Lt.	28.1			Flared Resid. Ent.			
183+73.75	Rt.	25.8			Flared Resid. Ent.			
183+88.80	Lt.		21.8		Flared Comm. Ent.			
184+41.72	Rt.	13.4			Resid. Entrance			
184+56.26	Rt.	18.4			Flared Alley Entrance			
184+57.48	C.L.			4.0	Concrete Manhole Collar			
185+06.31	Rt.	24.0			Flared Resid. Ent.			
185+42.95	Lt.	8.8			Flared Resid. Ent.			
186+22.36	Lt.	11.7			Flared Resid. Ent.			
186+45.75	Lt.	8.3			Flared Resid. Ent.			
186+50.00	Rt.		85.3		2nd Avenue Intersection			
187+55.36	Lt.		65.2		Curbed Comm. Ent. (Patriots Bank)			
187+95.74	Rt.		59.6		Curbed Comm. Ent. (Wise Auto)			
	-				Curbed Comm. Ent. (Wise Auto) Curbed Comm. Ent. (Patriots Bank)			
188+25.54	Lt.	40.0	19.0					
188+32.26	Rt.	16.3		4.0	Flared Alley Entrance			
188+34.38	C.L.		11.0	4.0	Concrete Manhole Collar			
188+71.31	Rt.		44.3		Curbed Comm. Ent. (Askins Beller Liquo			
189+37.39	Rt.		48.3		Curbed Comm. Ent. (Askins Beller Liquo			
189+53.71	C.L.			4.0	Concrete Manhole Collar			
189+63.85	Lt.		72.8		1st Avenue Intersection			
190+19.74	C.L.			4.0	Concrete Manhole Collar			
190+24.51	Rt.		86.0		1st Avenue Intersection			
191+14.43	Lt.	27.1			Flared Comm. Ent.			
191+14.43	Rt.		34.7		Curbed Comm. Ent. (Car Wash)			
191+65.30	Rt.		35.6		Curbed Comm. Ent. (Car Wash)			
191+79.61	Lt.	18.8			Flared Comm. Ent.			
192+15.47	Rt.		36.8		Curbed Comm. Ent. (Sonic)			
192+75.59	Rt.		36.8		Curbed Comm. Ent. (Sonic)			
193+14.10	C.L.			4.0	Concrete Manhole Collar			
193+56.71	Lt.		71.8		Curbed Comm. Ent. (Subway)			
194+21.26	Rt.		80.1		Curbed Comm. Ent. (Garnett State bank)			
TOTAL =	1	245.3	1,091.0	24.0				
		REM	OVAL OF EXISTI	NG STRUCTURE	S			
LOCAT	ION	SIDE	REMARKS					
179+		Rt.	+	5 Lin. Ft. of 2'x2' I	RCB			
180+73				2 Lin. Ft. of 8" PV				
				Lin. Ft. of 2'x2' R				
190+6		Rt.		2 Lin. Ft. of 30" R				
191+6		Lt.		Lin. Ft. of 24" RC				
191+9		Lt.		Possible Buried Manhole & 15 Lin. Ft. of 24" RCP Storm Sewer				
193+0	J5	Rt.	Storm Junction	Box/Manhole & 1	36 Lin. Ft. of 36" RCP Storm Sewer			

The schedule for "Removal of Existing Structures" is for information only and may not be complete. Payment for structures or obstructions not listed but whose removal is required by construction, as determined by the Engineer, shall not be paid for separately, but shall be included in the bid item "Removal of Existing Structures".

RCP

44

197

(REINF.) 15" 18" 24" 30" 7.0 s.f. 10.0 s.f.

176

92

190

100

241 220 280 652 152 368

152

230

138

STRUCTURES (EACH)

BOX

LOCATION SIDE INLET

Lt.

1

1

1

1

Rt. 1

Rt. 1

Rt.

Lt.

TOTALS = 15

179+40.00

180+10.00

181+15.00

182+15.00

182+15.00

184+00.00

186+00.00 187+10.00 187+10.00

189+05.00

190+65.00 193+03.00

190+25.00

192+10.00

193+95.00 Lt.

JUNCTION | MANHOLE

DRAINAGE STRUCTURES, STORM SEWER, AND PIPES

RCP or PE

24"

177

12

STORM SEWER (LIN. FT.)

RCPHE

			EARTHW	ORK						
			EXCAVA [*]	TION				COMPACTION		
	COMMON		ROCK		CONTR.	FURN.	TYPE AA (MR-)	TYPE A (MR-)	TYPE B (MR-90)	
LOCATION	CU. YDS.		CU. YDS.	VMF	CU. YDS.	VMF	CU. YDS.	CU. YDS.	CU. YDS.	
Maple Street (US-59	225	0.83	460	1.00					50	
TOTALS =	225		460						50	
NOTES										
1. Volume Modification Factors (VMF's) are	assumed.									
2. Rock Excavation has been estimated ba		-				•			veways, and	

COMBINED CURB AND GUTTER (AE)								
		LIN.	, ,					
LOCATION	SIDE	Type I	Type II	REMARKS				
179+91 to SW Return 3rd Ave	Lt.	159.1	105.0					
NW Return 3rd Ave to Ent. 187+55.36	Lt.	374.5	131.0					
Ent. 187+55.36 to Ent. 188+25.54	Lt.	61.2						
Ent. 188+25.54 to SW Return 1st Ave	Lt.	138.0						
NW Return 1st Ave to Ent. 193+56.71	Lt.	314.8	70.2					
Ent. 193+56.71 to END	Lt.	92.7	20.0					
179+29.11 to Ent. 180+09.95	Rt.	74.2						
Ent. 180+09.95 to SE Return 3rd Ave	Rt.	218.7	30.0	Includes SE Curb Return				
NE Return 3rd Ave to SE Return 2nd Ave	Rt.	293.0	81.2	Includes Curb Returns				
NE Return 2nd Ave to Ent. 187+95.74	Rt.	127.2	6.0	Includes NE Curb Return				
Ent. 187+95.74 to Ent. 188+71.31	Rt.	40.6	23.4					
Ent. 188+71.31 to Ent. 189+37.39	Rt.	54.8	11.0					
Ent. 189+37.39 to SE Return 1st Ave	Rt.	79.5	11.5	Includes SE Curb Return				
NE Return 1st Ave to Ent. 191+14.43	Rt.	75.6	6.0	Includes NE Curb Return				
Ent. 191+14.43 to Ent. 191+65.30	Rt.	37.7						
Ent. 191+65.30 to Ent. 192+15.47	Rt.	32.6						
Ent. 192+15.47 to Ent. 192+75.59	Rt.	38.1						
Ent. 192+75.59 to Ent. 194+21.26	Rt.	134.6	5.5					
Ent. 192+75.59 to END	Rt.	56.6	4.6					
ТО	TALS =	2,403.5	505.4					

ADJUSTMENT OF WATER VALVE BOX, WATER METER BOX, AND MANHOLE								
		А	DJUST (E	ACH)				
		WATER VALVE	WATER METER					
LOCATION	SIDE	BOX	BOX	MANHOLE	REMARKS			
180+79.12	C.L.			1	San Sewer MH			
184+57.48	C.L.			1	San Sewer MH			
188+34.38	C.L.			1	San Sewer MH			
189+53.71	C.L.			1	San Sewer MH			
190+19.74	C.L.			1	San Sewer MH			
193+14.10	C.L.			1	San Sewer MH			
	TOTAL =			6				

SIDEWALK CONSTRUCTION (AE)								
		QUANTITY (SQ. YDS.)						
LOCATION	SIDE	4" SIDEWALK	REMARKS					
SW Cor. 3rd & Maple	Lt.	2.8						
SE Cor. 3rd & Maple	Rt.	11.6						
NE Cor. 3rd & Maple	Rt.	8.6						
SE Cor. 2nd & Maple	Rt.	11.1						
NE Cor. 2nd & Maple	Rt.	8.3						
188+45.00	Rt.	7.8						
189+00.00	Rt.	15.6						
189+80.00	Rt.	25.0						
NE Cor. 1st & Maple	Rt.	4.5						
193+50.00	Rt.	55.9						
NE Corner Country/Kansas	Rt.	4.4						
TO	DTAL =	155.6						

	AGGRE	GATE BASE (A	AB-3)(6")
		QUANTITY	
LOCATION	SIDE	(Sq. Yds.)	REMARKS
179+91 to 182+19.40	Lt.	76.1	Under Curb and Gutter
3rd Avenue Intersection	Lt.	116.3	Under Apron & Curb Returns
182+88.40 to 189+31.85	Lt.	214.5	Under Curb and Gutter
1st Avenue Intersection	Lt.	93.6	Under Apron & Curb Returns
189+95.85 to 194+77.05	Lt.	160.4	Under Curb and Gutter
179+29.11 to 182+33.13	Rt.	101.3	Under Curb and Gutter
3rd Avenue Intersection	Rt.	112.0	Under Apron & Curb Returns
183+04.13 to 186+15	Rt.	103.6	Under Curb and Gutter
2nd Avenue Intersection	Rt.	108.8	Under Apron & Curb Returns
186+85 to 189+90	Rt.	101.7	Under Curb and Gutter
1st Avenue Intersection	Rt.	109.7	Under Apron & Curb Returns
190+60.40 to 194+77	Rt.	138.9	Under Curb and Gutter
	TOTAL =	1,436.9	

	PCCP PATCHING (FULL DEPTH)(UNSOUND)								
		9"							
LOCATION	SIDE	(SQ. YDS.)	REMARKS						
179+50.00	Rt.	22.4	For Removal of Exist. Storm Sewer						
180+78.83	C.L.	24.0	For Storm Sewer X-ing US-59						
180+79.12	C.L.	24.0	For Storm Sewer X-ing US-59						
182+53.90	Lt.	3.3	For Connection to Exist. Storm Sewer						
On the Project	Rt.	50.0	Contingency Quantity for Patches after Milling						
-	TOTAL =	123.7							

	-							
ENTRAN	ICE PIPE (LIN. FT.)	END SI	ECTIONS	(EACH)	FLOWABLE		
C	CAP or RCI	Р		CA or RC		FILL		_
12"	18"	24"	12"	18"	24"	(CU. YDS.)	REMARKS	_
						29	Flowable Fill for Pipe Removal	L
						5		
						5		
						5		<u> </u>
						3		
							4"x8' Opening in Back	
							4"x8' Opening in Back	
					-	+	+	

47

	SIDEV	VALK RAMP (A	AE)
LOCATION	SIDE	QUANTITY (Sq. Yds.)	REMARKS
SW Cor. 3rd & Maple	Lt.	4.9	Curb Ramp (Type 1)
SE Cor. 3rd & Maple	Rt.	8.0	(2 each) Curb Ramp (Type 1)
NE Cor. 3rd & Maple	Rt.	4.3	Curb Ramp (Type 1)
SE Cor. 2nd & Maple	Rt.	3.8	Curb Ramp (Type 1)
NE Cor. 2nd & Maple	Rt.	4.4	Curb Ramp (Type 1)
188+55.00	Rt.	3.7	Curb Ramp (Type 1) - Omit Domes
188+85.00	Rt.	3.7	Curb Ramp (Type 1) - Omit Domes
189+20.00	Rt.	3.7	Curb Ramp (Type 1) - Omit Domes
189+52.00	Rt.	3.7	Curb Ramp (Type 1) - Omit Domes
SE Cor. 1st & Maple	Rt.	4.4	Curb Ramp (Type 1)
NE Cor. 1st & Maple	Rt.	4.4	Curb Ramp (Type 1)
193+00.00	Rt.	4.9	Curb Ramp (Type 1) - Omit Domes
194+00.00	Rt.	3.8	Curb Ramp (Type 1) - Omit Domes
194+43.00	Rt.	3.2	Curb Ramp (Type 1) - Omit Domes
	TOTAL =	60.9	

STATE	PROJECT NO.	YEAR	SHEET NO.	TOTAL SHEETS
ANSAS	59-2 KA-5422-01	2022	25	69

RECAPITULATION OF ROAD	QUANTITIES	
ITEM	QUANTITY	UNIT
Contractor Construction Staking	Lump Sum	Lump Sum
Field Office and Laboratory (Type A)	1	Each
Foundation Stabilization (Set Price)	1	Cu. Yd.
Mobilization	Lump Sum	Lump Sum
Mobilization (DBE)	Lump Sum	Lump Sum
Removal of Existing Structures	Lump Sum	Lump Sum
Clearing and Grubbing	Lump Sum	Lump Sum
Common Excavation (Urb)	225	Cu. Yd.
Rock Excavation	460	Cu. Yd.
Compaction of Earthwork (Type B)(MR-90)	50	Cu. Yd.
Water (Grading)(Set Price)	1	M. Gal.
Inlet (Curb)(Setback)	15	Each
Curb and Gutter, Combined (AE)	1,455	Lin. Ft.
Storm Sewer (15")(RCP)	241	Lin. Ft.
Storm Sewer (18")(RCP)	220	Lin. Ft.
Storm Sewer (24")(RCP)	280	Lin. Ft.
Storm Sewer (24")	189	Lin. Ft.
Storm Sewer (30")(RCP)	652	Lin. Ft.
Storm Sewer (7.0 s.f.)(RCPHE)	152	Lin. Ft.
Storm Sewer (10.0 s.f.)(RCPHE)	368	Lin. Ft.
Flowable Fill (Low Strength)	47	Cu. Yd.
, ,		
Sidewalk Construction (4")(AE)	156	Sq. Yd.
Sidewalk Ramp	61	Sq. Yd.
Concrete Pavement (6" Uniform)(AE)	245	Sq. Yd.
Concrete Pavement (8" Uniform)(AE)	1,091	Sq. Yd.
Concrete Pavement (10" Uniform)(AE)	24	Sq. Yd.
PCCP Patching (Full Depth)(9")(Unsound)	124	Sq. Yd.
Aggregate Base (AB-3)(6")	1,437	Sq. Yd.
Water (Aggregate Base)(Set Price)	1	M. Gal.
Adjustment of Manhole	6	Each
Adjustment of Meter Box (Water)	x	Each
Adjustment of Valve Box (Water)	X	Each

For Surfacing Quantities, see Sheet 26
For Temporary Erosion and Pollution Control Quantities, see Sheet 27
For Permanent Seeding Quantities, see Sheet 36
For Pavement Marking Quantities, see Sheet 41
For Permanent Signing Quantities, see Sheet 47
For Traffic Control Quantities, see Sheet 63

2	1-14-08	Rem. Drainage Structure summary	S.W.K.	J.O.B.]
1	1-9-91	Detailed on CADD	R.J.S	J.O.B.	
NO.	DATE	REVISIONS	BY	APP'D]
		KANSAS DEPARTMENT OF TRANSPORTATION			Certified
	Sl	JMMARY OF QUANTITIE	S		cs Ce

RD050 FHWA APPROVAL _5-28-08

KDOT Graphics Certified 03-13-2018

Over all structures, unless otherwise directed by the Engineer, where the top of the hubguard is level with or above the finished shoulder grade, the earth cover over the structure slab shall be removed and backfilled with _____ material

as directed by the Engineer. The removal of this material will be subsidiary. The _____ material used to backfill over the structure shall be paid for at the prices shown in the contract.

The earth shoulders shall be compacted full depth (Type -MR) except, when ordered by the Engineer, the top 3" shall be left uncompacted for seeding.

All side roads and house entrances shall be surfaced with to the R/W line as indicated on the detail. All side roads and house entrances with existing asphalt surface shall be surfaced with _____ at least to the R/W line or to the end of construction, as directed by the Engineer. Each mailbox turnout (ON PROJECTS WHERE STABILIZED SHOULDERS ARE NOT SPECIFIED) shall be surfaced

<u>to the limits shown on the detail.</u> Surfacing material (SA-_____) shall be used for surfacing house entrances and side roads (C.Y./SQ. YD.) beyond the limits of the asphalt surface to the

The thickness of side road and entrance surfacing may be increased to the same thickness as the stabilized shoulder within the approximate limits of the shoulder.

limits of construction as determined by the Engineer.

On projects which specify both asphalt base and surface course materials, side roads, house entrances and mailbox turnouts may be surfaced with both materials at the contractors option, with the approval of the Engineer.


Quantities for aggregate for shoulders, AS-1, are calculated on the basis of 150 lbs. per cu. ft. Quantities for stabilized base course, AB-3, are calculated on the basis of 1 56 lbs. per cu. ft. Weight/cu. ft. includes moisture allowed by specification.

The base course shall be constructed to the plan thickness as shown.

Thicknesses indicated for all construction which is paid for on a weight or volume basis are approximate and may vary to correct for unevenness in the foundations or for other normal unevenness encountered in placement operations.

A tack coat of SS-1HP shall be provided between each lift of all base courses and surface courses and under the first lift of base or surface courses when they are placed on an existing asphalt, brick, or concrete surface, when so ordered by the Engineer and at the rate designated by him. Quantities are included for these tacks calculated at the rate of 0.06 gal. /sq. yd.

Asphalt Material quantities are calculated on the basis of 8.328 lbs. per gal. Shoulder rumble strips will not be constructed as part of this project.

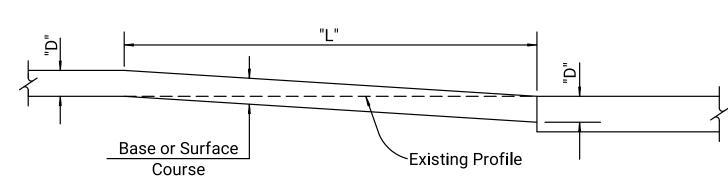

TYPICAL PROFILE AT GRADE CONTROL POINTS

The Contractor shall cut the subgrade in accordance with this profile at all grade control points, i.e.; existing pavements, grade bridges and R.R. crossings, also at changes in thickness of base or surface courses. Corresponding dimensions of "D" and "L" shall be as given in the table below.

The work of cutting the subgrade and disposing of excess excavated material shall be subsidiary to other items in the contract.

			Т	ABLE	OF DI	MENS	IONS				
D	L	D	L	D	L	D	L	D	L	D	L
1"	25'	3"	75'	5"	125'	7"	175'	9"	225'	11"	275'
2"	50'	4"	100'	6"	150'	8"	200'	10"	250'	12"	300'

SU	MMARY O	F QUANTI	ΓIES			
ITEM	MAINLINE	MAINLINE			TOTAL	UNIT
MILLING						
STA. 179+18 to STA. 190+50 (36' WIDTH)	4,528.0	4,528.0			4,528.0	SQ. YD.
STA. 190+50 to STA. 191+00 (36' TO 43' WIDTH)	219.4	219.4			219.4	SQ. YD.
STA. 191+00 to STA. 194+77 (43' WIDTH)	1,801.2	1,801.2			1,801.2	SQ. YD.
STA. 194+77 to STA. 195+30 (VARIABLE WIDTH TRANSITION)	282.0	282.0			282.0	SQ. YD.
# HMA - COMMERCIAL GRADE (CLASS A)	Ø BASE	## SURFACE				
STA. 179+18 to STA. 190+50 (36' WIDTH)	361.0	517.0			878.0	TON
STA. 190+50 to STA. 191+00 (36' TO 43' WIDTH)	17.5	25.1			42.6	TON
STA. 191+00 to STA. 194+77 (43' WIDTH)	143.7	205.7			349.4	TON
STA. 194+77 to STA. 195+30 (VARIABLE WIDTH TRANSITION)	22.5	32.2			54.7	TON
# HMA - COMMERCIAL GRADE (CLASS A)(PATCHING)						
BEGIN TO END	150.0				150.0	TON
					100.0	

≠ COMPUTED AT THE RATE OF 145 LBS. PER CU. FT.

 ϕ QUANTITIES INCLUDE A 10% CONTINGENCY FOR VARIATIONS IN THE EXISTING MILLED PAVEMENT SURFACE.

☐ QUANTITIES INCLUDE A 5% CONTINGENCY FOR VARIATIONS IN THE EXISTING MILLED PAVEMENT SURFACE (IN AREAS WITHOUT A LEVELING BASE COL

OTAL	UNIT	
,528.0	SQ. YD.	
219.4	SQ. YD.	
,801.2	SQ. YD.	
282.0	SQ. YD.	
878.0	TON	
42.6	TON	
349.4	TON	
54.7	TON	♦ Width shall be 8' or shoulder width, whichever i
150.0	TON	Note: The face of Mail Box should be no closer to the roadway than the edge of the shoulder. Align with edge of turnout when turnout width is greater than shoulder width.
		<u></u>
		1
		Į DE
	1	1
OURSE).		_

RECAPITULATION OF QUANTITIES

ITEM

HMA - COMMERCIAL GRADE (CLASS A)(PATCHING)

HMA - COMMERCIAL GRADE (CLASS A)

MILLING

Surfaced Roadbed Shoulder Line M.B. Turnout nall be 8' or shoulder width, whichever is greater.

PROJECT NO.

59-2 KA-5422-01

YEAR | SHEET NO.

26

2022


SECTION A-A

STATE

KANSAS

edge of turnout when turnout width 110' | 15' | 15' | 40' ✓ Mail Box Direction of Traffic Edge of Surfacing~

DETAIL FOR SURFACING OF MAIL BOX TURNOUTS

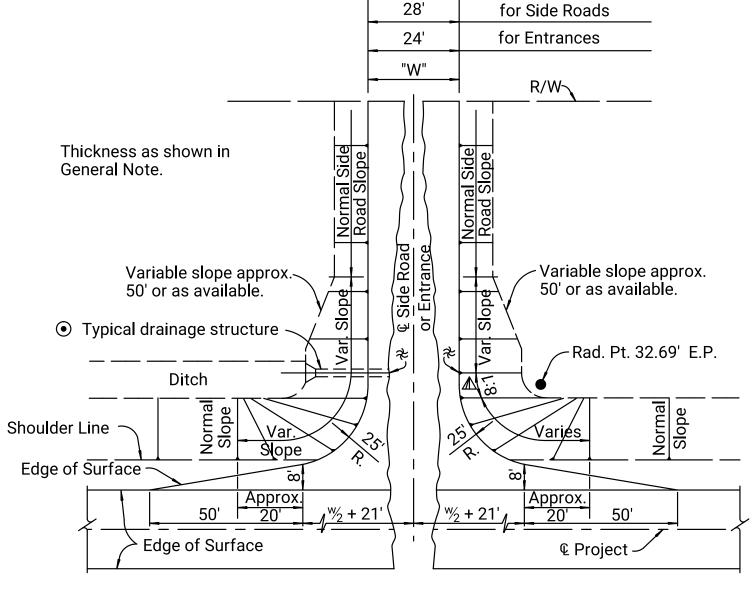

WITH DRAINAGE STRUCTURE

UNIT

TON

TON

TOTAL

6,831

1,325

150

MOUND ENTRANCE OR SIDE ROAD

DETAIL FOR SURFACING OF SIDE ROADS & HOUSE ENTRANCES

▲ 8:1 Slope at the appropriate clear zone shall apply to all mound entrances SQ. YD. and mound side roads to 10' fill height.

Normal Slope (but not steeper than 6:1) for over 10' fill height. Normal Slope (but not steeper than 6:1) at approximate & Structure or appropriate clear zone width.

 On side roads and entrances which slope toward the highway, a low point approx. 6" deep shall be constructed to divert surface drainage into the highway ditch, unless otherwise shown on the plans.

12	1-10-07	Changed bituminous to asphalt	S.W.K.	J.O.B.
11	8-30-06	Changed tack type/rate	S.W.K.	J.O.B.
10	3-24-05	Revised compaction, tack type/rate	S.W.K.	J.O.B.
9	6-12-02	Added low point off shoulder.	S.W.K.	J.O.B.
NO.	DATE	REVISIONS	BY	APP'D

KANSAS DEPARTMENT OF TRANSPORTATION

SUMMARY OF QUANTITIES (Surfacing)


RD051 APP'D. James O. Brewer


RATES OF APPLICATION					
RATE	UNIT	ITEM			

	†	Comp	outed at	the rate of	of
-	††	Com	outed at	the rate of	of

FHWA APPROVAL 9-06-06 TRACED Bowser
TRACE CK. Hecht

KDOT Graphics Certified 07-20-2021

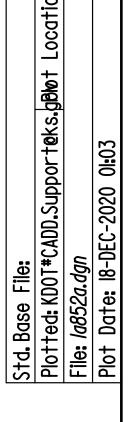

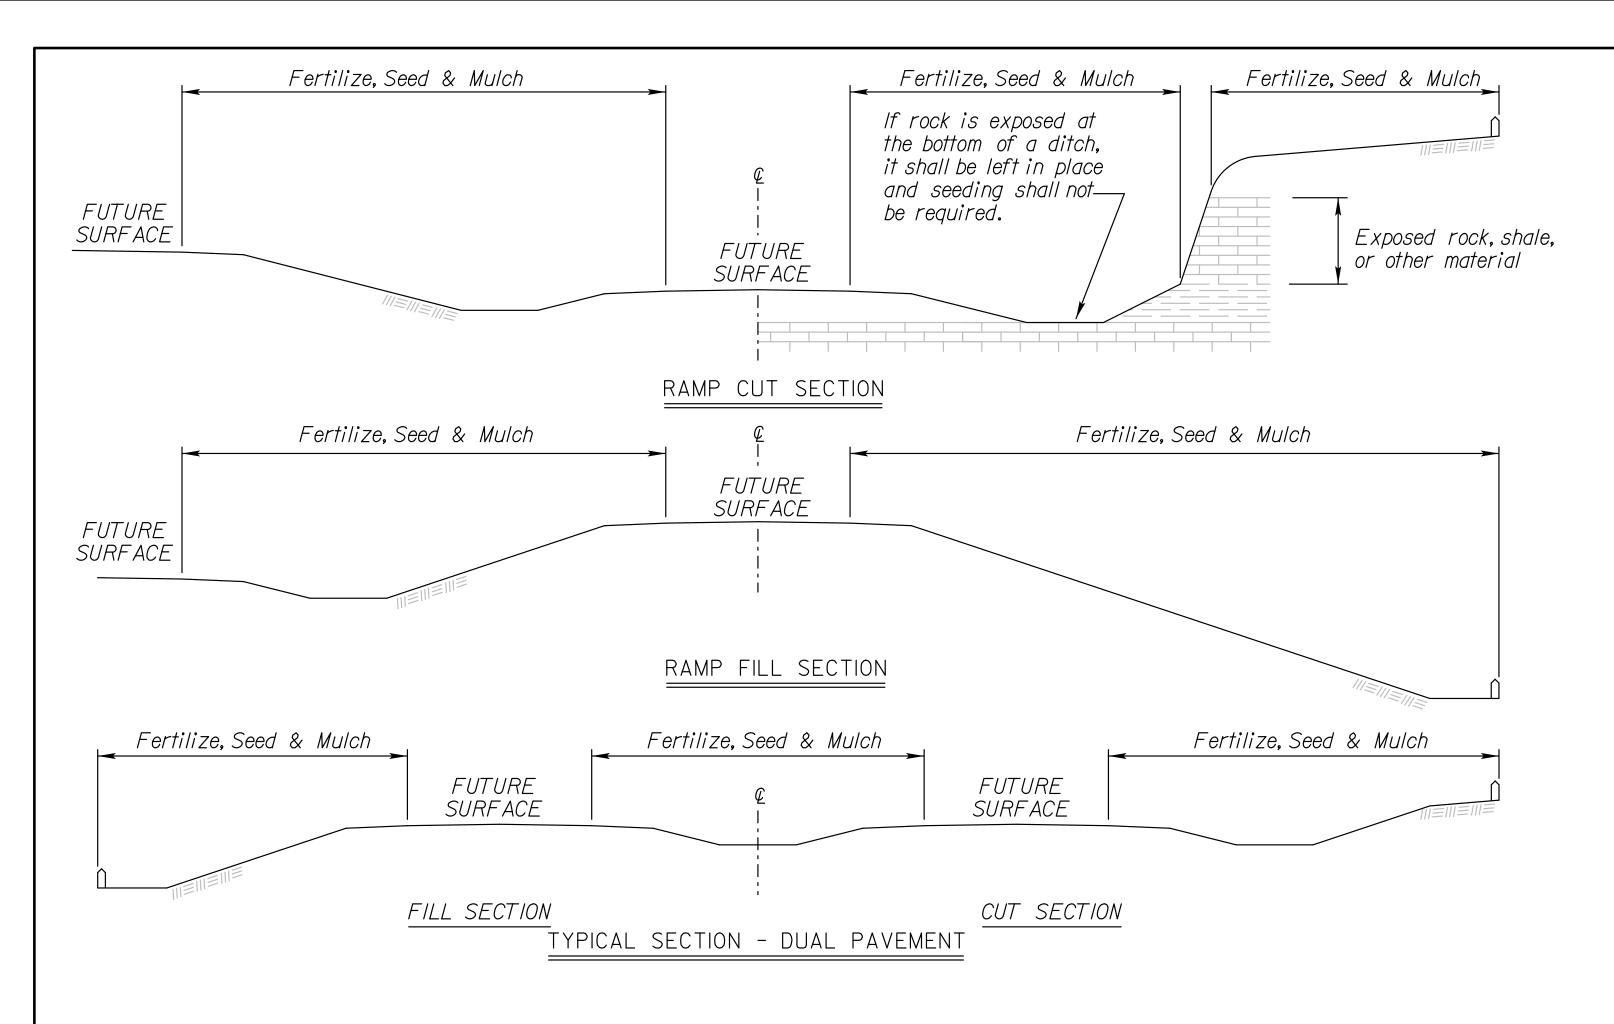

FERTILIZER: A ratio and application rate that equals or exceeds the required minimum rate per acre of N, P₂ O₅, K₂O listed in Summary of Quantities will be acceptable.

- * N = Nitrogen Rate of Application
- ** P₂ O₅ = Phosphorous Rate of Application
- *** $\overline{K_20}$ = Potassium Rate of Application

The Contractor will be required to finish areas of excavation, borrow and embankment in accordance with the specifications. Areas that require installation or construction of temporary water pollution control items will be finished in reasonable close conformity to the alignment, grade and cross section shown on the plans or as established by the Engineer.

CLT = Construction Limit Tract. This area is defined by the entire disturbed area of the project that requires seeding and erosion control measures to be placed. Any impervious areas (i.e. pavement, gravel, riprap, etc.) shall not be included in this measurement.

Slope = Defined by the area of the project that requires Class I erosion control material to be placed. This area shall be seeded using the Soil Erosion Mix prior to placement of the material. Drilling seed is preferred, however, broadcasting is acceptable if drilling is not possible.

Channel = Defined by the area of the project that requires Class 2 erosion control material to be placed. This area shall be seeded using the Soil Erosion Mix prior to placement of the material. Drilling seed is preferred, however, broadcasting is acceptable if drilling is not possible.

GENERAL NOTES

The entire disturbed area, excepting the paved or surfaced areas, steep rocky slopes and areas of undisturbed native sod or other desirable vegetation shall be fertilized (limed when required), seeded, and mulched. Soil preparation shall conform to the Standard Specifications.

Temporary seeding shall be done during any time of the year that the soil can be cultivated. After the temporary seeding has been completed on the entire project, permanent seeding shall be done during the normal seeding season.

MULCHING: Mulch shall be spread uniformly over all disturbed areas and punched in the soil, unless otherwise noted on the plans. The rate of application per acre, thickness in place, for the mulching materials is generally as follows:

 $1\frac{3}{4}$ - $2\frac{1}{4}$ Tons per Acre = $1\frac{1}{2}$ " loose depth spread uniformly over acre.

Agricultural products, such as native prairie hay, used for mulching and erosion control practices, excluding wood based mulch, shall meet the North American Weed Free Forage Standards.

Other vegetative mulches are acceptable only with the Engineer's concurrence.

The above rate is a guide. It will be at the discretion of the Engineer to determine what rate is sufficient for adequate protection of newly seeded areas.

STATE	PROJECT NO.	YEAR		TOTAL SHEETS
KANSAS	59-2 KA-5422-01	2022	27	69

	SUMN	MARY	OF S	SEEDING / EROSION CONTROL Q	UANTITIES	
P.L.S. RAT	E/ ACRE	ACF	RES	DID ITEM	01144171717	
CLT	SL/CH	CLT	SL/CH	- BID ITEM	QUANTITY	UNIT
100		0.8		Temporary Fertilizer (15-30-15)		LB
50		0.8		Temporary Seed (Annual Ryegrass)		LB
				Temporary Seed (Grain Oats)		LB
				Temporary Seed (Sterile Wheatgrass)		LB
				Soil Erosion Mix		LB
				Erosion Control(Class 1, Type C)	1,450	SQ YD
				Erosion Control(Class 2, Type Y)		SQ YD
				Sediment Removal(Set Price)	1	CU YD
				Synthetic Sediment Barrier		LF
				Temporary Berm (Set Price)		LF
				Temporary Ditch Check (Rock)		CU YD
				Temporary Inlet Sediment Barrier		EACH
				Temporary Sediment Basin		CU YD
				Temporary Slope Drain		LF
				Temporary Stream Crossing		EACH
				Biodegradable Log (9")		LF
				Biodegradable Log (12")	500	LF
				Biodegradable Log (20")		LF
				Filter Sock (8")	150	LF
				Geotextile (Erosion Control)		SQ YD
				Silt Fence		LF
				SWPPP Design †		LS
				SWPPP Inspection #		EACH
				Water Pollution Control Manager †		EACH
	/ acre			Mulch Tacking Slurry		LB
2 tons	/ acre	0.5		Mulching		TON
				Water (Erosion Control) (Set Price)		MGAL

NOTE: Projects less than I acre shall be bid as "Seeding" by the lump sum. See Permanent Seeding Summary of Seeding Quantities sheet LA850 for further details.

Geotextile (Erosion Control) shall be removed prior to placement of permanent slope protection.

Regreen and Quick Guard are the approved sterile wheatgrass products.

† If the total disturbed area of the project, not just the seeding area, is I acre or more, then these bid items must be included.

**** List size of material.

The amount of mulch and mulch tacking slurry in the bid quantities is estimated. (Acres of Seeding X 1.5 X 2 Tons/Acre). The estimated quantity includes mulching associated with both temporary and permanent seeding operations. The total mulch and mulch tacking slurry required shall be determined in the field. The bid item for mulching and mulch tacking slurry shall be paid for according to the Standard Specifications.

Quantities for all erosion control items are estimated to give full flexibility for compliance with the NPDES permit. Final quantities will be determined in the field.

SC	IL EROSION MI	X
PLS RATE	NAME	QTY (lb)
	Total	(lb)

The Soil Erosion Mix is to be placed under the Class I and/or Class 2 erosion control material.

The Soil Erosion Mix consists of the Shoulder Area of the Permanent Seed Mix used on the project.

NO.	DATE	REVISIONS	BY	APP'D
ı	06/01/17	Revised Standard	MRD	SHS
2	12/01/17	Revised Standard	MRD	SHS
3	08/03/20	Added Note	MRD	ML

KANSAS DEPARTMENT OF TRANSPORTATION

TEMPORARY EROSION AND POLLUTION CONTROL

LA852A

FHWA APPROVAL 1/26/2018 APP'D Scott H. Shields
DESIGNED MRD DETAILED MRD QUANTITIES CADD
DESIGN CK. SHS DETAIL CK. SHS QUAN.CK. CADD CK.

STATE	PROJECT NO.	YEAR	SHEET NO.	TOTAL SHEETS
KANSAS	59-2 KA-5422-01	2022	28	69

EROSION CO	NTRO	L- Cla	ass 1, Ty	/pe C
LOCATION	SIDE	LENGTH	WIDTH	SQ YARI
On the Project			1112111	1,450.0
				
				+
				+
				+
				1
	1			+
				+
				+
				_
				
				†
				+
TOTAL EROSION CONTRO	<u> </u>		450	<u> </u>

The quantity of Erosion Control (Class 1, Type C) tabulated on this sheet has been included for 0.3 acres of disturbed areas on the Project that are designated to be seeded and fertilized but would be better stabilized with Erosion Control blanket rather than Mulching. Contractor shall install Erosion Control at locations as directed by the Engineer.

> BY APP'D REVISIONS

KANSAS DEPARTMENT OF TRANSPORTATION


EROSION CONTROL SEEDING-SODDING


LA852A-EC

FHWA APPROVAL I/04/2006 APP'D

DESIGNED MRM DETAILED MRM QUANTITIES

DESIGN CK. SHS DETAIL CK. SHS QUAN.CK.

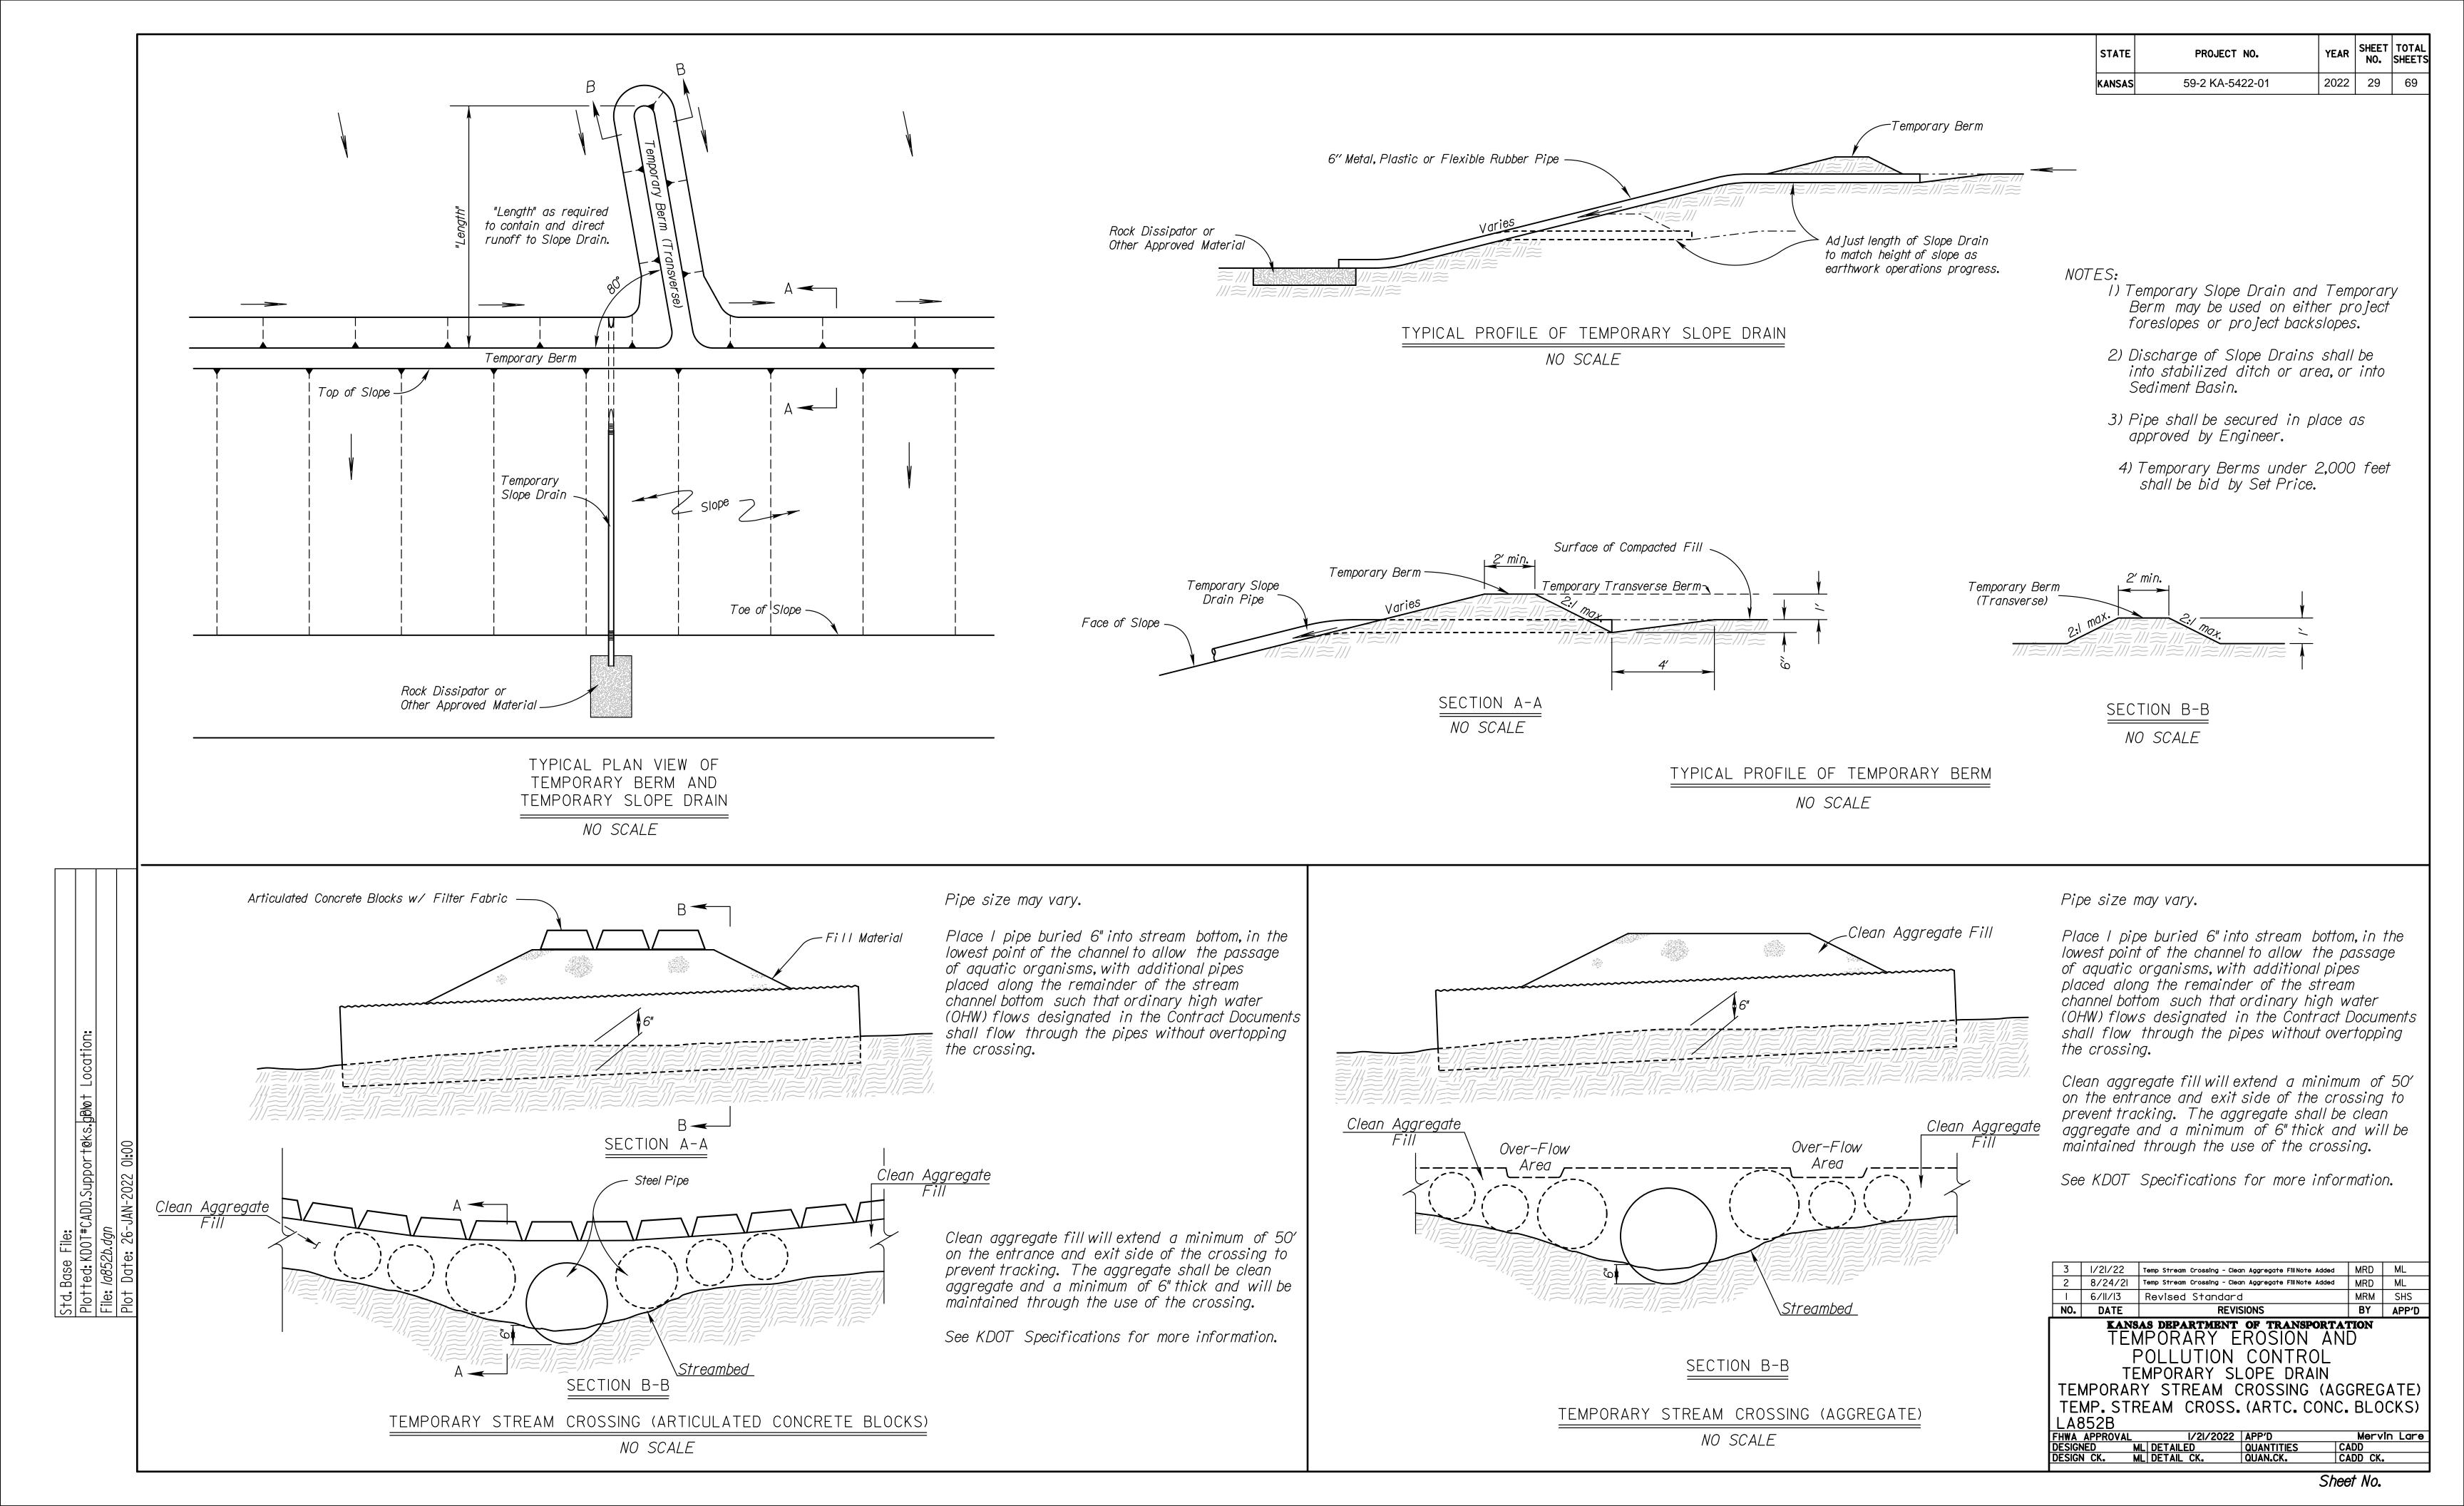

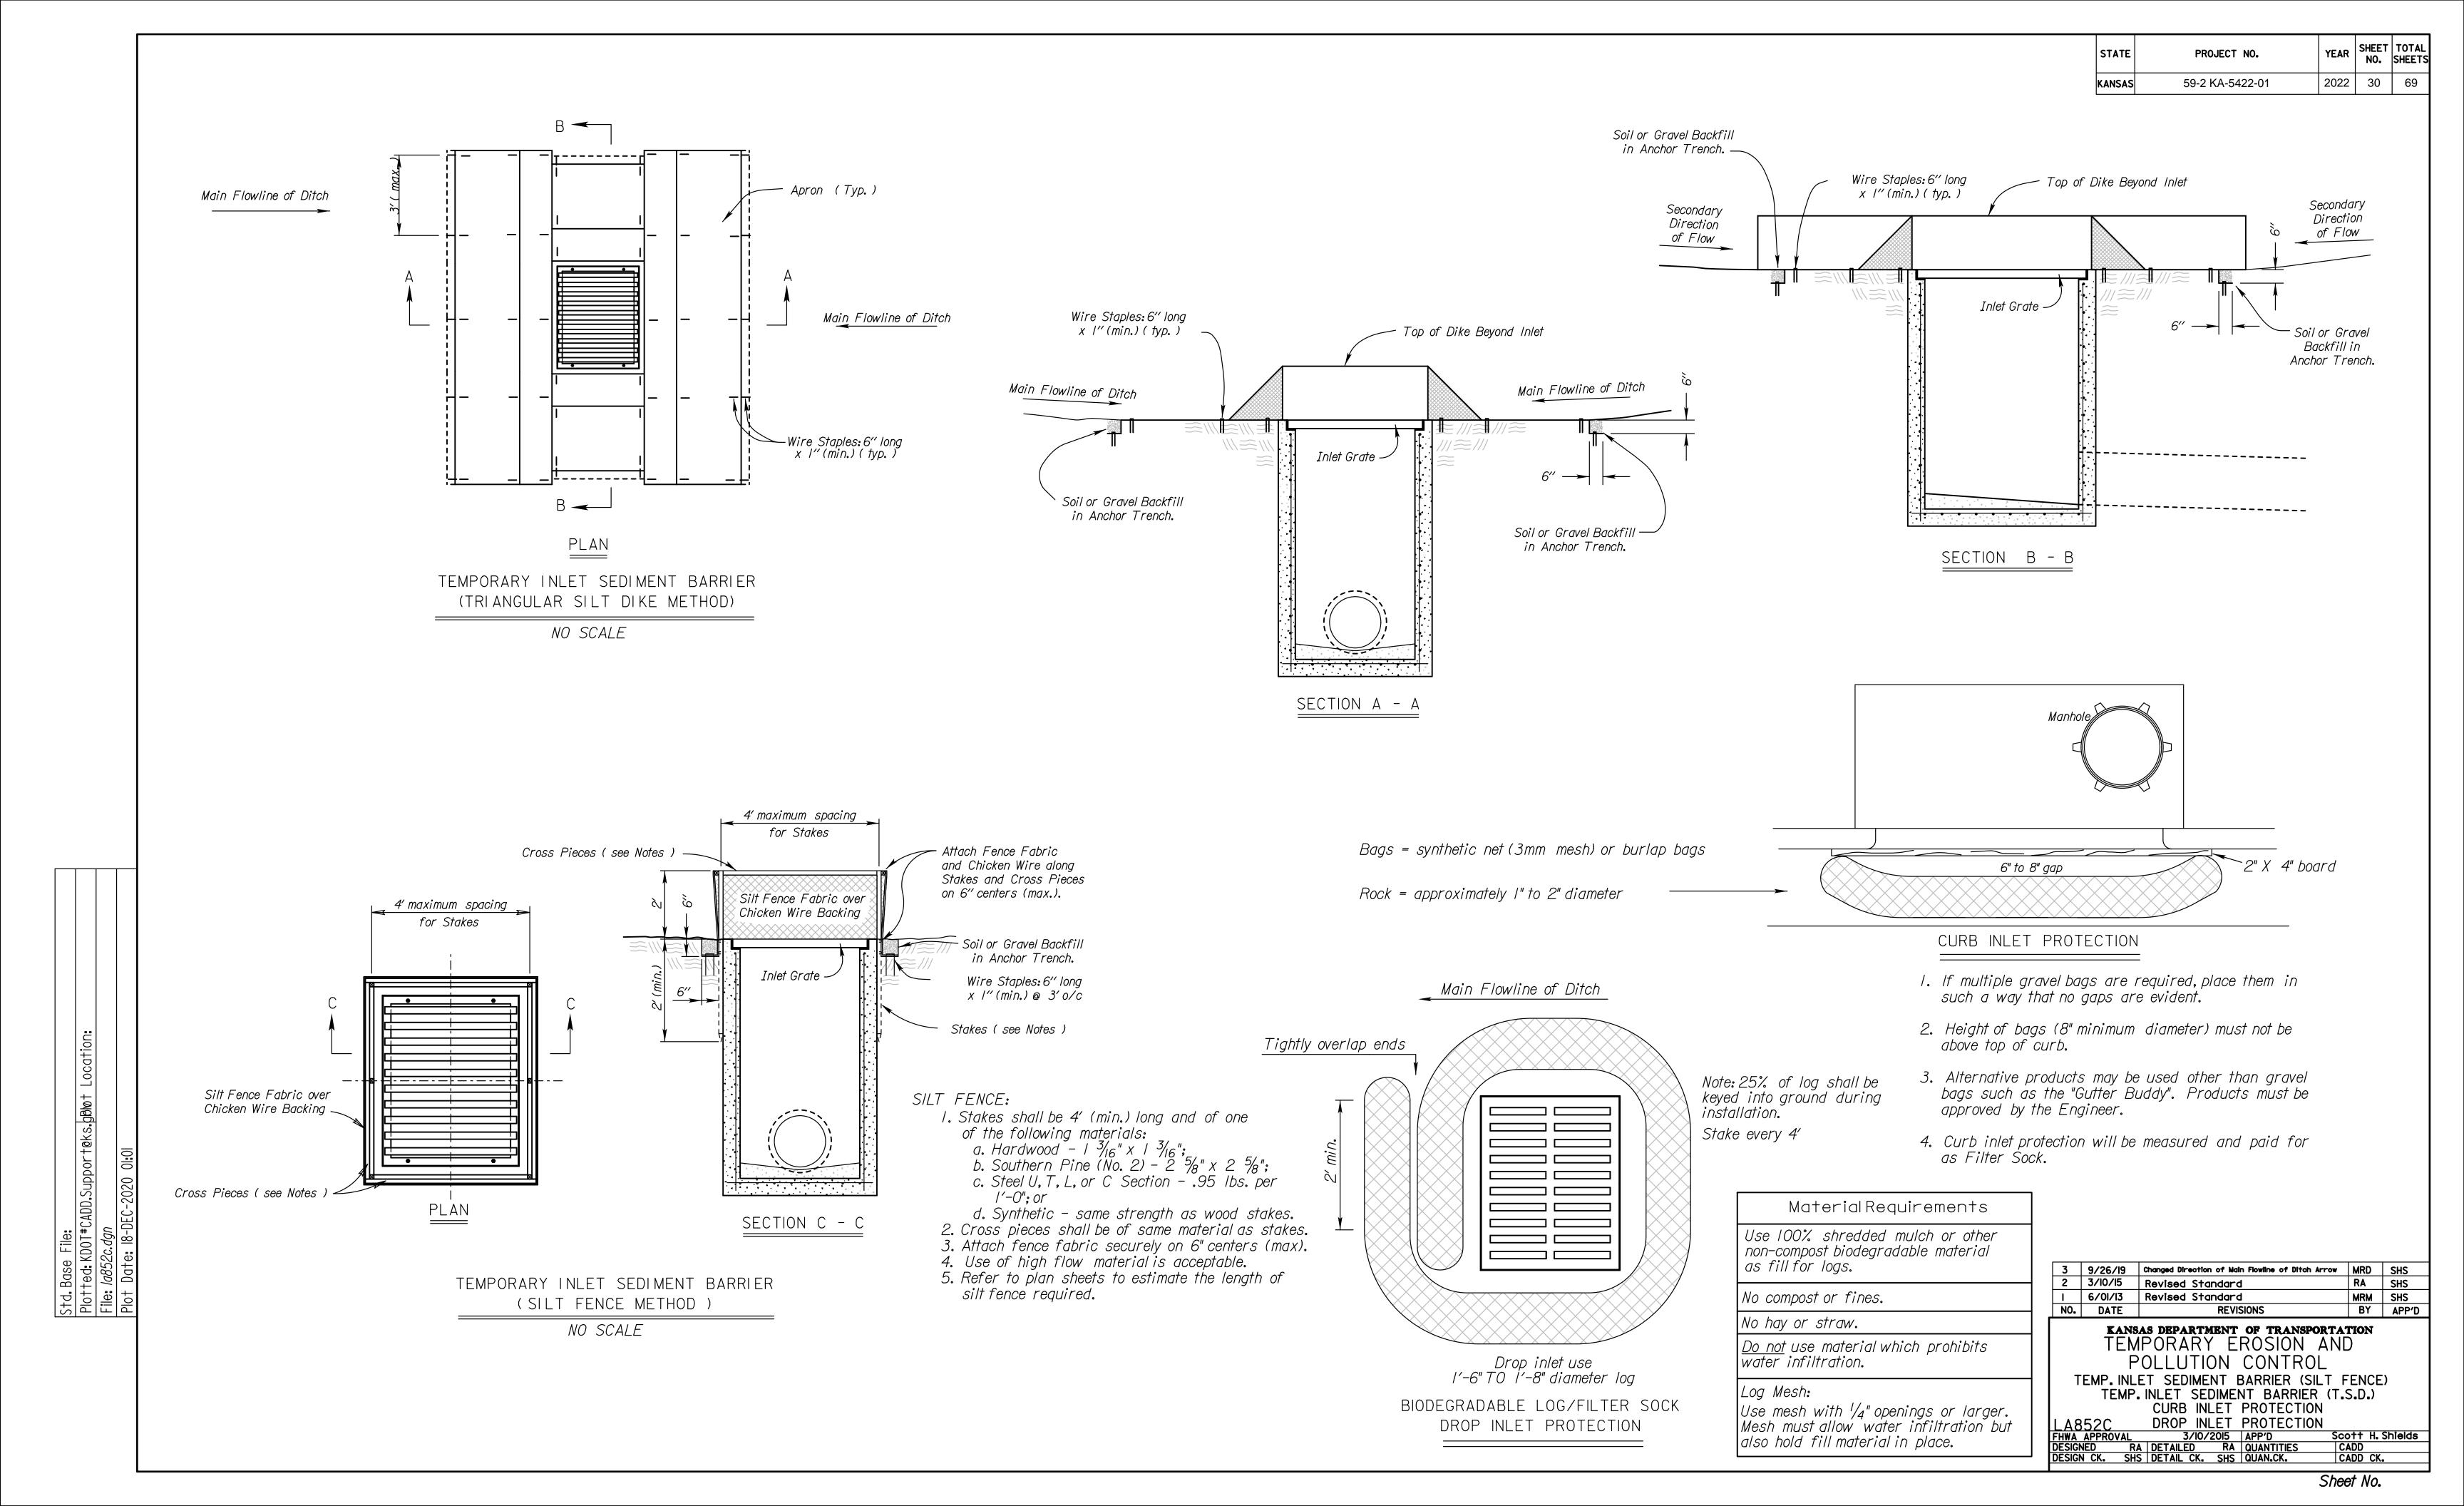

4' (max.) 4' (max.) (on center) (on center) Silt Fence Fabric Soil or Gravel Groundline at Backfill in Anchor Silt Fence Trench TYPICAL ELEVATION SILT FENCE BARRIER NO SCALE Silt Fence Fabric

-18″ (min**.**) diameter

18" (min.) diameter

Alternative Staking (Optional)

Biodegradable Log Section

-Downstream Apron

(Optional)

Location: 1

Plot

1/4h —

1/4h -

Direction of Flow

Direction of Flow

SECTION A - A


ALT. DETAIL

OPTIONAL

Biodegradable Log Section

Downstream Apron

(Optional)

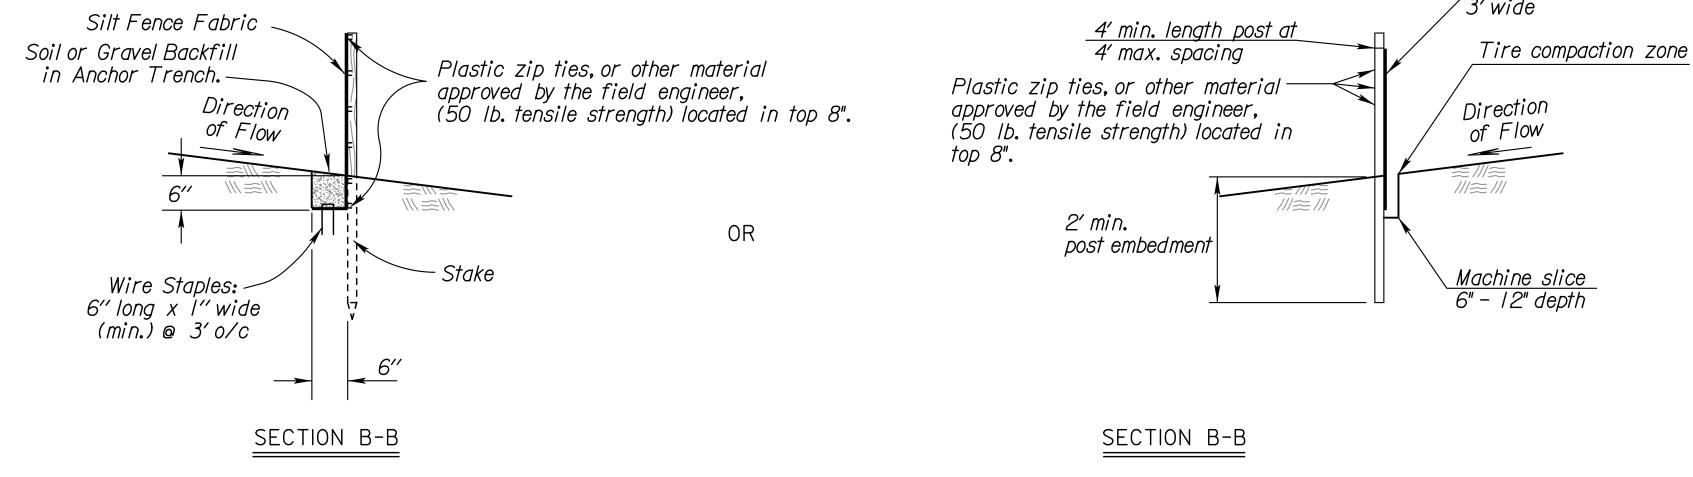

4' (max.)

BIODEGRADABLE LOG SLOPE INTERRUPTIONS

OR Filter Sock

Stakes (typ.)

TYPICAL ELEVATION



STATE	PROJECT NO.	YEAR	SHEET NO.	TOTAL SHEETS
KANSAS	59-2 KA-5422-01	2022	31	69

SILT FENCE:

- I. Stakes shall be 4' (min.) long and of one of the following materials:
 - a. Hardwood | 3/16" x | 3/16";
 - b. Southern Pine (No. 2) 2 \(\frac{5}{8}'' \) x 2 \(\frac{5}{8}'' \);
 - c. Steel U, T, L, or C Section .95 lbs. per I'-O"; or
 - d. Synthetic same strength as wood stakes.
- 2. Attach fence fabric with 3 zip ties within the top 8" of the fence Alternate attachment methods may be approved by the Engineer on a performance basis.
- 3. Use of high flow material is acceptable.
- 4. Refer to plan sheets to estimate the length of silt fence required.

BIODEGRADABLE LOG OR FILTER SOCK

- 1. Place biodegradable logs or filter sock tightly together minimum overlap of 18".
- 2. Wood stakes shall be 2" x 2" (nom.).
- 3. Refer to plan sheets to estimate length of biodegradable log and filter sock required.
- 4. Each log or sock (except compost filter socks) should be keyed into the ground at a minimum of 25% of its height. Compost filter socks should be placed on smooth prepared ground with no gaps between the sock and soil.
- 5. Length of stakes should be 2 times the height of the log at a minimum with minimum ground embedment equal to the height of the log / sock.

Rindearadable Loa or Filter Sock Slope Interruptions

Geotextile fabric

DIOC	iegi adable L	log of Filler Sock	Siope Illiei Lupitolik	5			
	PRODUCT						
		9" Sediment Log or 8" Filter Sock (ft)	12" Sediment Log or 12" Filter Sock (ft)	20" Sediment Log or 18" Filter Sock (ft)			
int	≤4H:/V	40	60	80			
Gradient	3H:IV	30	<i>4</i> 5	60			
Slope (
/S							

		LOW FLOW	HIGH FLOW
	9"	Straw/Compost	Excelsior / Wood Chips / Coconut Fiber
$\left\{ \right.$	12"	Straw/Compost	Excelsior / Wood Chips / Coconut Fiber
	18"-20"	Straw/Compost	Excelsior / Wood Chips / Coconut Fiber
1		.	I.

BIODEGRADABLE LOG MATERIAL

Deviations should be approved by the Field Engineer.

GENERAL NOTES

- I) Slope interruptions shall be placed along contour lines, with a short section turned upgrade at each end of the barrier.
- 2) The maximum length of the slope interruptions shall not exceed 250 feet, and the barrier ends need to be staggered.
- 3) Interruptions damaged by Contractor's negligence, including improper maintenance or lack of maintenance, shall be repaired immediately by Contractor at no additional cost to KDOT.
- 4) Agricultural products, such as native prairie hay, used for mulching and erosion control practices, excluding wood based mulch, shall meet the North American Weed Free Forage Standards.

KANSAS DEDARTMENT OF TRANSPORTATION				
NO.	DATE	REVISIONS	BY	APP'D
1	6/01/13	Revised Standard	MRM	SHS
2	3/01/15	Revised Standard	RA	SHS
3	6/28/16	Revised Standard	RA	SHS

TEMPORARY EROSION AND POLLUTION CONTROL


SLOPE INTERRUPTIONS BIODEGRADABLE LOG / SILT FENCE

FHWA APPROVAL 9/14/2016 APP'D
DESIGNED SHS DETAILED RA QUANTITIES
DESIGN CK. SHS DETAIL CK. QUAN.CK. Scott H. Shields
| CADD | CADD | CK.

Sheet No. 0

CADconform Certify This File

STATE	PROJECT NO.	YEAR	SHEET NO.	TOTAL SHEETS
KANSAS	59-2 KA-5422-01	2022	32	69

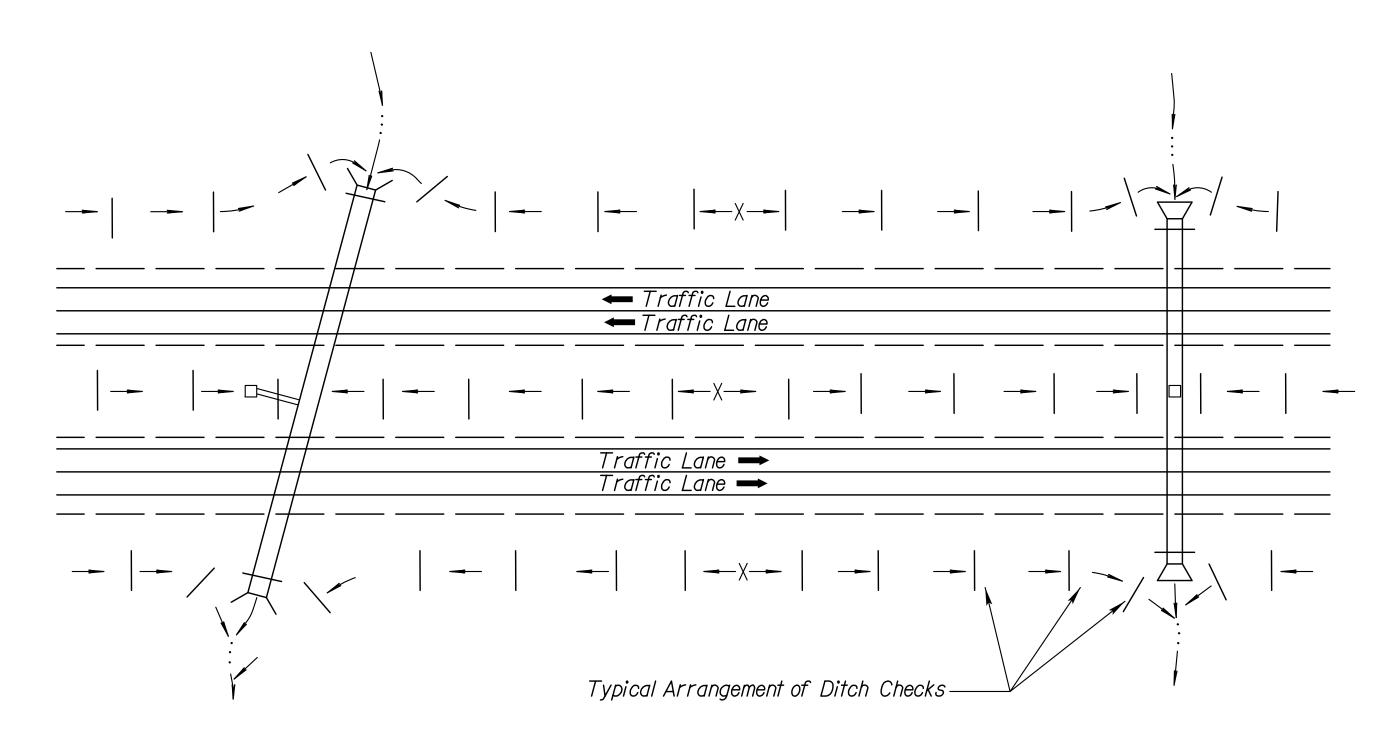

TYPICAL DITCH CHECK LAYOUT PLAN

NO SCALE

GENERAL NOTES

- The choice of ditch check methods is at the option of the Contractor.
- 2) Use only rock checks in situations where the ditch slope is 6 percent or greater.

Plot

2) Ditch checks damaged by Contractor's negligence, including improper maintenance or lack of maintenance, shall be repaired by Contractor at no extra cost to KDOT.

2011	IOLOG
CHECK	SPACING
DITCH Q SLOPE (%)	SPACING INTERVAL (FEET)
1.0	125
2.0	60
3.0	40
4.0	30
5.0	25

5. <i>0</i>	25
NOTE: Use this space except Rock Ditch Cl	cing for all hecks.

I8" FILTE	18" FILTER SOCK		
CHECK	SPACING		
DITCH Q SLOPE (%)	SPACING INTERVAL (FEET)		
1.0	110		
	· · · -		
2.0	55		
3.0	<i>35</i>		
4.0	25		
5.0	20		

NOTE: Use this spacing for all except Rock Ditch Checks.

3	8/10/16	Revised Standard	RAA	SHS
2	6/28/16	Revised Standard	RAA	SHS
1	6/01/13	Revised Standard	MRM	SHS
NO.	DATE	REVISIONS	BY	APP'D

TEMPORARY EROSION AND POLLUTION CONTROL

DITCH CHECKS


LA852E

FHWA APPROVAL 9/14/2016 APP'D Scott H. Shields

DESIGNED SHS DETAILED RAA QUANTITIES CADD RAA


DESIGN CK. SHS DETAIL CK. SHS QUAN.CK. CADD CK. SHS


CADconform Certify This File

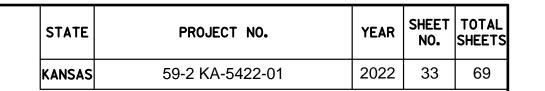

ROCK DITCH CHECK NOTES

- I. Rock shall be clean aggregate, D50-6" and aggregate filler.
- 2. Place rock in such manner that water will flow over, not around ditch check.
- 3. Do not use rock ditch checks in clear zone.
- 4. Excavation: The ditch area shall be reshaped to fill any eroded areas. Prior to placement of the rock, the ditch shall be excavated to the dimensions of the Rock Ditch Check and to a minimum depth of 6" (150mm). After placement of the rock, backfill and compact any over-excavated soil to ditch grade. This work shall be subsidiary to the bid item Temporary Ditch Check (Rock).
- 5. Aggregate excavated on site may be used as an alternate to the 6" rock, if approved by the Engineer.
- 6. The Engineer may approve the use of larger aggregates for the downstream portion of the check when conditions warrant their use.
- 7. When the use of larger rock is approved, D50-6" rock will be placed between the larger aggregate and the aggregate filler.
- 8. Aggregate filler will be placed on the upstream face of the ditch check. Aggregate filler will comply with Filter Course Type I, Division 1114.

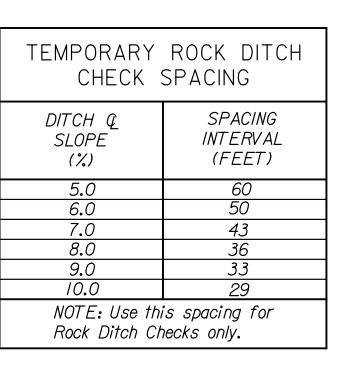

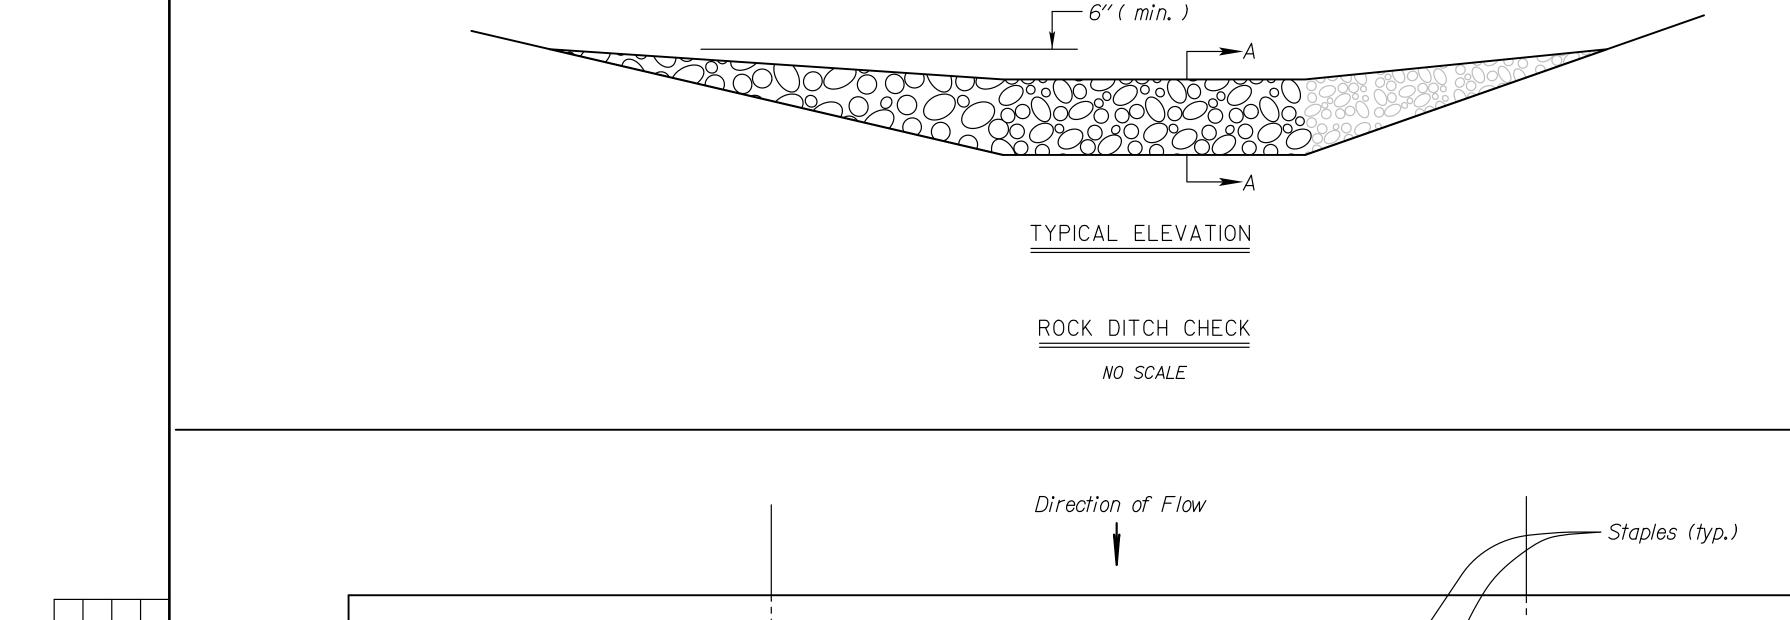

4′ (max.)

PLAN

TYPICAL ELEVATION

- Stakes (typ.)

10'

·Ground Level

Downstream Apron


(Optional)


Aggregate Filler

Direction of Flow

Location:

Std. Base File: la852g.dgn
Plotted: KDOT*CADD.Support@ks.g8Met L
File: la852g.dgn
Plot Date: 24-NOV-2020 01:01

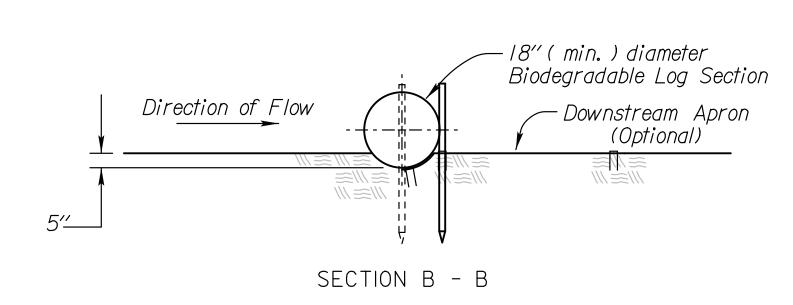

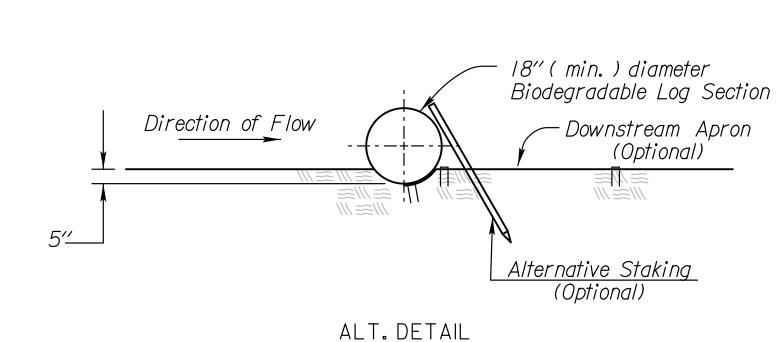

OPTIONAL

BIODEGRADABLE LOG DITCH CHECK

4′(max.)

OR Filter Sock Ditch Check
NO SCALE


BIODEGRADABLE LOG DITCH CHECK NOTES


- I. Use as many biodegradable log sections as necessary to ensure water does not flow around end of ditch check.
- 2. Overlap sections a minimum of 18".
- 3. Stakes shall be wood or steel according to Section 2114 of the Standard Specifications. Length of stakes shall be a minimum of 2 x the diameter of the log.
- 4. Use Erosion Control (Class I) (Type C) as the downstream apron when required.
- 5. A downstream apron is required when directed by the Engineer. Apron material will be paid at the contract unit price.
- 6. Each log or sock (except compost filter socks) should be keyed into the ground at a minimum of 25% of its height. Compost filter socks should be placed on smooth prepared ground with no gaps between the sock and soil.

3	11/19/20	Revised	Standard		MRD	ML	
2	8/10/16	Revised	Standard		RAA	SHS	
	10/21/15	Revised	Standard		RAA	SHS	
NO.	DATE		REVISIONS		BY	APP'D	
	KANS	AS DEPAR	TMENT OF TRANS	PORTA?	rion		
	TEMPORARY EROSION AND						
	POLLUTION CONTROL						
	ROCK DITCH CHECKS						
	BIODEGRADABLE LOG DITCH CHECKS						

LA852G

THWA APPROVAL II/19/2020 APP'D Mervin La
DESIGNED ML DETAILED DK QUANTITIES CADD
DESIGN CK. ML DETAIL CK. ML QUAN.CK. CADD CK.

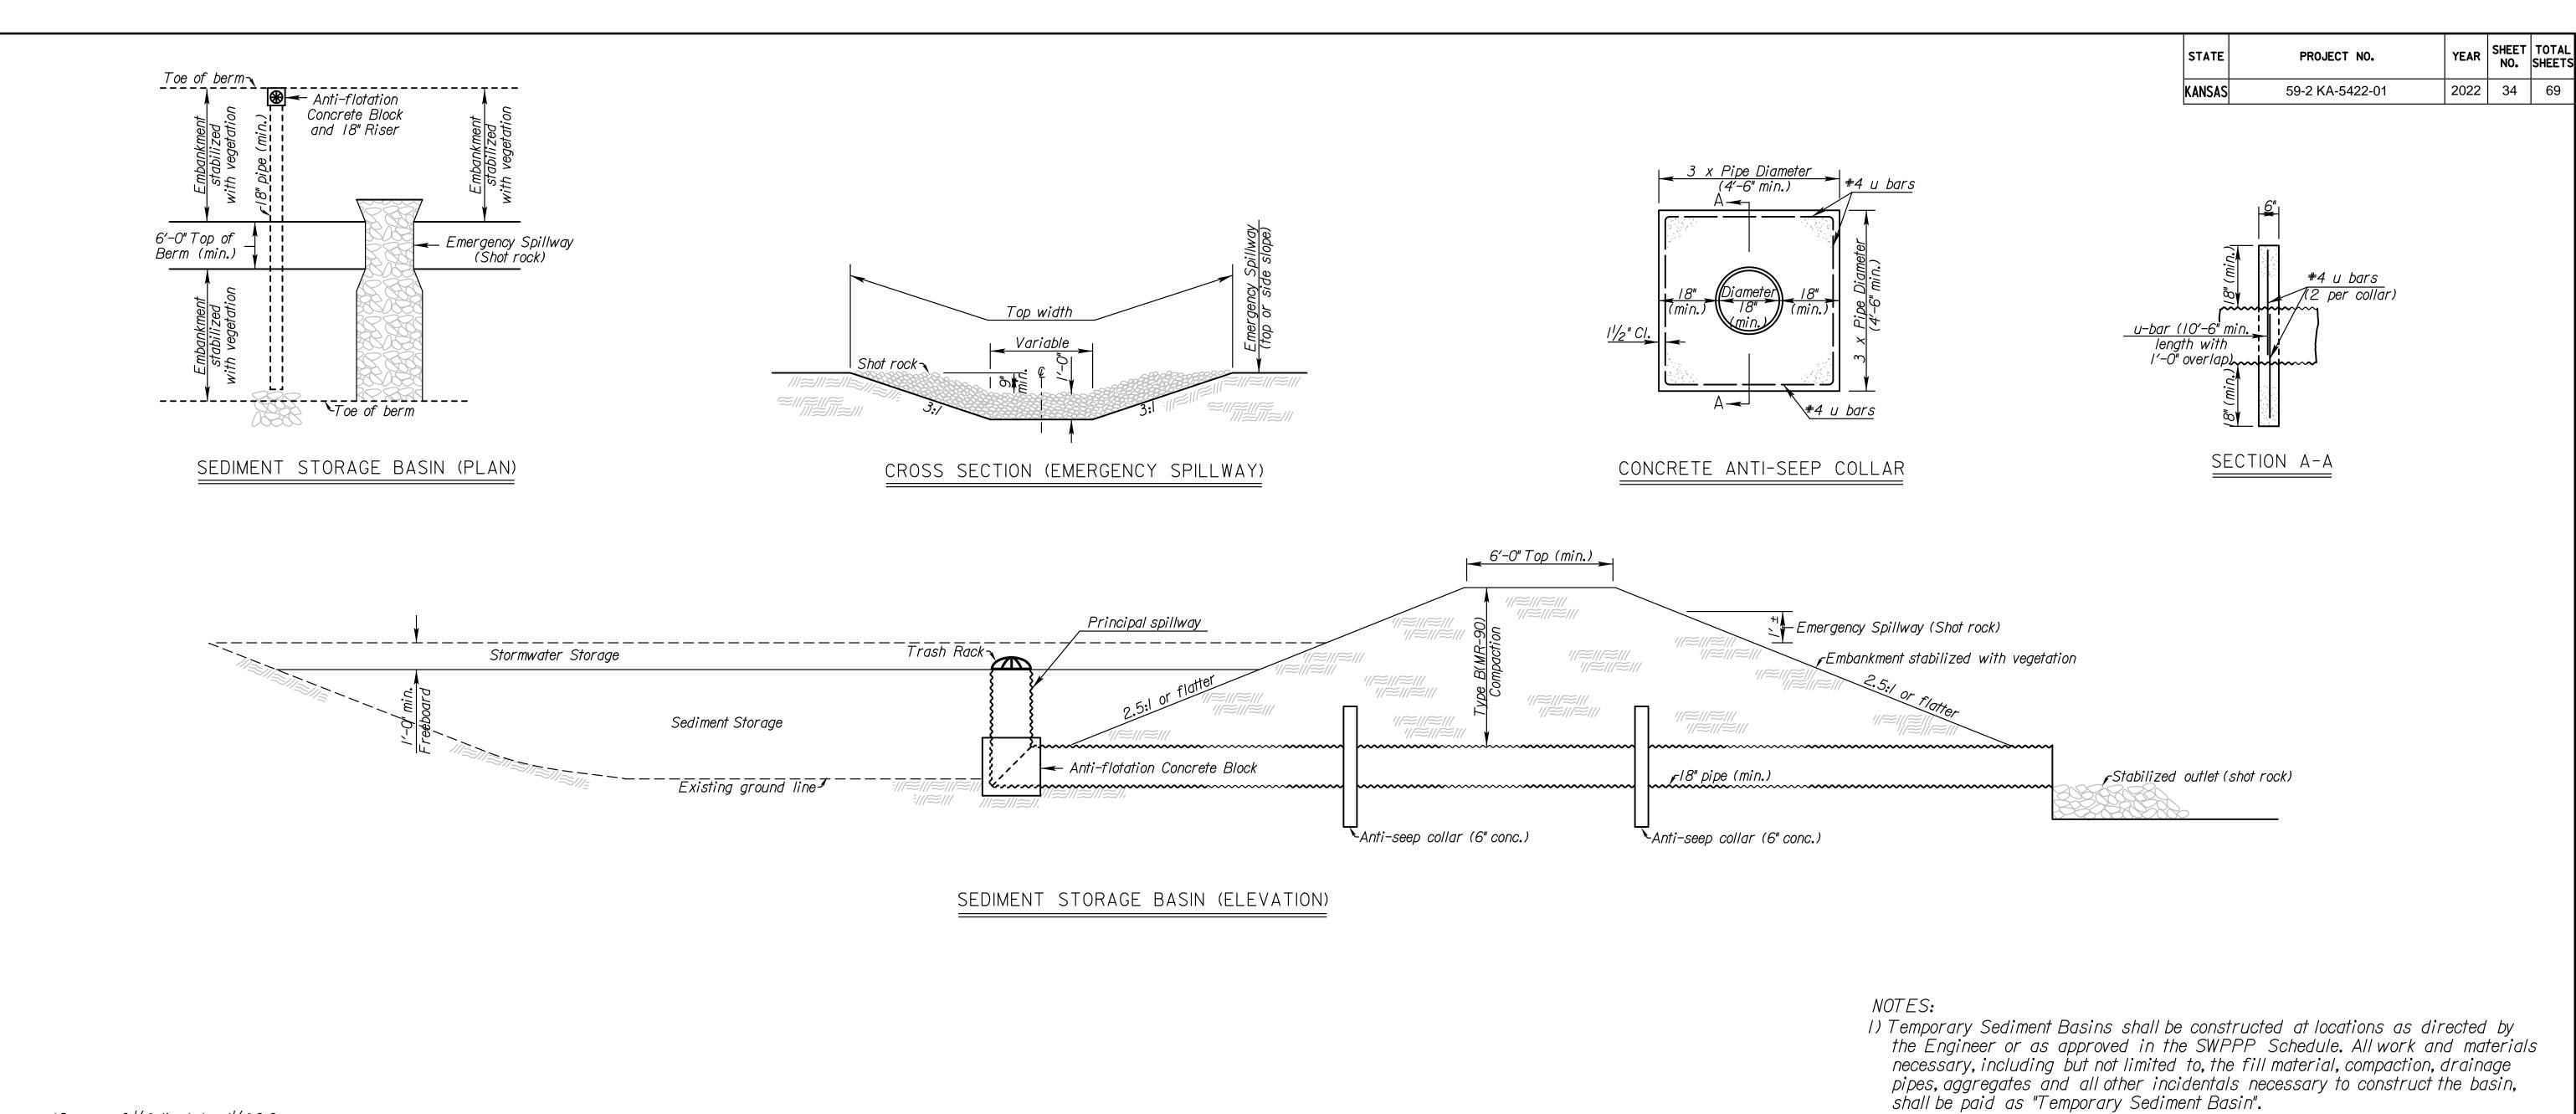

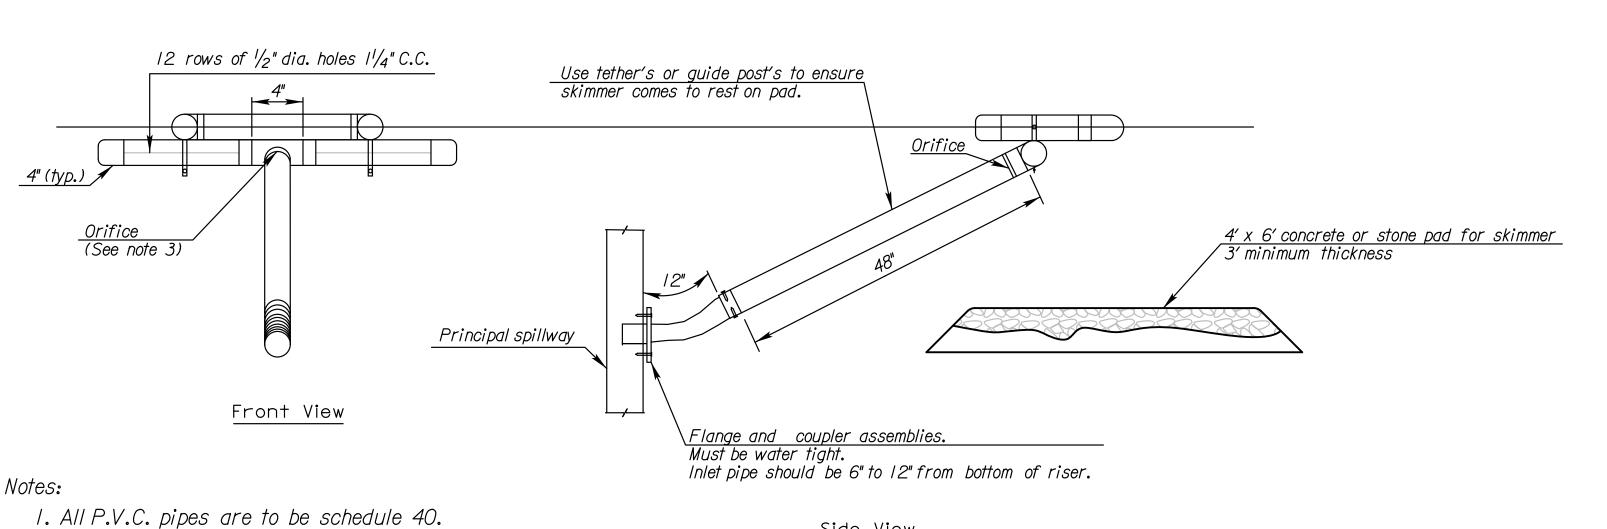

2. HDPE flexible drain pipes is to be attached to the pond outlet structure with water-tight connections.

time to 2 to 5 days and approved by the engineer.

3. The orifice shall be sized of to provide drawdown

4. Other skimmer designs maybe used that dewaters

The design must be approved by the engineer.

from the surface at a controlled rate.

Side View

SKIMMER DEWATERING DEVICE

	SEDIMENT	STOR	AGE BASIN LOCATIONS
STATION TO	STATION	SIDE	REQUIRED STORAGE CAPACITY

3				
2	9/3/13	Added Skimmer Dewatering Device	MRM	SHS
1	7/17/13	Revised Standard	MRM	SHS
NO.	DATE	REVISIONS	BY	APP'D
	MILLY	TEMPORARY EROSION AND POLLUTION CONTROL		
		SEDIMENT STORAGE BASIN		


KDOT Graphics Certified 07-28-2021


2) Lengths and top dimensions shall be determined in the field by the Engineer.

3) Skimmer dewatering device required and must be used reguardless the size

of the drainage area.

Sheet No.

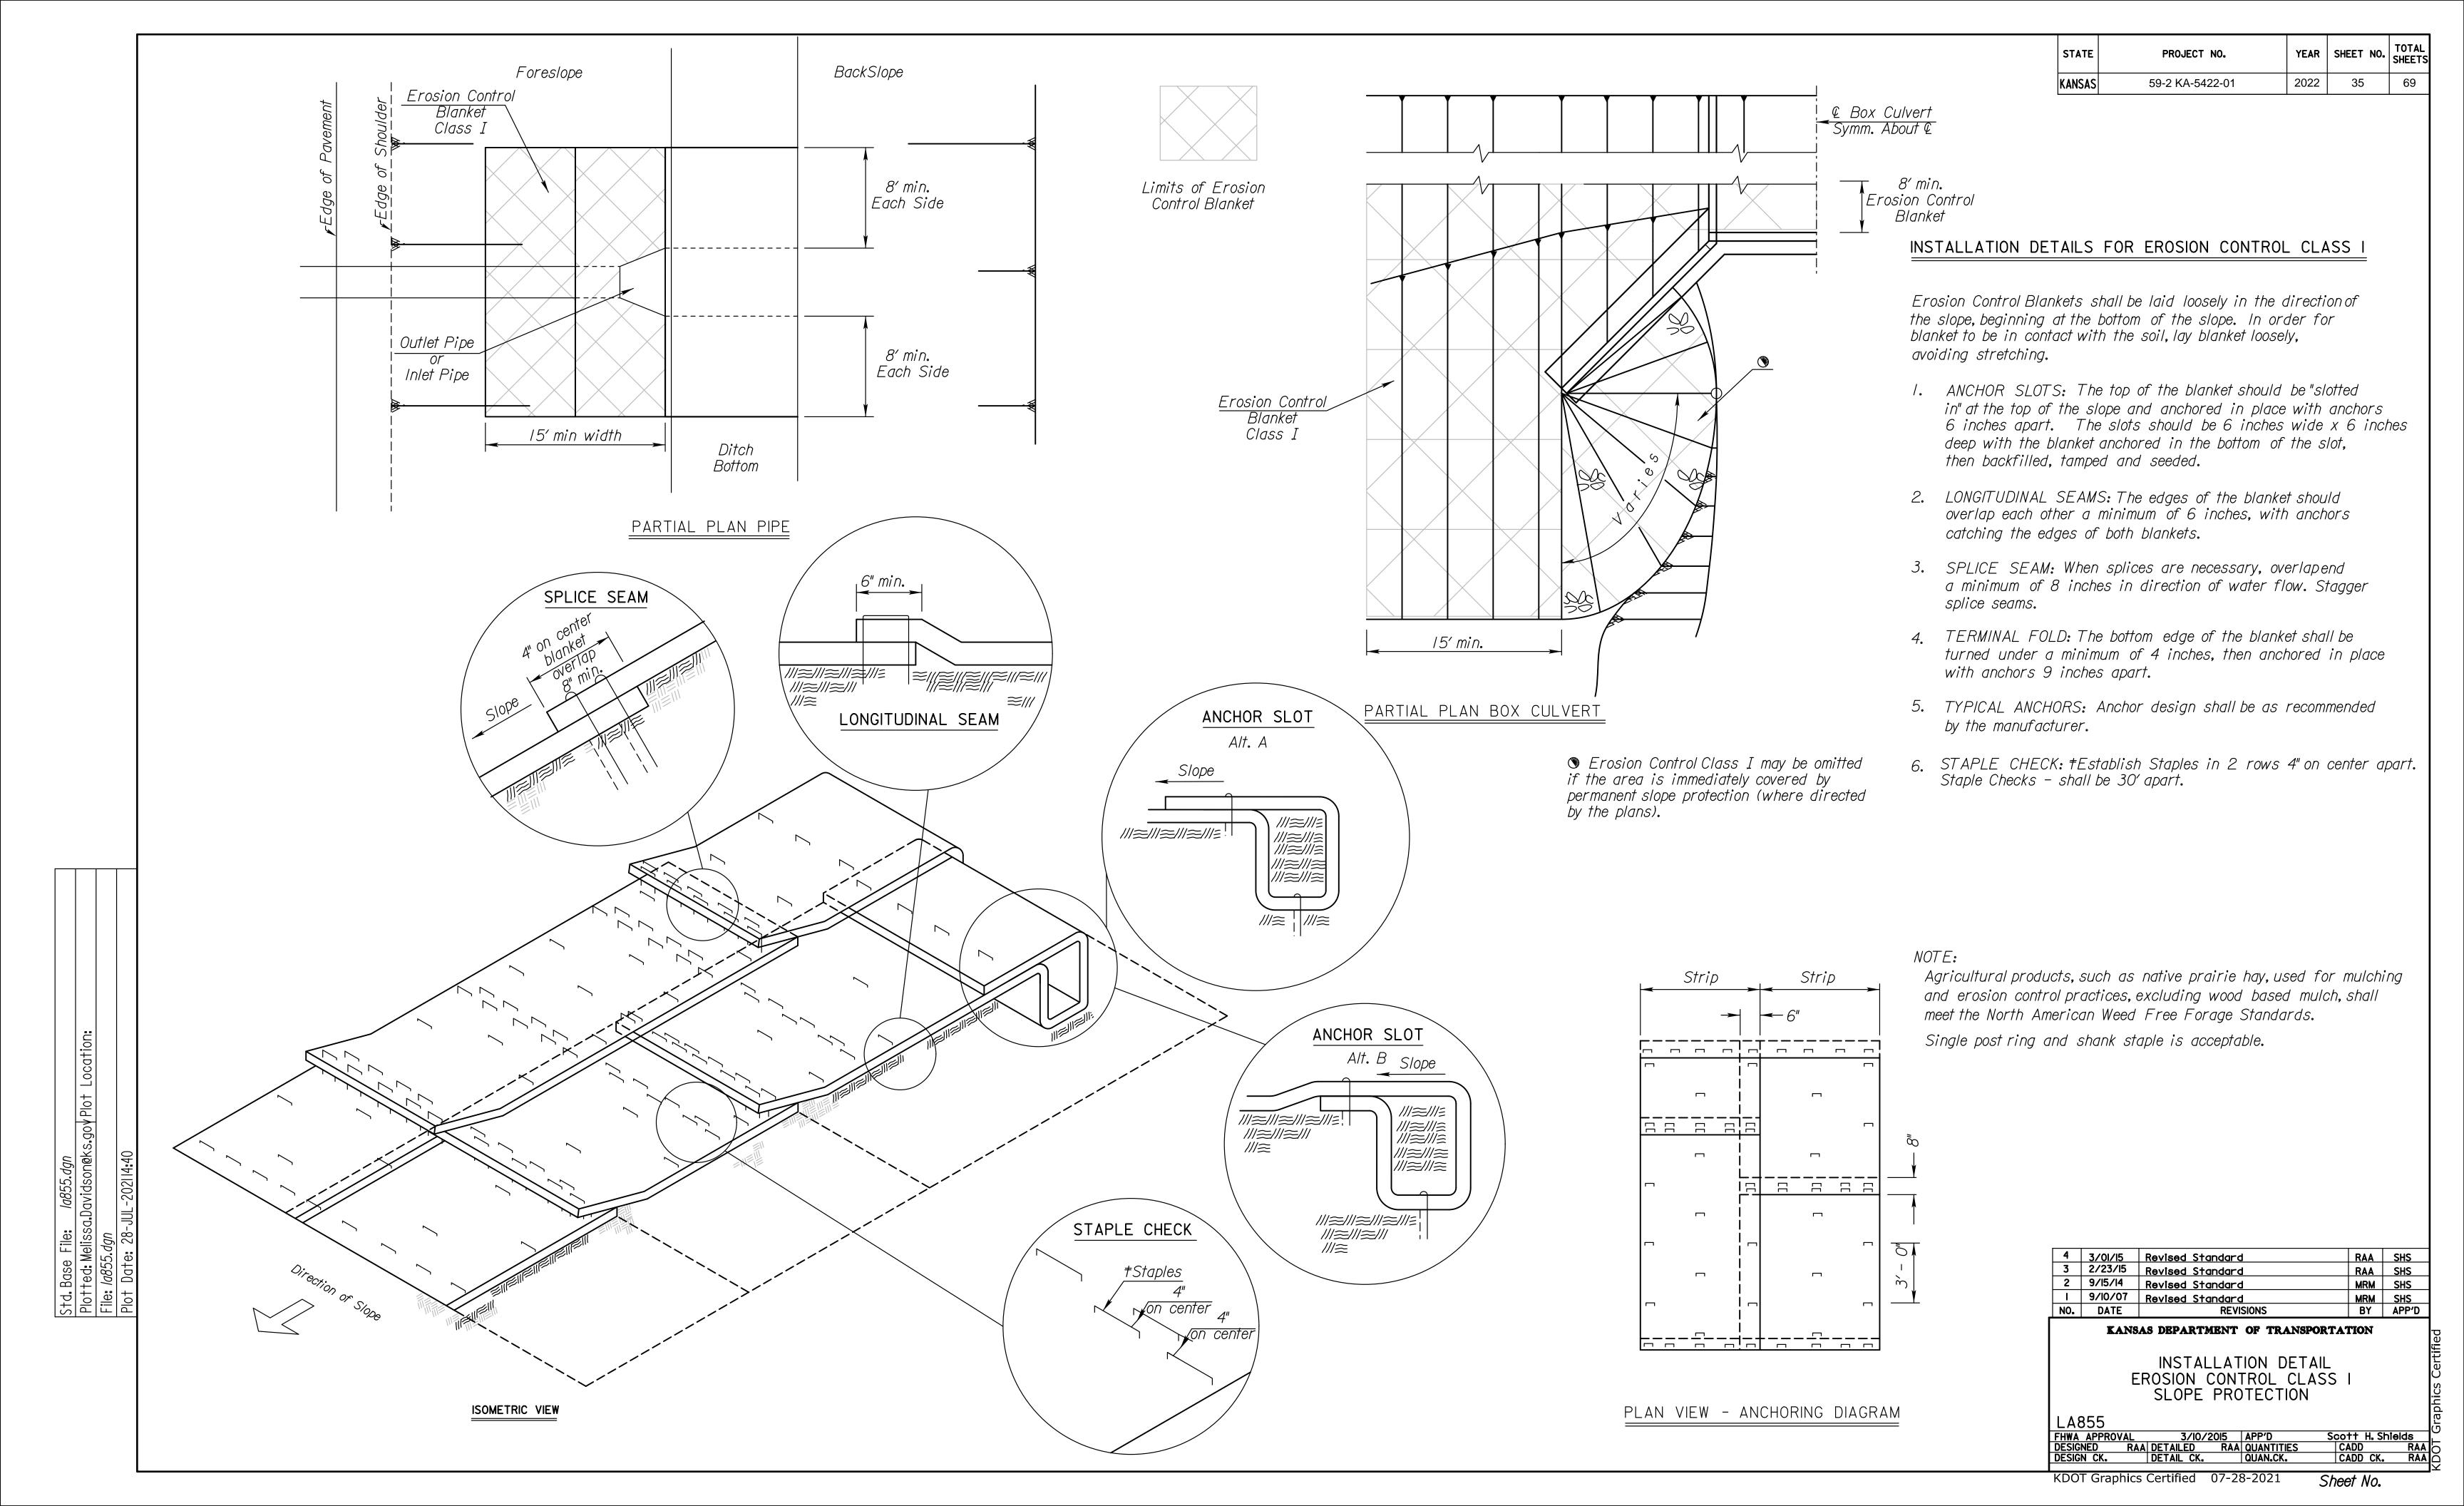

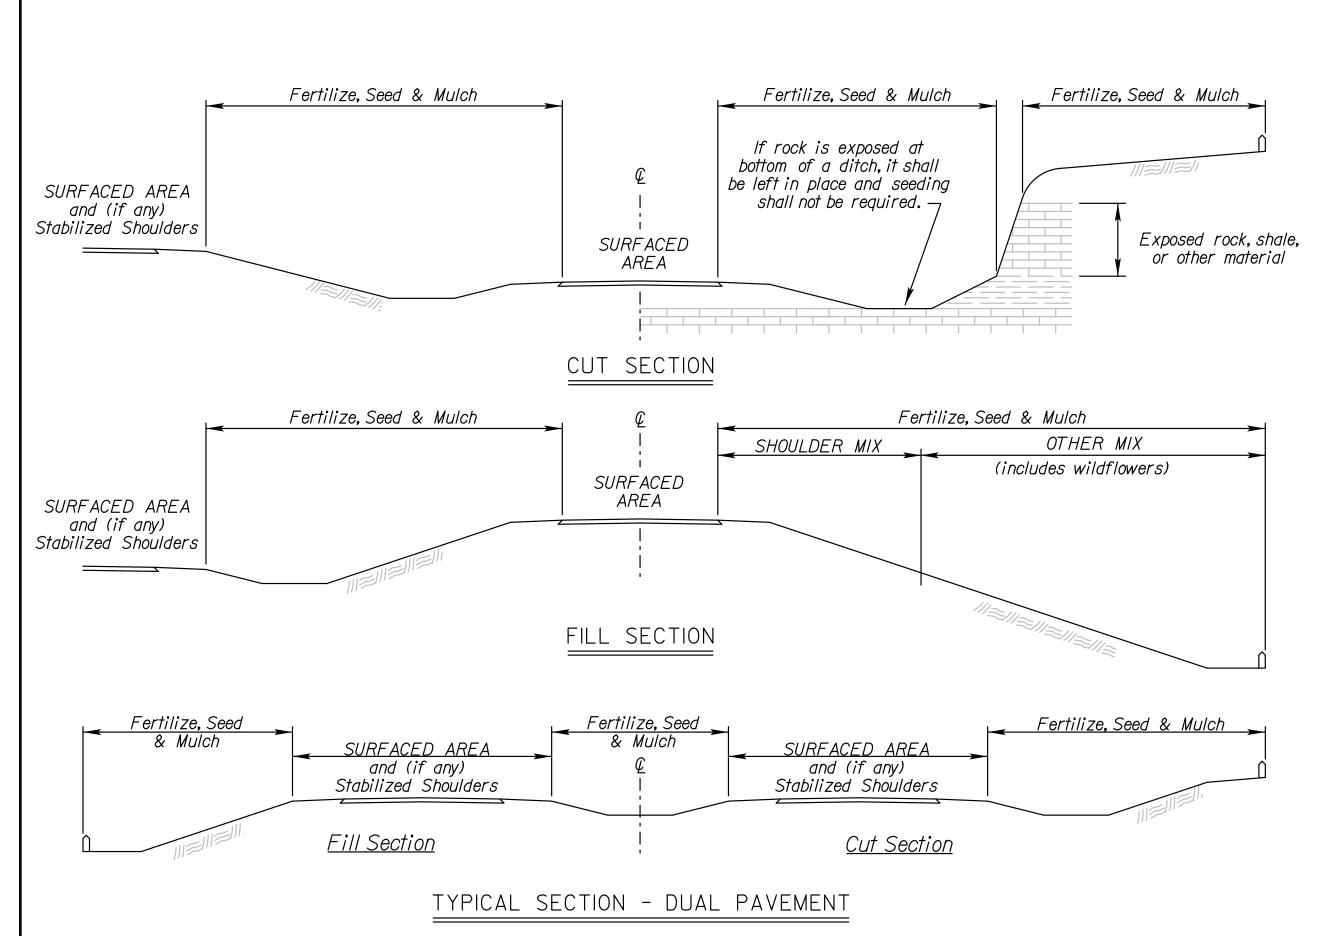

COOL SEASON GRASSES	WARM SEASON GRASSES & WILDFLOWER
February 15 thru April 20	November 15 thru June I
August 15 thru September 30	
SPECIES	SPECIES
Bluegrasses	Bermuda Grass
Brome Grasses	Big Bluestem
Canada Wildrye	Blue Grama
Fescues	Buffalo Grass
Prairie Junegrass	Indiangrass
Ryegrasses	Little Bluestem
Sterile Wheatgrass	Sand Bluestem
Tall Dropseed	Sand Dropseed
Western Wheatgrass	Sand Lovegrass
	Side Oats Grama
	Switchgrass
	Wildflower Mixes

GRASS & WILDFLOWER SEEDING SEASONS

When the area to be seeded is less than lacre, seed the area any time of the year.

Season.

SEASONS
WARM SEASON GRASSES
May 15 thru September I
SPECIES
Buffalo Grass Sod

If the soilis workable, the Engineer may allow placement of sod between November 15 and March I. If sod is placed during this time, maintain the sod until 20 days after the beginning of the spring sodding season.

STATI	PROJECT NO.	YEAR	SHEET NO.	TOTAL SHEETS
KANSA	59-2 KA-5422-01	2022	36	69

GENERAL NOTES

The entire disturbed area, excepting the paved or surfaced areas, steep rocky slopes and areas of undisturbed native sod or other desirable vegetation shall be fertilized (limed when required), seeded and mulched. Soil preparation shall conform to the Standard Specifications except as noted below.

All borrow areas shown on the plans are to be fertilized, seeded, and mulched. However, operation in borrow areas where crops are growing may be omitted when requested by the owner.

If temporary cover has provided stable slopes with no erosion, seed the permanent grasses into the existing cover.
If there has been erosion that requires repair prior to seeding, then it may be necessary to regrade the area,
resulting in bare ground.

FERTILIZER: A ratio and application rate that equals or exceeds the required minimum rate per acre of N, P₂ O₅, K₂O listed in Summary of Seeding Quantities will be acceptable.

MULCHING: Mulch shall be spread uniformly over all disturbed areas and punched in the soil, unless otherwise noted on the plans. The rate of application per acre, thickness in place, for the mulching material is generally as follows:

 $1\frac{3}{4}$ - $2\frac{1}{4}$ Tons per Acre = $1\frac{1}{2}$ " loose depth spread uniformly over acre.

Agricultural products, such as native prairie hay, used for mulching and erosion control practices, excluding wood based mulch, shall meet the North American Weed Free Forage Standards.

Other vegetative mulches are acceptable only with the Engineer's concurrence.

The above rate is a guide. It will be at the discretion of the Engineer to determine what rate is sufficient for adequate protection of newly seeded areas.

NATIVE	WILDFLOWER M	IX I
PLS RATE	NAME	QTY (Ib)
0.3	Butterfly Milkweed	
0.3	Common Milkweed	
0.3	Black Eyed Susan	
0.5	Blanket Flower	
0.5	False Sunflower	
0.5	Lance-Leaf Coreopsis	
0.2	Maximilian Sunflower	
0.1	New England Aster	
0.2	Pinnate Prairie Coneflower	
0.2	Plains Coreopsis	
0.3	Purple Coneflower	
0.3	Upright Prairie Coneflower	
0.3	Dames Rocket	
0.3	Lemon Mint	
0.2	Pitcher Sage	
0.2	Wild Bergamot	
1.0	Illinois Bundleflower	
0.2	Common Evening Primrose	
0.1	Hoary Verbena	
0.8	Purple Prairie Clover	
0.3	Roundhead Lespedeza	
3.0	Showy Partridge Pea	
0.2	White Prairie Clover	
10.3	Total (lb)	

NATIVE	WILDFLOWER M	IX 2
PLS RATE	NAME	QTY (Ib)
0.3	Butterfly Milkweed	
0.3	Black Eyed Susan	
0.5	Black Sampson Coneflower	
1.0	Blanket Flower	
0.2	Maximilian Sunflower	
0.2	Plains Coreopsis	
0.2	Upright Prairie Coneflower	
0.2	Western Yarrow	
0.3	Lemon Mint	
0.4	Pitcher Sage	
I . 5	Illinois Bundleflower	
0.2	Common Evening Primrose	
I . O	Blue Wild Indigo	
0.4	Leadplan†	
0.4	Purple Prairie Clover	
0.3	White Prairie Clover	
7.4	Total (lb)	

Package and deliver the wildflower seed separately from the grass seed mix. Package and deliver the Tall Drop Seed separately from the grass seed and the wildflower mix. Place the grass seed (except Tall Drop Seed) in the large seed box and drill (cover) seed $\frac{1}{8}$ " - $\frac{1}{4}$ ". Place the wildflower seed in a separate seed box and drill (cover) seed $\frac{1}{16}$ " maximum. Place the Tall Drop Seed in a separate (third) seed box and place the seed (using the seed drill) on the soil surface.

OPTION: Broadcast Tall Drop Seed on the soil surface.

				SU	MMAR	Y OF	SEEDING QUANTITIES				
	RATE.	S. /ACRE			RES		BID ITEM	QUANTITY			
SHLDR	1		SHLDR	OTHER					UNIT		
	100			0.8			Fertilizer (15 30 15)		Lbs.		
	180			0.8			Seed (Turf-type Tall Fescue Seed Blend)		Lbs.		
							Seeding	Lump Sum	L.S.		
			 				Mulching *				

SHLDR = Seeded with the Shoulder Mix. Typically 15 feet for 2-lane roads and 30 feet for 4-lane roads. Includes outside roadsides, turfed portions of shoulders, and turfed portion of the median.

OTHER = Seeded with the "Other" Mix. Designated as all other turf areas, except the Shoulder. Usually includes a Native Wildflower Mix.

NOTE: Projects less than I acre shall be bid as "Seeding" by the lump sum. All disturbed areas shall be seeded, fertilized and mulched at the listed rate per acre. The acres are estimated.

Refer to the Standard Specifications, Division 900, Section 904 'Seeding', and Section 907 'Sodding', for the seeding and sodding seasons.

* See LA852A for mulching quantity. The quantity of mulch is estimated (Acres of Seeding X 1.5 X 2 Tons/Acre). The total mulch required shall be determined in the field. The bid item for mulching shall be paid for according to the Standard Specifications.

NO.	DATE	REVISIONS	BY	APP'D
1	08/03/20	Revised Standard	MRD	SHS
2	11/25/20	Updated Seeding / Sodding Periods Charts	MRD	ML


PERMANENT SEEDING SUMMARY OF SEEDING QUANTITIES


LA850


FHWA APPROVAL 05/06/2019 APP'D Mervin Lare


DESIGNED MRD DETAILED MRD QUANTITIES CADD

DESIGN CK. DETAIL CK. QUAN.CK. CADD CK.

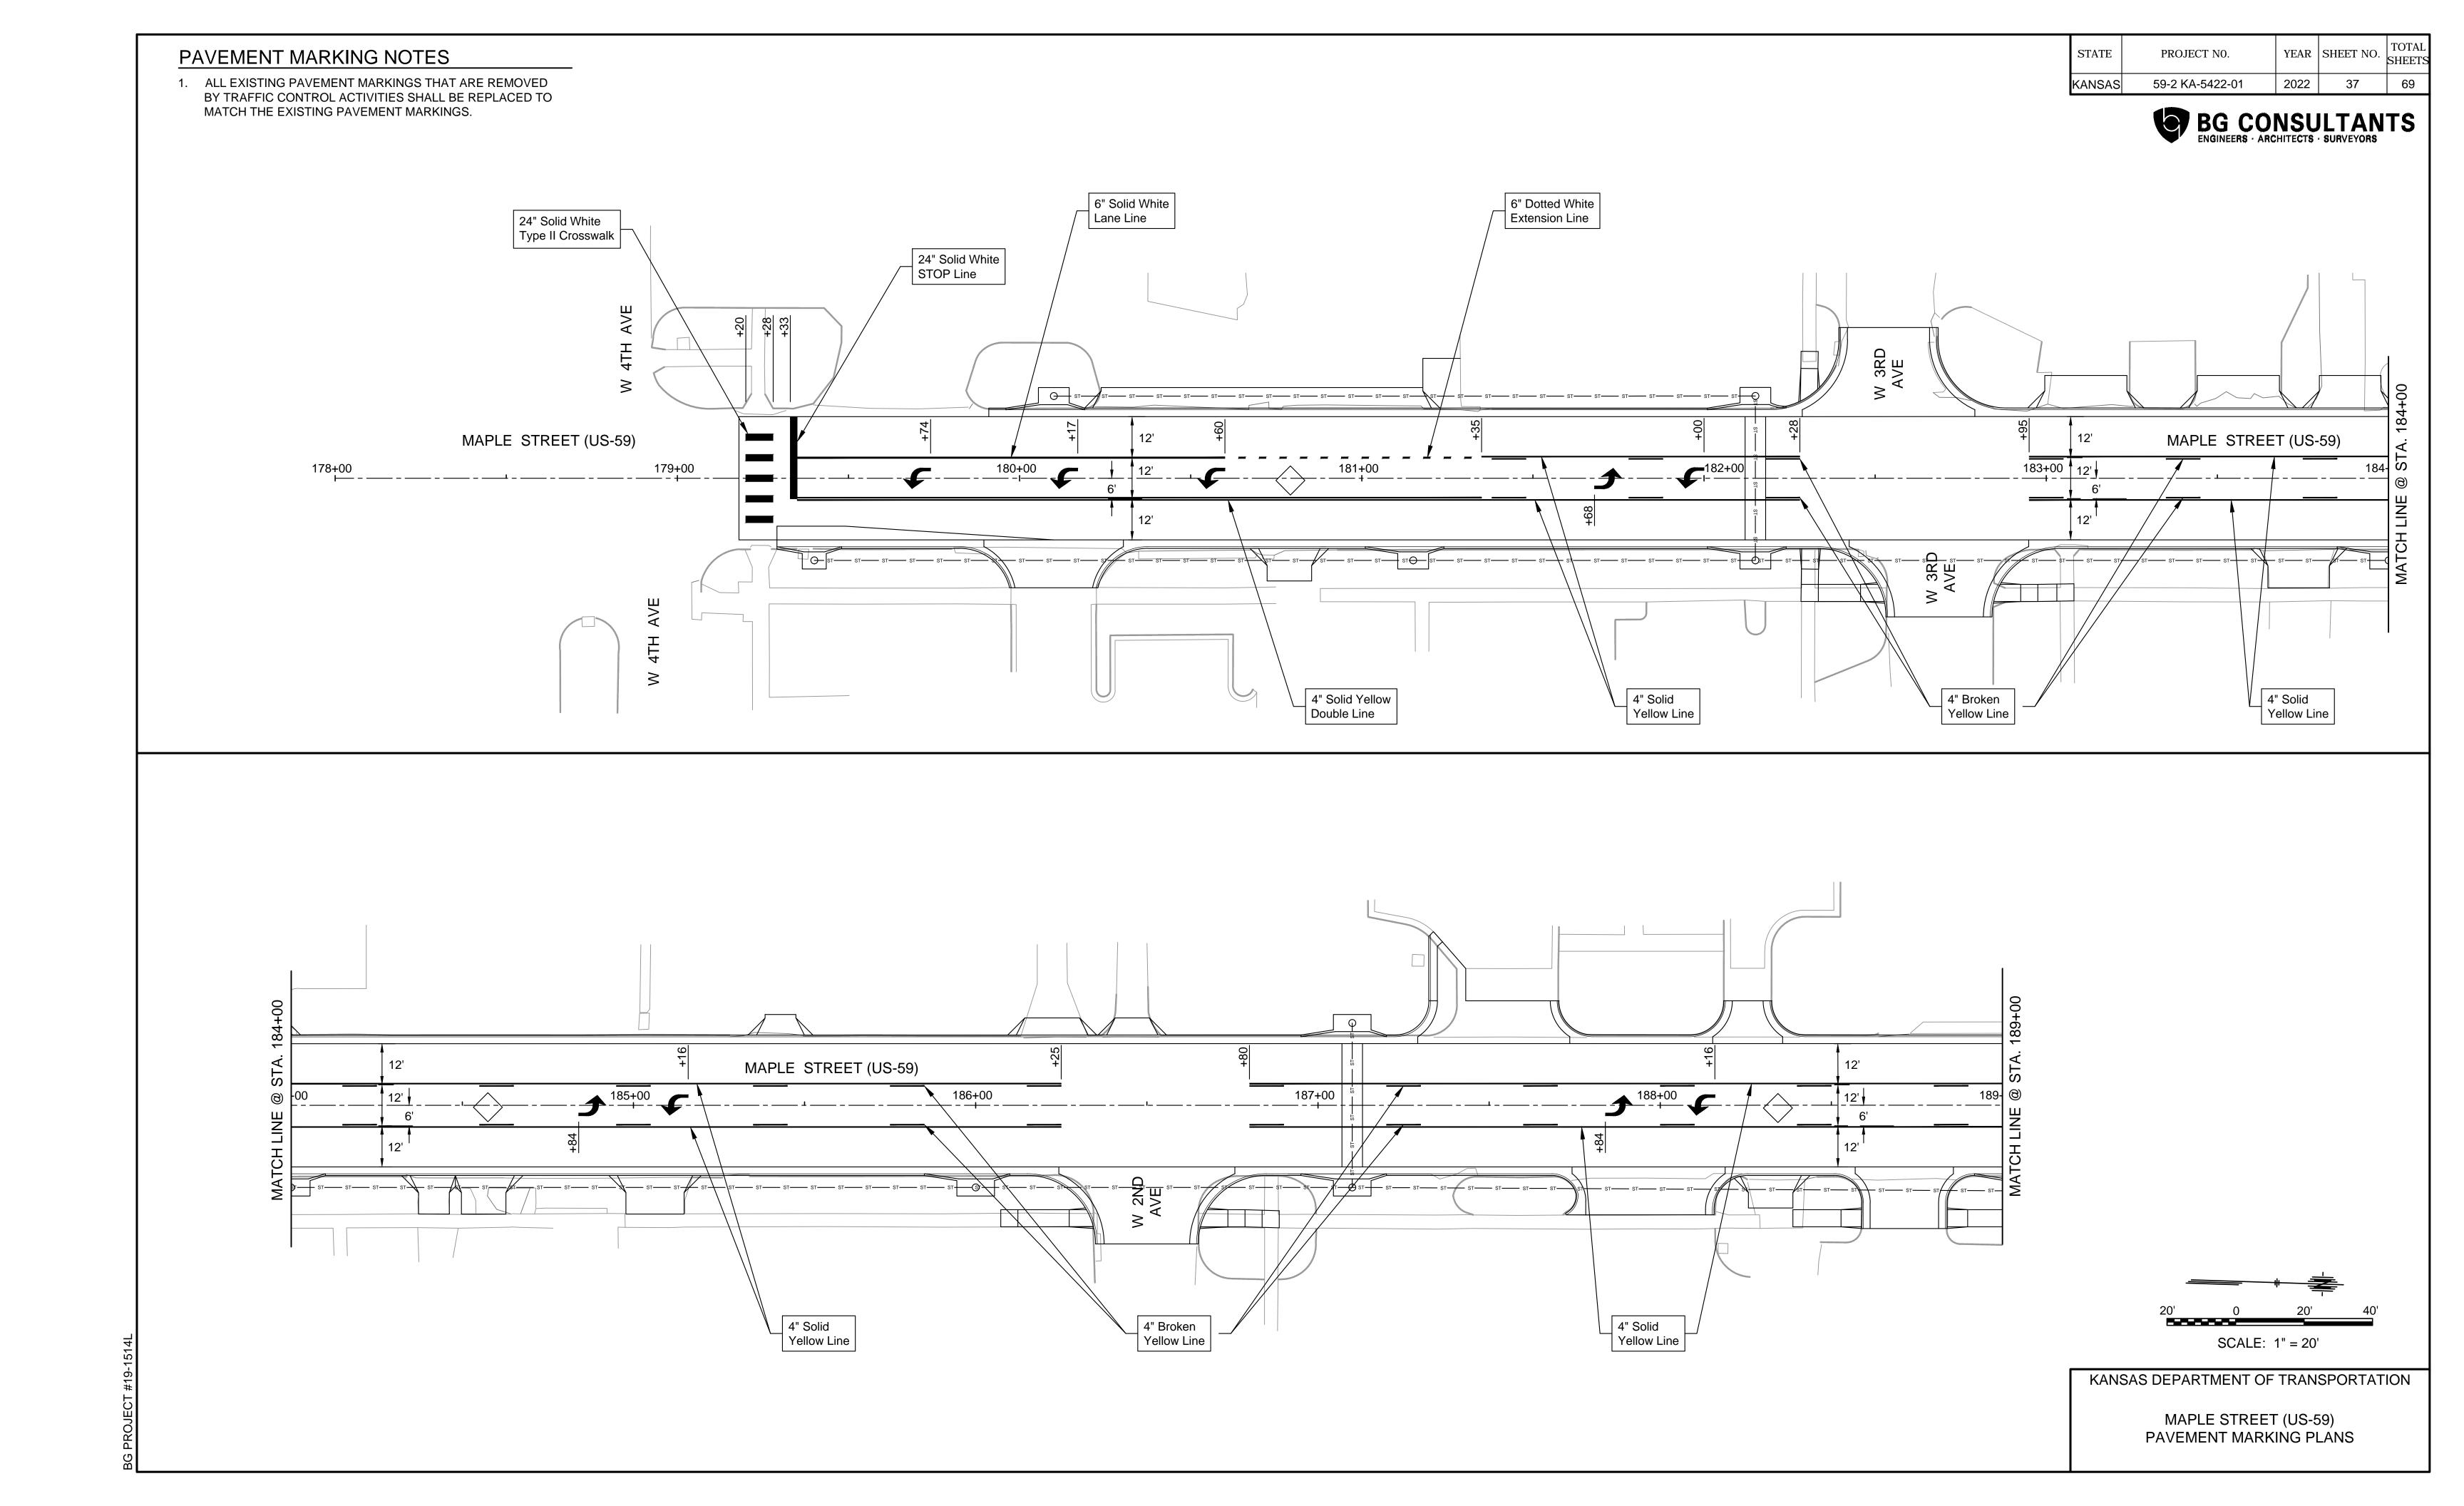

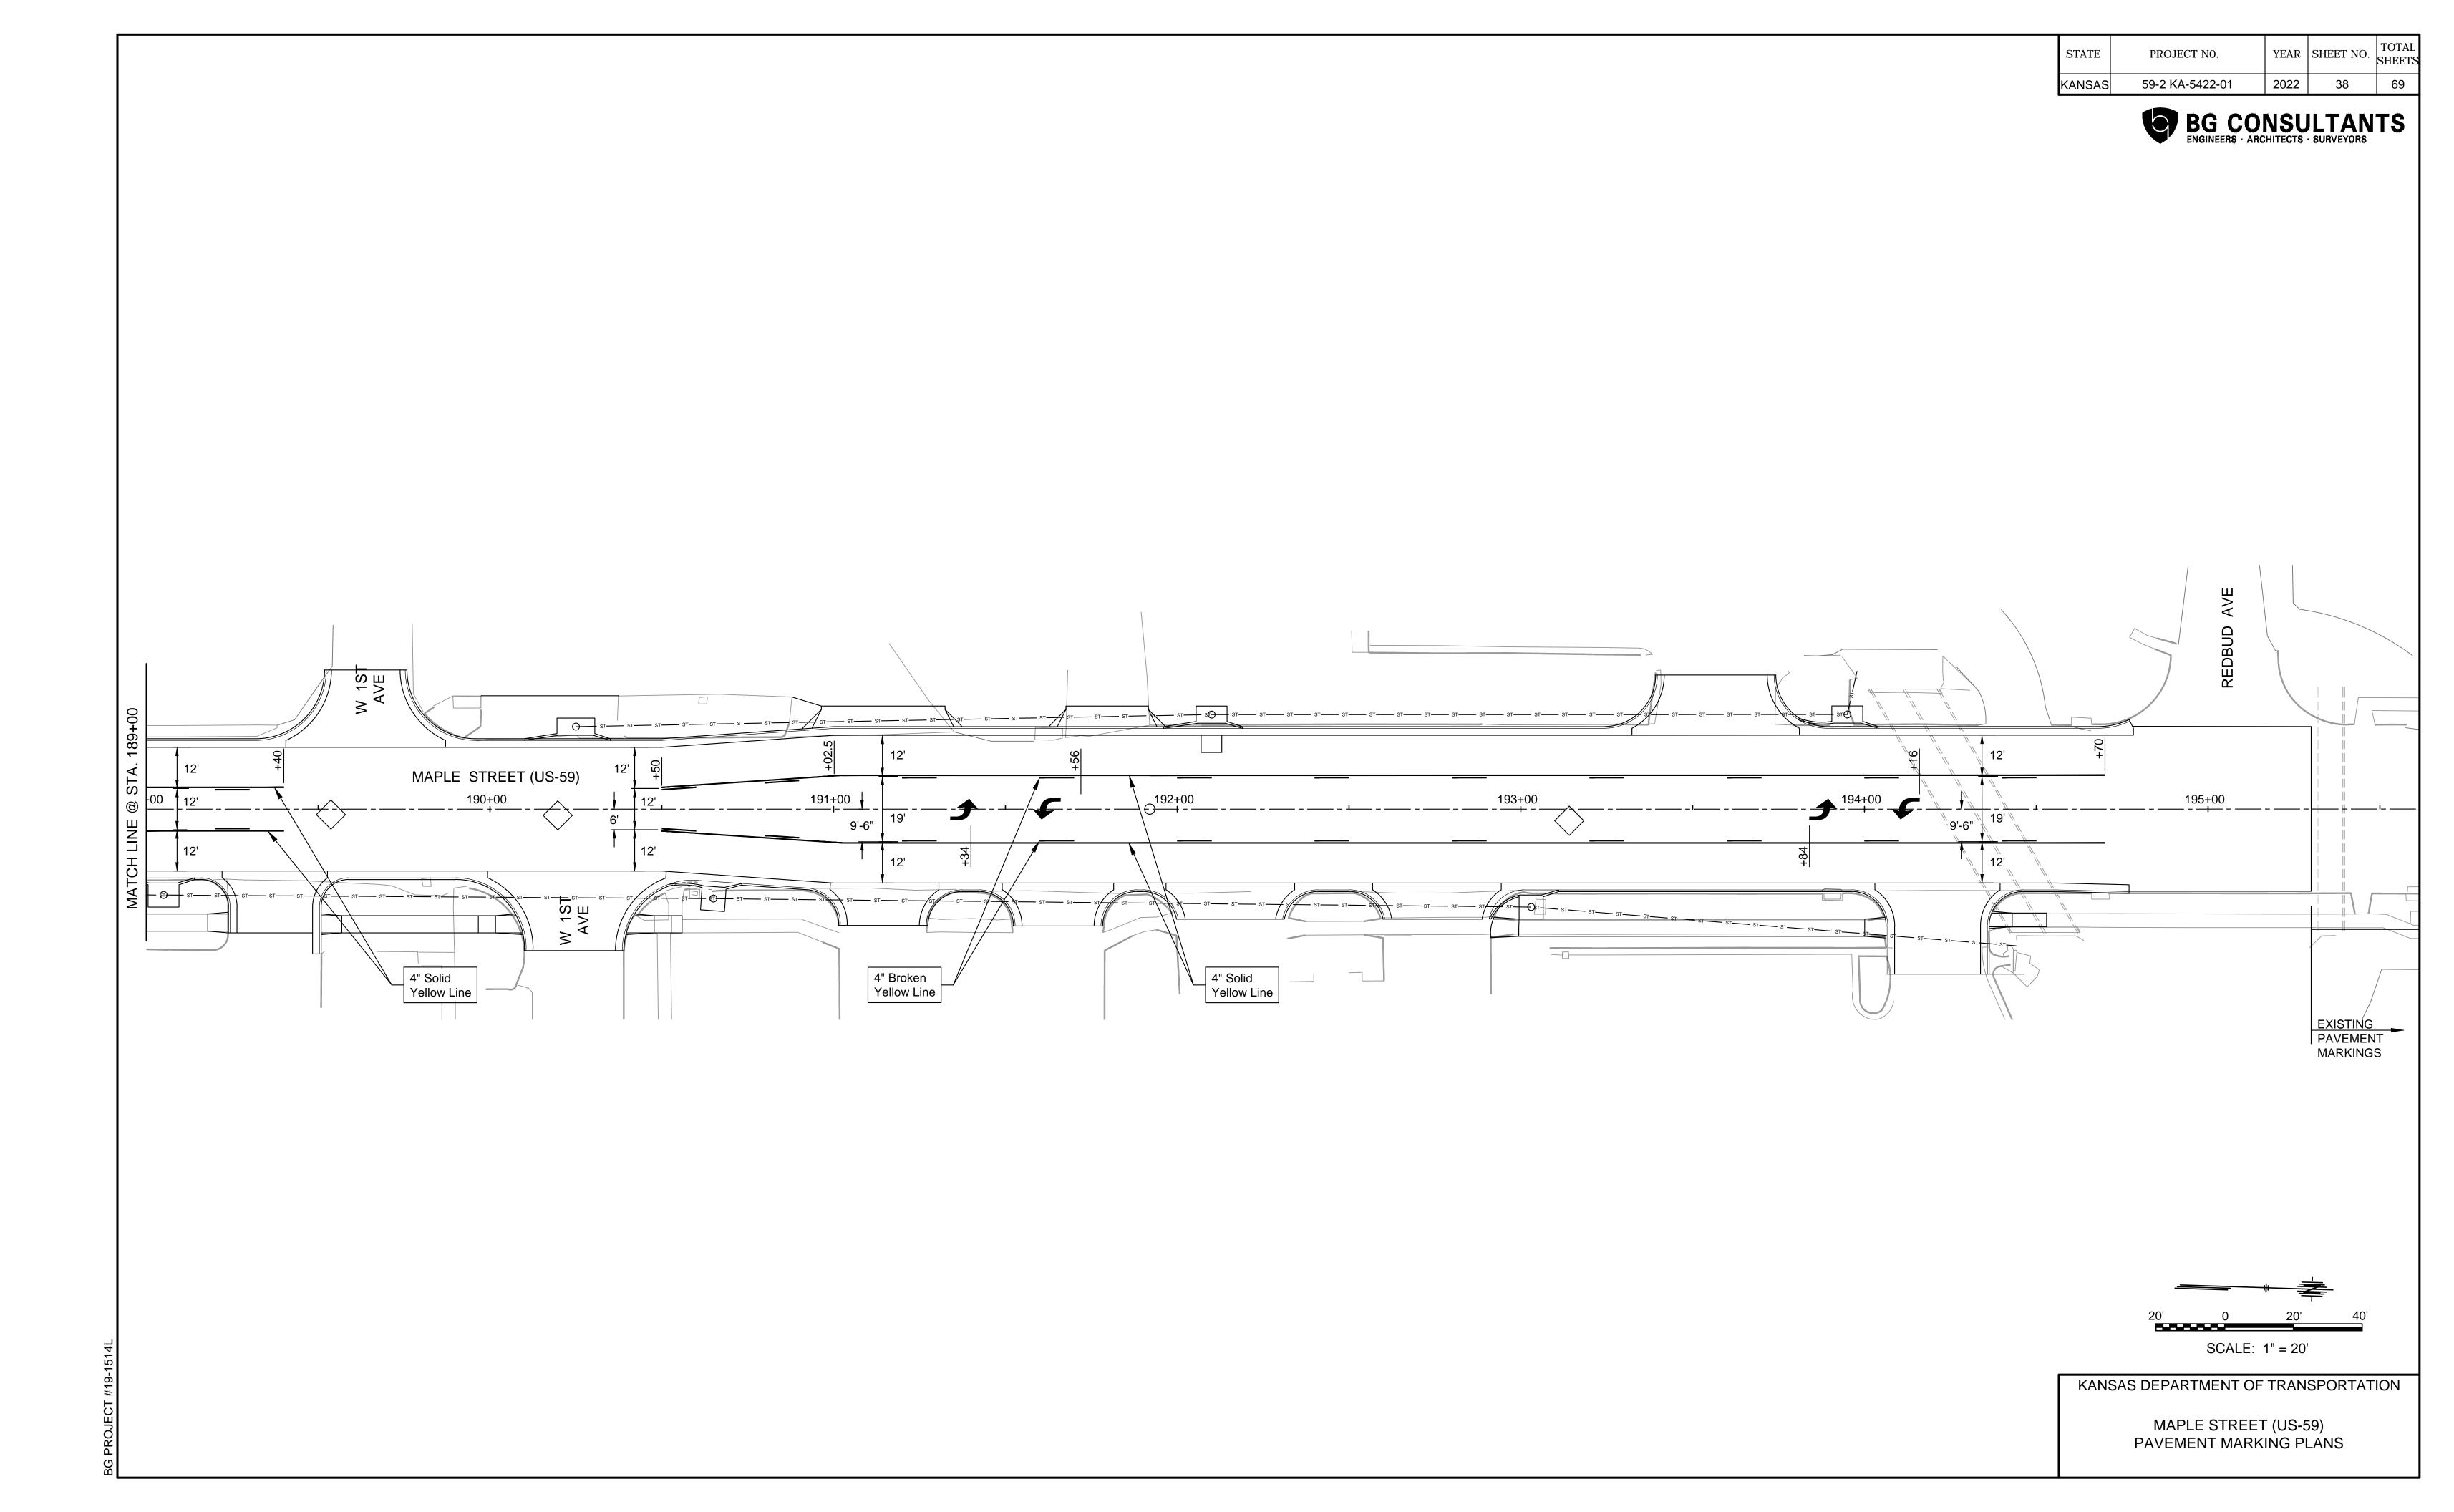

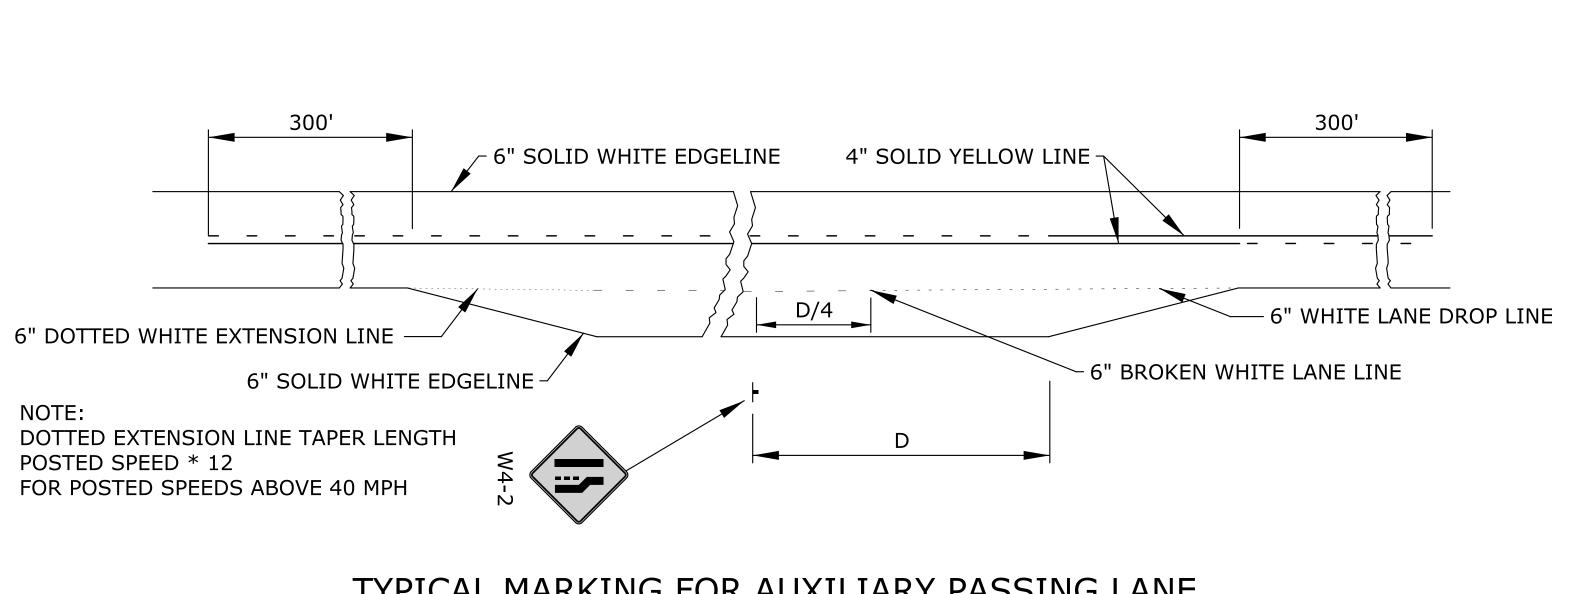


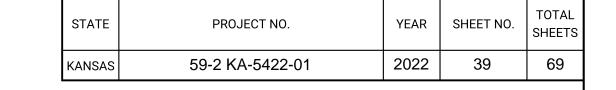


NOTE:

ALL PAVEMENT MARKINGS SHALL BE BROKEN AT CROSS ROADS.


FOR HIGHWAY JUNCTIONS THE NO PASSING ZONE WILL EXTEND 1000' FROM INTERSECTION.

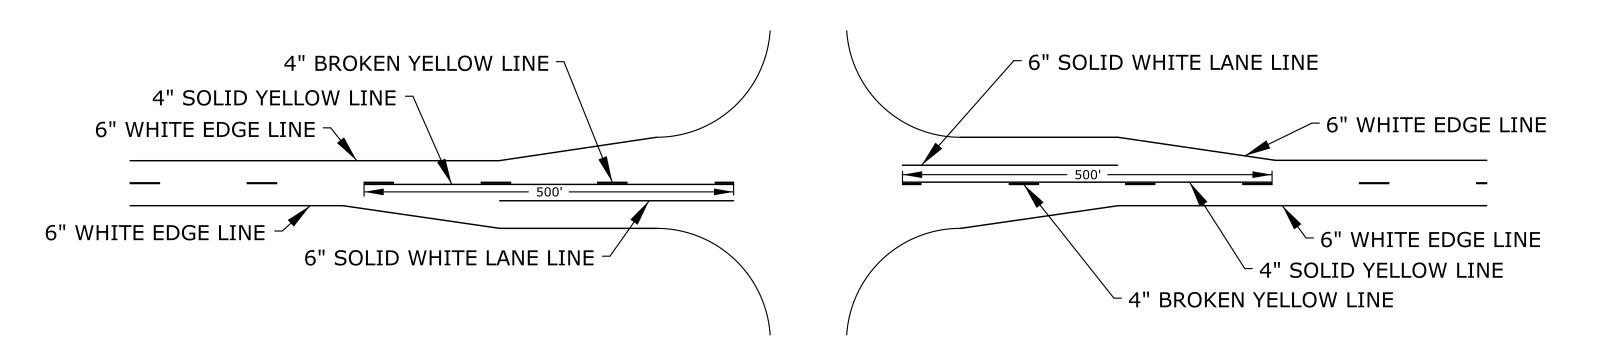


TYPICAL MARKING FOR AUXILIARY PASSING LANE

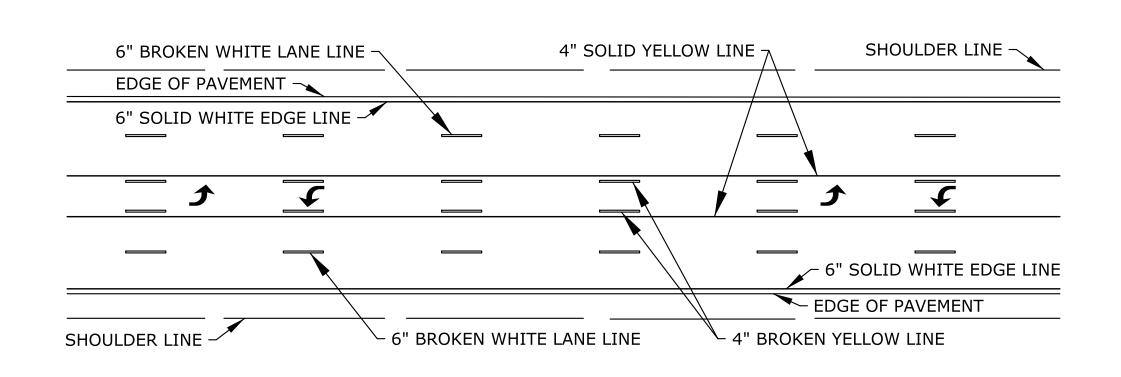

TWO-WAY LEFT TURN DETAIL FOR FIVE LANE ROADWAY

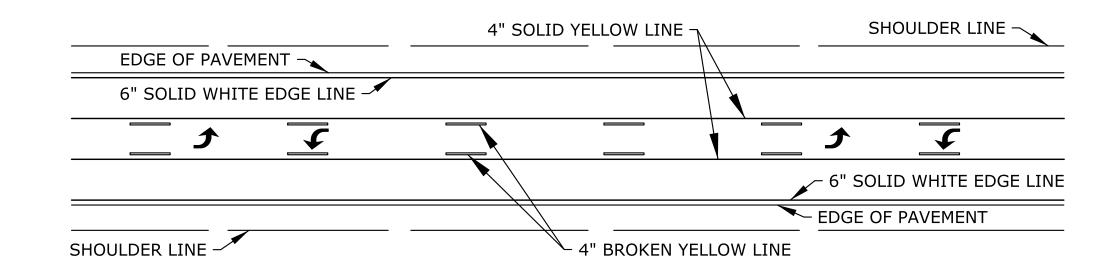


TWO-WAY LEFT TURN DETAIL FOR THREE LANE ROADWAY

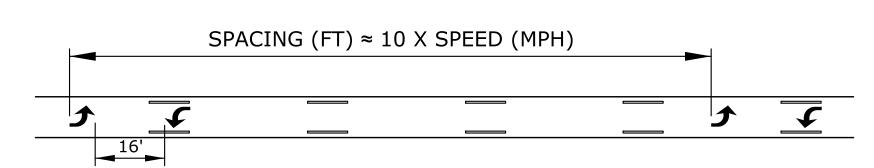


TWO-WAY LEFT TURN ARROW SPACING DETAIL


NOTE: IF ARROWS ARE USED SPACE THE ARROWS AS SHOWN IN THE SPACING DETAIL.

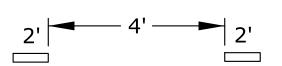


TYPICAL SPACING FOR DOTTED EXTENSION LINES, UNLESS OTHERWISE NOTED ON PLANS.

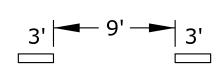

TYPICAL SPACING FOR LANE DROP. **UNLESS OTHERWISE** NOTED ON PLANS.

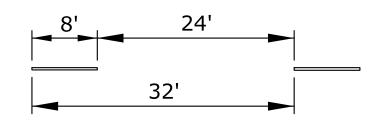


TYPICAL SPACING FOR BROKEN LINES UNLESS OTHERWISE NOTED ON PLANS

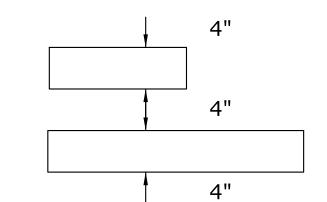


TYPICAL SPACING FOR NO PASSING LINES UNLESS OTHERWISE NOTED ON PLANS

TYPICAL ROAD JUNCTION MARKINGS WITH BYPASS LANES

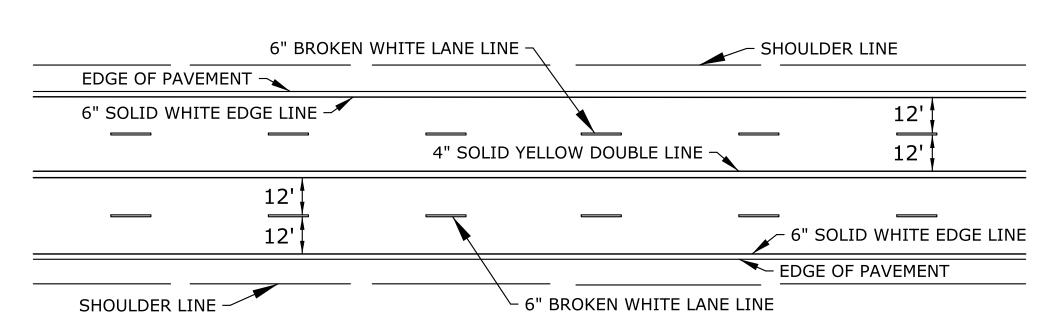

TYPICAL MARKINGS FOR FOUR LANE ROADWAY

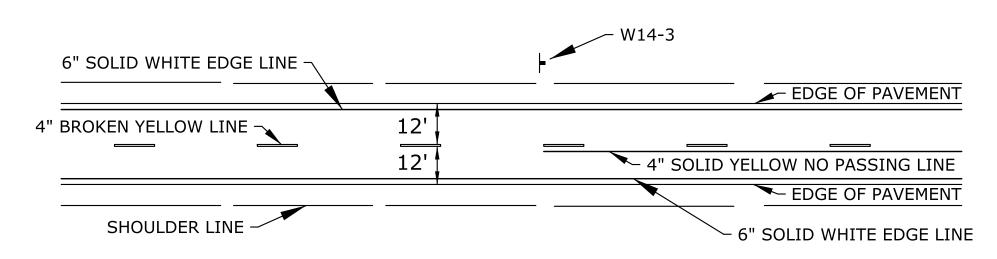

TYPICAL TWO LANE MARKINGS

NOTE:

LONGITUDINAL PAVEMENT MARKING LINES SHALL BE OFFSET A MINIMUM OF 2" FROM LONGITUDINAL PAVEMENT JOINTS.


NOTE:

ON NON I, US, AND K ROUTES, 4" EDGE LINES MAY BE INSTALLED. 6" EDGE LINES ARE NOT REQUIRED ON NON I, US, AND K ROUTES.

3	5/25/12	Added Dotted Extension and Lane Drop Lines	B.A.H.	B.D.G.
2	9/20/05	Removed Aux. Passing Lane Dotted Ext. Line	J.F.F.	B.D.G.
1	7/26/05	New FHWA Approval Date	J.F.F.	B.D.G.
NO.	DATE	REVISIONS	BY	APP'D
	KA	NSAS DEPARTMENT OF TRANSPORTATI	ON	
	KA		ON	
	KA	TYPICAL PAVEMENT	ON	
	KA		ON	

5/25/2012 APP'D Brian D. Gower
J.F.F. QUANTITIES TRACED TRACE CK.

KDOT Graphics Certified 07-17-2018

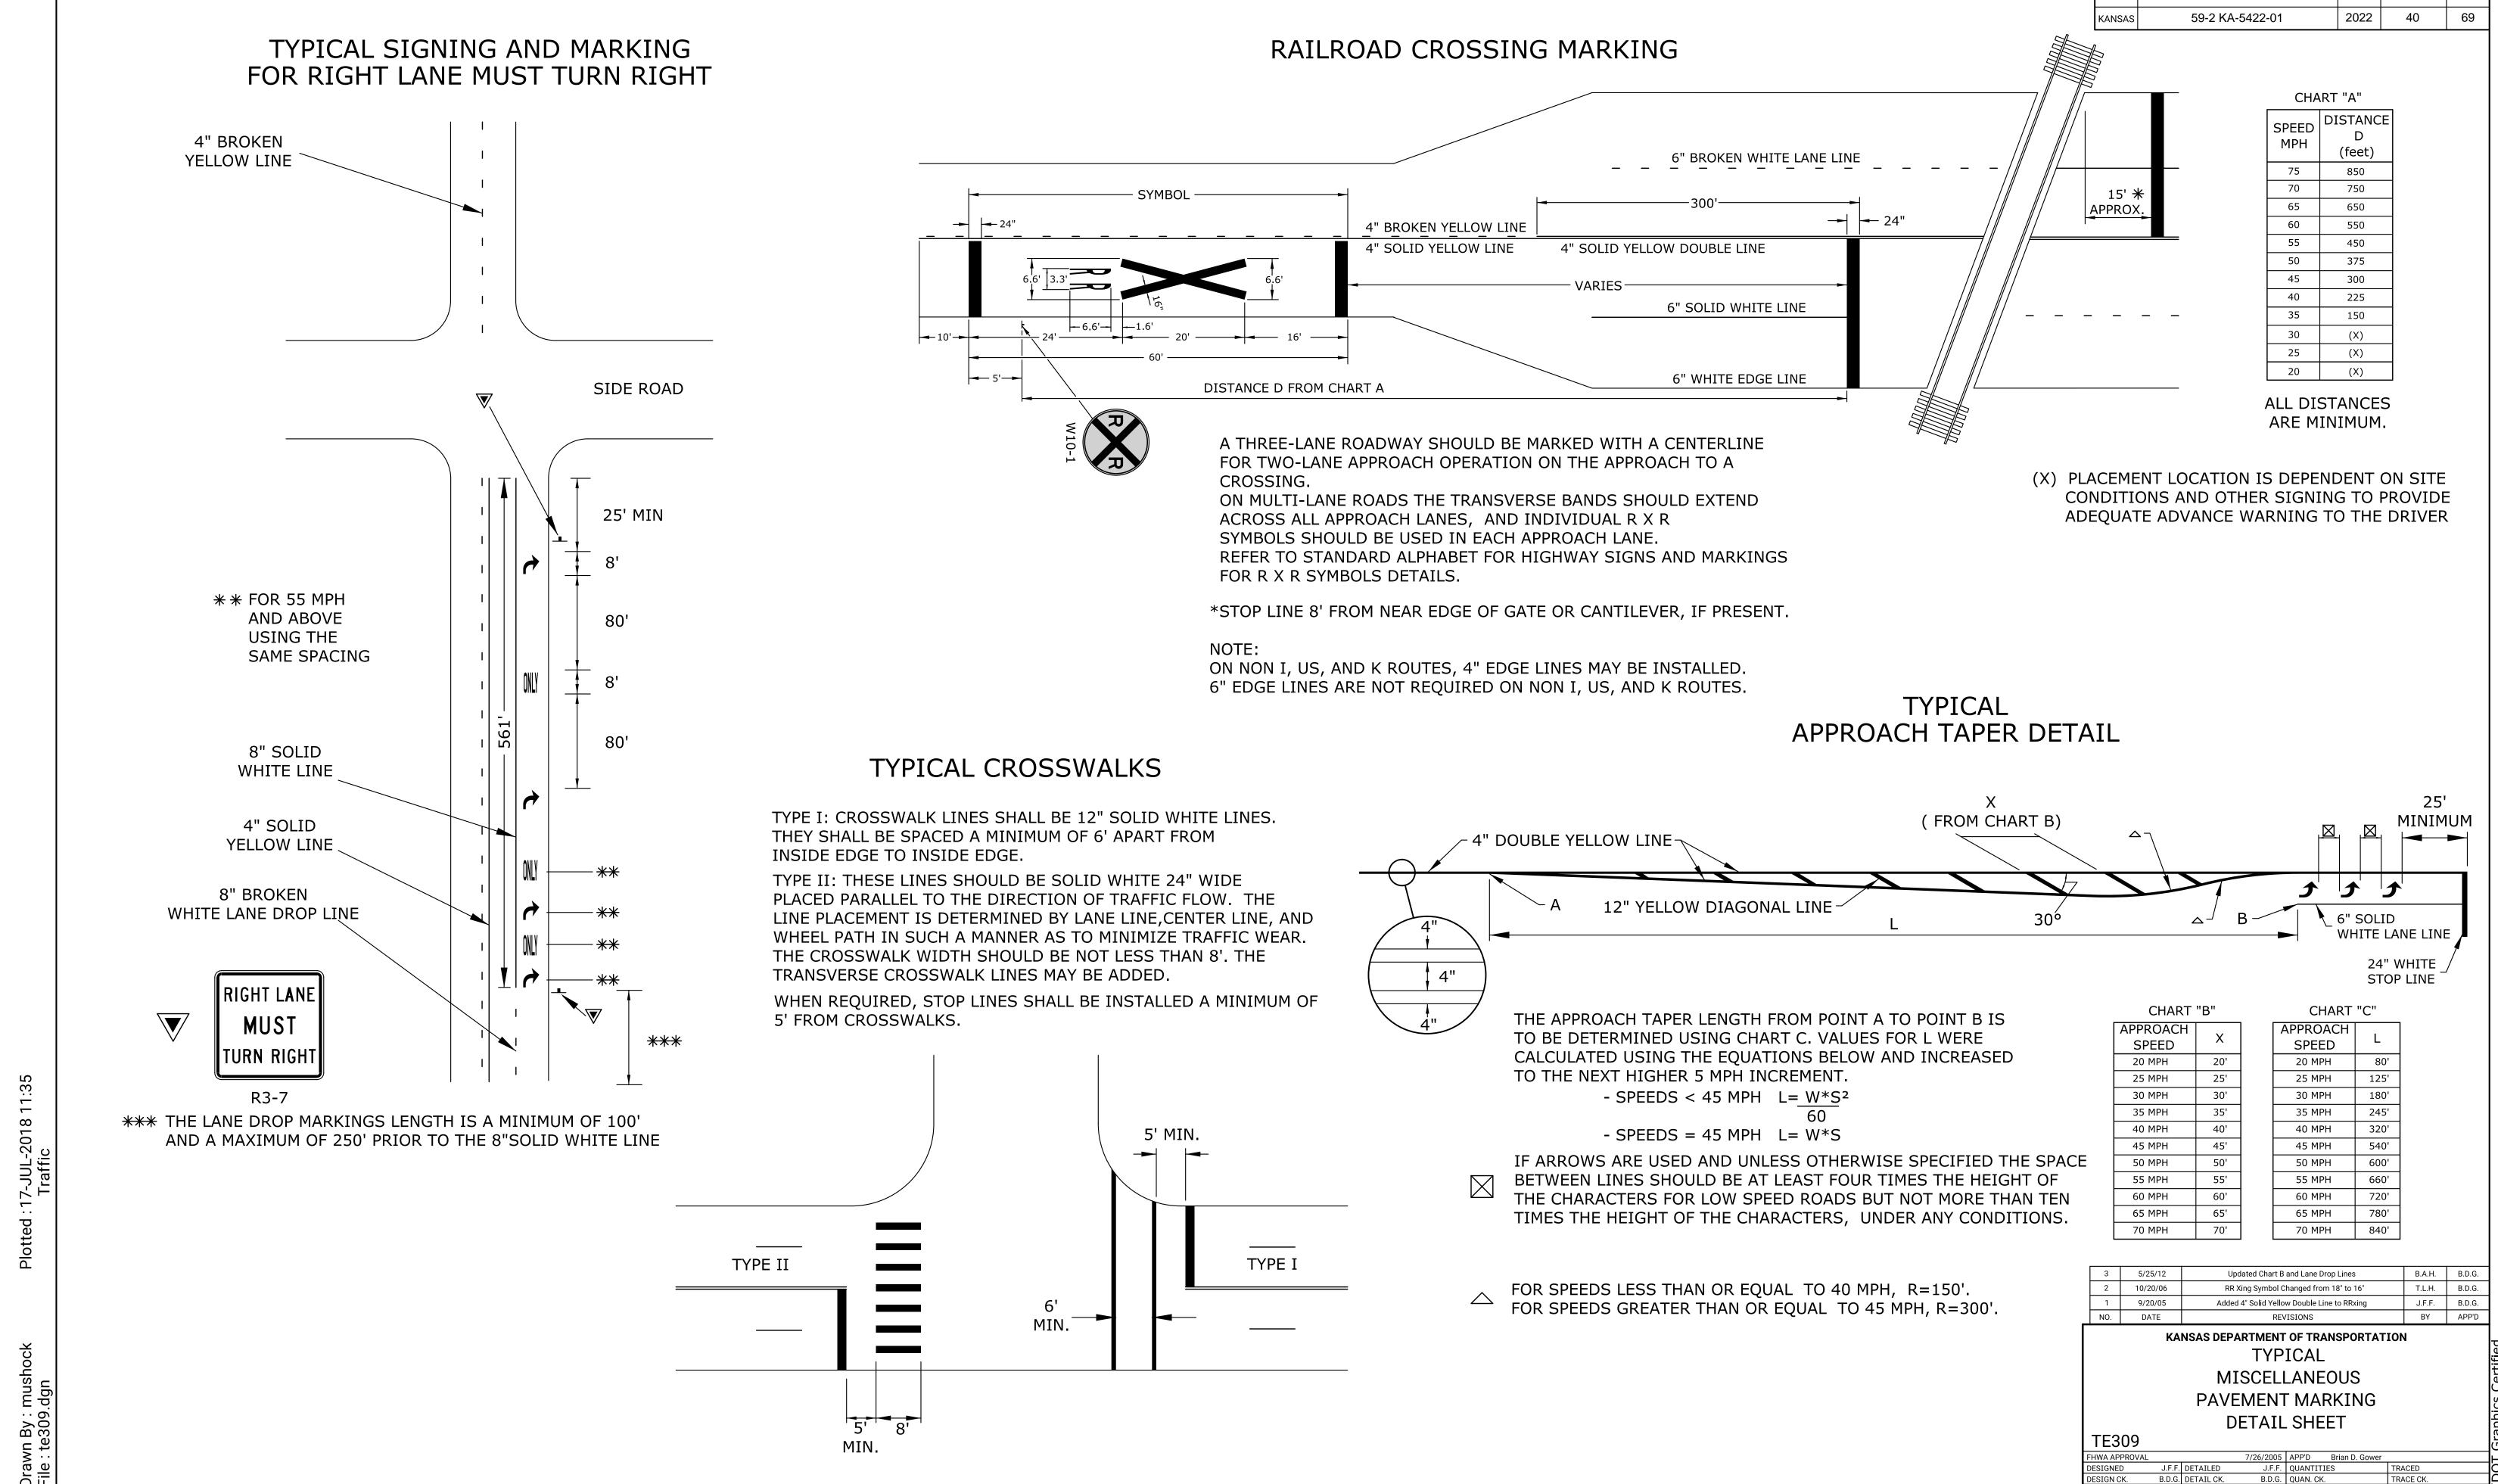

KDOT Graphics Certified 07-17-2018 Sh. No. XXX

YEAR SHEET NO.

STATE

PROJECT NO.

	SUMMARY OF PAVEMENT MARKINGS																				
LOCATION	4" Solid WHITE Edge Line	6" Solid WHITE Edge Line	6" Broken WHITE Lane Line	6" Broken WHITE Lane Line (PCP)	6" Dotted WHITE Extension Line	6" Broken WHITE Lane Drop Line	6" Solid WHITE Lane Line	8" Broken WHITE Lane Drop Line	8" Solid WHITE Gore Line	8" Dotted WHITE Extension Line	12" Solid WHITE Diagonal Line	12" Solid WHITE Chevron Line	WHITE	24" Solid WHITE Type II Crosswalk Line	Solid WHITE	4" Solid YELLOW Edge Line	4" Solid YELLOW Double Line	4" Solid YELLOW Line	4" Broken YELLOW Line	6" Solid YELLOW Edge Line	12" Solid YELLOW Diagonal Line
SB LT-LANE @ 4th AVE (BEGIN to 181+35)					75		125							40	24		200				
TWO-WAY LEFT-TURN LANE (4th to 3rd)																		186	186		
TWO-WAY LEFT-TURN LANE (3rd to 2nd)																		330	330		
TWO-WAY LEFT-TURN LANE (2nd to 1st)																		260	260		
TWO-WAY LEFT-TURN LANE (1st to Redbud)																		420	420		
TOTALS					24		125							40	24		400	1,196	300		

STATE	PROJECT NO.	YEAR	SHEET NO.	TOTAL SHEETS
KANSAS	59-2 KA-5422-01	2022	41	69

ITEMS	TOTAL	UNITS
PAVEMENT MARKING (MULTI-COMPONENT)(WHITE)(4")		FT
PAVEMENT MARKING (MULTI-COMPONENT)(WHITE)(6")	149	FT
PAVEMENT MARKING (MULTI-COMPONENT)(WHITE)(8")		FT
PAVEMENT MARKING (MULTI-COMPONENT)(WHITE)(12")		FT
PAVEMENT MARKING (MULTI-COMPONENT)(YELLOW)(4")	1,896	FT
PAVEMENT MARKING (MULTI-COMPONENT)(YELLOW)(6")	•	FT
PAVEMENT MARKING (MULTI-COMPONENT)(YELLOW)(12")		FT
PAVEMENT MARKING (THERMOPLASTIC)(WHITE)(4")		FT
PAVEMENT MARKING (THERMOPLASTIC)(WHITE)(6")		FT
PAVEMENT MARKING (THERMOPLASTIC)(WHITE)(8")		FT
PAVEMENT MARKING (THERMOPLASTIC)(WHITE)(12")		FT
PAVEMENT MARKING (THERMOPLASTIC)(YELLOW)(4")		FT
PAVEMENT MARKING (THERMOPLASTIC)(YELLOW)(6")		FT
PAVEMENT MARKING (THERMOPLASTIC)(YELLOW)(12")		FT
PAVEMENT MARKING (EPOXY)(WHITE)(4")		FT
PAVEMENT MARKING (EPOXY)(WHITE)(6")		FT
PAVEMENT MARKING (EPOXY)(WHITE)(8")		FT
PAVEMENT MARKING (EPOXY)(WHITE)(12")		FT
PAVEMENT MARKING (EPOXY)(YELLOW)(4")		FT
PAVEMENT MARKING (EPOXY)(YELLOW)(6")		FT
PAVEMENT MARKING (EPOXY)(YELLOW)(12")		FT
PAVEMENT MARKING (INTERSECTION GRADE)(WHITE)(12")		FT
PAVEMENT MARKING (INTERSECTION GRADE)(WHITE)(24")	64	FT
PAVEMENT MARKING (INTERSECTION GRADE)(YELLOW)(12")		FT
PAVEMENT MARKING SYMBOL (INTERSECTION GRADE)(WHITE)(LT ARROW)	13	EACH
PAVEMENT MARKING SYMBOL (INTERSECTION GRADE)(WHITE)()		EACH
PAVEMENT MARKING SYMBOL (INTERSECTION GRADE)(WHITE)()		EACH
PAVEMENT MARKING SYMBOL (INTERSECTION GRADE)(WHITE)()		EACH
PAVEMENT MARKING SYMBOL (INTERSECTION GRADE)(WHITE)()		EACH
PAVEMENT MARKING SYMBOL (INTERSECTION GRADE)(US-SHIELD)()		EACH
PAVEMENT MARKING SYMBOL (INTERSECTION GRADE)(K-SHIELD)()		EACH
PAVEMENT MARKING SYMBOL (INTERSECTION GRADE)(I-SHIELD)()		EACH
PAVEMENT MARKING (PATTERNED COLD PLASTIC)(WHITE)(6")		FT
PAVEMENT MARKING (PATTERNED COLD PLASTIC)(WHITE)(8")		FT
PAVEMENT MARKING (PATTERNED COLD PLASTIC)(WHITE)(12")		FT

					S	SUMM	ARY (OF W	ORD	& SYM	BOL	MAR	KINGS	5							
LOCATION	\(\)	4	†	4	4	Ė	STOP	ONLY	X-ING	SCHOOL	70	435	24	400	(13)	5	4	\$	\$ 1	≅>	<
SB LEFT-TURN LANE 2 4th AVE				3																	
TWO-WAY LEFT-TURN LANE (4th to 3rd)				2																	
TWO-WAY LEFT-TURN LANE (3rd to 2nd)				2																	
TWO-WAY LEFT-TURN LANE (2nd to 1st)				2																	
TWO-WAY LEFT-TURN LANE (1st to Redbud)				4																	
TOTALC				40																	
TOTALS				13																	

NOTE: FOR SPECIFIC PAVEMENT MARKING DETAILS AND DIMENSIONS SEE PLAN SHEETS

NOTE: ALL TOTALS REFLECT ACTUAL QUANTITY OF PAVEMENT MARKING MATERIALS REQUIRED.

NOTE:

WORDS & SYMBOLS SHALL CONFORM TO THE LATEST EDITION OF "STANDARD ALPHABETS FOR HIGHWAY SIGNS AND PAVEMENT MARKINGS" PRINTED BY THE U.S. DEPARTMENT OF TRANSPORTATION, FEDERAL HIGHWAY ADMINISTRATION.

PRIOR TO COMMENCEMENT OF PAVEMENT MARKING WORK THE ENGINEER WILL ESTABLISH THE LIMITS FOR "NO PASSING" ZONES. THESE LIMITS SHALL BE USED FOR THE LOCATION OF "NO PASSING" LINES AND FOR THE COMPUTATION OF ACTUAL MARKING QUANTITIES FOR THIS LINE TYPE.

NO. DATE REVISIONS BY APP'D KANSAS DEPARTMENT OF TRANSPORTATION SUMMARY AND RECAPITULATION								
1	7/26/05	New FHWA Approval Date	J.F.F.	B.D.G.				
2	5/25/12	Added Line Types, Symbols, and Shields	B.A.H.	B.D.G.				

SUMMARY AND RECAPITULATION

OF PAVEMENT MARKING

QUANTITIES

TE311

FHWA APPROVAL

DESIGNED

J.F.F. DETAILED

DESIGN CK.

B.D.G. DETAIL CK.

B.D.G. QUAN. CK.

TRACED

TRACED

KDOT Graphics Certified 07-17-2018

Sh. No. XXX

STATE	PROJECT NO.	YEAR	SHEET NO.	TOTAL SHEETS
KANSAS	59-2 KA-5422-01	2022	42	69

SYMBOL KEY

REMOVE SIGN REMOVE POST REMOVE FOOTING

REMOVE SIGN & POST

REMOVE POST & FOOTING REMOVE SIGN, POST, & FOOTING

MOUNT ON WOOD POST IN CONCRETE FOOTING

MOUNT ON WOOD POST IN SOIL

MOUNT ON STEEL BEAM BREAKAWAY POST

MOUNT ON STEEL U-POST

MOUNT ON PSST POST

MOUNT ON EXISTING POST

MOUNT ON VERTICAL SUPPORT

SHOULDER MOUNTED INSTALLATION

OFFSET MOUNTED INSTALLATION

EXISTING SIGN

EXISTING SIGN TO BE OVERLAID

SIGN IS NOT PART OF PROJECT

TYPE 'A' DELINEATOR (RIGID)

TYPE 'A' DELINEATOR (RIGID) (BK-BK)

TYPE 'B' DELINEATOR (RIGID)

TYPE 'A' DELINEATOR (FLEXIBLE)

TYPE 'A' DELINEATOR (FLEXIBLE) (BK-BK)

TYPE 'B' DELINEATOR (FLEXIBLE)

TYPE 2 OBJECT MARKER

TYPE 3 OBJECT MARKER

TYPE 3 OBJECT MARKER (BK-BK)

GENERAL NOTES

In order to expedite the completion of the project for traffic service, the signing and delineator work shall be sequenced with any other contract work such that the phases of construction may proceed and be completed at the same time.

New signs erected on the project which are in conflict with existing signing are to be completely covered until the existing signs are removed or the new signing is applicable. The existing signs that are being replaced, removed, or do not follow the current MUTCD signing standards are to be removed when the project is completed or as determined by the Engineer.

The Contractor shall exercise caution at all times when installing sign supports in and around areas where utilities exist, either underground or overhead, and will be held responsible for any damage incurred to the system. The installation of sign supports shall include the excavation, drilling, or driving the support footing and the erection of the sign support. The contractor shall exercise caution when working around any existing signs that are to remain and will be held responsible for any damage to the signs, supports, or footings. The Contractor shall exercise care when working around shrubbery while removing or installing signs or sign supports.

An existing sign post installation shall be plumb and the compaction of the backfill soil shall comply with the specifications after the removal and resetting of a sign, the removal and replacement of a sign, or the installation of a new sign.

The Contractor shall provide mounting bolts that are of a length that does not extend more than a nominal 1 inch beyond the sign post. The Contractor shall not make any field modifications to the mounting bolt prior to or after the sign is installed.

Specific service (LOGO) signs that are to be removed shall have the business logo plaques removed and transported to location determined by KDOT, at which time the plaques become the property of KDOT. The Contractor will be assessed a replacement cost for any damage to a business logo plaque prior to the plaque becoming the property of KDOT.

The materials and fabrication for signing and delineation work shall conform to the Standard Specifications for State Road and Bridge Construction (2015 edition) and Special Provisions.

INDEX OF SHEETS

- 42 SIGNING INDEX, SYMBOLS, & GENERAL NOTES
 - POST SPACING & SIGN ANGLE DETAILS
- 43 HEIGHT & LATERAL DISTANCE FOR ERECTION
- POSITIONING, DESIGN, & MOUNTING FOR OBJECT MARKERS (TYPE 2 & 3)
- POSITIONING FOR CHEVRON (W1-8) SIGNS
- 44 PLAN SHEETS (INSTALLATIONS)
- 44 PLAN SHEETS (REMOVALS) QUANTITIES SHEETS (INSTALLATIONS)
- QUANTITIES SHEET (DELINEATORS & OBJECT MARKERS)

POSITIONING, DESIGN, & MOUNTING OF DELINEATORS

- 45 SUMMARY SHEET (INSTALLATIONS & REMOVALS)
- 46 SUMMARY SHEET (REMOVAL & RESET)
- 47 RECAPITULATION SHEET
- 48 STANDARD STRUCTURAL SIGN SUPPORTS (WOOD & STEEL POSTS)

MOUNTING OF SIGNS ON WOOD POSTS

MOUNTING OF FLAT SHEET SIGNS ON STEEL I-BEAM POSTS

MOUNTING OF REINFORCED PANEL SIGNS ON I-BEAM POSTS

49-51 DETAILS FOR FLAT SHEET SIGN BLANKS

DETAILS FOR PROCESSED SIGNS

DETAILS FOR REINFORCED PANELS

DETAILS FOR GUIDE SIGN LEGEND

DETAILS FOR GUIDE SIGNS

52 DETAILED SIGN SPECIFICATIONS

10/01/19 Changed symbols, notes, & index D.D.G. E.W.N. D.D.G. Changed General Notes and Spec Book Date KANSAS DEPARTMENT OF TRANSPORTATION


SIGNING SYMBOL KEY **GENERAL NOTES** AND INDEX


TE402 10/01/2019 APP'D Steven A. Buckley
W.S.B. QUANTITIES IWA APPROVAL D.D.G. DETAILED
S.A.B. DETAIL CK.


KDOT Graphics Certified 12-17-2019

TRACE CK.

7/1/03 등

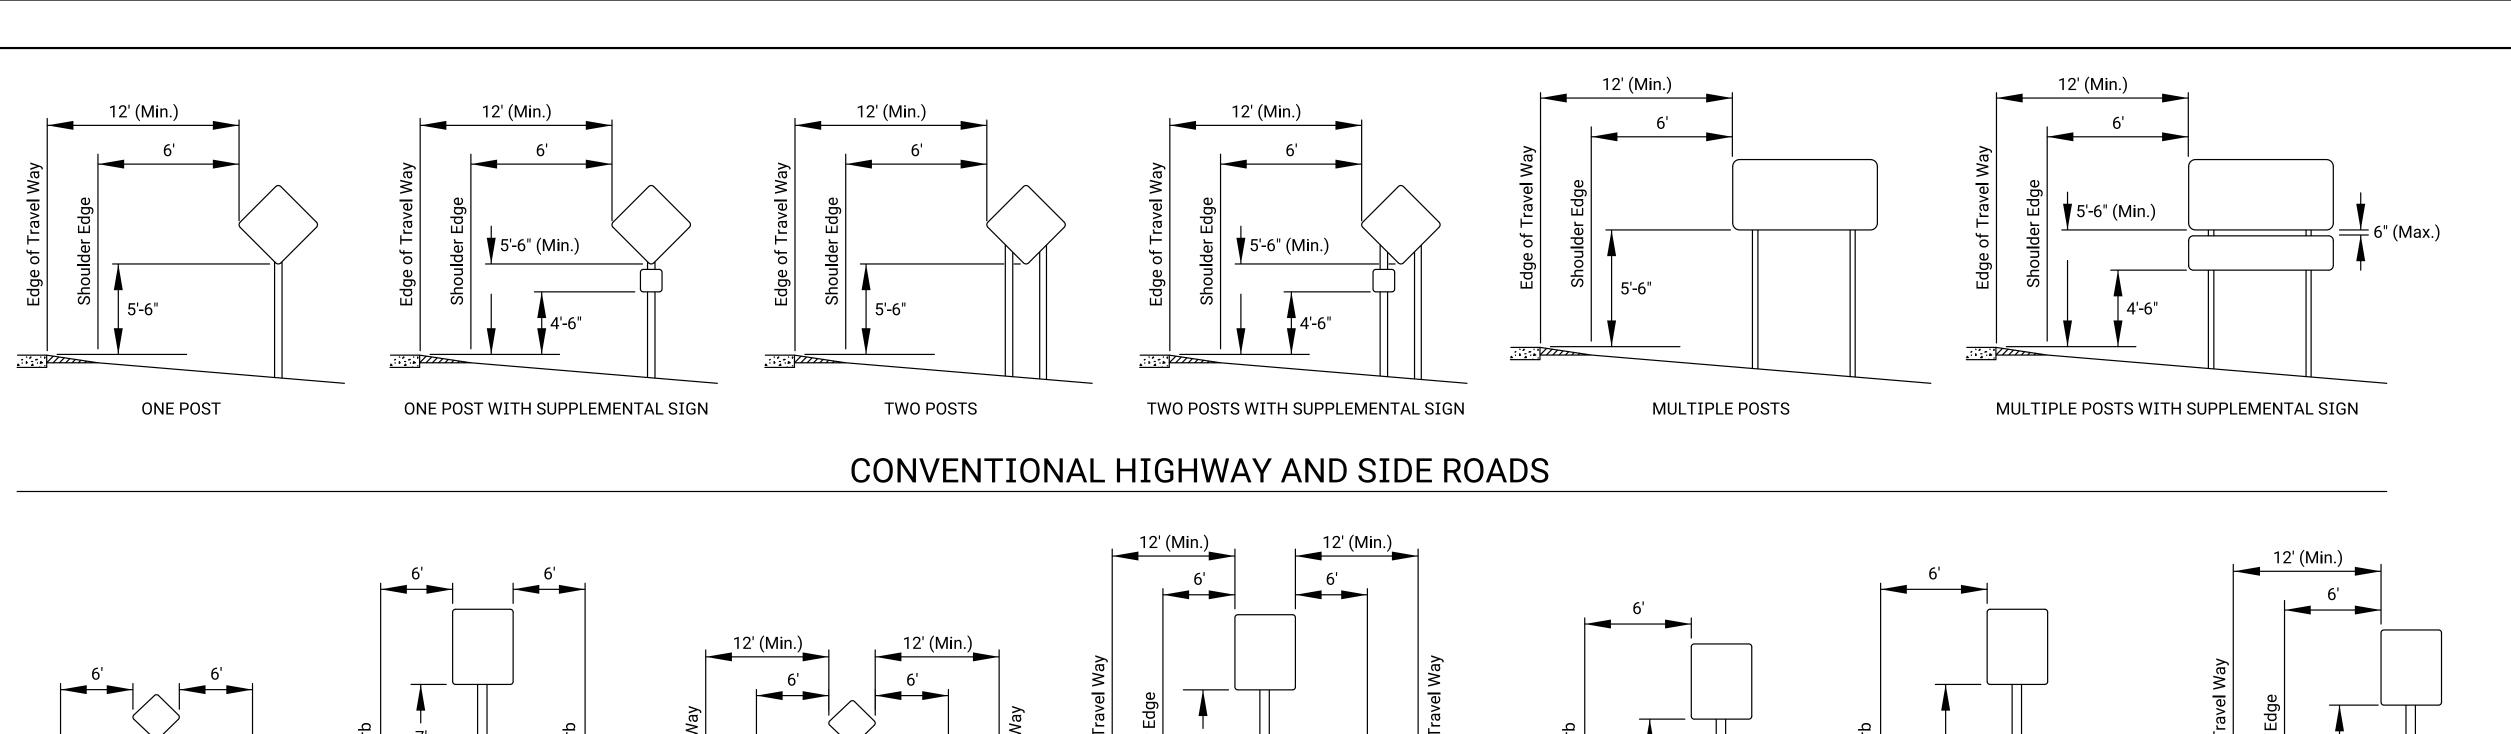

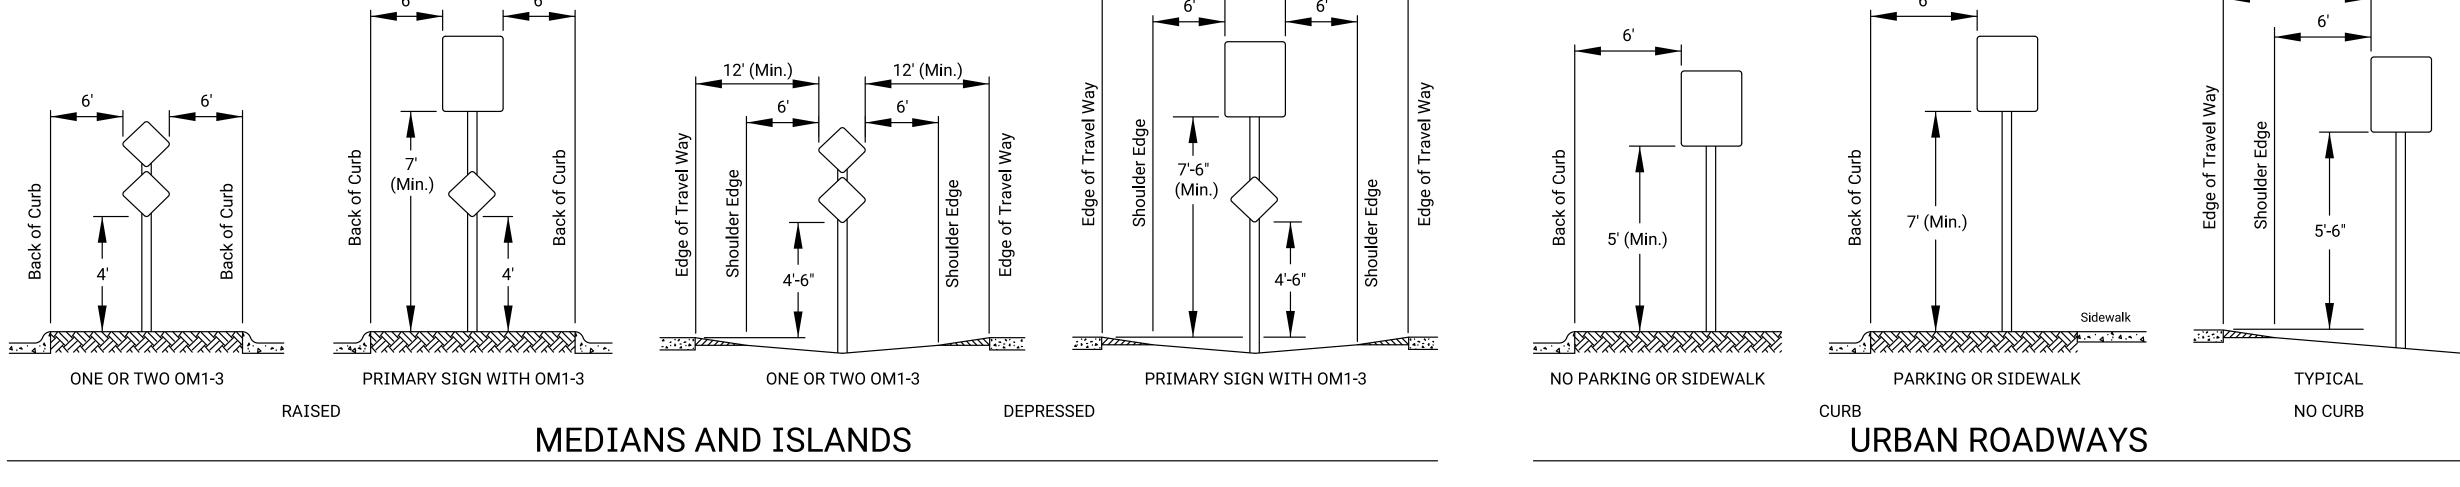

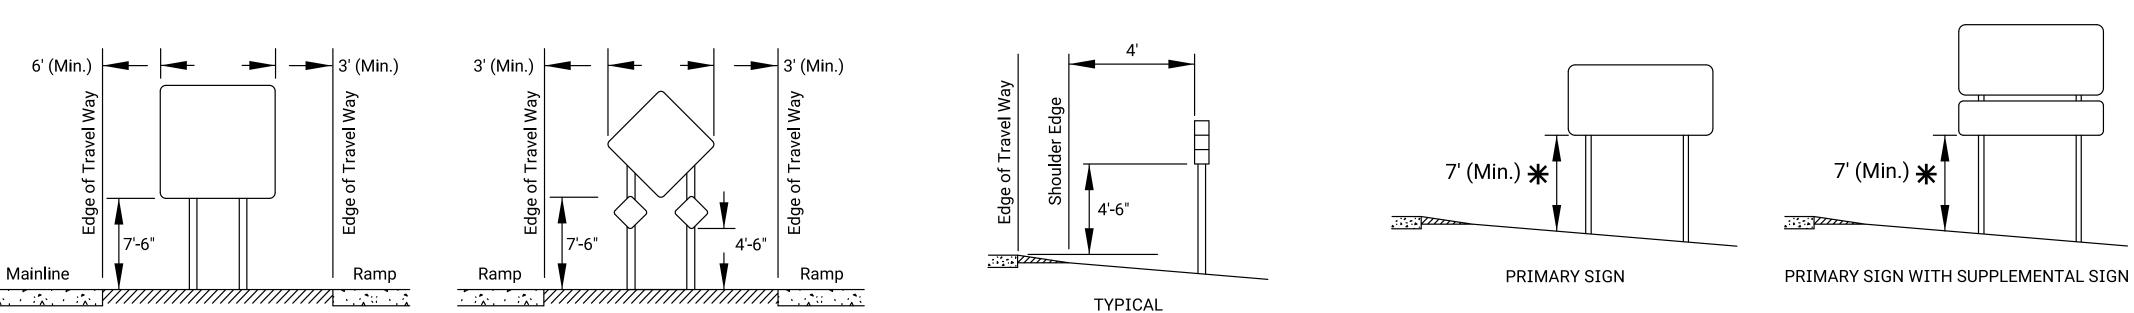

HIGHWAY GORES

RAMP/RAMP

MAINLINE/RAMP

REFERENCE MARKERS

Reference Marker Post: 2 Lb/Ft "U" Post

GROUND CLEARANCE FOR STEEL BEAM POSTS

*NOTE: Measured from the nearest point

between the sign and the groundline.

NOTES

The "Edge of Travel Way" is the edge line or the edge of the driving lane.

The outer edge of the sign shall not extend beyond the right of way line.

A minimum lateral clearance of 6' from pavement edge may be used where lateral offsets are limited.

In business, commercial, or residential districts where with limited lateral offsets, a minimum lateral clearance of 2' with a 7'-6" minimum mounting height may be used.


When signs are behind guard rail, the near edge of the sign shall not extend beyond the back side of the guard rail and the nearest sign post shall be a minimum of 5' from the face of the guard rail. Shoulder mounted shall not be located between 100' in advance of and 50' beyond the nose of the guard rail.

When the median or island is too narrow for the typical lateral placement, the sign may be placed a minimum of 2' from the back of the curb. In no case shall the sign edge extend beyond the back edge of the curb.

The gore sign shall be installed in the paved gore area. The edges of the gore sign shall not extend beyond the shoulder edge. The minimum distance from the centerline of the posts to the back of the paved gore area is 2'.

Signs may be moved laterally or longitudinally if it will improve visibility of the sign or other signs or if it will protect the sign more. The maximum allowable longitudinal adjustment is 100', with the exception of the reference marker which is 50'.

The minimum spacing between signs, excluding reference markers is 100'.

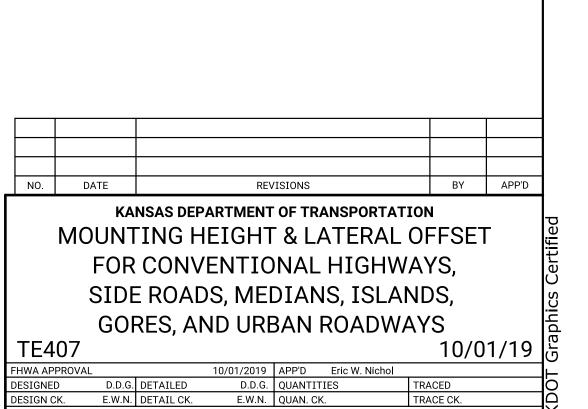

KDOT Graphics Certified 12-17-2019

Sh. No.

YEAR | SHEET NO.

43

2022


STATE

TYPICAL

ADOPT A HIGHWAY

PROJECT NO.

59-2 KA-5422-01

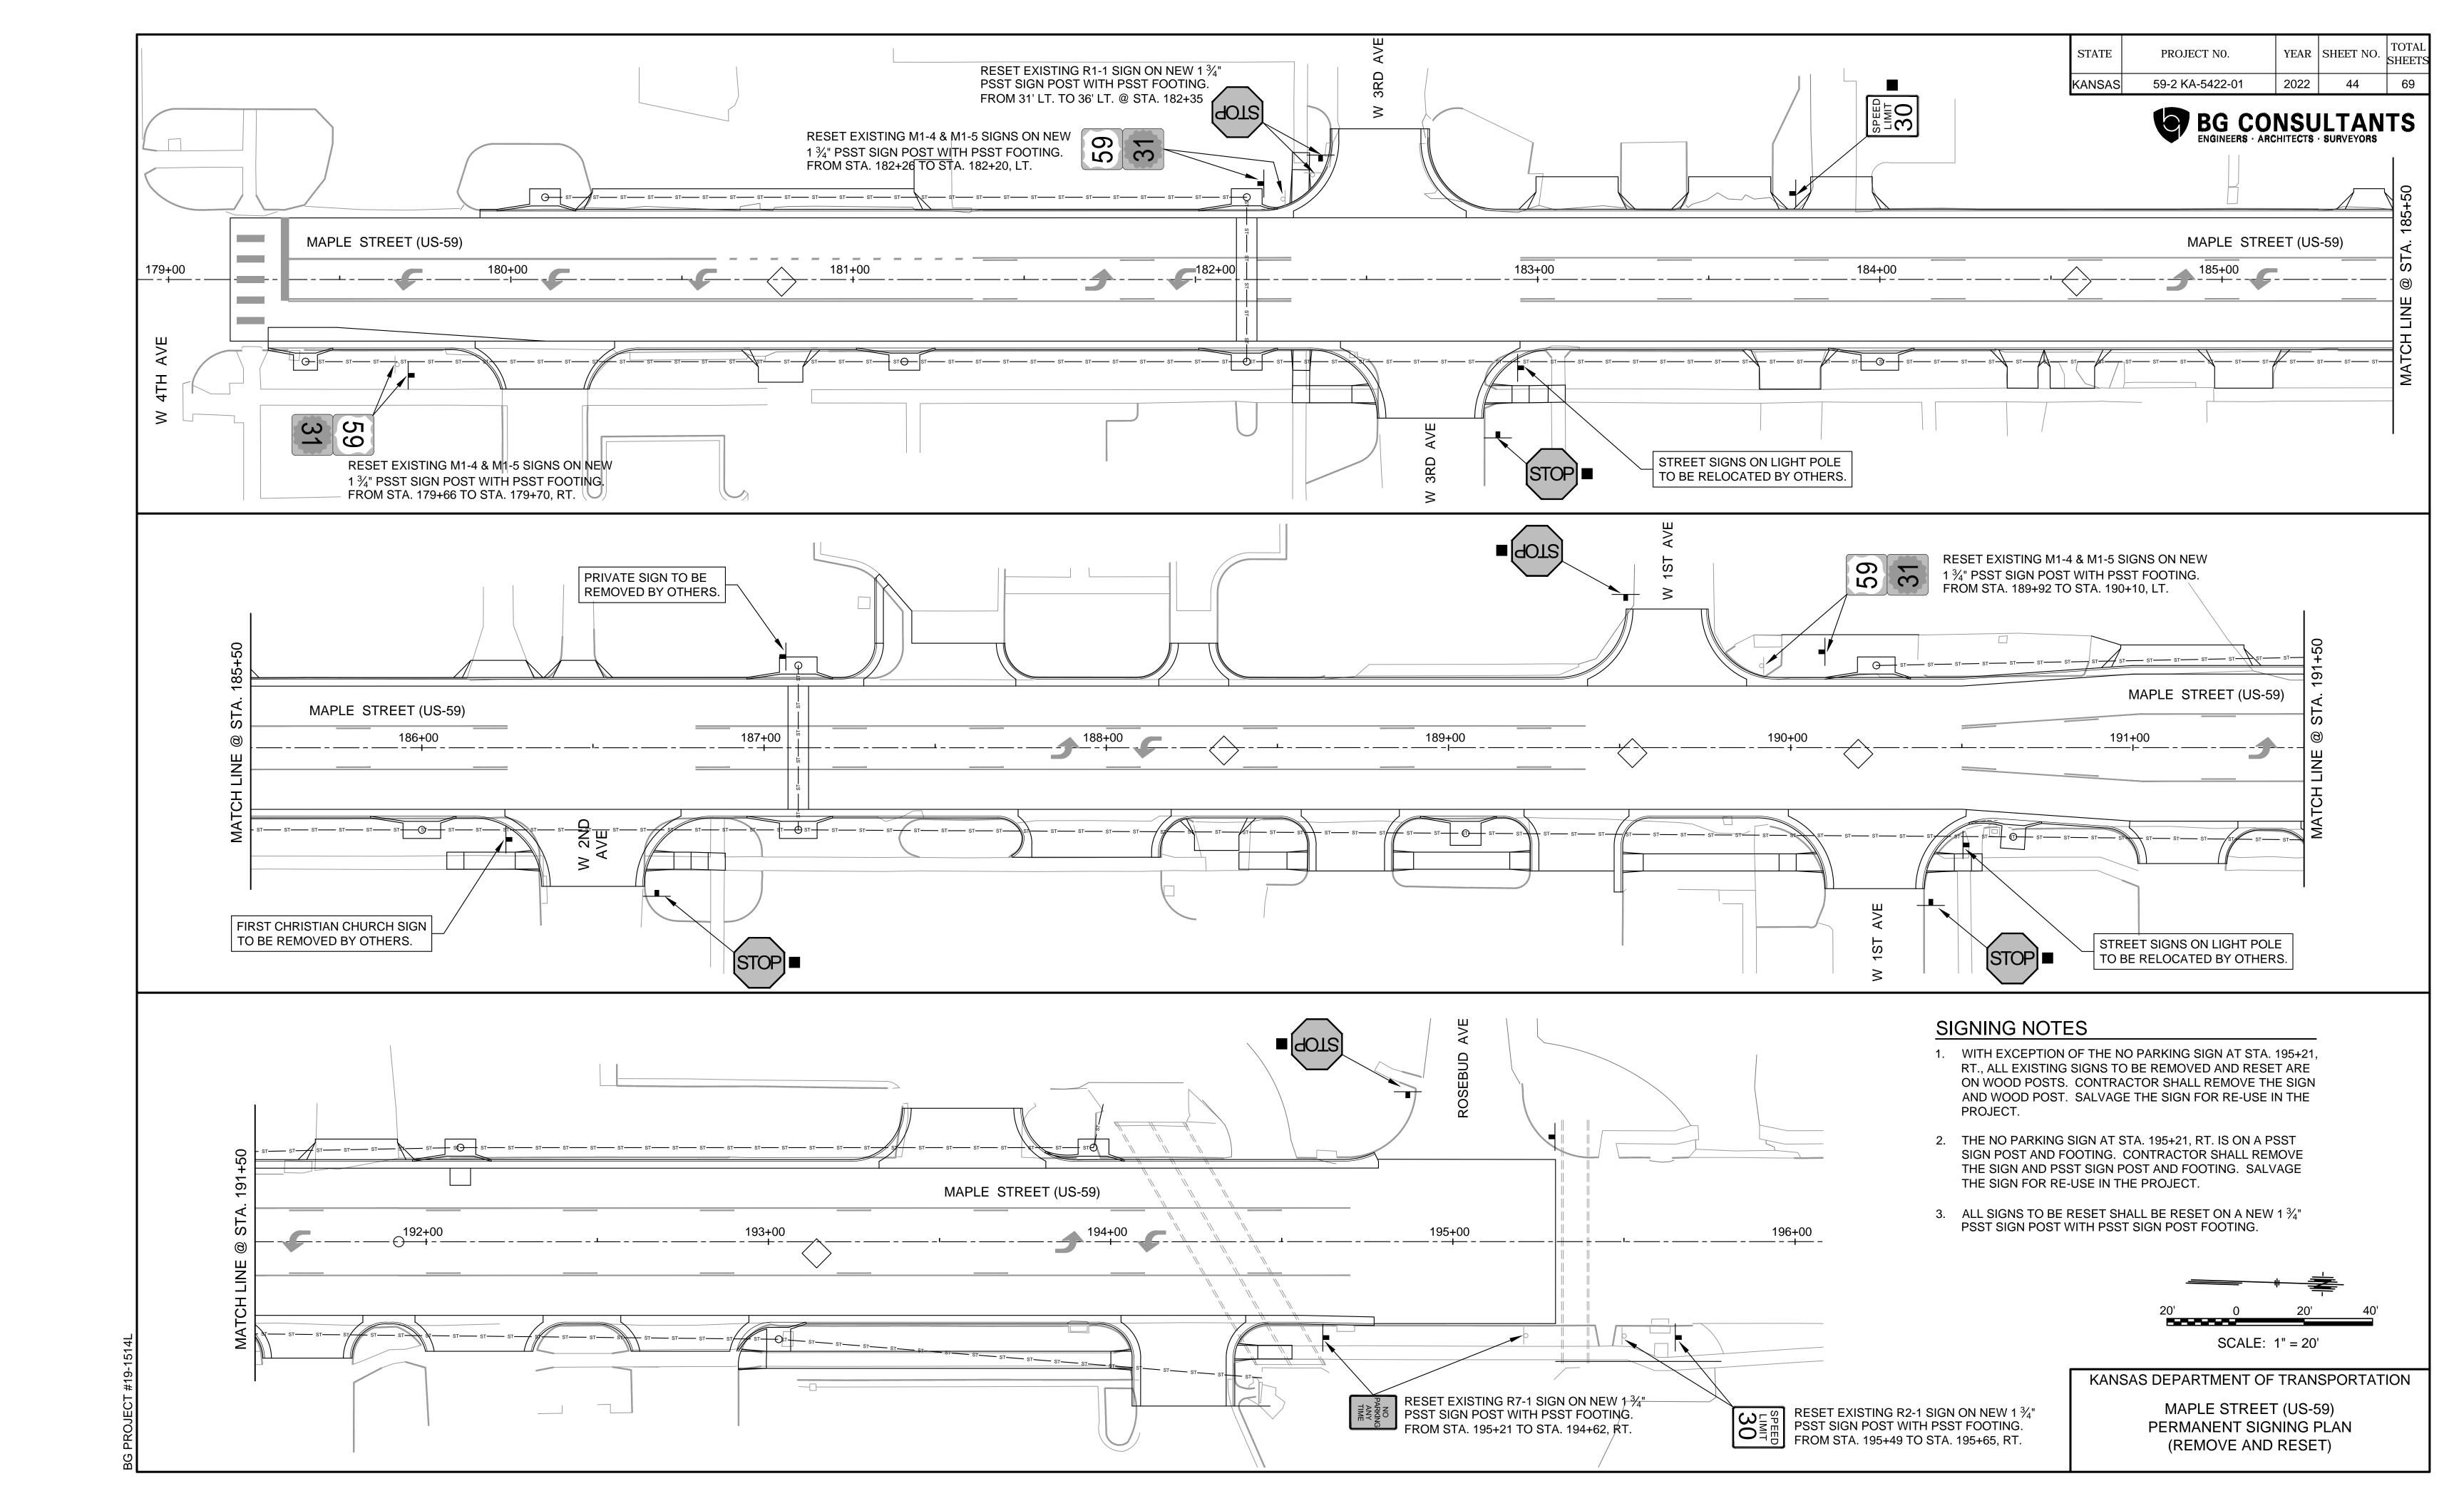

SUMMARY OF QUANTITIES

SI	SIGNS												
TYPE	NUMBER	SQUARE FEET											
FLAT SHEET													
REINFORCED PANEL													
OVERLAY													

DELINEA	TOR	S			
		IBLE EATOR	RIGID DELINEATOR		
TYPE	TYPE I ANCHOR	TYPE III ANCHOR	"U" POST	BRACKET MOUNT	
TYPE 'A' WHITE					
TYPE 'A' YELLOW					
TYPE 'B' WHITE					
TYPE 'B' YELLOW					
TYPE 'A' WHITE (BACK TO BACK)					
TYPE 'A' YELLOW (BACK TO BACK)					

OBJECT MARKERS							
	NUMBER						
TYPE 2 ("U" POS	T)						
TYPE 3 ("U" POS	T)						
	OM3-L						
INFORMATION ONLY	OM3-R						
	ОМ3-С						
TYPE 3 ("U" POS	TYPE 3 ("U" POST) (BACK TO BACK)						

NU	NUMBER & LENGTHS OF POSTS & ALUMINUM BEAMS (INFORMATION ONLY)								UM E	BEAM	IS (IN	IFOR	MAT	ION	ONLY	<u> </u>
	4"	x 6" PO	ST				(GALVAN	IZED ST	EEL BEA	AM POS	Т	PEI	RFORAT	ED SQU	ARE
	WO	OD	STEEL	M	"U" F	POST	We	5x9	W10)x12	W10)x22		TEEL TU		
LENGTH OF POST OR BEAM	FLAT SHEET SIGN	REINFORCED PANEL SIGN	STRUCTURAL TUBING	312.25 ALUMINUM BEAM	2 LBS/FT	3 LBS/FT	A36 STEEL	A572 STEEL (ALT)	A36 STEEL	A572 STEEL (ALT)	A36 STEEL	A572 STEEL (ALT)	1-3/4"	2"	2-1/4"	2-1/2"
2.1' - 4'																
4.1' - 6'																
6.1' - 8'																
8.1' - 10'																
10.1' - 12'													6			
12.1' - 14'																
14.1' - 16'																
16.1' - 18'																
18.1' - 20'																
20.1' - 22'																
22.1' - 24'																
24.1' - 26'																
26.1' - 28'																
28.1' - 30'																
30.1' - 32'																

	POSTS AND ALUMINUM BEAMS															
		1" x 6" POS	Т			GALVANIZED STEEL BEAM POST						PERFORATED SQUARE				
	WC	OOD	STEEL	≥	"U" F	POST	We	5x9	W10	0x12	W10	0x22			IBE (PSST)	
	FLAT SHEET SIGN	REINFORCED PANEL SIGN	STRUCTURAL TUBING	312.25 ALUMINUM BEAM	2 LBS/FT	3 LBS/FT	A36 STEEL	A572 STEEL (ALT)	A36 STEEL	A572 STEEL (ALT)	A36 STEEL	A572 STEEL (ALT)	1-3/4"	2"	2-1/4"	2-1/2"
NUMBER													6			
FEET													72			

	POST FOOTINGS AND BRACKETS										
		CONCRETE FOOTING (DIA.)				PERFORATED SQUARE STEEL					
		A572 STEEL TUBE FOOTI				OOTING		BRAC	CKET		
	WOOD	A36 S	STEEL	(ALT)							
	18"	24"	30"	24"	30"	1-3/4"	2"	2-1/4"	2-1/2"	1-3/4"	2"
NUMBER						6					
FEET											

BASE PLATES AND STUB POSTS								
	W6x9		W10x12		W10x22			
	A36 STEEL	A572 STEEL	A36 STEEL	A572 STEEL	A36 STEEL	A572 STEEL		
BREAKAWAY BASES		(ALT)		(ALT)		(ALT)		
BASE PLATE (TOP)								
STUB POST WITH BASE PLATE								
NON-BREAKAWAY BASES								
BASE PLATE								

SIGN STRUC	IURE	S		
TYPE	NEW	MODIFIED	REMOVE AND RESET	RESET
OVERHEAD STRUCTURE				
CANTILEVER STRUCTURE				
BUTTERFLY STRUCTURE				
BRIDGE MOUNT ATTACHMENT				
MAST ARM SIGN SUPPORT				
SINGLE TAPERED TUBE SIGN SUPPORT				

REMOVALS						
TYPE	NUMBER					
SIGNS (TO BE REUSED ON PROJECT)	9					
POSTS	6					
FOOTINGS	1					
SIGN STRUCTURES						

2	10/01/19		Revise	d Tables		D.	D.G.	E.W.N.	
1	7/23/10		Revise	ed Tables		D.	D.G.	D.B.	
NO.	NO. DATE REVISIONS BY APP'D								
SUMMARY OF QUANTITIES FOR INSTALLATIONS AND REMOVALS 7/1/03									
TE4	INS ⁻ 39	TALLA	FC)R				1/03	
TE4	39	TALLA	FC	OR AND I		VALS		1/03	
TE4 HWA AP ESIGNE	39 PROVAL	TALLA TO THE TRANSPORT THE TRA	FO FIONS	OR AND I	REMO	VALS		1/03	

SUMMARY OF QUANTITIES

REMOVAL AND RESETTING OF SIGNS ON PROJECT

EXISTING	NEW		
PLAN STATION	PLAN STATION	SIGN	SIGN SIZE
NUMBER	NUMBER	TYPE	
179+66, RT.	179+70, RT.	M1-4 & M1-5	24" x 24" (EACH)
182+26, LT.	182+20, LT.	M1-4 & M1-5	24" x 24" (EACH)
182+35, 31' LT.	182+35, 36' LT.	R1-1	30" x 30"
189+92, LT.	190+10, LT.	M1-4 & M1-5	24" x 24" (EACH)
195+21, RT.	194+62, RT.	R7-1	12" x 18"
195+49, RT.	195+65, RT.	R2-1	24" x 30"

		K	REMOVAL AND RESETTIN
EXISTING PLAN STATION NUMBER	NEW PLAN STATION NUMBER	SIGN TYPE	SIGN SIZE

	Т	T	
EXISTING PLAN STATION NUMBER	NEW PLAN STATION NUMBER	SIGN TYPE	SIGN SIZE

EXISTING PLAN STATION NUMBER	NEW PLAN STATION NUMBER	SIGN TYPE	SIGN SIZE

REVISIONS KANSAS DEPARTMENT OF TRANSPORTATION SUMMARY OF QUANTITIES ; cratif FOR REMOVAL AND RESETTING

OF SIGNS

Plotted by: KDOT#CADD.Support@ks.gov	18-DEC-201
File : te450.dgn	

BID ITEMS		XIMATE TITIES	UNITS
SIGN (FLAT SHEET) (HIGH PERFORMANCE)			SQUARE FOOT
SIGN (REINFORCED PANEL) (HIGH PERFORMANCE)			SQUARE FOOT
SIGN (OVERLAY) (HIGH PERFORMANCE)			SQUARE FOOT
SIGN POST (4" x 6" WOOD) (FLAT SHEET SIGN)			LINEAR FOOT
SIGN POST (4" x 6" WOOD) (REINFORCED PANEL SIGN)			LINEAR FOOT
SIGN POST (2 LB/FT "U" STEEL)			LINEAR FOOT
SIGN POST (3 LB/FT "U" STEEL)			LINEAR FOOT
SIGN POST (1-3/4" PERFORATED SQUARE STEEL TUBE)	7	72	LINEAR FOOT
SIGN POST (2" PERFORATED SQUARE STEEL TUBE)			LINEAR FOOT
SIGN POST (2-1/4" PERFORATED SQUARE STEEL TUBE)			LINEAR FOOT
SIGN POST (2-1/2" PERFORATED SQUARE STEEL TUBE)			LINEAR FOOT
SIGN POST (4" X 6" STRUCTURAL STEEL)			LINEAR FOOT
SIGN POST (3 I 2.25 ALUMINUM)			LINEAR FOOT
	A36	A572(ALT)	
SIGN POST (W6X9 STEEL BEAM)			LINEAR FOOT
SIGN POST (W10X12 STEEL BEAM)			LINEAR FOOT
SIGN POST (W10X22 STEEL BEAM)			LINEAR FOOT
SIGN POST STUB WITH BREAKAWAY BASE PLATE (W6X9)			EACH
SIGN POST STUB WITH BREAKAWAY BASE PLATE (W10X12)			EACH
SIGN POST STUB WITH BREAKAWAY BASE PLATE (W10X22)			EACH
SIGN POST BREAKAWAY BASE PLATE (W6X9)			EACH
SIGN POST BREAKAWAY BASE PLATE (W10X12)			EACH
SIGN POST BREAKAWAY BASE PLATE (W10X22)			EACH
SIGN POST FOOTING (24" Dia. CONCRETE)(STEEL BEAM POST)			LINEAR FOOT
SIGN POST FOOTING (30" Dia. CONCRETE)(STEEL BEAM POST)			LINEAR FOOT
SIGN POST FOOTING (18" Dia. CONCRETE)(WOOD POST)		1	LINEAR FOOT
SIGN POST FOOTING (1-3/4" PERFORATED SQUARE STEEL TUBE)		6	EACH
SIGN POST FOOTING (2" PERFORATED SQUARE STEEL TUBE)			EACH
SIGN POST FOOTING (2-1/4" PERFORATED SQUARE STEEL TUBE)			EACH
SIGN POST FOOTING (2-1/2" PERFORATED SQUARE STEEL TUBE)			EACH
SIGNING OBJECT MARKER (TYPE 2)			EACH
SIGNING OBJECT MARKER (TYPE 3)			EACH
SIGNING DELINEATOR (TYPE A)(WHITE RIGID, "U" POST)			EACH
SIGNING DELINEATOR (TYPE A)(YELLOW RIGID, "U" POST)			EACH
SIGNING DELINEATOR (TYPE B)(WHITE RIGID, "U" POST)			EACH
SIGNING DELINEATOR (TYPE B)(YELLOW RIGID, "U" POST)			EACH
SIGNING DELINEATOR (TYPE A)(WHITE FLEXIBLE)(TYPE I ANCHOR)			EACH
SIGNING DELINEATOR (TYPE A)(YELLOW FLEXIBLE)(TYPE I ANCHOR)			EACH
SIGNING DELINEATOR (TYPE B)(WHITE FLEXIBLE)(TYPE I ANCHOR)			EACH
SIGNING DELINEATOR (TYPE B)(YELLOW FLEXIBLE)(TYPE I ANCHOR)			EACH
SIGNING DELINEATOR (TYPE A)(WHITE FLEXIBLE)(TYPE 3 ANCHOR)			EACH
SIGNING DELINEATOR (TYPE A)(YELLOW FLEXIBLE)(TYPE 3 ANCHOR)			EACH
SIGNING DELINEATOR (TYPE B)(WHITE FLEXIBLE)(TYPE 3 ANCHOR)			EACH
SIGNING DELINEATOR (TYPE B)(YELLOW FLEXIBLE)(TYPE 3 ANCHOR)			EACH

BID ITEMS	APPROXIMATE QUANTITIES	UNITS
SIGN (REMOVE AND RESET)	LUMP SUM	L.S.

Note:

The contract bid for steel beam posts, stub posts, base plates, and footings will be based on A36 Grade steel quantities. When furnishing the A572 Grade alternate steel, the payment will be based on the equivalent A36 steel unit prices in the contract.

	2	10/01/19	Removed PSST coupler and changed the tables	D.D.G.	E.W.N.
	1	7/23/10	Changed Bid Items as per Spec Book (2007)	D.D.G.	D.B.
	NO.	DATE	REVISIONS	ВҮ	APP'D
Г					

KANSAS DEPARTMENT OF TRANSPORTATION
RECAPITULATION OF
SIGNING & DELINEATION
BID ITEMS

TE450

FHWA APPROVAL

DESIGNED

DESIGN CK.

S.A.B. DETAIL CK.

D.D.G. QUAN. CK.

TRACE CK.

7/1/03

DESIGN CK.

7/1/03

DESIGN CK.

TRACE CK.


KDOT Graphics Certified 12-17-2019

YEAR SHEET NO.


2022 47

PROJECT NO.


59-2 KA-5422-01

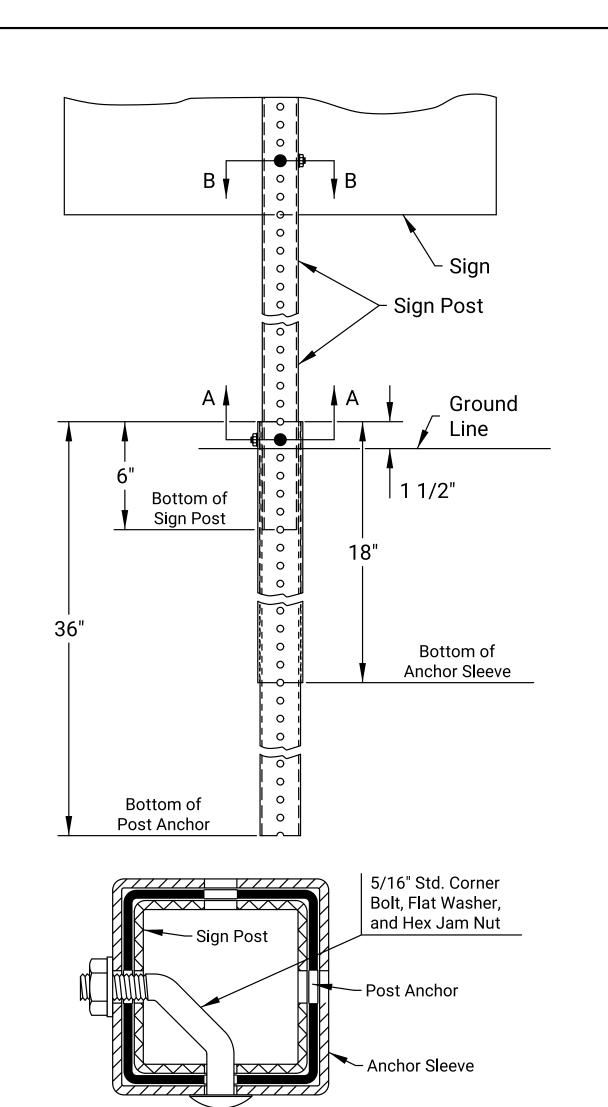

1 $\frac{3}{4}$ ", 2", OR 2 $\frac{1}{4}$ " PSST SIGN POST

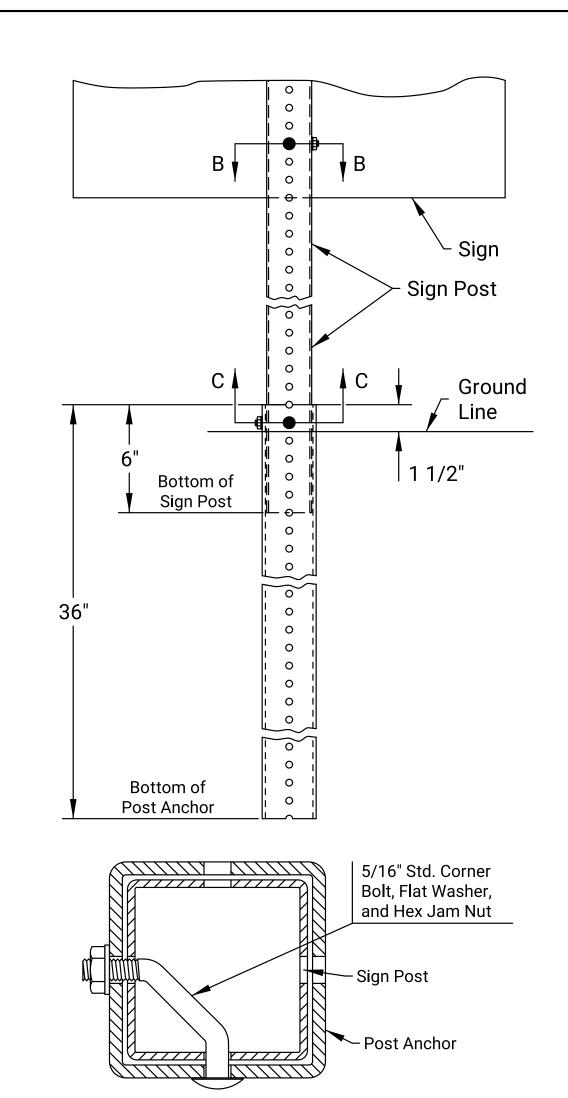

SECTION C-C 2 ½" PSST SIGN POST

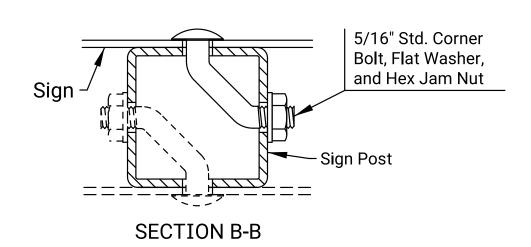

SECTION A-A


MATERIALS	TABLE FOR SIGN POST A	ND FOOTING
SIGN POST	FOO ⁻	TING
12 GA. OR 14 GA.	POST ANCHOR	ANCHOR SLEEVE
1 ¾" X 1 ¾"	2" X 2" X 12 GA.	2 ¼" X 2 ¼" X 12 GA.
2" X 2"	2 ¼" X 2 ¼" X 12 GA.	2 ½" X 2 ½" X 12 GA.
2 ½" X 2 ½"	2 ½" X 2 ½" X 12 GA.	3" X 3" X 7 GA.
2 ½" X 2 ½"	3" X 3" X 7 GA.	Not Required

NOTE: 14 ga. posts must meet a certified minimum yield strength of 60,000 p.s.i.

INSTALLATION PROCEDURES

- 1. Plumb and drive post anchor into the ground 18", if anchor sleeve is required, or to the specified height above the ground line.
- 2. Install anchor sleeve (if required) on the post anchor and align the first holes above the ground line. Plumb and drive post anchor with anchor sleeve into the ground to the specified height above the ground line.
- 3. Install sign post into the post anchor.

PERFORATED SQUARE STEEL TUBE POST (PSST)

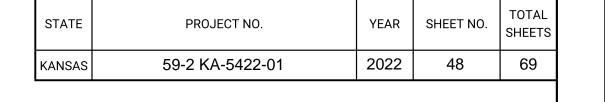

"U" Post

 $|\frac{5}{16}$ " X 2 $\frac{1}{2}$ " Carriage Bolt,


Sign

Light Lock Washer, Nylon

Washer, and Reg. Hex Nut

SECTION D-D

(BACK TO BACK)

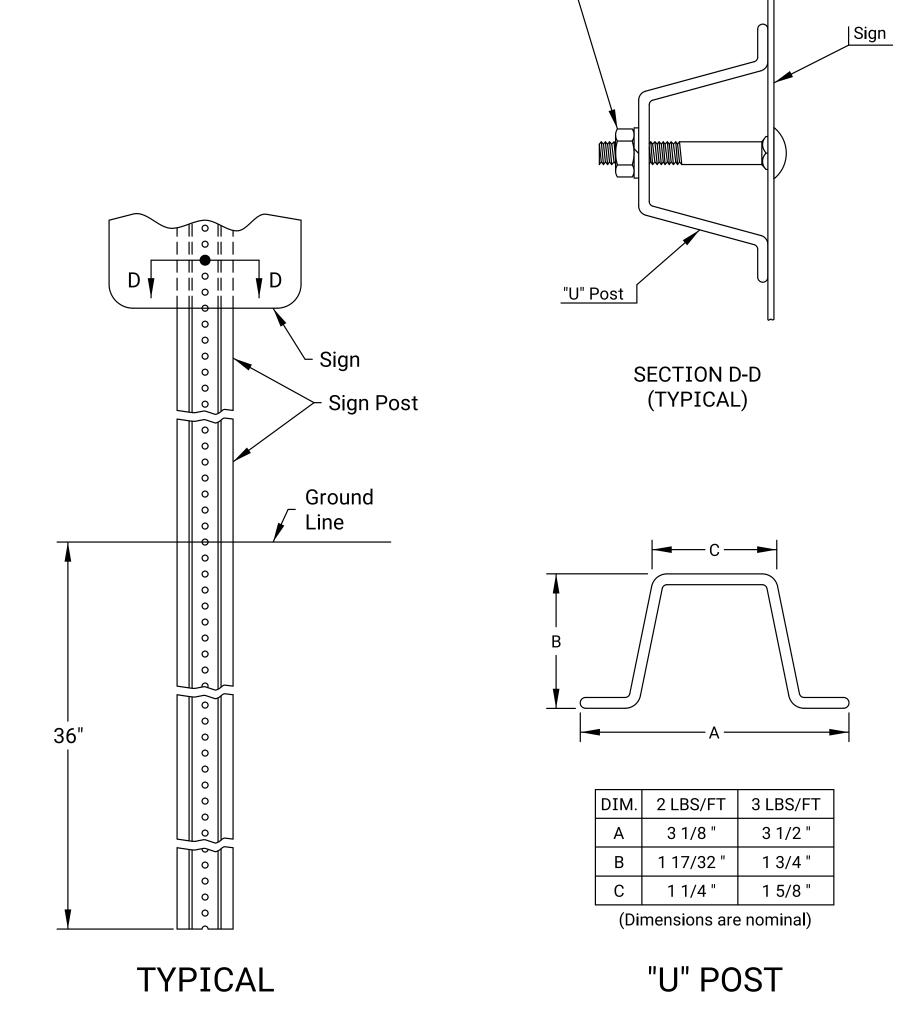


 $|\frac{5}{16}$ " X 2 $\frac{1}{2}$ " Carriage

and Reg. Hex Nut


Bolt, Light Lock Washer,

STEEL "U" POST

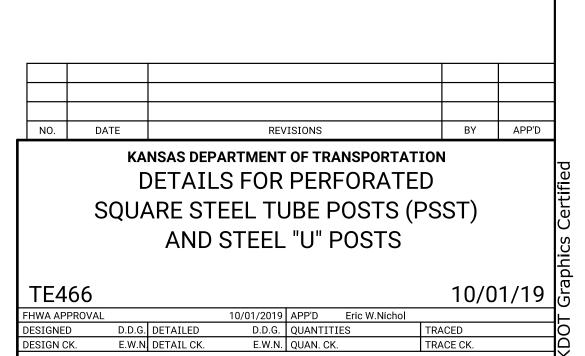

KDOT Graphics Certified 12-17-2019

Sh. No.

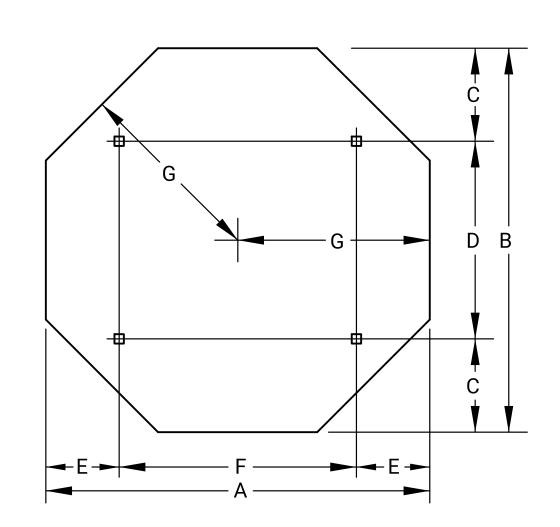

A	C
	D

	_A	
	+	В
		T C L
A		
		D
	E	


B	<u>/</u>
E	

SIGN SIZE	А	В	С	D	Е	F	G	Т	AREA
48 X 48	48	48	12	24	9	30	24	0.100	13.25


010110175					_	A D E A
SIGN SIZE	А	В	Ü	U		AREA
36 X 36	36	3	18	2	0.080	3.90

SIGN SIZE	Α	В	С	D	Е	Т	AREA
48 X 48	48	3	12	18	3	0.080	6.93
60 X 60	60	3	18	18	4	0.100	10.83


SIGN SIZE	Α	В	С	D	Е	Т	AREA
48 X 36	48	36	9	14 3/4	2 1/4	0.125	5.56

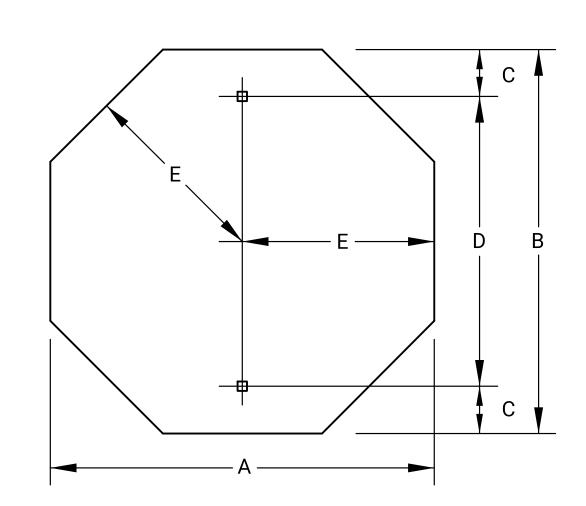

			T	T			•
SIGN SIZE	Α	В	С	D	Ē	Т	AREA
30 X 30	30	30	3	24	15	0.080	5.18
36 X 36	36	36	6	24	18	0.080	7.46

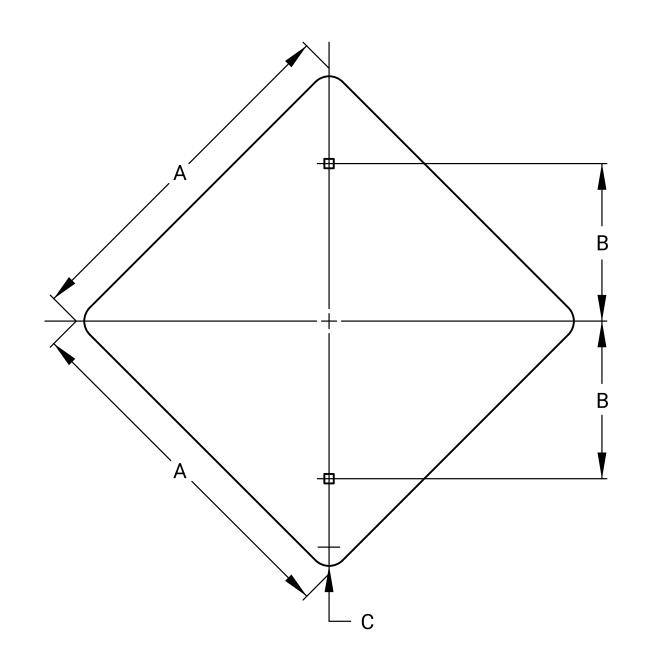

	SIGN SIZE	Α	В	С	Т	AREA
	18 X 18	18	6	1 ½	0.080	2.25
	24 X 24	24	12	1 ½	0.080	4.00
	30 X 30	30	12	1 %	0.080	6.25
1	36 X 36	36	18	2 1/4	0.080	9.00

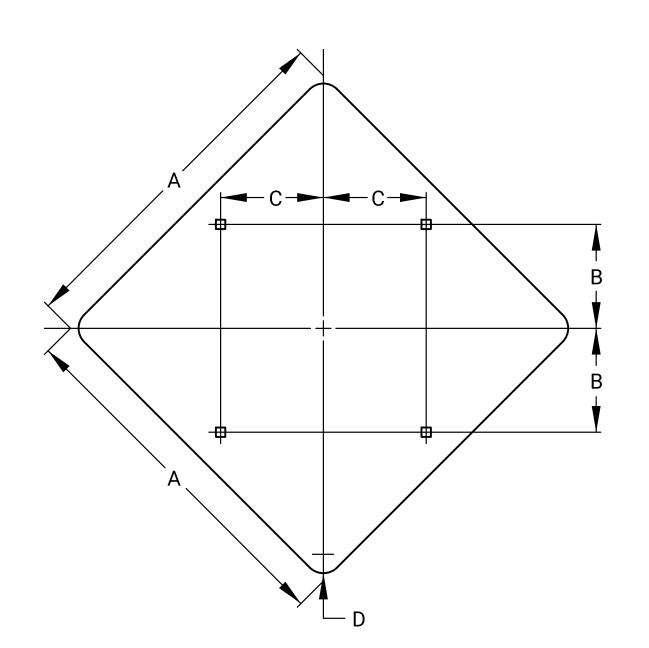


SIGN SIZE	Α	В	С	D	Т	AREA
48 X 48	48	12	15	3	0.100	16.00

NOTE: All holes are 3/8 " square unless otherwise noted.

The dimension "t" is the thickness of the aluminum blank.

1 Center hole is required.

All dimensions are in inches.

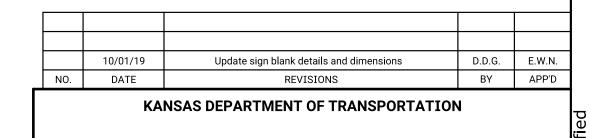

SIGN BLANK DETAILS FOR FLAT SHEET SIGNS

7/1/03 👨 FHWA APPROVAL

DESIGNED

D.D.G. DETAILED

DESIGN CK.

DETAILED

DETAILED

DETAILED

DETAILED

DETAILED

D.D.G. QUANTILES


T


DESIGN CK.

D.D.G. QUAN. CK.

T

KDOT Graphics Certified 12-17-2019

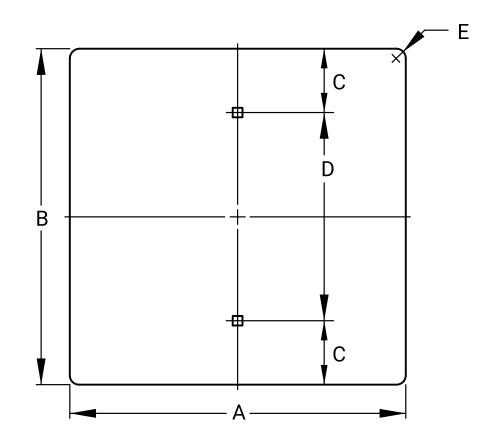

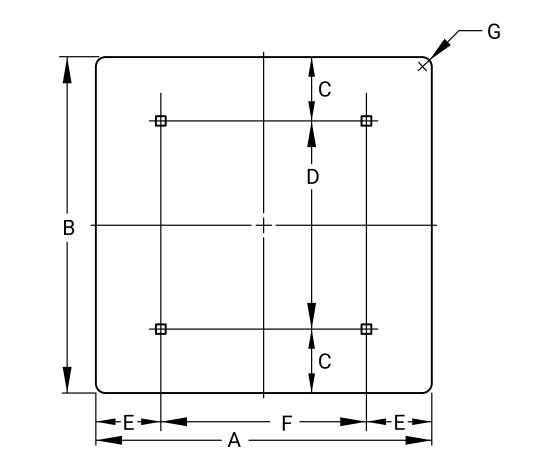

	SIGN SIZE	Α	В	С	D	Е	Т	AREA
1)	3 X 8	3	8	1	6	3/8	0.040	0.17
1)	6 X 12	6	12	3	6	3/8	0.063	0.50
	12 X 6	12	6	1 ½	3	3/4	0.063	0.50
	12 X 9	12	9	1 ½	6	1 ½	0.063	0.75
	12 X 18	12	18	3	12	1 ½	0.063	1.50
	12 X 24	12	24	3	18	1 ½	0.080	2.00
	12 X 36	12	36	6	24	1 ½	0.080	3.00
	12 X 48	12	48	6	36	1 ½	0.080	4.00
	18 X 6	18	6	1 ½	3	1 ½	0.063	0.75
	18 X 18	18	18	3	12	1 ½	0.063	2.25
	18 X 30	18	24	3	24	1 ½	0.080	3.75
	18 X 36	18	24	6	24	1 ½	0.080	4.50
	18 X 42	18	24	6	30	1 ½	0.080	5.25
	18 X 48	18	24	6	36	1 ½	0.080	6.00
	21 X 15	21	15	1 ½	12	1 ½	0.080	2.19
	24 X 6	24	6	1 ½	3	1 ½	0.080	1.00
	24 X 12	24	12	3	6	1 ½	0.080	2.00
	24 X 18	24	18	3	12	1 ½	0.080	3.00
	24 X 24	24	24	3	18	1 ½	0.080	4.00
	24 X 30	24	30	3	24	1 ½	0.080	5.00
	24 X 36	24	36	6	24	1 ½	0.080	6.00
	30 X 12	30	12	3	6	1 %	0.080	2.50
	30 X 15	30	15	1 ½	12	1 %	0.080	3.13
	30 X 18	30	18	3	12	1 %	0.080	3.75
	30 X 21	30	21	1 ½	18	1 ½	0.080	4.38
	30 X 24	30	24	3	18	1 %	0.080	5.00
	30 X 30	30	30	3	24	1 %	0.080	6.25
	30 X 36	30	36	6	24	1 %	0.080	7.50
	36 X 12	36	12	3	6	1 ½	0.080	3.00
	36 X 18	36	18	3	12	1 ½	0.080	4.50
	36 X 24	36	24	3	18	1 ½	0.080	6.00
		†	 	†			†	

36 X 30

36 X 36

45 X 36

36

36

45

30

36

36

2 ½ | 0.080 | 7.50

2 ½ 0.080 9.00

2 1/4 | 0.100 | 11.25

SIGN SIZE	Α	В	С	D	Е	F	G	Т	AREA
36 X 12	36	12	3	6	3	30	1 ½	0.080	3.00
36 X 30	36	30	3	24	3	30	2 1/4	0.080	7.50
36 X 48	36	48	9	30	6	24	0	0.100	12.00
36 X 60	36	60	12	36	6	24	0	0.100	15.00
36 X 72	36	72	6	60	6	24	0	0.100	18.00
42 X 12	48	12	3	6	6	30	1 ½	0.080	3.50
42 X 18	48	18	3	12	6	30	1 ½	0.080	5.25
42 X 24	48	24	6	12	6	30	1 %	0.080	7.00
42 X 36	48	36	6	24	6	30	0	0.100	10.50
48 X 12	48	12	3	6	9	30	1 ½	0.080	4.00
48 X 18	48	18	3	12	9	30	1 ½	0.080	6.00
48 X 24	48	24	6	12	9	30	1 %	0.080	8.00
48 X 30	48	30	6	18	9	30	0	0.100	10.00
48 X 36	48	36	6	24	9	30	0	0.100	12.00
48 X 42	48	42	6	30	9	30	0	0.100	14.00
48 X 48	48	48	9	30	9	30	0	0.100	16.00
48 X 60	48	60	12	36	9	30	0	0.100	20.00
48 X 72	48	72	6	60	9	30	0	0.100	24.00
48 X 96	48	96	12	72	9	30	0	0.100	32.00
60 X 12	60	12	3	6	12	36	0	0.100	5.00
	36 X 12 36 X 30 36 X 48 36 X 60 36 X 72 42 X 12 42 X 18 42 X 24 42 X 36 48 X 12 48 X 18 48 X 24 48 X 30 48 X 36 48 X 42 48 X 48 48 X 60 48 X 72 48 X 96	36 X 12 36 36 X 30 36 36 X 48 36 36 X 60 36 36 X 72 36 42 X 12 48 42 X 18 48 42 X 24 48 42 X 36 48 48 X 12 48 48 X 12 48 48 X 30 48 48 X 30 48 48 X 36 48 48 X 36 48 48 X 36 48 48 X 42 48 48 X 42 48 48 X 42 48 48 X 42 48 48 X 49 48	36 X 12 36 12 36 X 30 36 30 36 X 48 36 48 36 X 60 36 60 36 X 72 36 72 42 X 12 48 12 42 X 18 48 18 42 X 36 48 36 48 X 12 48 12 48 X 18 48 18 48 X 24 48 24 48 X 30 48 30 48 X 36 48 36 48 X 42 48 42 48 X 48 48 48 48 X 60 48 60 48 X 72 48 96	36 X 12 36 12 3 36 X 30 36 30 3 36 X 48 36 48 9 36 X 60 36 60 12 36 X 72 36 72 6 42 X 12 48 12 3 42 X 18 48 18 3 42 X 24 48 24 6 42 X 36 48 36 6 48 X 12 48 12 3 48 X 18 48 18 3 48 X 24 48 24 6 48 X 30 48 36 6 48 X 36 48 36 6 48 X 42 48 42 6 48 X 48 48 48 9 48 X 60 48 60 12 48 X 72 48 72 6 48 X 96 48 96 12	36 X 12 36 12 3 6 36 X 30 36 30 3 24 36 X 48 36 48 9 30 36 X 60 36 60 12 36 36 X 72 36 72 6 60 42 X 12 48 12 3 6 42 X 18 48 18 3 12 42 X 24 48 24 6 12 42 X 36 48 36 6 24 48 X 12 48 12 3 6 48 X 18 48 18 3 12 48 X 24 48 12 3 6 48 X 30 48 30 6 18 48 X 36 48 36 6 24 48 X 42 48 42 6 30 48 X 48 48 48 9 30 48 X 48 48 48 9 30 48 X 72 48 72 6 60	36 X 12 36 12 3 6 3 36 X 30 36 30 3 24 3 36 X 48 36 48 9 30 6 36 X 60 36 60 12 36 6 36 X 72 36 72 6 60 6 42 X 12 48 12 3 6 6 42 X 18 48 18 3 12 6 42 X 24 48 24 6 12 6 42 X 36 48 36 6 24 6 48 X 12 48 12 3 6 9 48 X 18 48 18 3 12 9 48 X 24 48 24 6 12 9 48 X 30 48 30 6 18 9 48 X 36 48 36 6 24 9 48 X 42 48 42 6 30 9 48 X 48 48 48 9 30 9 48 X 60 48 60 12 36 9 48 X 96 48 96 12 72 9	36 X 12 36 12 3 6 3 30 36 X 30 36 30 3 24 3 30 36 X 48 36 48 9 30 6 24 36 X 60 36 60 12 36 6 24 36 X 72 36 60 60 6 24 42 X 12 48 12 3 6 6 30 42 X 18 48 18 3 12 6 30 42 X 24 48 24 6 12 6 30 42 X 36 48 36 6 24 6 30 48 X 12 48 12 3 6 9 30 48 X 12 48 12 3 6 9 30 48 X 30 48 18 3 12 9 30 48 X 36 48 36 6 24 9 30 48 X 42 48 42 6 30 9 30 48 X 48 48 48 9 30 9 30 48 X 60 48 60 12 36 9 <	36 X 12 36 12 3 6 3 30 1½ 36 X 30 36 30 3 24 3 30 2¼ 36 X 48 36 48 9 30 6 24 0 36 X 60 36 60 12 36 6 24 0 36 X 72 36 72 6 60 6 24 0 42 X 12 48 12 3 6 6 30 1½ 42 X 18 48 18 3 12 6 30 1½ 42 X 24 48 24 6 12 6 30 1½ 48 X 12 48 36 6 24 6 30 0 48 X 12 48 12 3 6 9 30 1½ 48 X 18 48 12 3 6 9 30 1½ 48 X 24 48 12 3 6 9 30 1½ 48 X 30 48 36 6 12 9 30 0 48 X 36 48 36 6 24 9 30 0	36 X 12 36 12 3 6 3 30 1½ 0.080 36 X 30 36 30 3 24 3 30 2¼ 0.080 36 X 48 36 48 9 30 6 24 0 0.100 36 X 60 36 60 12 36 6 24 0 0.100 36 X 72 36 72 6 60 6 24 0 0.100 42 X 12 48 12 3 6 6 30 1½ 0.080 42 X 18 48 18 3 12 6 30 1½ 0.080 42 X 24 48 24 6 12 6 30 1½ 0.080 42 X 36 48 36 6 24 6 30 0 0.100 48 X 12 48 12 3 6 9 30 1½ 0.080 48 X 18 48 18 3 12 9 30 1½ 0.080 48 X 24 48 24 6 12 9 30 1½ 0.080 48 X 36 48 36 6<

SIGN SIZE	Α	В	С	D	Е	F	G	Т	AREA
60 X 18	60	18	3	12	12	36	0	0.100	7.50
60 X 24	60	24	6	12	12	36	0	0.100	10.00
60 X 30	60	30	6	18	12	36	0	0.100	12.50
60 X 36	60	36	6	24	12	36	0	0.100	15.00
60 X 42	60	42	6	30	12	36	0	0.100	17.50
60 X 48	60	48	9	30	12	36	0	0.100	20.00
72 X 12	72	12	3	6	15	42	0	0.100	6.00
72 X 18	72	18	3	12	15	42	0	0.100	9.00
72 X 24	72	24	6	12	15	42	0	0.100	12.00
72 X 30	72	30	6	18	15	36	0	0.100	15.00
72 X 36	72	36	6	24	15	42	0	0.100	18.00
72 X 42	72	42	6	30	15	42	0	0.100	21.00
72 X 48	72	48	9	30	15	42	0	0.100	24.00
84 X 12	84	18	3	6	18	48	0	0.100	7.00
84 X 18	84	18	3	12	18	48	0	0.100	10.50
84 X 24	84	24	6	12	18	48	0	0.100	14.00
84 X 30	84	30	6	18	18	48	0	0.100	17.50
84 X 36	84	36	6	24	18	48	0	0.100	21.00
84 X 42	84	42	6	30	18	48	0	0.100	24.50
84 X 48	84	48	9	30	18	48	0	0.100	28.00

NOTE: All holes are $\frac{3}{8}$ " square, unless otherwise noted.

The dimension "T" is the thickness of the aluminum blank.

- 1 Holes shall be $\frac{5}{16}$ " diameter.
- 2 Dimension "D" requires a center hole.
- 3 Additional hole 12" below top hole.

All dimensions are in inches.

1	10/01/19	Update sign blank details and dimensions	D.D.G.	E.W.N.					
NO.	DATE	REVISIONS	BY	APP'D					
	KANSAS DEPARTMENT OF TRANSPORTATION								

SIGN BLANK DETAILS FOR FLAT SHEET SIGNS

L/L So/1/L Graphics Certifie TE506 FHWA APPROVAL

DESIGNED

D.D.G. DETAILED

DESIGN CK.

S.A.B. DETAIL CK.


D.D.G. QUANTITIES


DESIGN CK.

D.D.G. QUAN. CK.

KDOT Graphics Certified 12-17-2019

Sh. No.

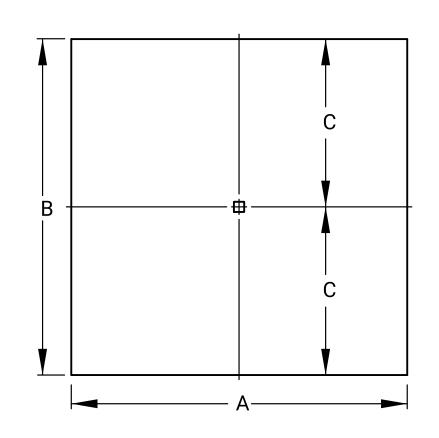

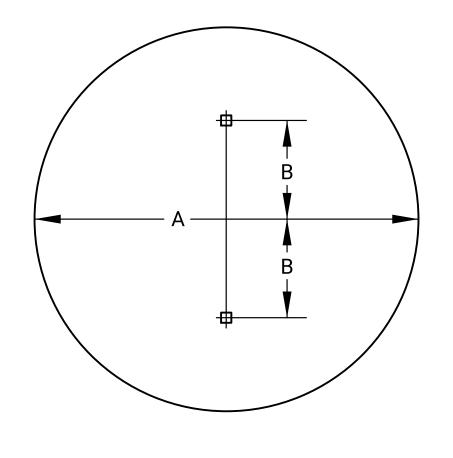

C W	C -	F	F
<u> </u>		D -	F

	G ——
G	H
	H
	H C C
	F — E — A

SIGN SIZE	Α	В	С	Т	AREA
6 X 6	6	6	3	0.063	0.25

SIGN SIZE	Α	В	Т	AREA
36 DIA	36	12	0.080	7.07

SIZE

24 X 24

36 X 36

30 X 24

45 X 36

30


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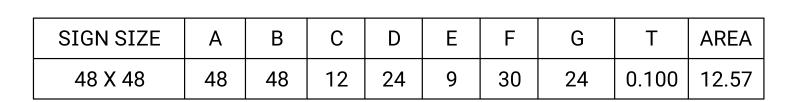
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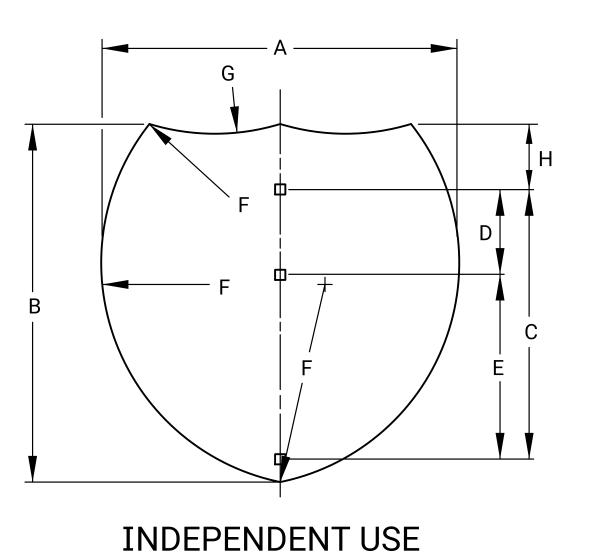
12

SIGN SIZE	А	В	С	D	Е	F	Т	AREA
30 X 30	30	30	15	3	24	1 %	0.080	4.69
36 X 36	36	36	18	6	24	2 1/4	0.080	6.75

SIGN SIZE	А	В	С	D	Е	F	G	Н	Т	AREA
48 X 48	48	48	3	24	9	30	24	3	0.100	12.00





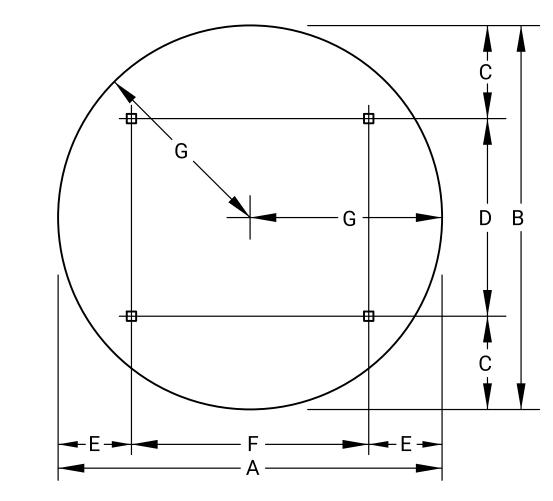

DIMENSIONS T AREA G 0.080 3.20 18 | 22 ½ | 22 ½ | 0.080 7.20 30

25 ½

36

0.080 3.99

0.100 8.99

NOTE: All holes are $\frac{3}{8}$ " square, unless otherwise noted. Dimension "T" is the thickness of the aluminum blank.

All c	limensior	ns are i	n inches.	

NO.	DATE	REVISIONS	BY	APP'D
NO	10/01/19	Update sign blank details and dimensions	D.D.G.	E

SIGN BLANK DETAILS FOR FLAT SHEET SIGNS

Craphics Certi
 FHWA APPROVAL
 10/01/2019
 APP'D
 Steven A. Buckley

 DESIGNED
 D.D.G.
 DETAILED
 A.A.D.
 QUANTITIES
 PURITY

 DESIGN CK.
 S.A.B.
 DETAIL CK.
 D.D.G.
 QUAN. CK.
 PURITY

KDOT Graphics Certified 12-17-2019

Sh. No.

DETAILED SPECIFICATIONS FOR FLAT SHEET SIGNS AND OVERLAY PANELS

All new flat sheet sign blanks shall be of the fabrication and thickness shown on the flat sheet blank detail sheets, unless other details are shown in the plans.

Flat sheet blanks shall be used for signs that are less than or equal to 7'-0" in length and/or less than or equal to 4'-0" in height, unless other details are shown in the plans. Flat sheet blanks shall also be used for signs that are 4'-0" in length and less than or equal to 8'-0" in height, unless other details are shown in the plans.

The design details for signs (color, letter height, and letter series) shall be as shown in the FHWA Standard Highway Signs and Markings book (2004 edition and supplements), unless other details are shown in the plans.

All sign faces shall be covered with Type IV high intensity retroreflective sheeting, unless otherwise noted in the plans.

The sheeting used for the direct applied legend and borders shall be Type IV high intensity retroreflective sheeting, unless otherwise noted in the plans.

The school warning signs, the "SCHOOL" portion of the S5-1 sign, S4-3p plaque, and any supplemental plaques used with these warning signs shall have a fluorescent yellow-green background, unless otherwise noted in the plans.

The type of adhesive used for retroreflective sheeting or lettering film shall be heat activated or pressure sensitive.

DETAILED SPECIFICATIONS FOR REINFORCED PANEL SIGNS

All new reinforced sign panels shall be of the fabrication and thickness shown on the reinforced panel detail sheets. If extrusheet fabricated sign panels are used, they shall be of the length, width and in the position shown. If extrusheet fabricated panel dimensions are not shown, a line of legend should be placed entirely on one panel. If extruded fabricated sign panels are used, either 1'-0" or 6" panels shall be used. The 6" panels shall be used only at the top or bottom of signs.

Reinforced panels shall be used for signs that are greater than 7'-0" in length or greater than 4'-0" in height, unless other details are shown in the plans.

All sign faces shall be covered with Type IV high intensity retroreflective sheeting, unless otherwise noted in the plans.

The sheeting used for the direct applied legend and borders shall be Type IV high intensity retroreflective sheeting, unless otherwise noted in the plans.

The type of adhesive used for retroreflective sheeting or lettering film shall be heat activated or pressure sensitive.

Letters and numbers on reinforced panel signs are modified Series "E" unless otherwise shown.


Spacing table dimensions are in inches.

2	10/01/19	Changed notes	D.D.G.	E.W.N.
1	7/23/10	Changed Notes and Sheeting Type	D.D.G.	D.B.
NO.	DATE	REVISIONS	BY	APP'D

KANSAS DEPARTMENT OF TRANSPORTATION DETAILS SPECIFICATIONS FOR REINFORCED SIGN PANELS AND FLAT SHEET SIGNS

10/01/2019 APP'D Steven A. Buckley
K.D.S. QUANTITIES
D.D.G. QUAN. CK. D.D.G. DETAILED S.A.B. DETAIL CK.


7/01/03 🖔

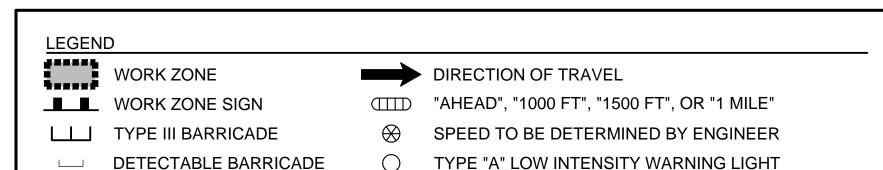


ARROW BOARD

CHANNELIZING DEVICES

PEDESTRIAN CHANNELIZER

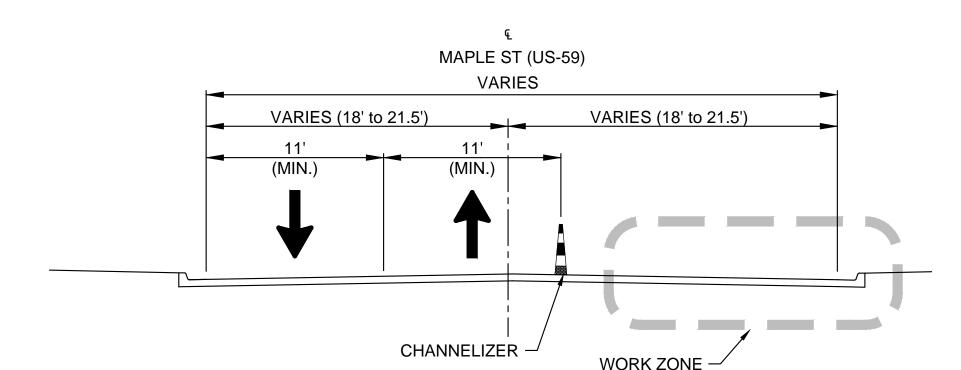

PHASE 1 - TYPICAL SECTION MAPLE ST (US-59)
BEGIN TO END

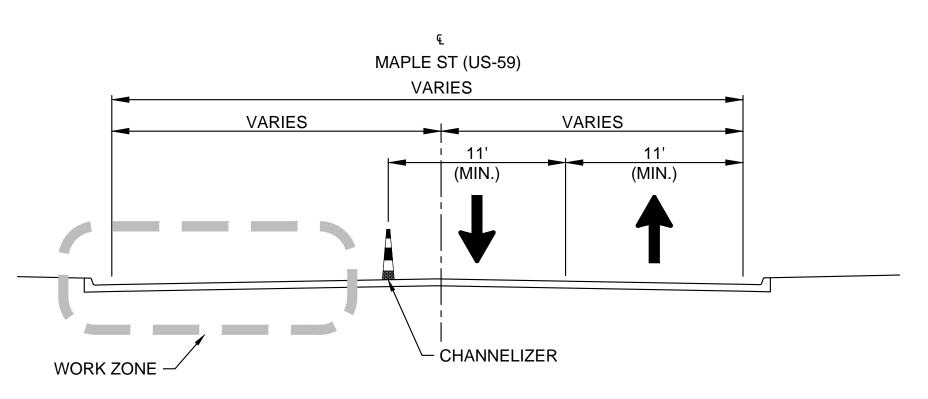

PHASE 2 - TYPICAL SECTION MAPLE ST (US-59)
BEGIN TO END

PROJECT PHASING NOTES

THE CONTRACTOR SHALL NOT MILL THE EXISTING ASPHALT UNTIL THE PROPOSED HMA SURFACING IS READY TO BE PLACED. TRAFFIC CARRIED THROUGH CONSTRUCTION ON MILLED PAVEMENT SHOULD BE HELD TO A MINIMUM SO AS TO MINIMIZE TRAFFIC DAMAGE TO EXISTING PAVEMENT.

PHASE 1 GENERALLY CONSISTS OF WORK ON THE EAST SIDE OF MAPLE STREET (US-59), MORE PARTICULARLY THE STORM SEWER, CURB AND GUTTER, INTERSECTION/ENTRANCE RECONSTRUCTION, AND SIDEWALK IMPROVEMENTS FROM 4TH AVENUE TO REDBUD AVENUE.


- THE CONTRACTOR SHALL CARRY SOUTHBOUND MAPLE STREET (US-59) THROUGH CONSTRUCTION IN THE EXISTING SOUTHBOUND THRU LANE. NARROWING OF THE SOUTHBOUND LANE TO 11 FT. (MINIMUM) WILL BE ALLOWED TO FACILITATE THE SHIFT OF NORTHBOUND TRAFFIC.
- THE CONTRACTOR SHALL USE THESE TRAFFIC CONTROL PLANS AND THE KDOT STANDARD DRAWING TE724 TO SHIFT NORTHBOUND MAPLE STREET (US-59) TO THE CENTER TWO-WAY LEFT-TURN LANE SOUTH OF 4TH AVENUE. CARRY NORTHBOUND TRAFFIC THROUGH CONSTRUCTION IN THE CENTER LANE. SHIFT NORTHBOUND TRAFFIC BACK TO THE EXISTING NORTHBOUND THRU LANE IMMEDIATELY NORTH OF REDBUD AVENUE.
- CROSS ROAD STORM SEWER CONSTRUCTION AT 3RD AVENUE AND SHALL BE PHASED. THE CONTRACTOR HAS THE OPTION TO FLAG TRAFFIC USING KDOT STANDARD DRAWING TE730 TO COMPLETE THE CROSS ROAD STORM SEWER WORK

PHASE 2 GENERALLY CONSISTS OF WORK ON THE WEST SIDE OF MAPLE STREET (US-59), MORE PARTICULARLY THE STORM SEWER, CURB AND GUTTER, INTERSECTION/ENTRANCE RECONSTRUCTION, AND SIDEWALK IMPROVEMENTS FROM 4TH AVENUE TO REDBUD AVENUE. THE CONTRACTOR MAY BEGIN ASPHALT MILLING AND SURFACING IN THE WORK ZONE OF PHASE 2 PRIOR TO SWITCHING TO PHASE 3.

- THE CONTRACTOR SHALL USE THESE TRAFFIC CONTROL PLANS AND THE KDOT STANDARD DRAWING TE724 TO SHIFT SOUTHBOUND MAPLE STREET (US-59) TO THE CENTER TWO-WAY LEFT-TURN LANE IMMEDIATELY NORTH OF 4TH AVENUE. CARRY SOUTHBOUND TRAFFIC THROUGH CONSTRUCTION IN THE CENTER LANE. SHIFT SOUTHBOUND TRAFFIC BACK TO THE EXISTING SOUTHBOUND THRU LANE IMMEDIATELY SOUTH OF 4TH AVENUE.
- THE CONTRACTOR SHALL CARRY NORTHBOUND MAPLE STREET (US-59) THROUGH CONSTRUCTION IN THE EXISTING NORTHBOUND THRU LANE. NARROWING OF THE NORTHBOUND LANE TO 11 FT. (MINIMUM) WILL BE ALLOWED TO FACILITATE THE SHIFT OF SOUTHBOUND TRAFFIC.

PHASE 3 GENERALLY CONSISTS OF ASPHALT MILLING AND SURFACING ON THE REMAINDER OF THE PROJECT. IT IS THE INTENT OF THESE PLANS FOR THE FINAL HMA SURFACE TO BE PLACED AFTER COMPLETION OF ALL STORM SEWER, CURB/GUTTER, AND INTERSECTION/ENTRANCE CONSTRUCTION. THE CONTRACTOR SHALL USE KDOT STANDARD DRAWING TE724 FOR ANY LANE SHIFTS AND TE730 TO CARRY 2-WAY TRAFFIC IN ONE LANE WITH A PILOT CAR FOR MILLING, SURFACING, AND PAVEMENT MARKING STRIPING.

PHASE 4 GENERALLY CONSISTS OF CONSTRUCTING THE CONCRETE MANHOLE COLLARS ON THE SANITARY SEWER MANHOLES IN THE CENTER OF MAPLE STREET (US-59). CONTRACTOR SHALL CLOSE THE CENTER TURN LANE AT THE WORK ZONE LOCATION. USE STEEL STREET PLATES AS NECESSARY TO PROTECT THE WORK AND MAINTAIN TRAFFIC FLOW.

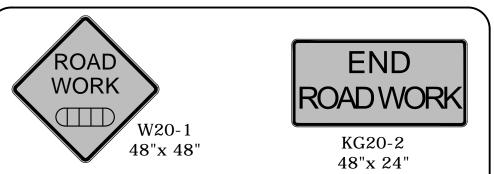

BASIC TRAFFIC CONTROL SIGNING

ALL PUBLIC STREETS THAT REMAIN OPEN TO THE TRAVELING PUBLIC DURING CONSTRUCTION SHALL HAVE, AT A MINIMUM, A "ROAD WORK AHEAD" SIGN IN ADVANCE OF THE WORK ZONE AND AN "END ROAD WORK" SIGN 500 FEET DOWNSTREAM OF THE LAST TEMPORARY TRAFFIC CONTROL DEVICE.

WHEN CONSTRUCTION PHASING REQUIRES TRAFFIC ON AN EXISTING STOP CONTROLLED SIDE STREET TO CROSS THE WORK ZONE, A TEMPORARY STOP SIGN SHALL BE INSTALLED PER FIGURE 2 ON TE705.

THESE SIGNS MAY NOT BE SHOWN ON THE WORK ZONE TRAFFIC CONTROL PLANS, BUT NEVERTHELESS SHALL BE REQUIRED.

STATE	PROJECT NO.	YEAR	SHEET NO.	TOTAL SHEETS
KANSAS	59-2 KA-5422-01	2022	53	69



TRAFFIC CONTROL GENERAL NOTES

- 1. THESE TRAFFIC CONTROL PLANS ADDRESS SOME OF THE MAJOR ITEMS OF WORK, BUT NOT ALL ITEMS OF THE CONTRACTOR'S WORK, AND ARE INTENDED TO PROVIDE A GENERAL OVERVIEW OF TRAFFIC HANDLING. TRAFFIC CONTROL REQUIREMENTS SHOWN ON THESE PLANS DO NOT ATTEMPT TO ADDRESS IN DEPTH THE VARIETY OF SITUATIONS THAT MAY OCCUR ONCE CONSTRUCTION HAS STARTED. IN NO WAY DO THE REQUIREMENTS SHOWN ON THESE PLANS RELIEVE THE CONTRACTOR OF THEIR RESPONSIBILITY TO SELECT PROPER TRAFFIC CONTROL DEVICES AND IMPLEMENTATION PROCEDURES TO ACCOMMODATE THE SAFETY OF MOTORISTS, BICYCLISTS, PEDESTRIANS, WORKERS, ETC. AT ALL TIMES.
- 2. PRIOR TO CONSTRUCTION, THE CONTRACTOR SHALL SUBMIT A DETAILED SEQUENCING PLAN TO THE ENGINEER FOR REVIEW AND APPROVAL.
- 3. THE CONTRACTOR HAS THE OPTION OF DEVELOPING THEIR OWN TRAFFIC CONTROL PLAN AND SUBMITTING IT TO THE ENGINEER FOR REVIEW AND APPROVAL (AT LEAST TWO WEEKS PRIOR TO PROPOSED IMPLEMENTATION).
- 4. ALL TRAFFIC CONTROL DEVICES (SIGNS, BARRICADES, DRUMS, CHANNELIZERS, ETC.) SHALL BE PROVIDED, ERECTED AND MAINTAINED BY THE CONTRACTOR AND SHALL CONFORM TO THE MOST RECENT MANUAL ON UNIFORM TRAFFIC CONTROL DEVICES (MUTCD), THE KDOT TE STANDARD DRAWINGS, AND THE AASHTO ROADSIDE DESIGN GUIDE, WHICHEVER IS MOST STRINGENT. THE CONTRACTOR SHALL BE RESPONSIBLE FOR MAINTAINING IN POSITION, CLEANING, AND REPLACING DAMAGED TRAFFIC CONTROL DEVICES.
- 5. THE ENGINEER SHALL DETERMINE THE FINAL LOCATION OF ALL TRAFFIC CONTROL DEVICES.
- 6. THE CONTRACTOR SHALL PROVIDE WRITTEN NOTICES AS DIRECTED IN THE GENERAL NOTES OF THESE CONSTRUCTION PLANS AND THE SPECIFICATIONS. THE CONTRACTOR SHALL SEQUENCE DRIVEWAY CONSTRUCTION AND COORDINATE WITH THE ADJACENT PROPERTY OWNERS SO AS TO MINIMIZE THE DURATION OF TIME PROPERTY OWNERS DO NOT HAVE ACCESS TO THEIR DRIVEWAY.
- 7. USE KDOT STANDARD DRAWING TE720 WHEN WORK IS LOCATED BEHIND THE CURB AND/OR ADJACENT TO THE STREET AND DOES NOT REQUIRE LANE CLOSURE.
- 8. A MINIMUM OF ONE-LANE SHALL REMAIN OPEN AT ALL TIMES TO BOTH DIRECTIONS OF TRAVEL ON MAPLE STREET (US-59).
- 9. MAPLE STREET/4TH AVE TRAFFIC SIGNAL OPERATIONS: THE CONTRACTOR SHALL COORDINATE WITH THE CITY OF GARNETT FOR ANY SIGNAL TIMING AND SIGNAL PHASING ADJUSTMENTS TO THE EXISTING TRAFFIC SIGNAL SYSTEM. CHANGES TO THE SIGNAL PHASING AND/OR TIMING SHALL ONLY BE PERFORMED BY CITY OF GARNETT STAFF.
- 9.1. THE EXISTING SIGNAL SYSTEM SHOULD BE USED TO CARRY TRAFFIC THROUGH THE INTERSECTION DURING CONSTRUCTION.
- 9.2. SIGNAL PHASING FOR THE EAST AND WEST TRAFFIC MOVEMENTS SHOULD REMAIN IN THE CURRENT PHASING PATTERN.
- 9.3. IF NECESSARY TO ACCOMMODATE TRAFFIC PATTERNS DURING CONSTRUCTION, SIGNAL PHASING FOR THE NORTHBOUND AND SOUTHBOUND MOVEMENTS MAY BE MODIFIED TO OPERATE IN A SPLIT-PHASE MODE SUCH THAT THE NORTHBOUND AND SOUTHBOUND MOVEMENTS ARE NOT ALLOWED TO TIME GREEN CONCURRENTLY.
- 10. INTERSECTIONS AND DRIVEWAYS: SEE KDOT STANDARD TE705 FOR MAINTAINING ACCESS TO ENTRANCES/INTERSECTIONS DURING CONSTRUCTION. EVERY EFFORT SHALL BE MADE TO KEEP ENTRANCES AND SIDE STREETS OPEN TO THE EXTENT FEASIBLE DURING CONSTRUCTION. SEQUENCE INTERSECTION RECONSTRUCTION SUCH THAT A ONE-BLOCK CLOSURE OF THE SIDE STREETS IS ALTERNATED TO EVERY-OTHER INTERSECTING STREET. SEQUENCE WORK AT PROPERTIES WITH MULTIPLE ENTRANCES TO MAINTAIN AT LEAST ONE OPEN ENTRANCE AT ALL TIMES. ENTRANCES TO A PROPERTY THAT HAVE ONLY ONE ACCESS SHALL BE CONSTRUCTED ONE-HALF AT A TIME. THE CONTRACTOR SHALL COORDINATE WITH PROPERTY OWNERS WHEN CONSTRUCTION ACTIVITIES LIMIT ACCESS TO THEIR PROPERTY.

11. PEDESTRIAN TRAFFIC CONTROL:

- 11.1. USE KDOT STANDARD DRAWING TE704 TO CLOSE THE NORTH CROSSWALK AT MAPLE/4TH AVE. PROVIDE PEDESTRIAN BARRICADES AND SIGNS TO DIRECT TRAFFIC TO USE THE SOUTH CROSSWALK TO CROSS MAPLE STREET (US-59).
- 11.2. DUE TO A LACK OF EXISTING SIDEWALK CONTINUITY AND ALTERNATE ACCESSIBLE PEDESTRIAN ROUTES, CONTRACTOR MAY CLOSE THE EAST SIDEWALK OF MAPLE STREET (US-59) BETWEEN 4TH AVENUE AND REDBUD AVENUE, BUT THE SIDEWALK CLOSURE SHOULD BE LIMITED TO ONLY THE BLOCK(S) WHERE CONSTRUCTION WORK IS ACTIVE. EXISTING BLOCKS OF SIDEWALK NOT IMPACTED BY THE WORK AREA SHOULD REMAIN OPEN TO PEDESTRIANS TO THE EXTENT FEASIBLE.

KANSAS DEPARTMENT OF TRANSPORTATION

MAPLE STREET (US-59)
TRAFFIC CONTROL PLAN

2) Minimum Lane Width: Lane widths shall be a minimum of 11' (measured between centerlines of pavement markings) or as shown on the plans, or as directed by the engineer. A lane width less than 11' may require restricted roadway width signing.


3) Consideration should be made to separate pedestrian and, if needed, bicycle movements from both work site activity and vehicular traffic. Unless a reasonable safe route that does not involve crossing the roadway can be provided, pedestrians should be appropriately directed with advance signing that encourages them to cross to the opposite side of the roadway. In urban and suburban areas with high vehicular traffic volumes, these signs should be placed at intersections (rather than midblock locations) so that pedestrians are not confronted with midblock work sites that will induce them to attempt skirting the work site or making a midblock crossing.

4) When existing pedestrian facilities are disrupted, closed, or relocated, the temporary facilities shall be detectable and include accessibility features consistent with the features present in the existing pedestrian facility.

5) When the driving surface open to traffic is milled or is a temporary surface made of loose material, or when directed by the engineer a W8-15 (Grooved Pavement) or W8-7 (Loose Gravel) sign shall be used on mainline approaches. This sign should be placed a "C" distance after the W20-1 (Road Work Ahead) sign. A W8-15p motorcycle plaque shall be used to supplement the W8-15 or W8-7 signs. All signs shall be displayed as long as the condition is present.

6) Alternative temporary rumble strip options may be available. Please contact the Temporary Traffic Control Unit for more information at 785-296-1179 or 785-296-1183.

STATE	PROJECT NO.	YEAR	SHEET NO.	TOTAL SHEETS	
KANSAS	59-2 KA-5422-01	2022	54	69	

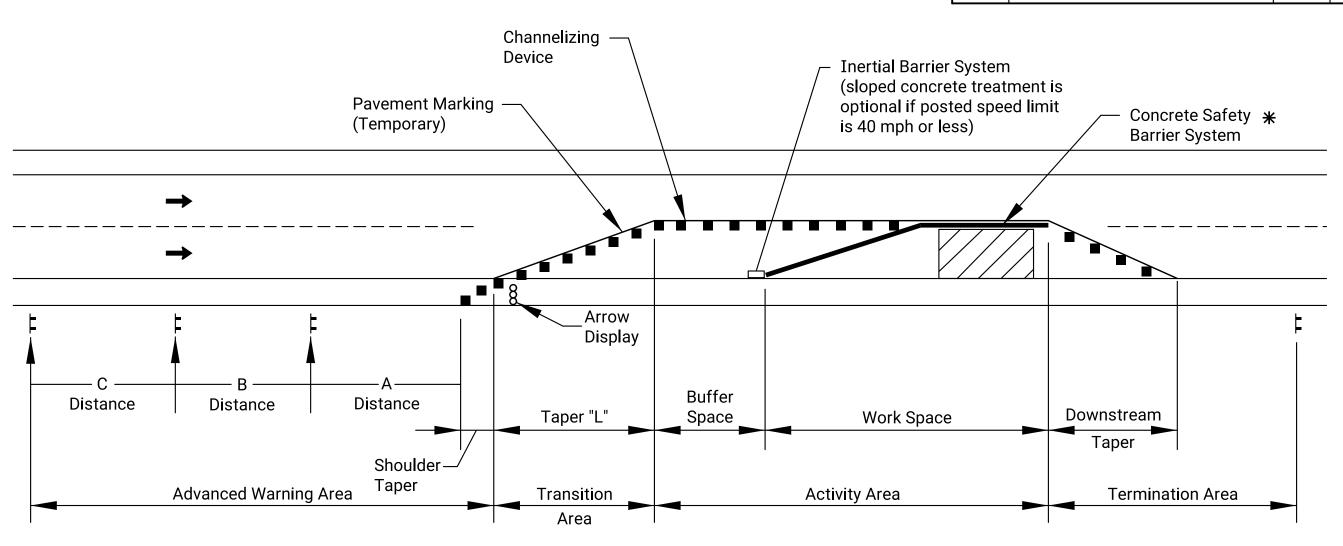

TYPICAL WORK ZONE COMPONENTS

*When concrete barrier system is used, portable channelizing devices are not needed along the tangent barrier section.

Minimum advance warning sign spacing (in feet):

SPEED (MPH) *	Α	В	С
URBAN (40 MPH OR LOWER)	100	100	100
URBAN (45 MPH OR HIGHER)	350	350	350
RURAL (55 MPH OR LOWER)	500	500	500
RURAL (60 MPH OR HIGHER)	750	750	750
EXPRESSWAY/FREEWAY	1000	1500	2640

* Posted speed prior to work starting

The minimum spacing between signs shall be no less than 100', unless directed by the engineer.

The spacing between any signs may be increased beyond the minimum values in the table above as approved by the engineer in order to maximize visibility.

Taper Formulas:

L = WS for speeds of 45 MPH or more

 $L = WS^2/60$ for speeds of 40 MPH or less

Where: L = Minimum length of taper in feet

S = Numericial value of posted speed prior to work starting in MPH

W = Width in offset feet

Shifting Taper=1/2 L Shoulder Taper=1/3 L

Channelizer Placement:

(1) The spacing between devices in transition area (taper) should not exceed a distance in feet equal to 1/2 the posted speed limit in mph prior to work starting.

(2) The spacing between devices in the advanced warning area and the activity area should not exceed a distance in feet equal to two times the posted speed limit in mph prior to work starting.

(3) Channelizing devices shall be placed for optimum visibility,

normally at right angles to the traffic flow.

(4) Place directional indicator barricades in series to direct traffic onto the new path. The arrow sign should not be visible to opposing traffic.

(5) Alternating diagonal orange and white striping must slope downward in the direction traffic is expected to pass.

Buffer Space

SPEED (MPH) *	20	25	30	35	40	45	50	55	60	65	70	75
LENGTH (ft)	115	155	200	250	305	360	425	495	570	645	730	820

* Posted speed prior to work starting

Neither work activity nor storage of equipment, vehicles, or material should occur in the buffer space. When a protection vehicle is placed in advance of the work space, only the space upstream of the vehicle constitutes the buffer space.


If temporary concrete safety barrier system is used to separate approaching traffic from the work space, the barrier system shall be considered part of the activity area. A full lane width should be available throughout the length of the buffer space. See typical work zone components above.


2	03/13/18	W8-15p usage changed to Shall	R.W.B.	E.G.K.
		1 3 3		
1	08/18/15	Channelizer spacing info	R.W.B.	K.E.
NO.	DATE	REVISIONS	BY	APP'D


TRAFFIC CONTROL GENERAL NOTES


TE700 03/13/18 APP'D Eric Kocher
R.W.B QUANTITIES
QUAN. CK. IWA APPROVAL B.A.H. DETAILED DETAIL CK. TRACED TRACE CK.


KDOT Graphics Certified 03-13-2018

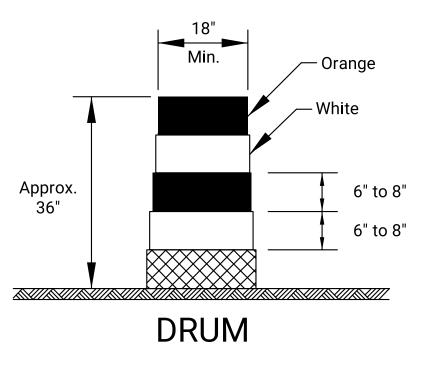


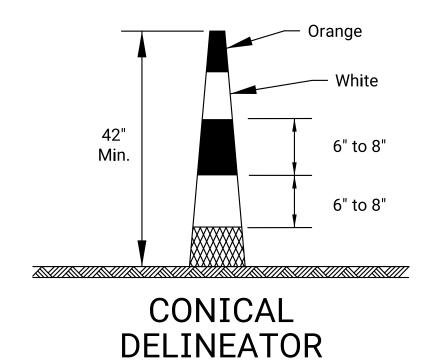


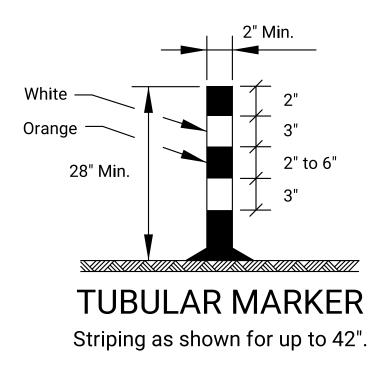

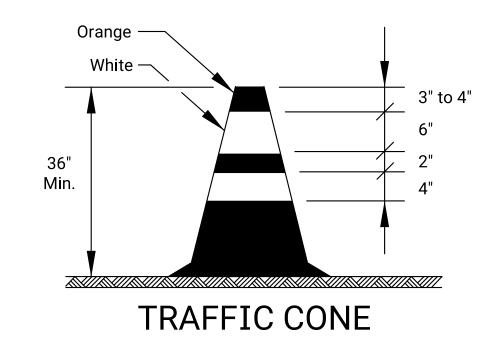


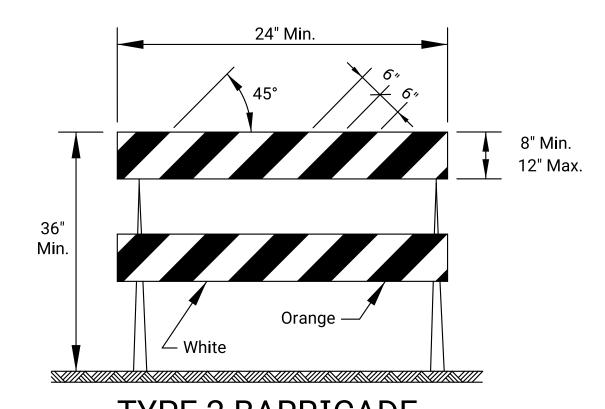

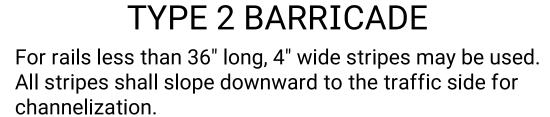

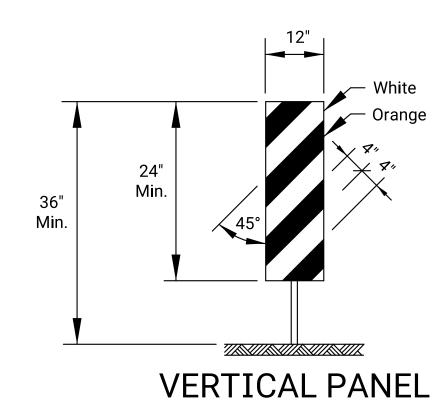


The stripes shall slope downward to the traffic side for channelization.

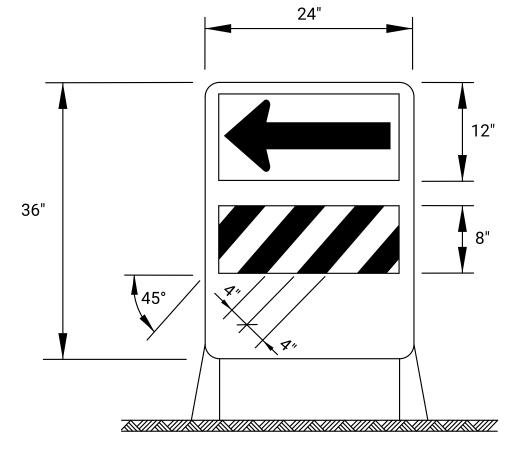


DIRECTION INDICATOR BARRICADE

The stripes shall slope downward in the direction traffic is to pass. The direction indicator barricade shall be used in series to direct the motorist into the intended lane of travel.

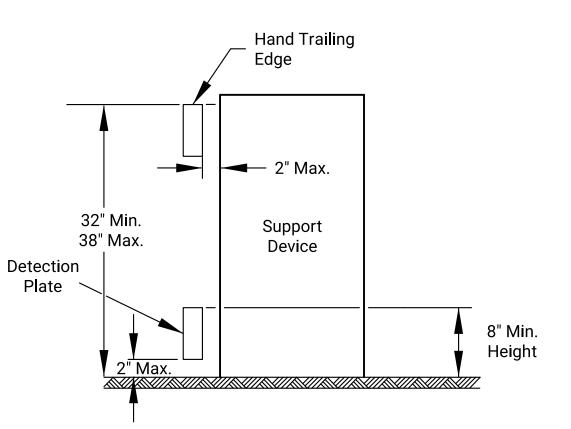


PEDESTRIAN CHANNELIZER

- 1. Support device shall not project beyond the detection plate into the pathway.
- 2. Hand trailing edges and detection plates are optional for continuous walls.
- 3. Interconnect pedestrian channelizers to prevent displacement and to provide continuous guidance through or around work.
- 4. Alternate pathways shall be firm, stable, and slip resistant. 5. Treat height differentials > 1/2" in the surfaces of alternate
- paths with a firm, stable, and slip resistant temporary ramp having a slope of 12:1 or flatter and having a width equal to the alternate path.
- 6. Use alternating orange/white on interconnected devices.

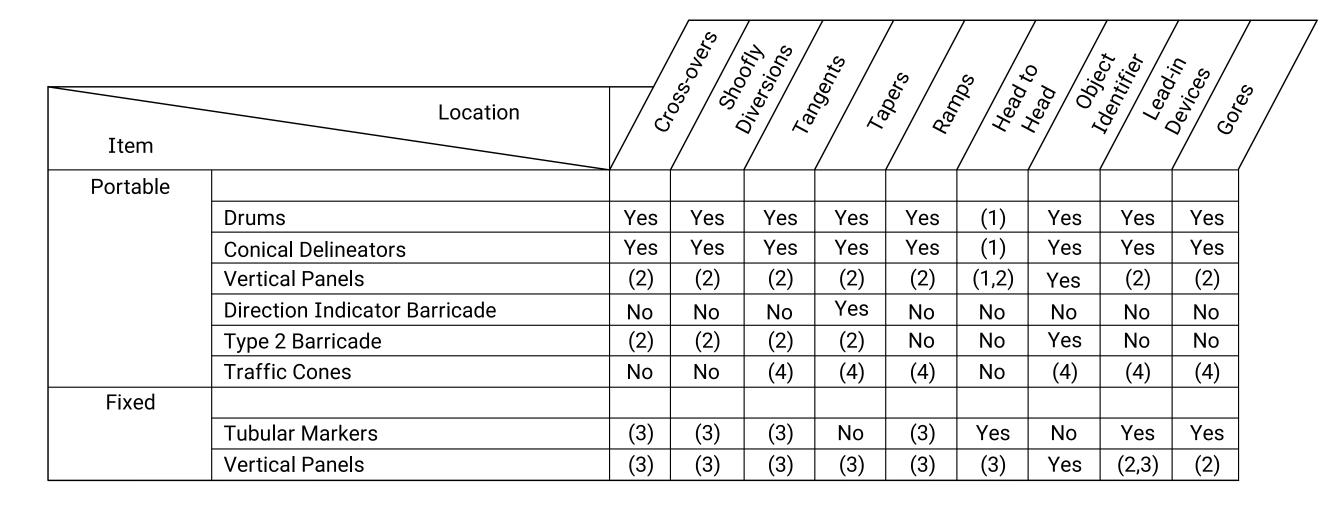



- (1) Not allowed on centerline delineation along freeways or expressways.
- (2) The stripes shall slope downward to the traffic side for channelization.
- (3) May be used upon the approval of the engineer.
- (4) Daytime operations only.

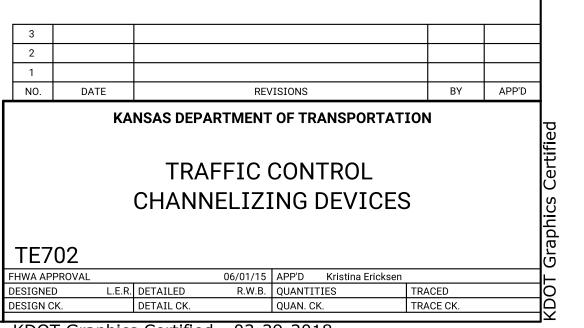



lotted:29-MAR-2018 Traffic


KDOT Graphics Certified 03-29-2018

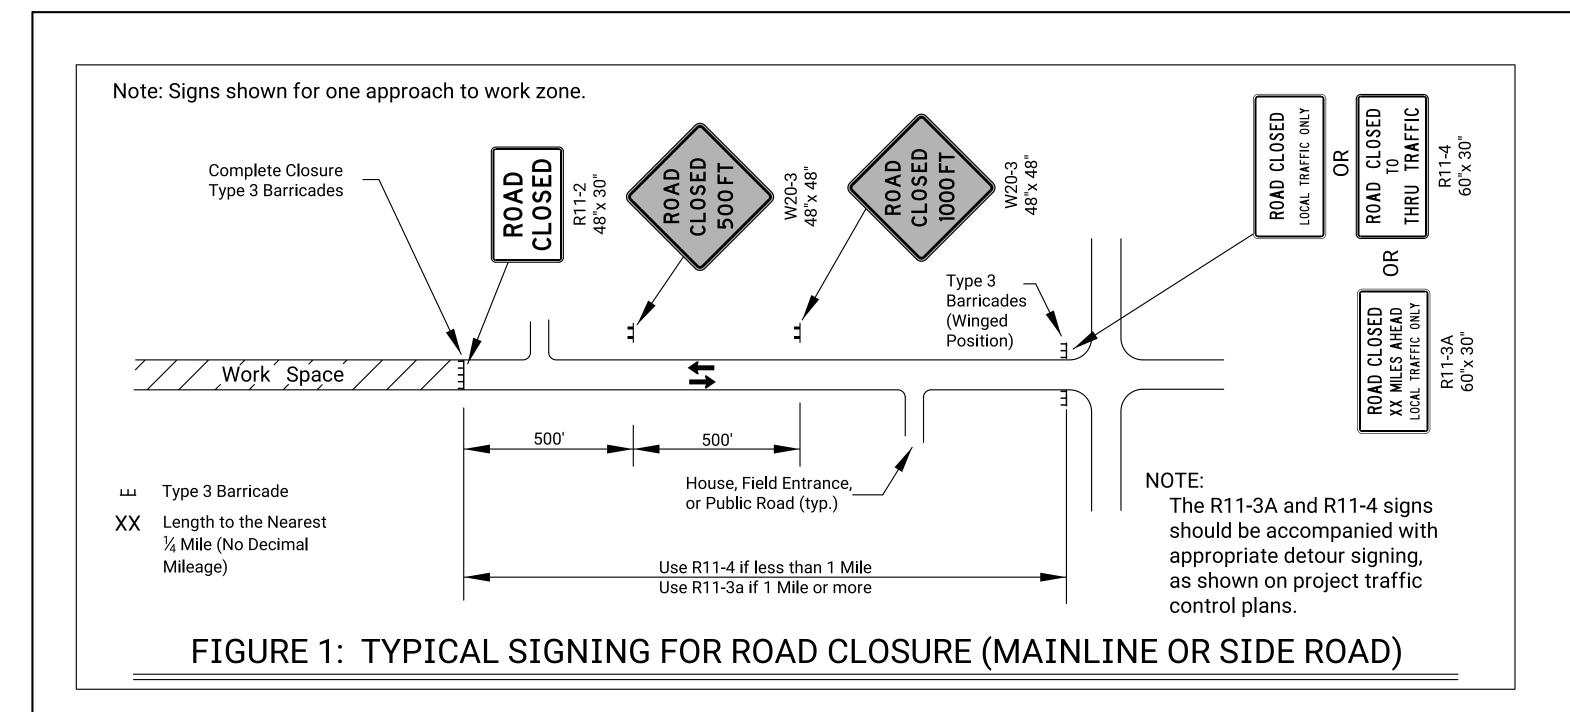

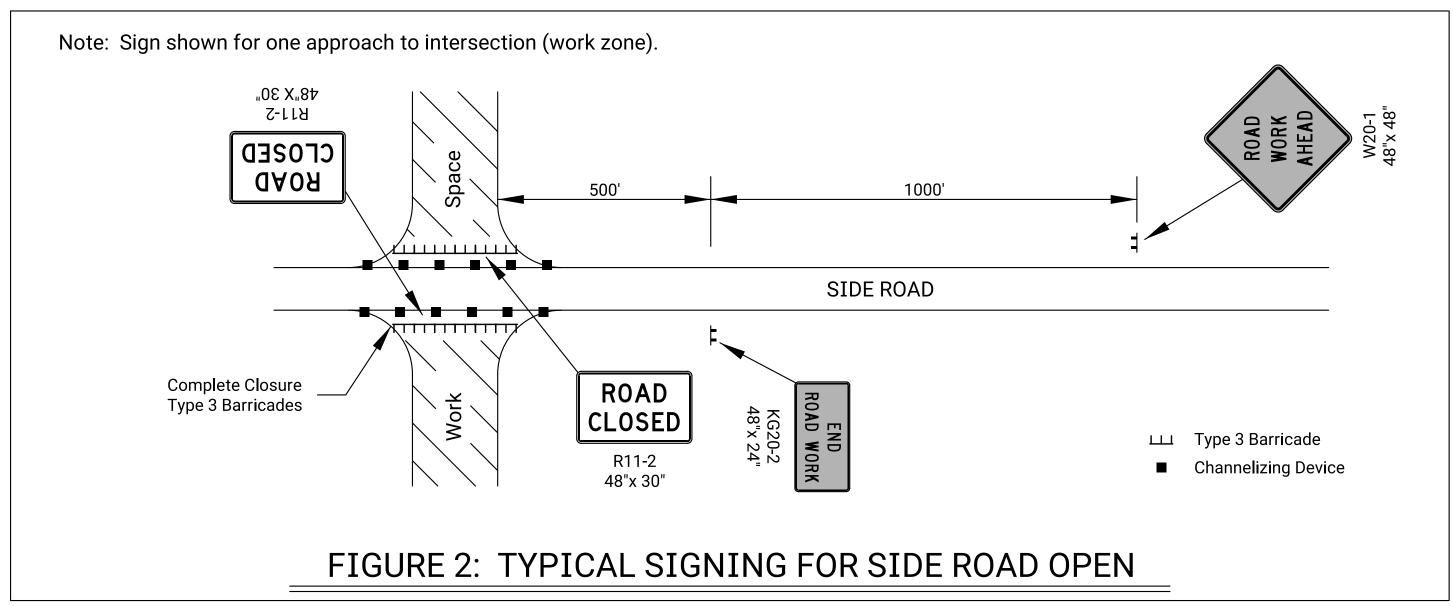


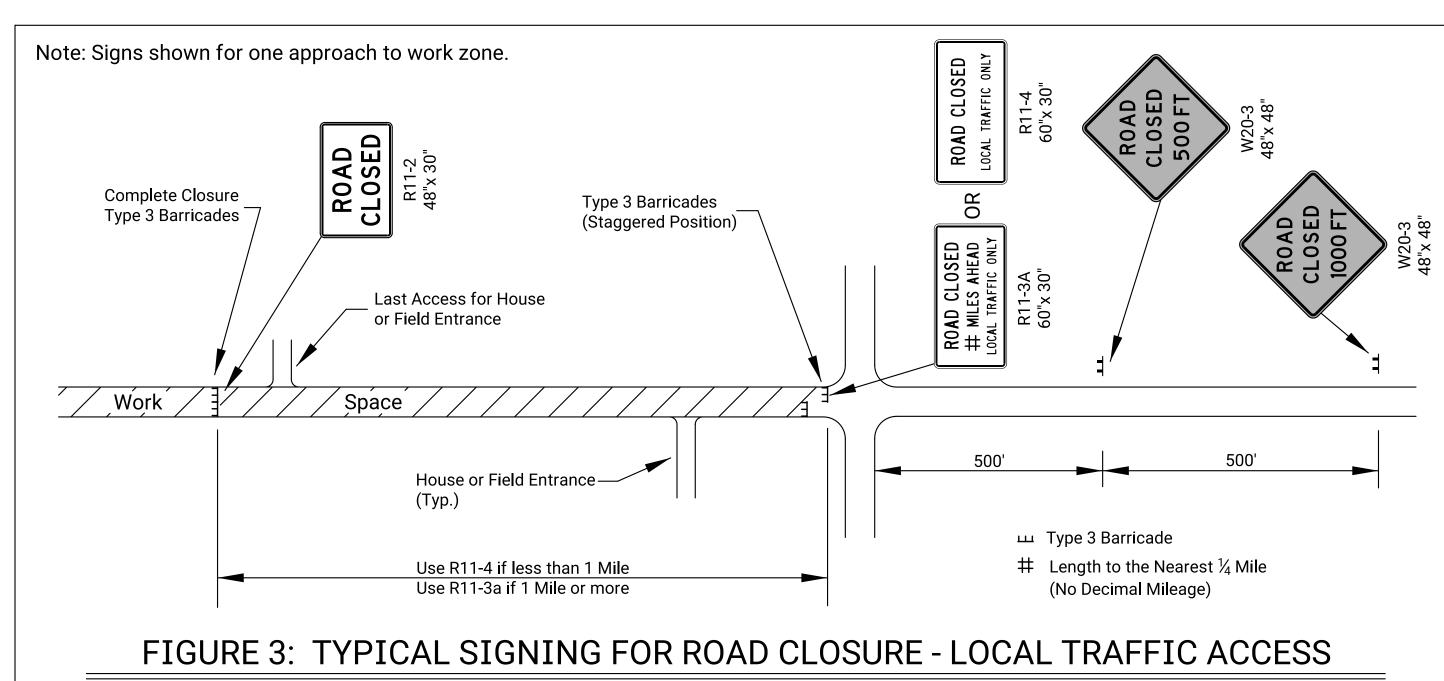

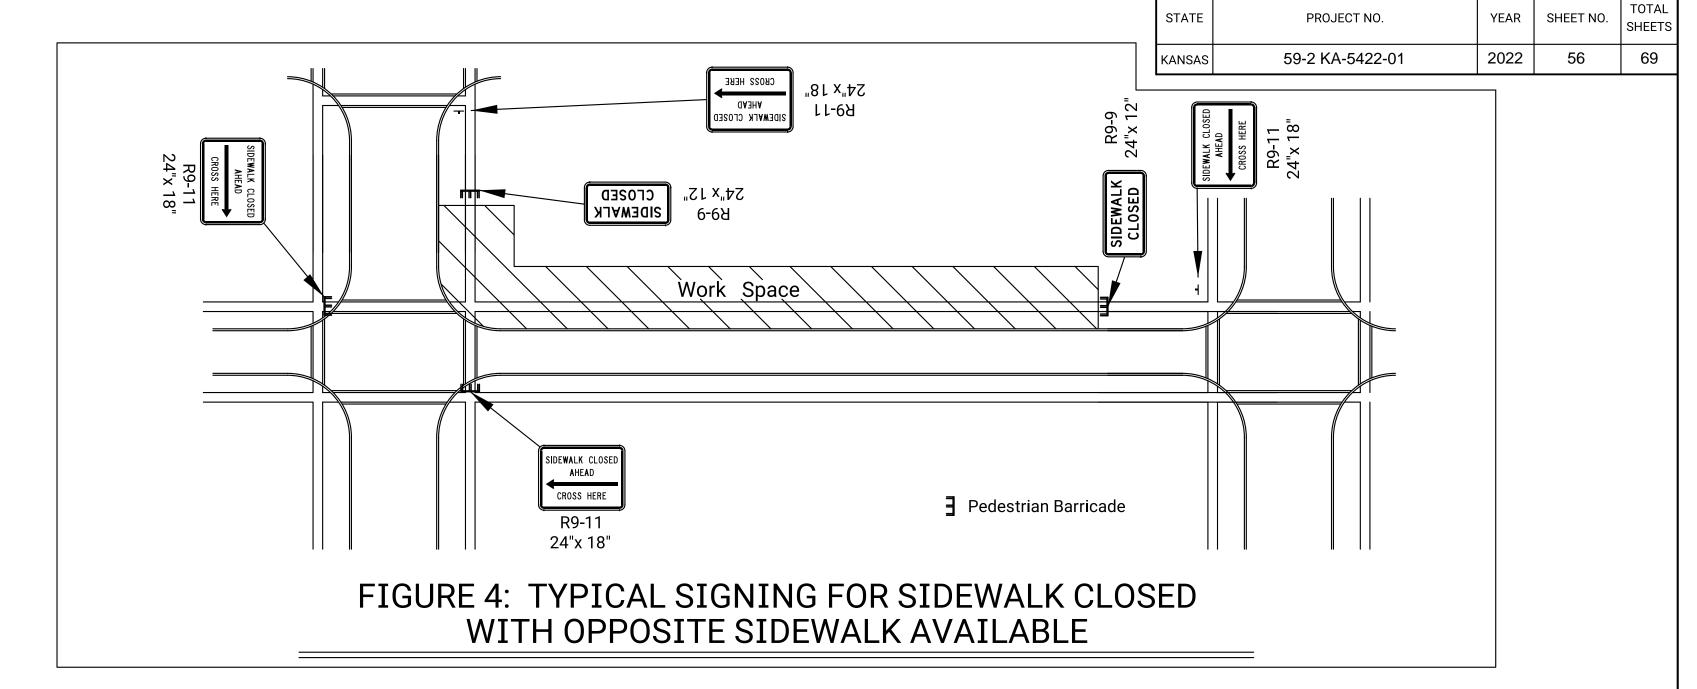

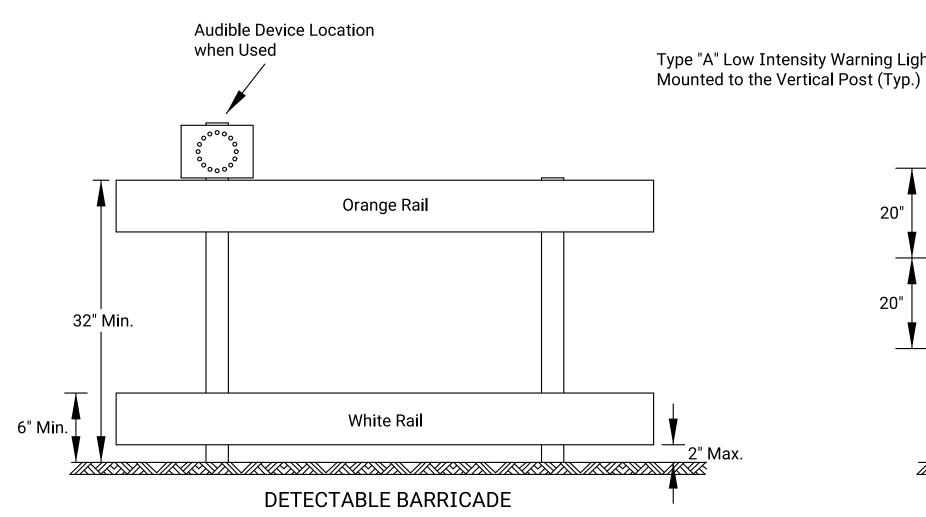

- 1. Support device shall not project beyond the detection plate into the pathway.
- 2. Barricades shall be used to close the entire width of the pathway.
- 3. Do not use warning lights on pedestrian barricades.
- 4. Do not use warning lights on audible devices.

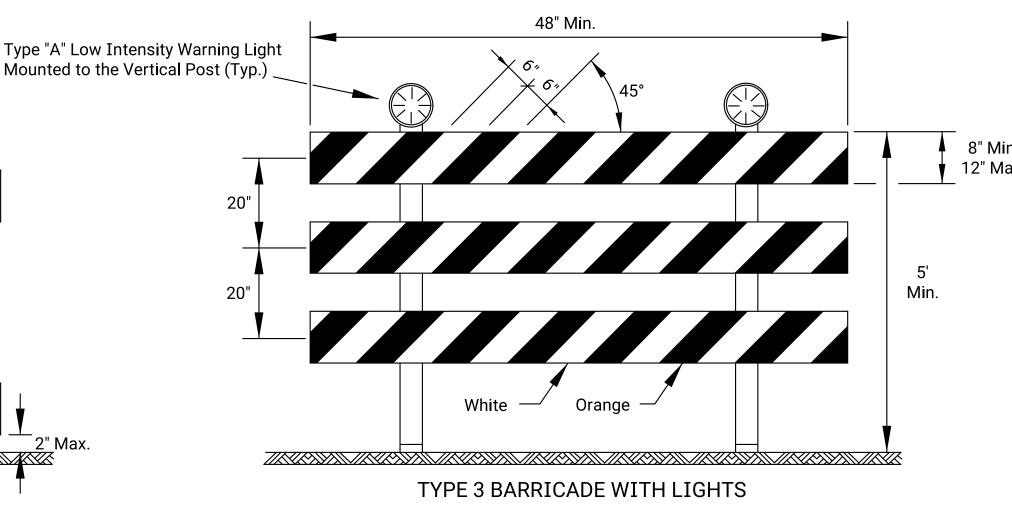

Approved signs mounted on Type 3 barricades should not cover more than 50% of the top two rails or 33% of the total area of the three rails.

When barricades are placed end-to-end or staggered, a Type "A" low intensity warning light shall be mounted to the vertical post near each outside corner of the end barricades.

ROAD CLOSED GENERAL NOTES


As shown in Figure 1, at the point where thru traffic must detour and local traffic can proceed to the location where the roadway is completely closed, the R11-3a (ROAD CLOSED # MILES AHEAD LOCAL TRAFFIC ONLY) or R11-4 (ROAD CLOSED LOCAL TRAFFIC ONLY or ROAD CLOSED TO THRU TRAFFIC) sign shall be used with Type 3 barricades (winged position), placed on the shoulders of roadway.

As shown in Figure 3, when local traffic must be allowed access into the work zone, Type 3 barricades shall be longitudinally staggered to maintain the appearance of a closed roadway. A second line of end-to-end Type 3 barricades shall be placed just beyond the last access point in the work zone, to completely close the roadway.

The R11-4 (ROAD CLOSED TO THRU TRAFFIC or ROAD CLOSED LOCAL TRAFFIC ONLY) sign shall be used when the distance to the point of complete closure of the roadway is less than 1 mile.


The R11-3a (ROAD CLOSED # MILES AHEAD LOCAL TRAFFIC ONLY) sign shall be used when the distance to the point of complete closure of the roadway is 1 mile or greater.


The words "BRIDGE OUT" (or BRIDGE CLOSED) may be substituted for the words "ROAD CLOSED" on the R11-3a or R11-4 sign where applicable.

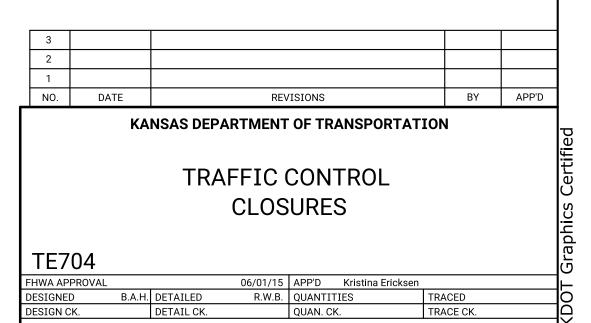



KDOT Graphics Certified 03-29-2018


Sh. No. XXX

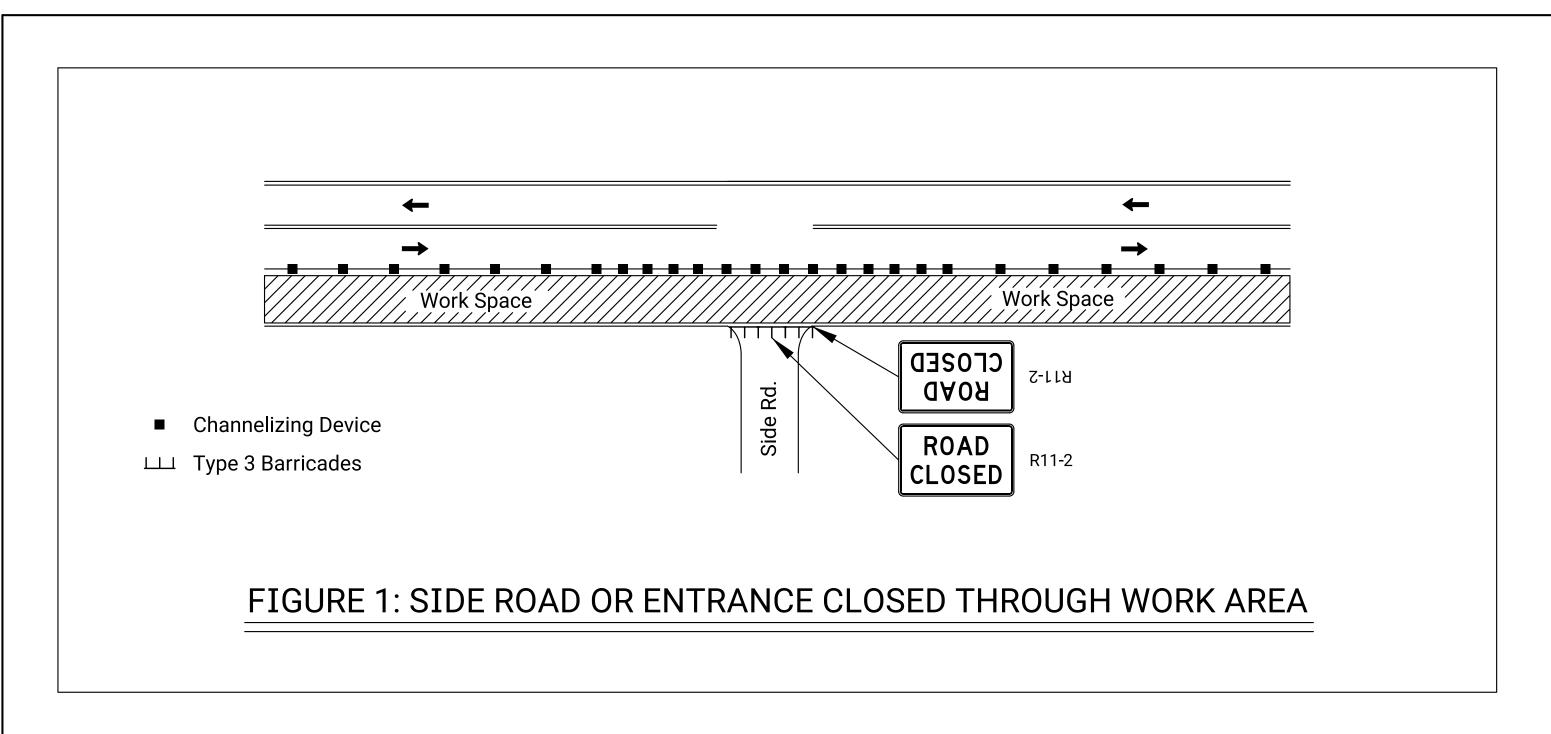


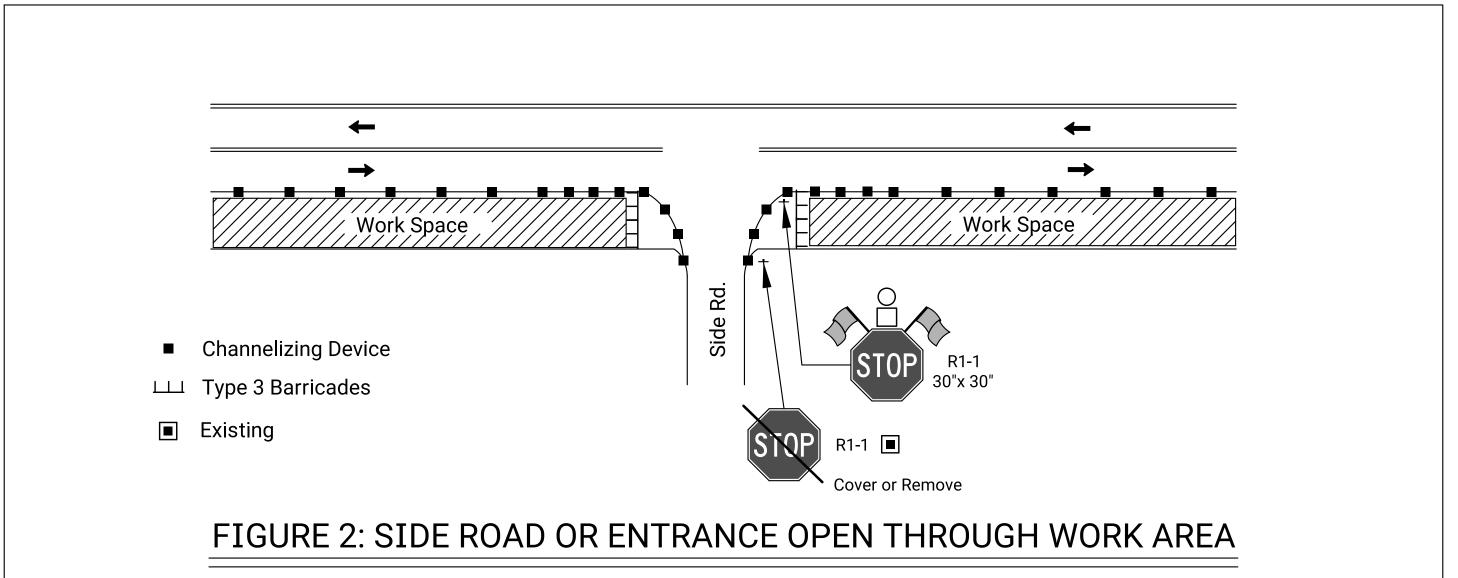

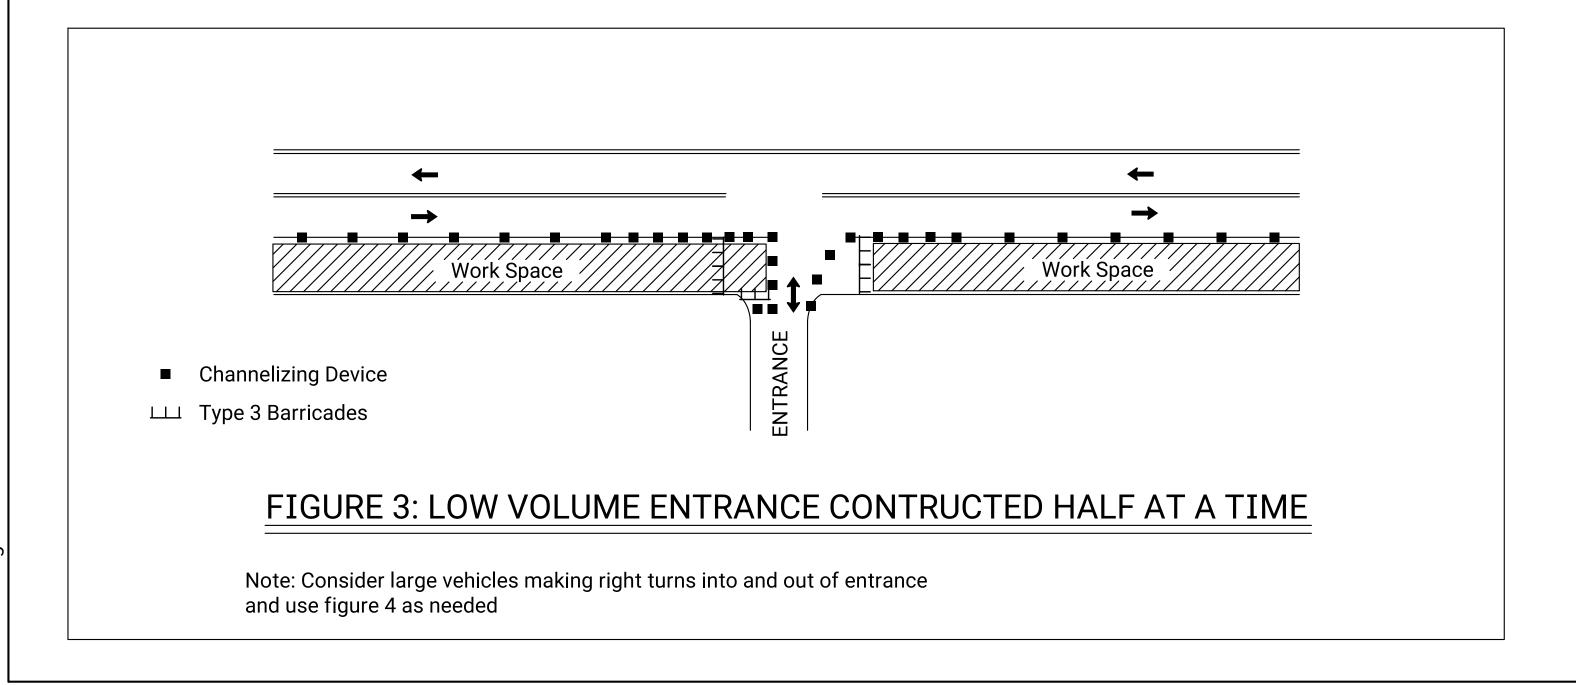

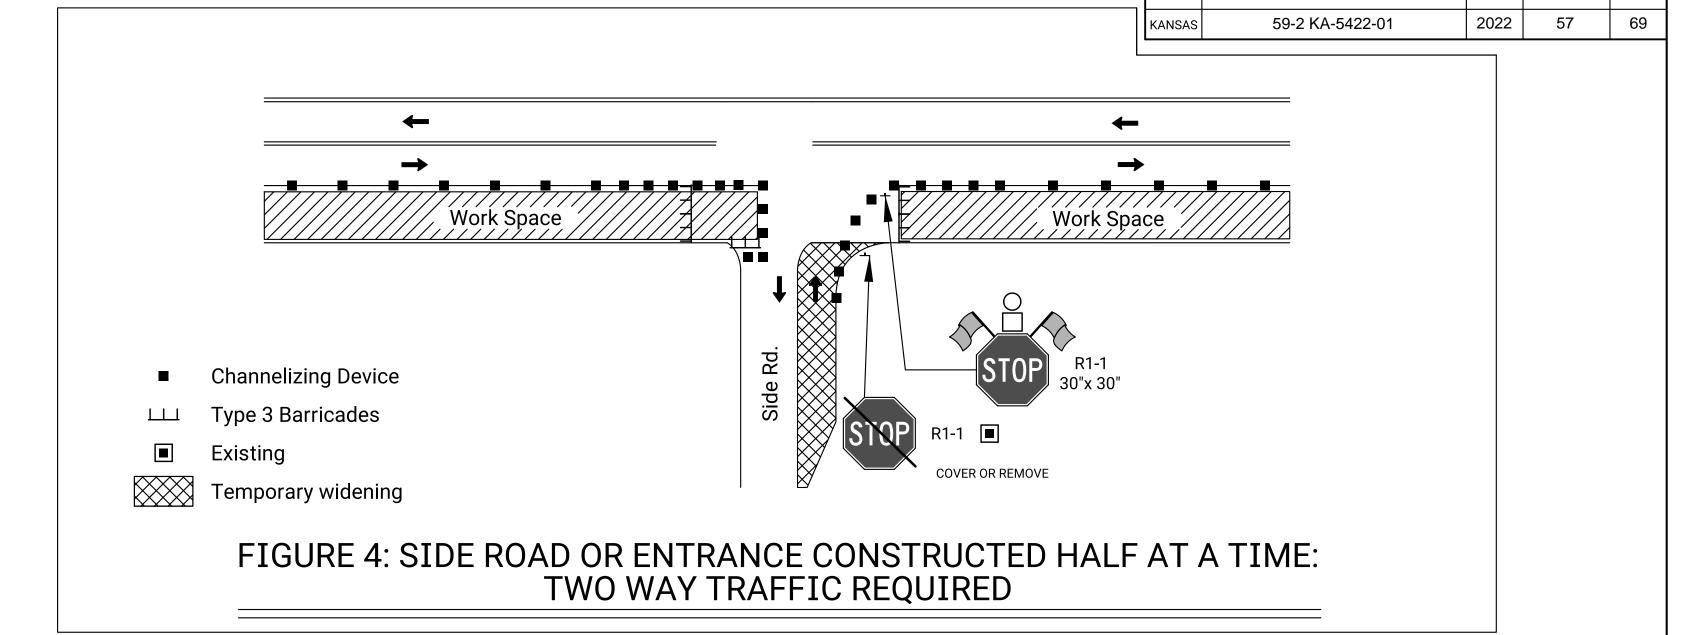

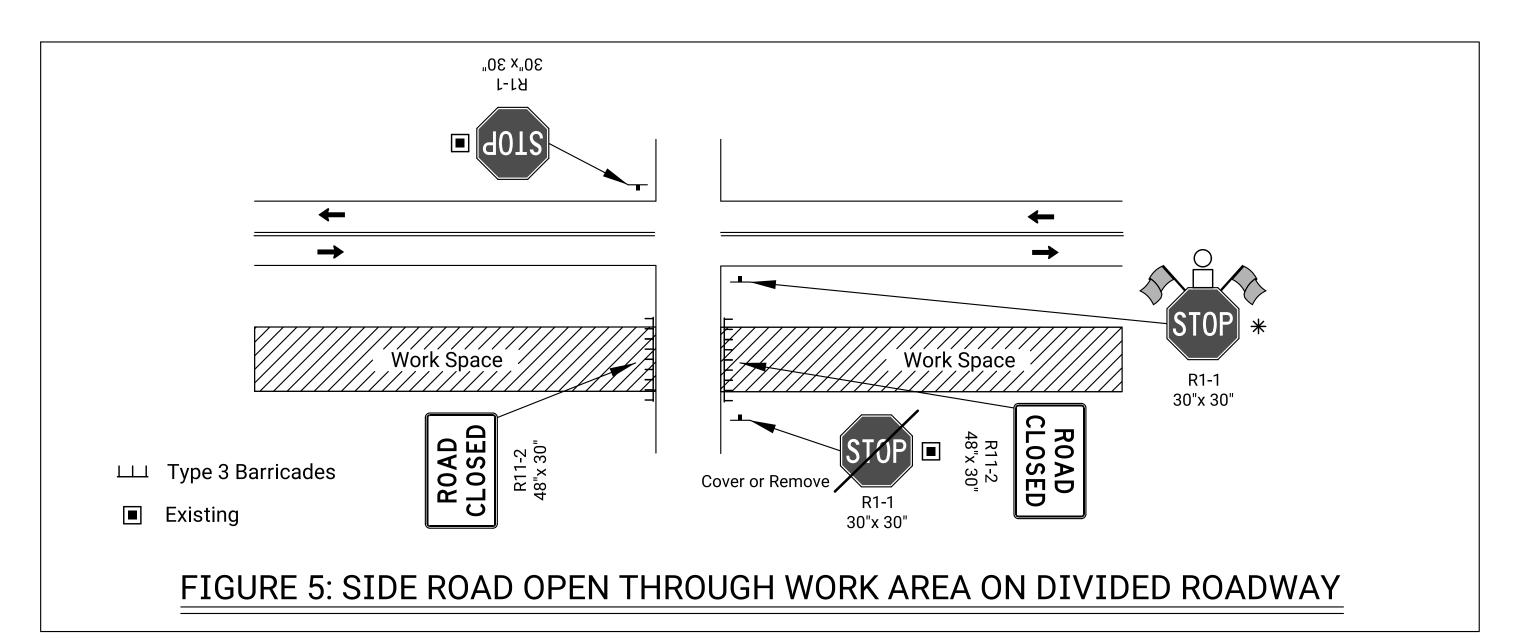

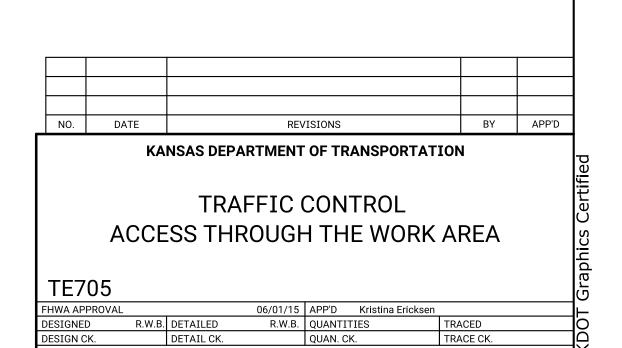

KDOT Graphics Certified 03-29-2018


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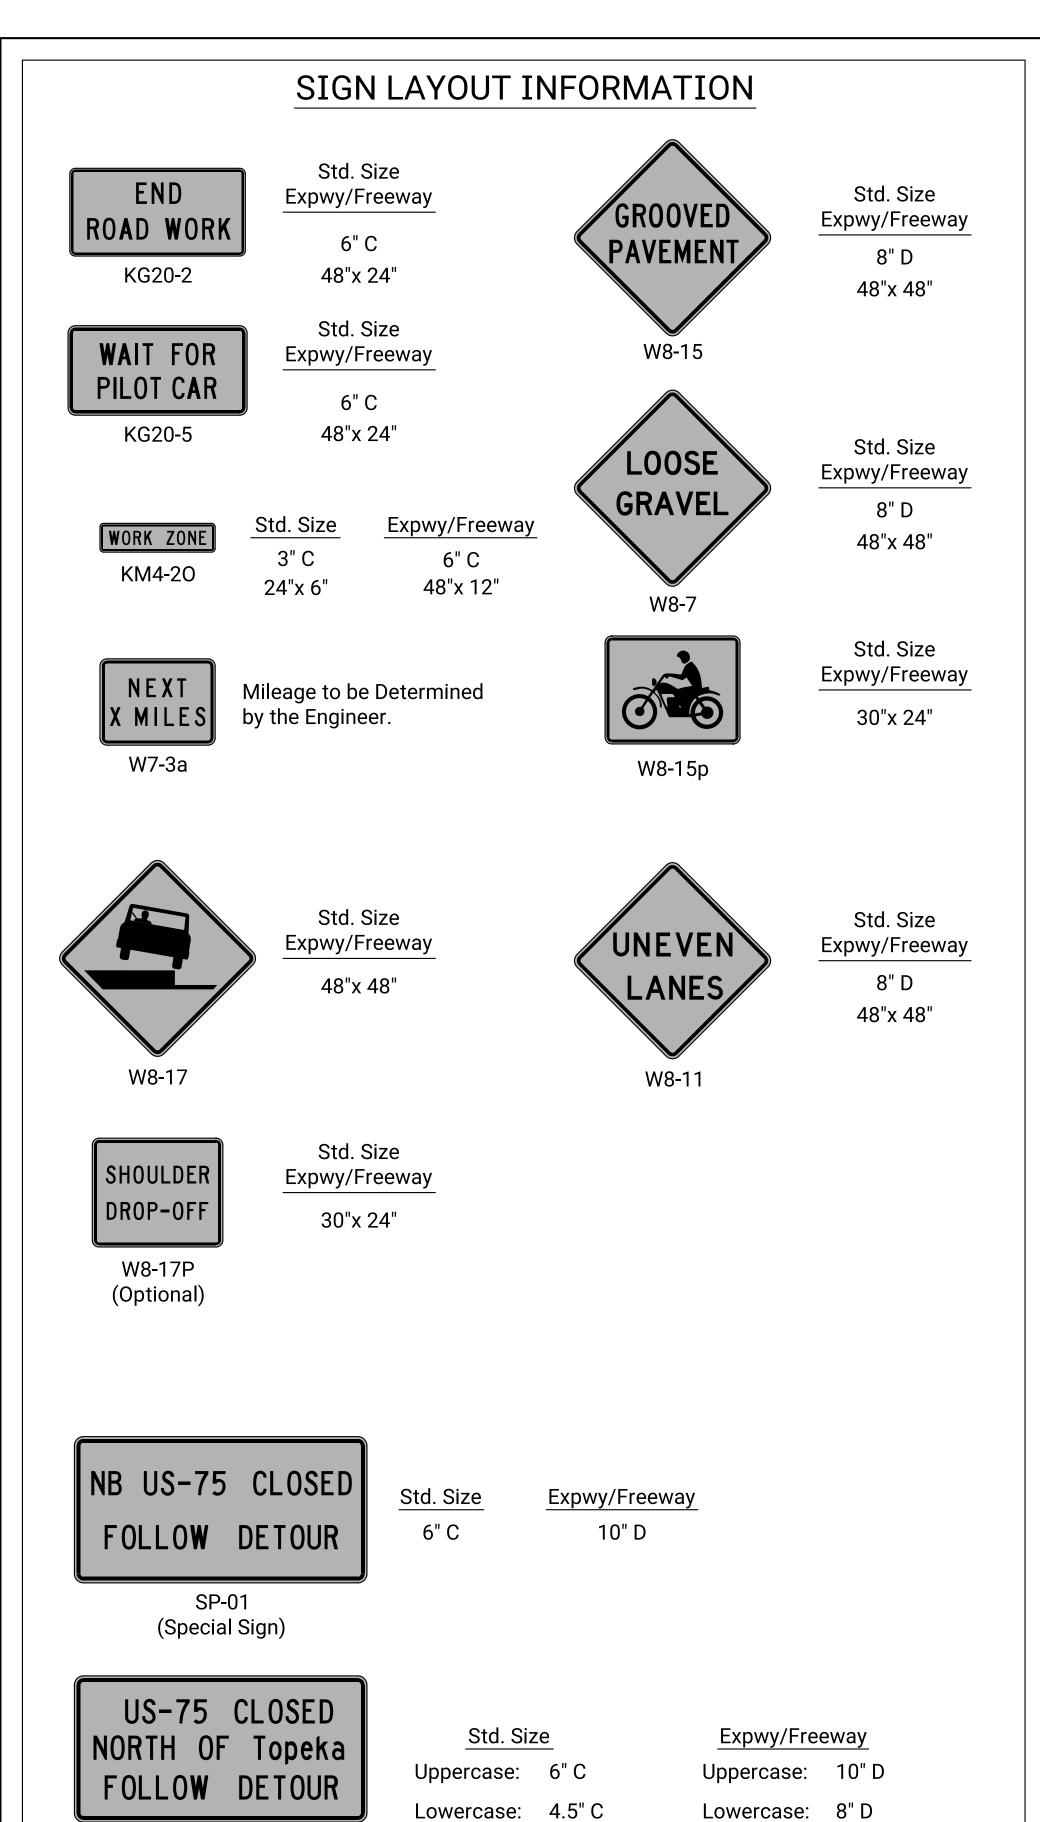
YEAR SHEET NO.


STATE

PROJECT NO.






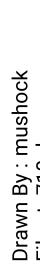

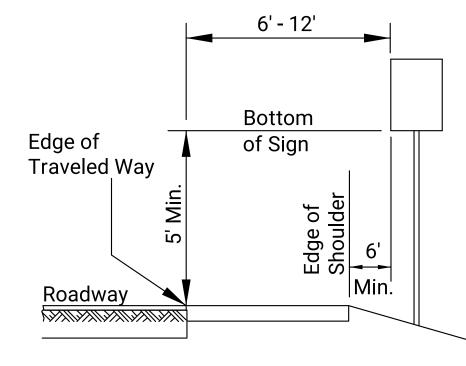


RURAL

- 1) Ground-mounted signs shall be mounted at a minimum height of 5' measured from the bottom of sign to the near edge of the pavement.
- 2) Large signs having an area exceeding 50 square feet installed on multiple breakaway posts shall be mounted a minimum of 7' above the ground.
- 3) The height of the secondary sign mounted below another sign may be 4' measured from the bottom of the sign to the near edge of the pavement. Signs shall not overlap each other.

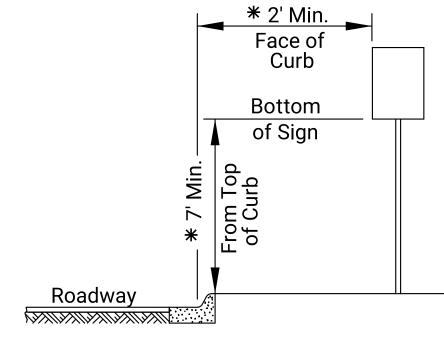

URBAN


- 1) Signs shall be mounted at a minimum height of 7' measured from the bottom of sign to the near edge of the pavement.
- 2) Neither portable nor permanent sign supports should be located on sidewalks or areas designated for pedestrian or bicycle traffic.
- 3) Signs mounted lower than 7' should not project more than 4" into pedestrian facilities.
- 4) The height from of the secondary sign mounted below another sign may be 6' measured from the bottom of sign to the near edge of the pavement. Signs shall not overlap each other.
- 5) Large signs having an area exceeding 50 square feet installed on multiple breakaway posts shall be mounted a minimum of 7' above the ground.
- * 6) Pedestrian detour signing shall be a minimum of 2' measured from the top of the pedestrian pathway to the bottom of the sign and shall not protrude into the walkway nor shall it project beyond the back of curb.

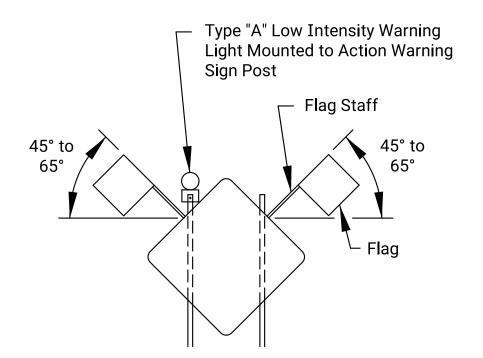

When the sign width is equal to or greater than 9', three or more wood posts may be used with a minimum of 4' between the centerline of each post. All signs less than 9' in width shall use a maximum of two wood posts.

In the case of hitting rock when driving posts

- 1. Shift the sign location. Do not violate minimum sign spacing.
- 2. With the engineer's approval, use acceptable alternative sign stands.

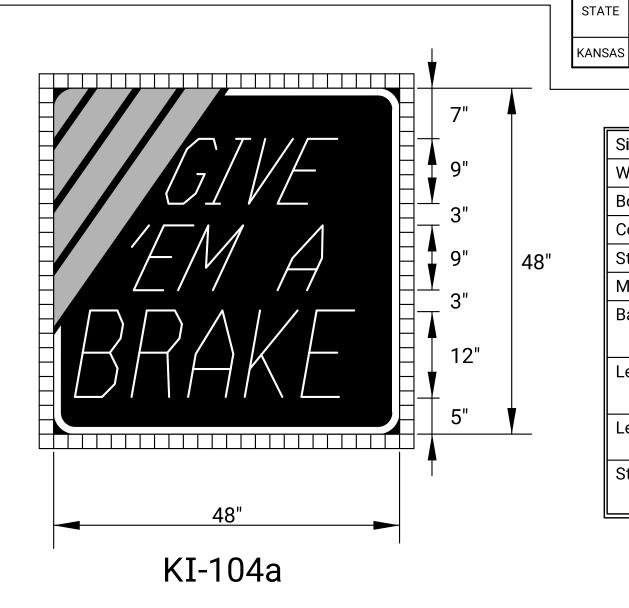

Sign Number	GIVE EM A BRAKE
Width x Height	4'-0" x 4'-0"
Border Width	1.0"
Corner Radius	4.0"
Stripe Width	3.0"
Mounting	Ground
Background	Type: Non-Reflective
	Color: Black
Legend/Border	Type: Reflective
	Color: White
Legend Font	Dutch 801 Roman SWC 25 Degree Slant
Stripes	Type: Reflective
	Color: Orange


PROJECT NO.

59-2 KA-5422-01

YEAR SHEET NO.

58

2022

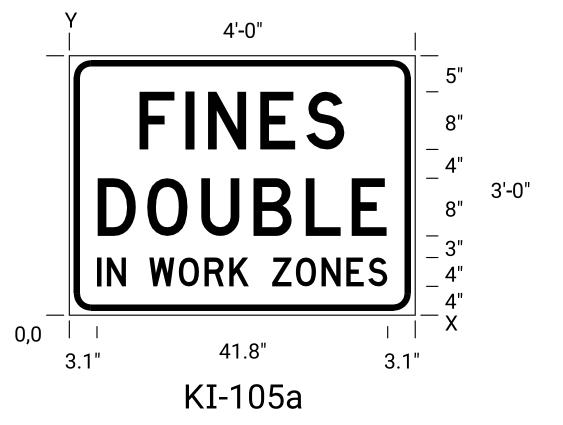

FINES DOUBLE
4'-0" x 3'-0"
0.9"
3.0"
Ground
Type: Reflective
Color: White
Type: Non-Reflective
Color: Black

Dimensions in inches

Spacings are to start of next letter


Y FONT						LE	ETTE	ER S	PA(CIN	GS					HT LEN
23.0	\times	F	Ι	N	Е	S										8.0
D	9.7	6.4	3.2	7.3	6.4	5.4	9.7									28.6
11.0	\times	D	0	U	В	L	E									8.0
D	3.9	6.9	7.5	7.3	7.3	6.4	4.9	3.9								40.3
4.0	\times	I	N		W	0	R	K		Z	0	N	Ε	S		4.0
D	3.1	1.6	2.7	3.2	4.3	3.8	3.6	2.8	3.2	3.4	3.8	3.6	3.2	2.7	3.1	41.8

Notes:

Typically, there are two sets of informational signs installed per project: one for each direction of traffic.

Install signs a minimum of 500' in advance of the road work ahead sign. The engineer may designate a more appropriate location if conditions dictate.

The informational signs are not to interfere with the traffic control signs for the project.

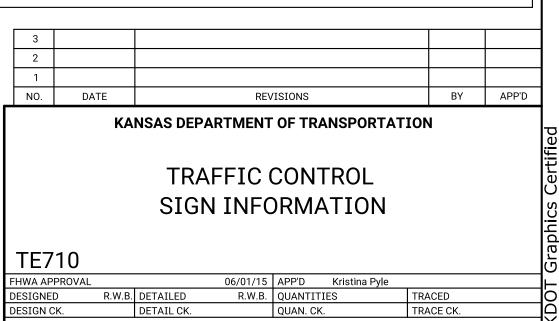


SP-02


(Special Sign)

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All city names and street names on special signs and destination signs must have upper and lower case letters.

Sh. No. XXX




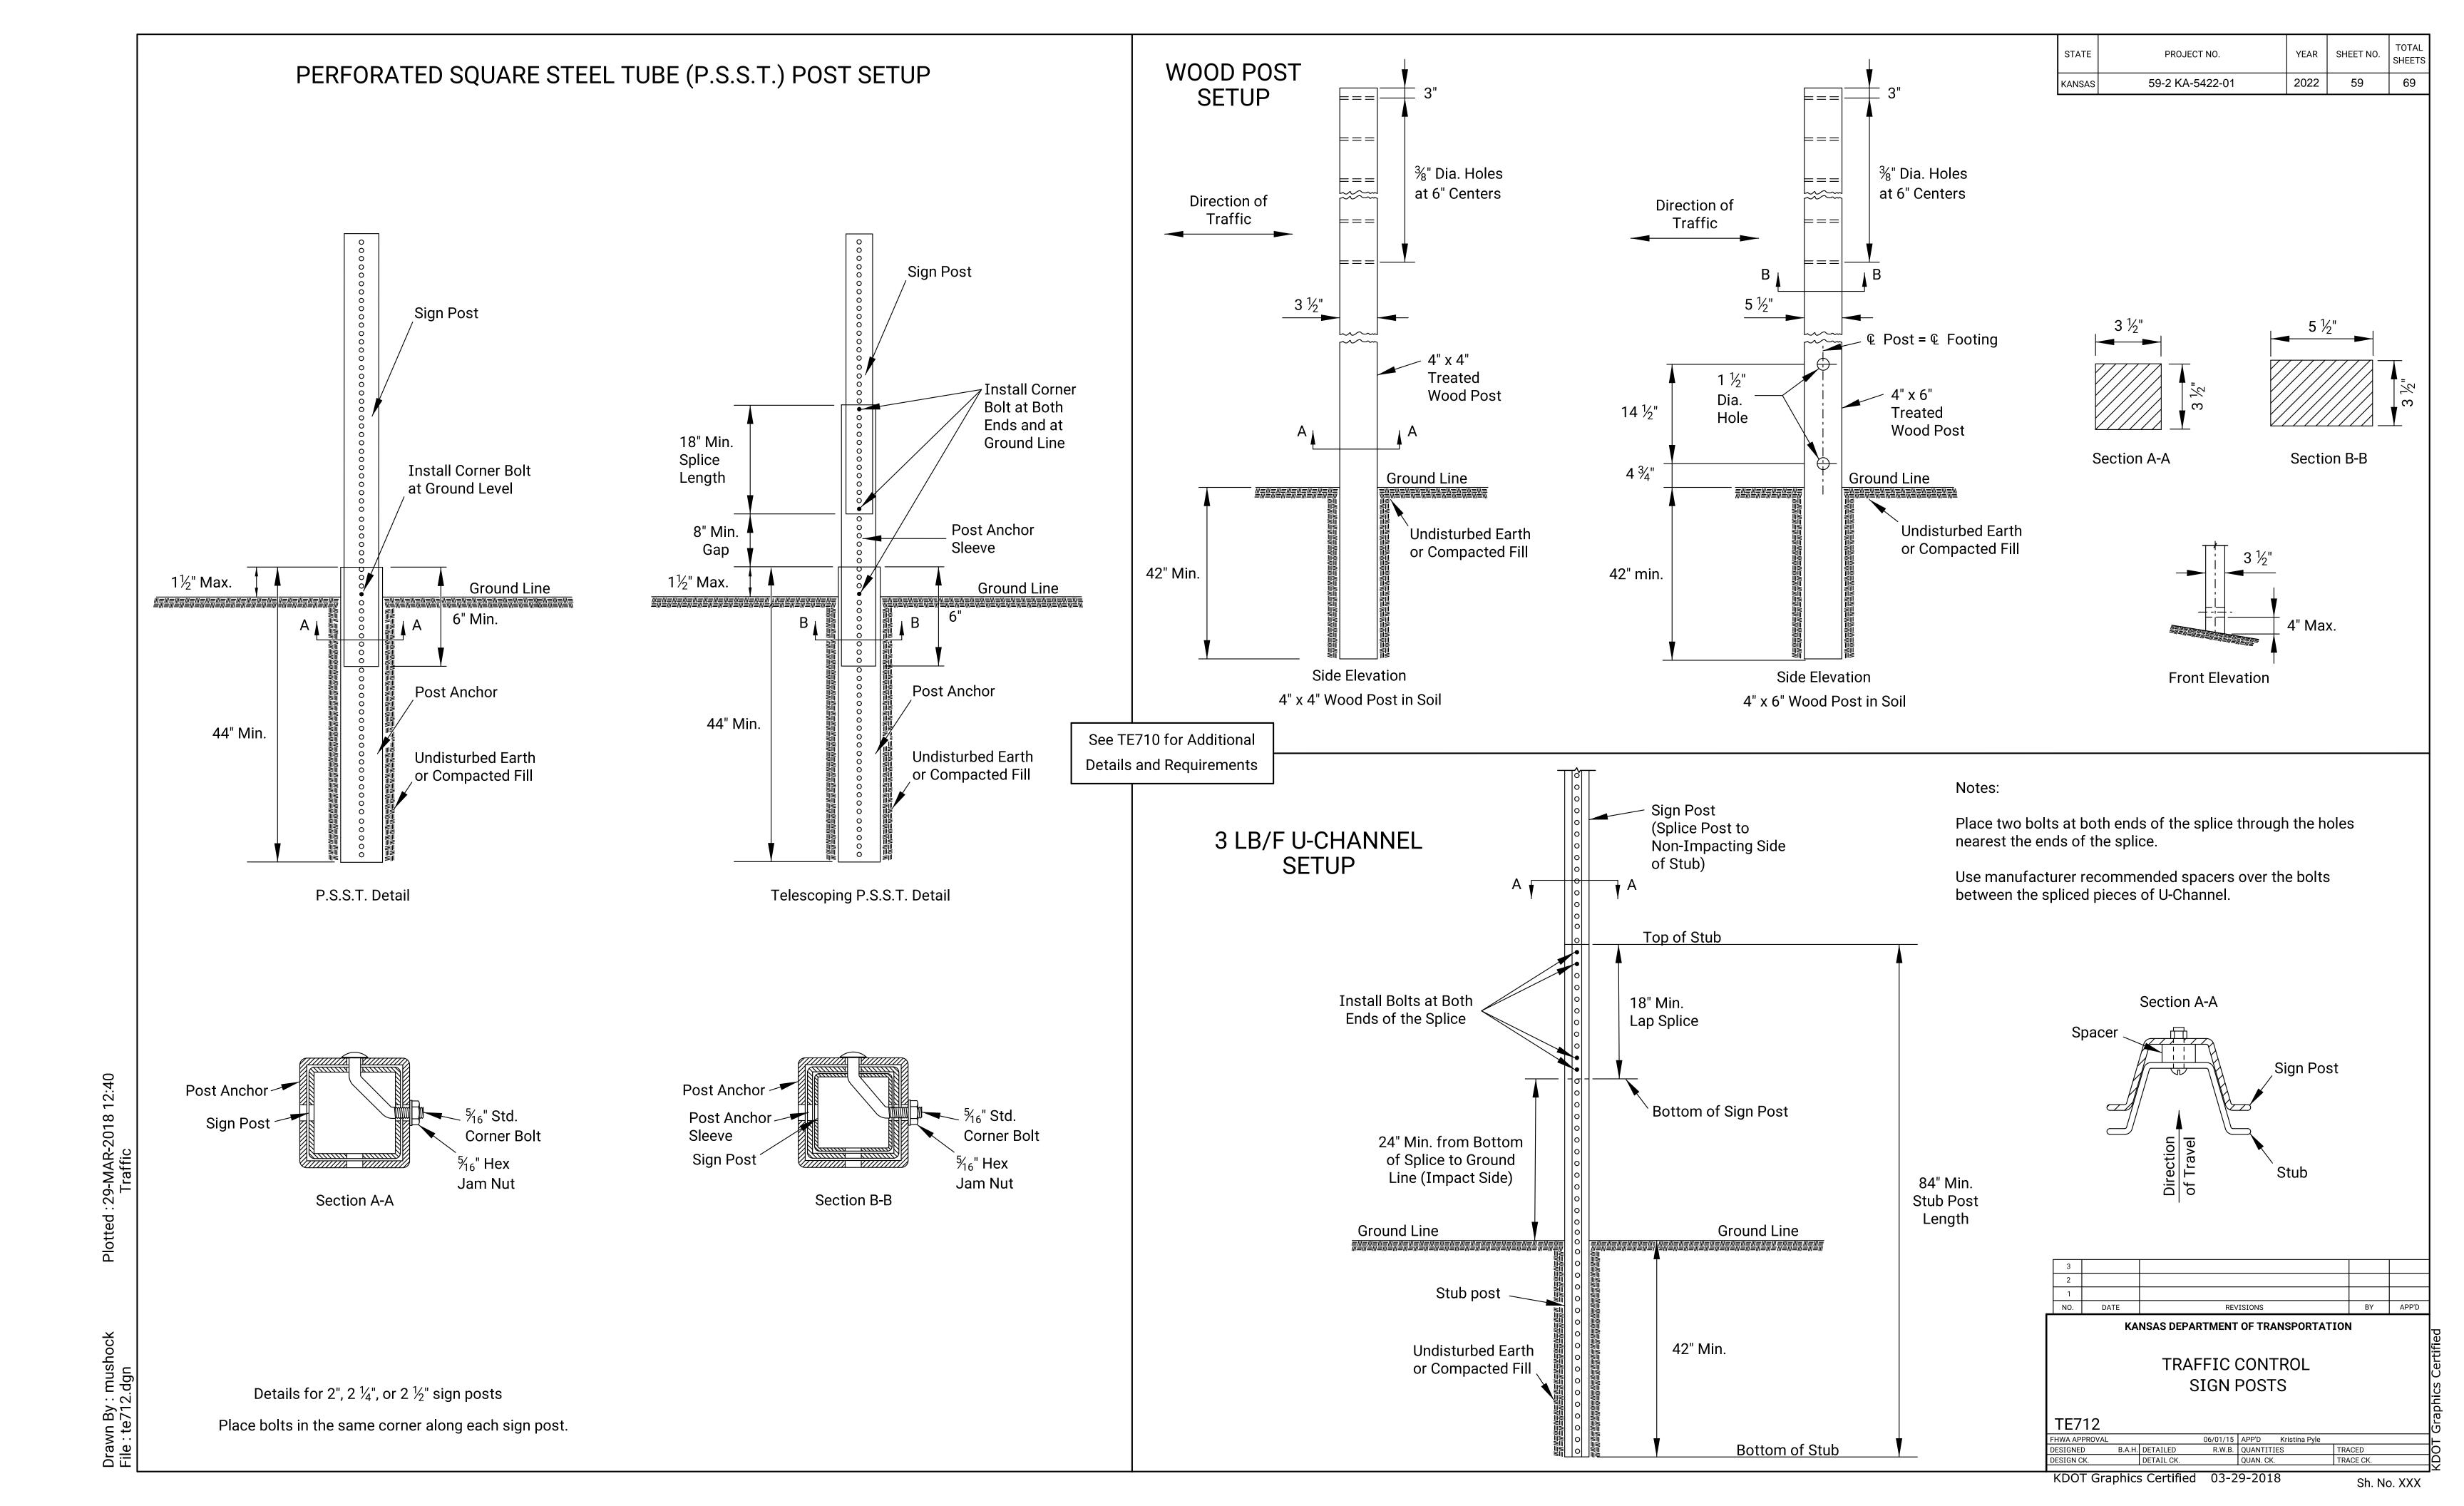

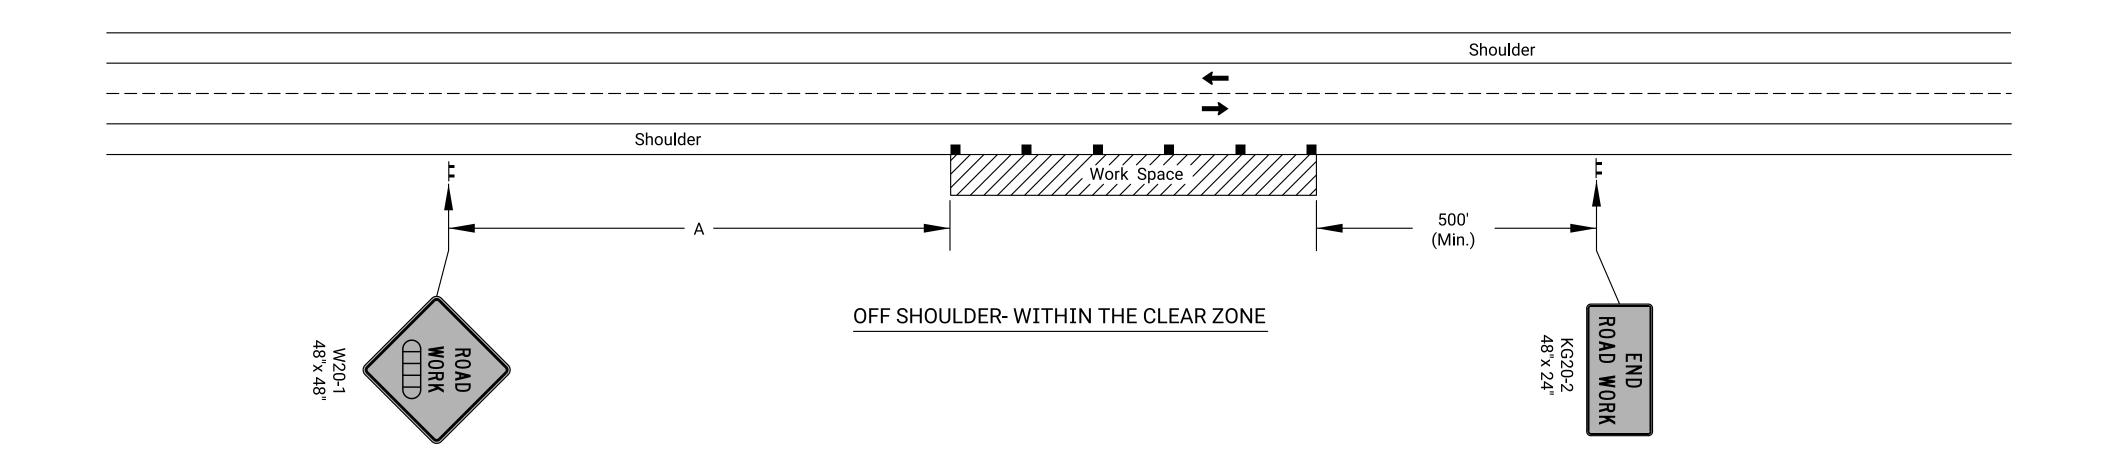Notes:

No traffic control is required if the Work Space is located outside of the clear zone.

For operations of 60 minutes or less, all signs and channelizing devices may be eliminated if a vehicle with high-intensity rotating, flashing, oscillating, or strobe lights is used.

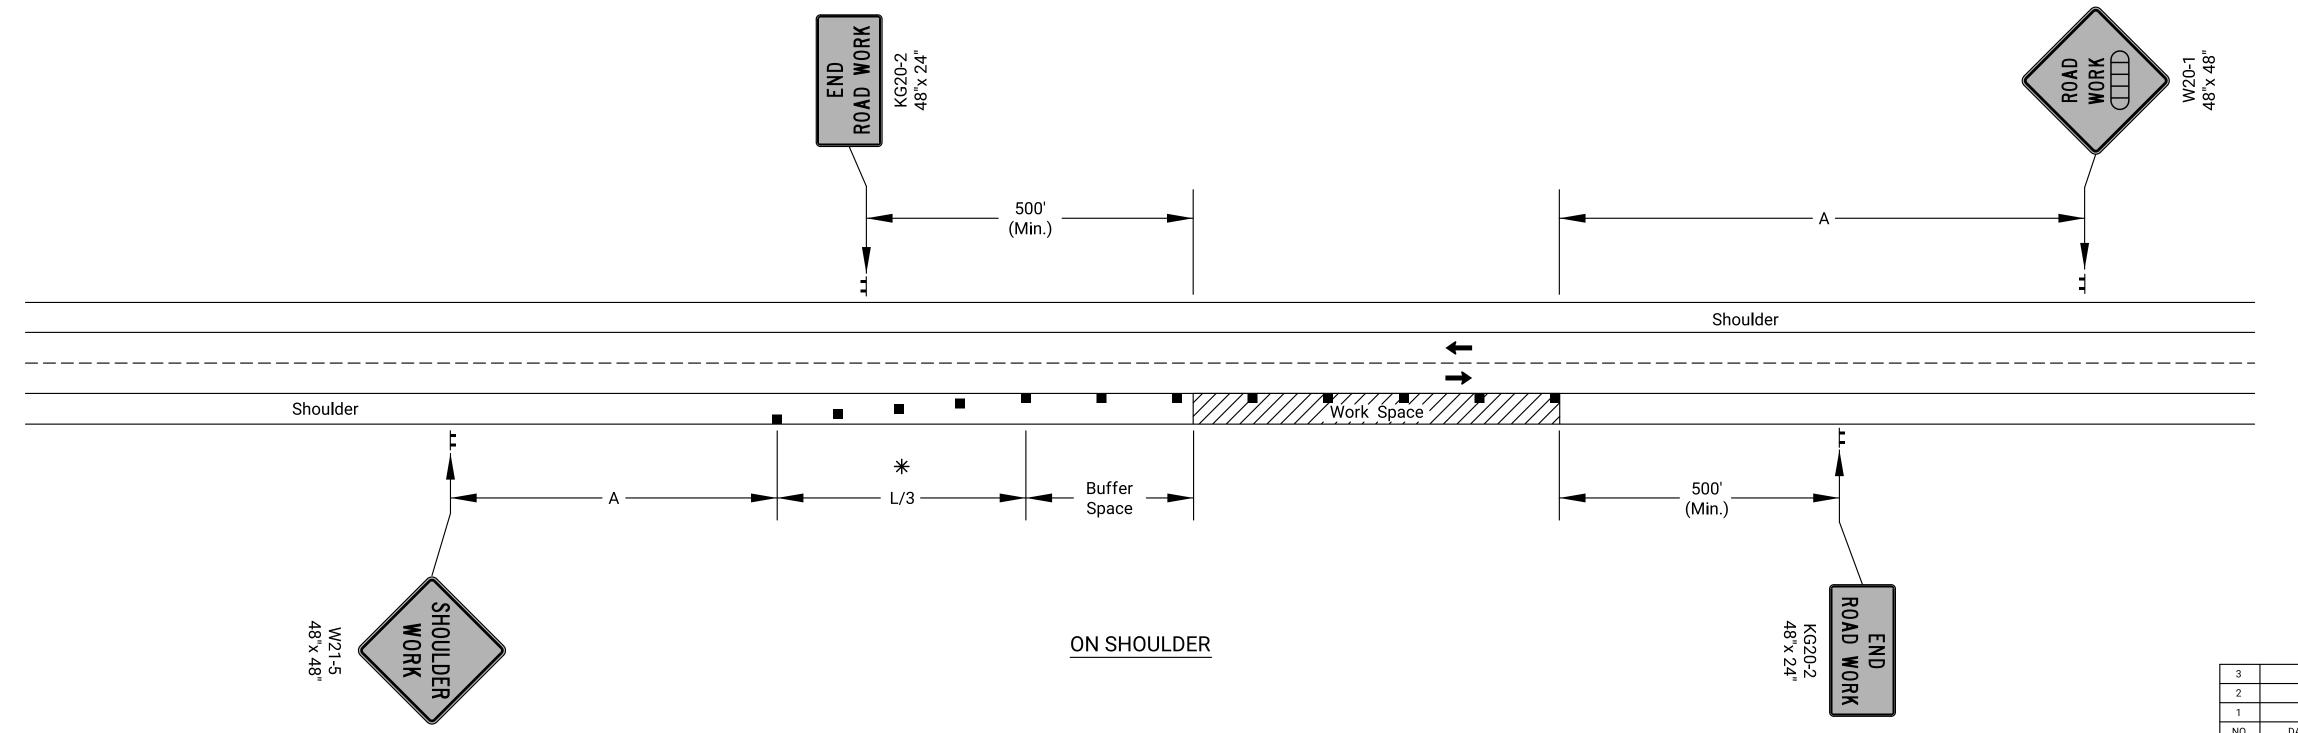


* Omit taper if paved shoulder is less than 8' wide.

Channelizing Device Ahead, 1500 ft, or 1 Mile


KANSAS DEPARTMENT OF TRANSPORTATION TRAFFIC CONTROL SHOULDER WORK UNDIVIDED ROADWAY TE720 06/01/15 APP'D Kristina Ericksen
R.W.B. QUANTITIES
QUAN. CK. TRACED TRACE CK.

REVISIONS

KDOT Graphics Certified 03-29-2018

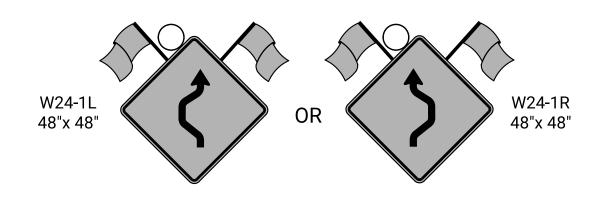

One W24-1 should be used per approach where the tangent distance between two reverse curves is less than 600 ft. If used, use in place of the first W1-4 and eliminate the second.

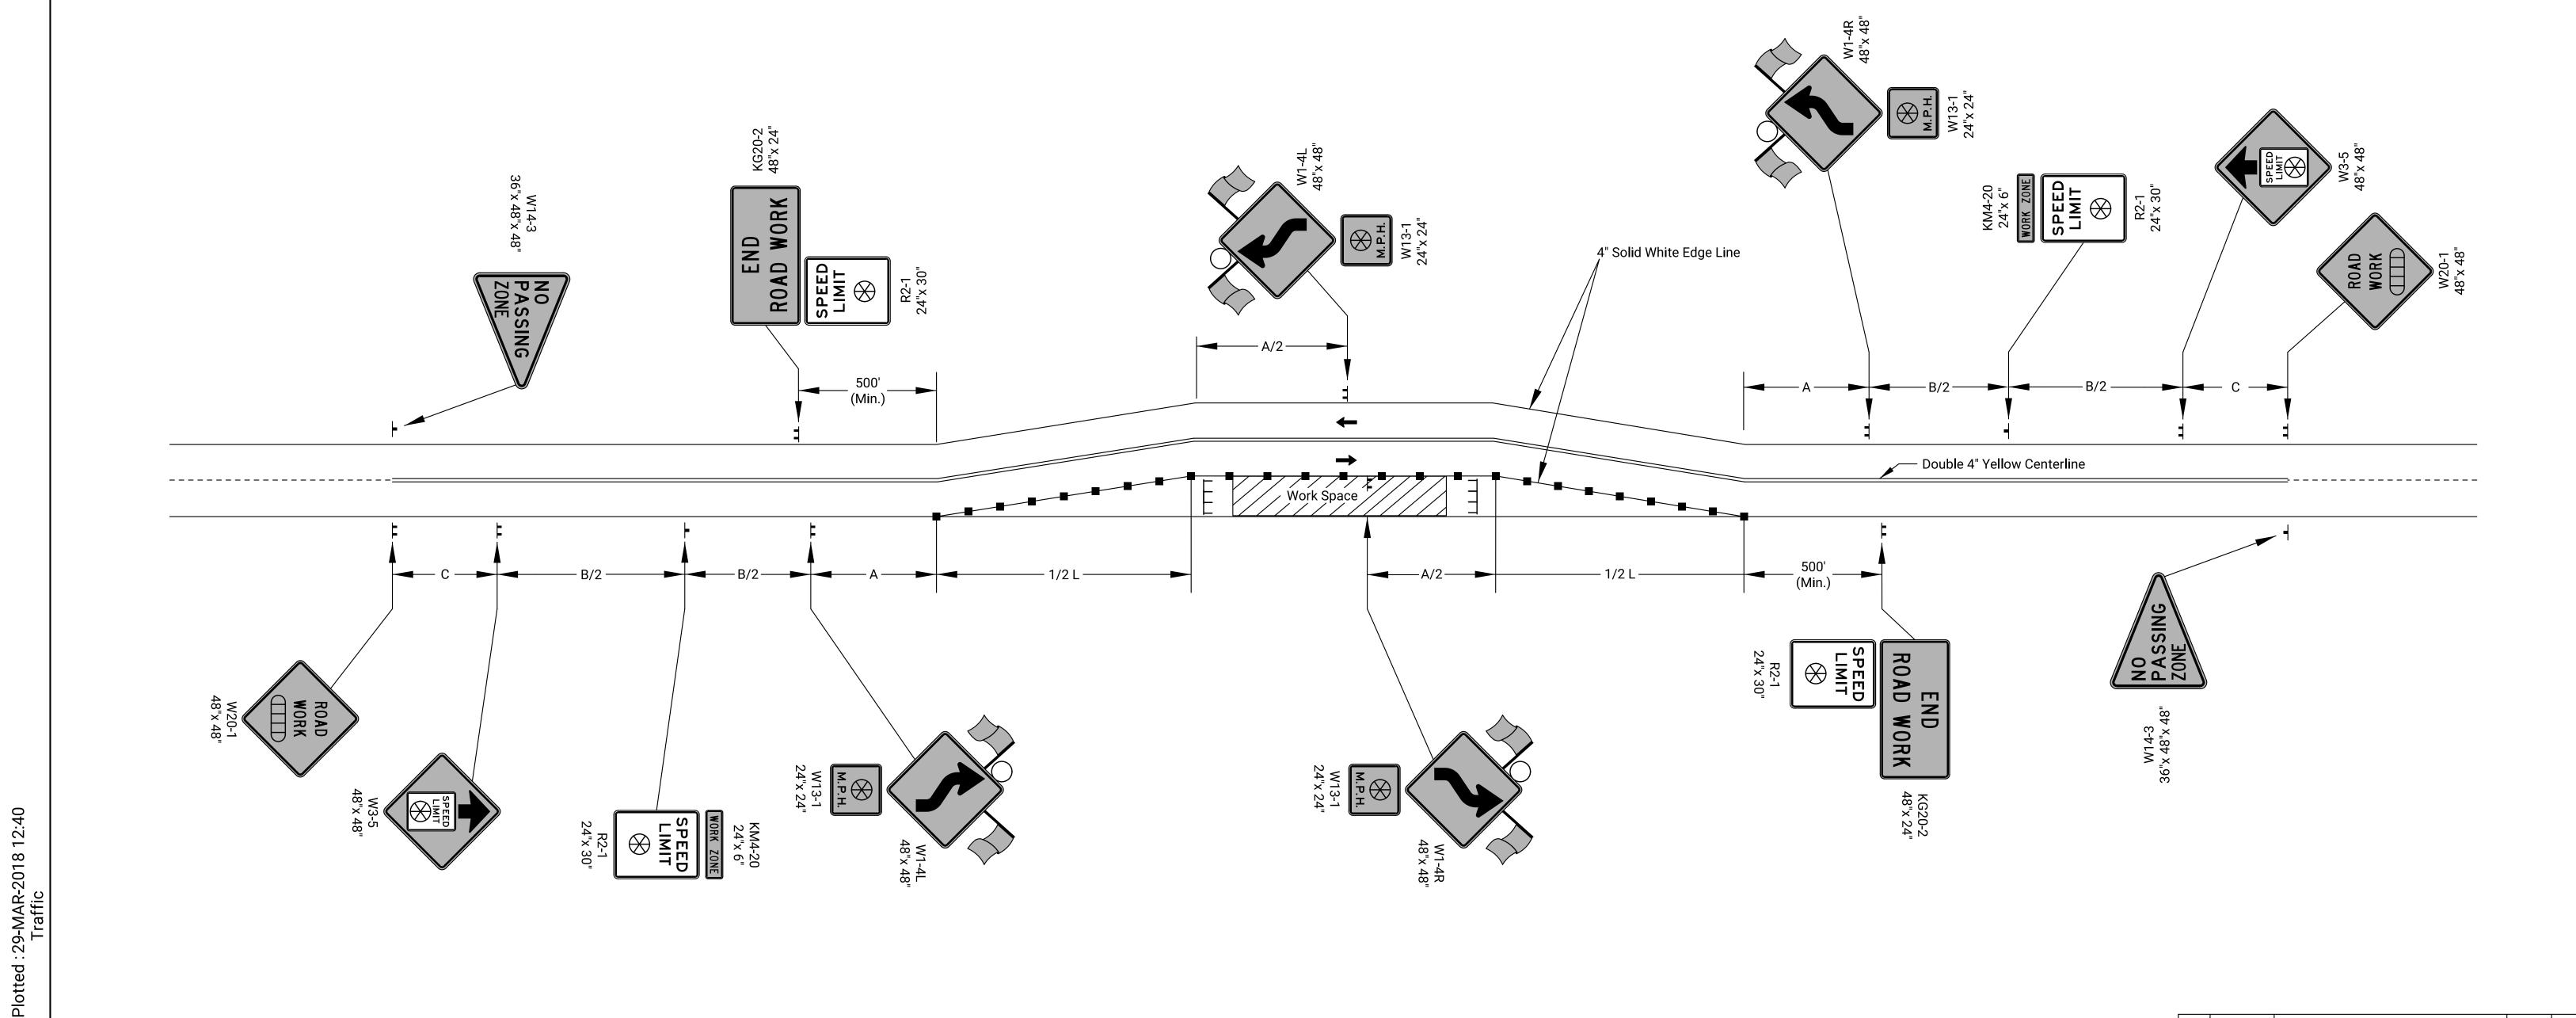

Ahead, 1500 ft, or 1 Mile


Speed to be Determined by the Engineer

Type "A" Low Intensity Warning Light

1 03/13/18 NO. DATE W24-1 usage changed to Should R.W.B. E.G.K. KANSAS DEPARTMENT OF TRANSPORTATION TRAFFIC CONTROL LANE SHIFT TE724 03/13/18 APP'D Eric Kocher
R.W.B. QUANTITIES
QUAN. CK.

KDOT Graphics Certified 03-29-2018

Sh. No. XXX

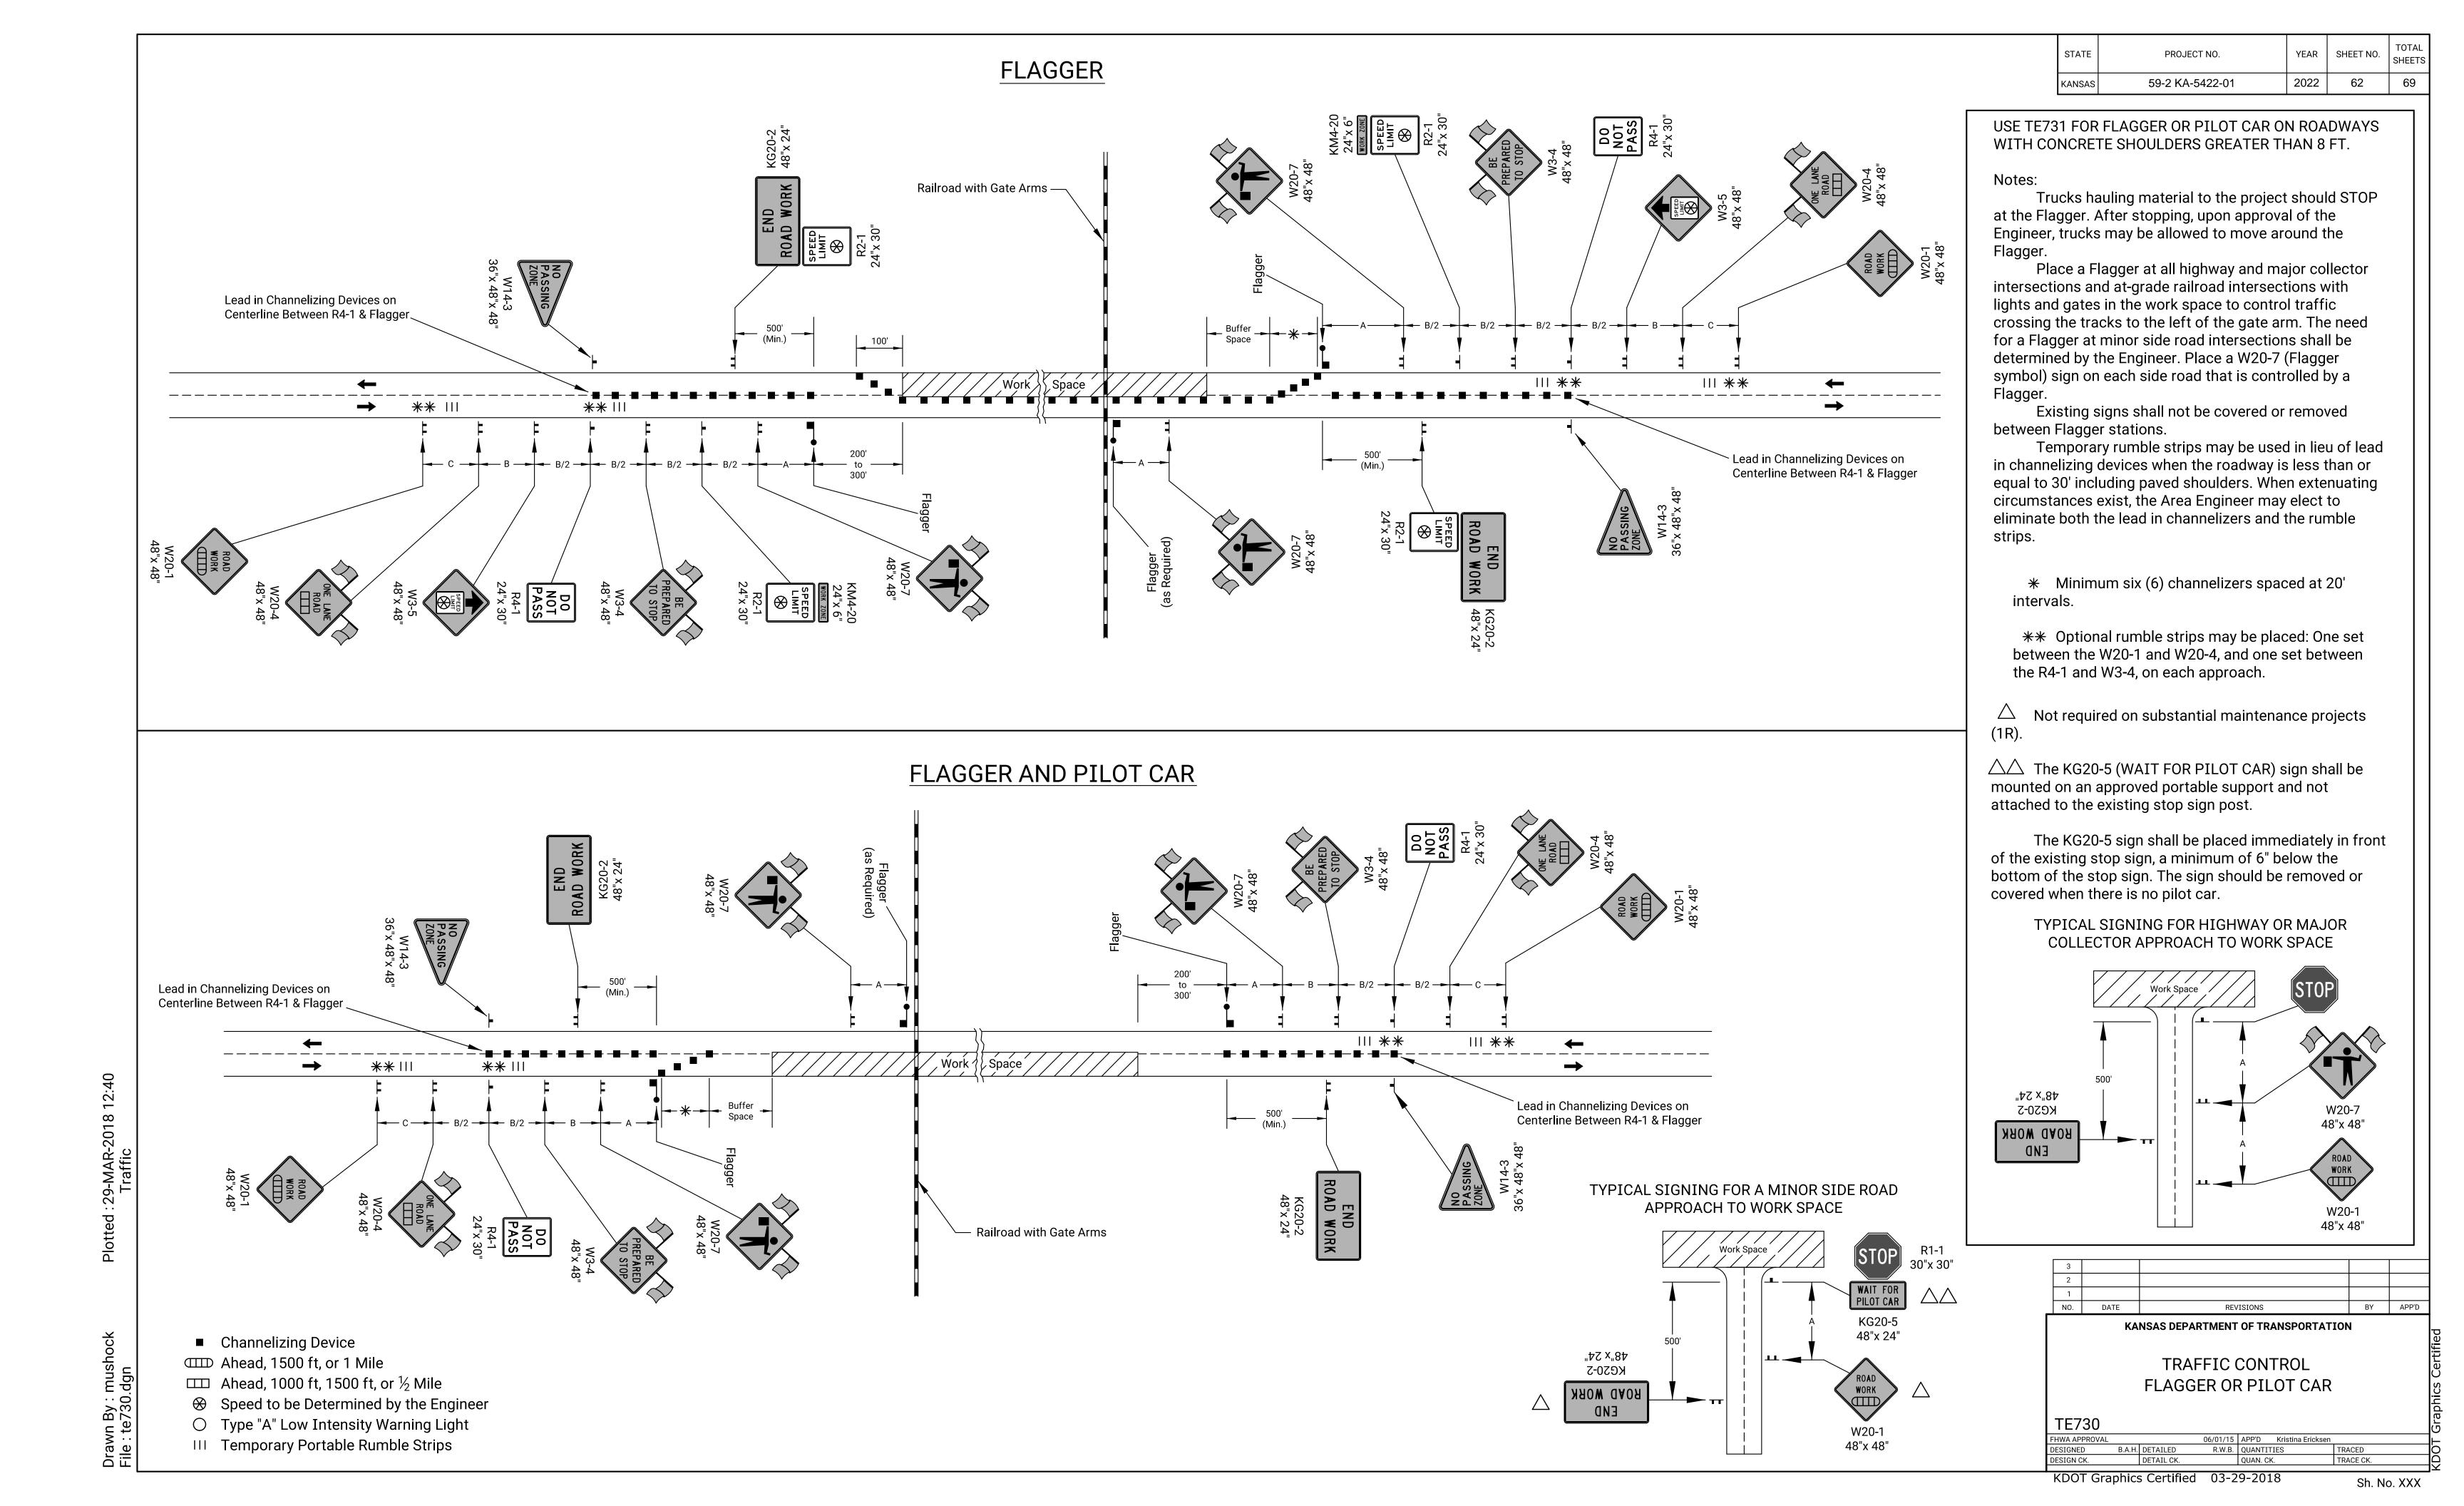

SUMMARY OF TRAFFIC CONTROL DEVICES (EACH)

Work Zone Sign (Special)							
Sign No.	16.25 Sq.Ft. & Less	16.26 Sq.Ft. & Over					

SUMMARY OF TRAFFIC CONTROL DEVICES (EACH PER DAY)

* Quantity most used on the project at any one time

Work Zone Signs **							
Sign No.	0-9.25	Size - Sq.Ft. 9.26-16.25	16.26 & Over				
W20-7	0 7.20	2					
W20-3		4					
W20-1		10					
W20-4		2					
W3-4		2					
W3-5		2					
W1-4L		1					
W1-4R		1					
W13-1	2						
W14-3	2						
R4-1	2						
R2-1	4						
KM4-20	2						
KG20-2	10						
R9-9	10						
R9-11L	1						
R9-11R	1						
R11-4		4					
R1-1	4						
		1					
		ļ					
		ļ					
		ļ					
	38	28					

Barrio	cades *	Cha	nnelizing Dev	vices *
Type 3 (4' to 12')	Pedestrian	Fixed	Portable	Pedestrian
35	12		90	

Lighted Devices *	
Work Zone Warning Light (Type "A" Low Intensity)	40
Work Zone Warning Light (Red Type "B" High Intensity)	4
Arrow Display	
Portable Changeable Message Sign	

STATE	PROJECT NO.	YEAR	SHEET NO.	TOTAL SHEETS
KANSAS	59-2 KA-5422-01	2022	63	69

Recapitulation of Quantities		
Item	Quantity	Unit
Work Zone Signs (0 to 9.25 Sq.Ft.)	X	Each Per Day
Work Zone Signs (9.26 to 16.25 Sq.Ft.)	X	Each Per Day
Work Zone Signs (16.26 Sq.Ft. & Over)	X	Each Per Day
Work Zone Barricades (Type 3 - 4' to 12')	X	Each Per Day
Work Zone Barricades (Pedestrian)		Each Per Day
Channelizer (Fixed)		Each Per Day
Channelizer (Portable)	X	Each Per Day
Channelizer (Pedestrian)		Each Per Day
Work Zone Warning Light (Type "A" Low Intensity)	X	Each Per Day
Work Zone Warning Light (Red Type "B" High Intensity)	X	Each Per Day
Arrow Display		Each Per Day
Portable Changeable Message Sign		Each Per Day
Pavement Marking (Temporary)		
4" Solid (Type I)	111.0	Sta./Line
4" Solid (Type II)		Sta./Line
4" Broken (8.0') (Type I)		Sta./Line
4" Broken (8.0') (Type II)		Sta./Line
4" Broken (3.0') (Type I)		Sta./Line
4" Broken (3.0') (Type II)		Sta./Line
4" Dotted Extension (Type I)		Sta./Line
4" Dotted Extension (Type II)		Sta./Line
Solid (Line Masking Tape)		Sta./Line
Broken (Line Masking Tape)		Sta./Line
Symbol (Type I)		Each
Symbol (Type II)		Each
Flexible Raised Pavement Marker (4" Broken (8.0'))		Sta./Line
Flexible Raised Pavement Marker (4" Broken (3.0'))		Sta./Line
Pavement Marking Removal		Lin. Ft.
Work Zone Sign (Special) (16.25 Sq. Ft. & Less)		Each
Work Zone Sign (Special) (16.26 Sq. Ft. & More)		Each
Rigid Raised Pavement Marker (Type I)		Each
Rigid Raised Pavement Marker (Type I)		Each
, , , ,		
Traffic Signal Installation (Temporary)	Lump Cum	Lump Sum
Traffic Control (Initial Set Up)	Lump Sum	Lump Sum
Traffic Control		Lump Sum
Flagger (Set Price)	1	Hour
	•	

REVISIONS KANSAS DEPARTMENT OF TRANSPORTATION


> TRAFFIC CONTROL SUMMARY OF DEVICES


RECAPITULATION OF QUANTITIES TE795


FHWA APPROVAL06/01/15APP'DKristina EricksenDESIGNEDB.A.H.DETAILEDR.W.B.QUANTITIESTRACEDDESIGN CK.DETAIL CK.QUAN. CK.TRACE CK.


KDOT Graphics Certified 03-29-2018


Sh. No. XXX

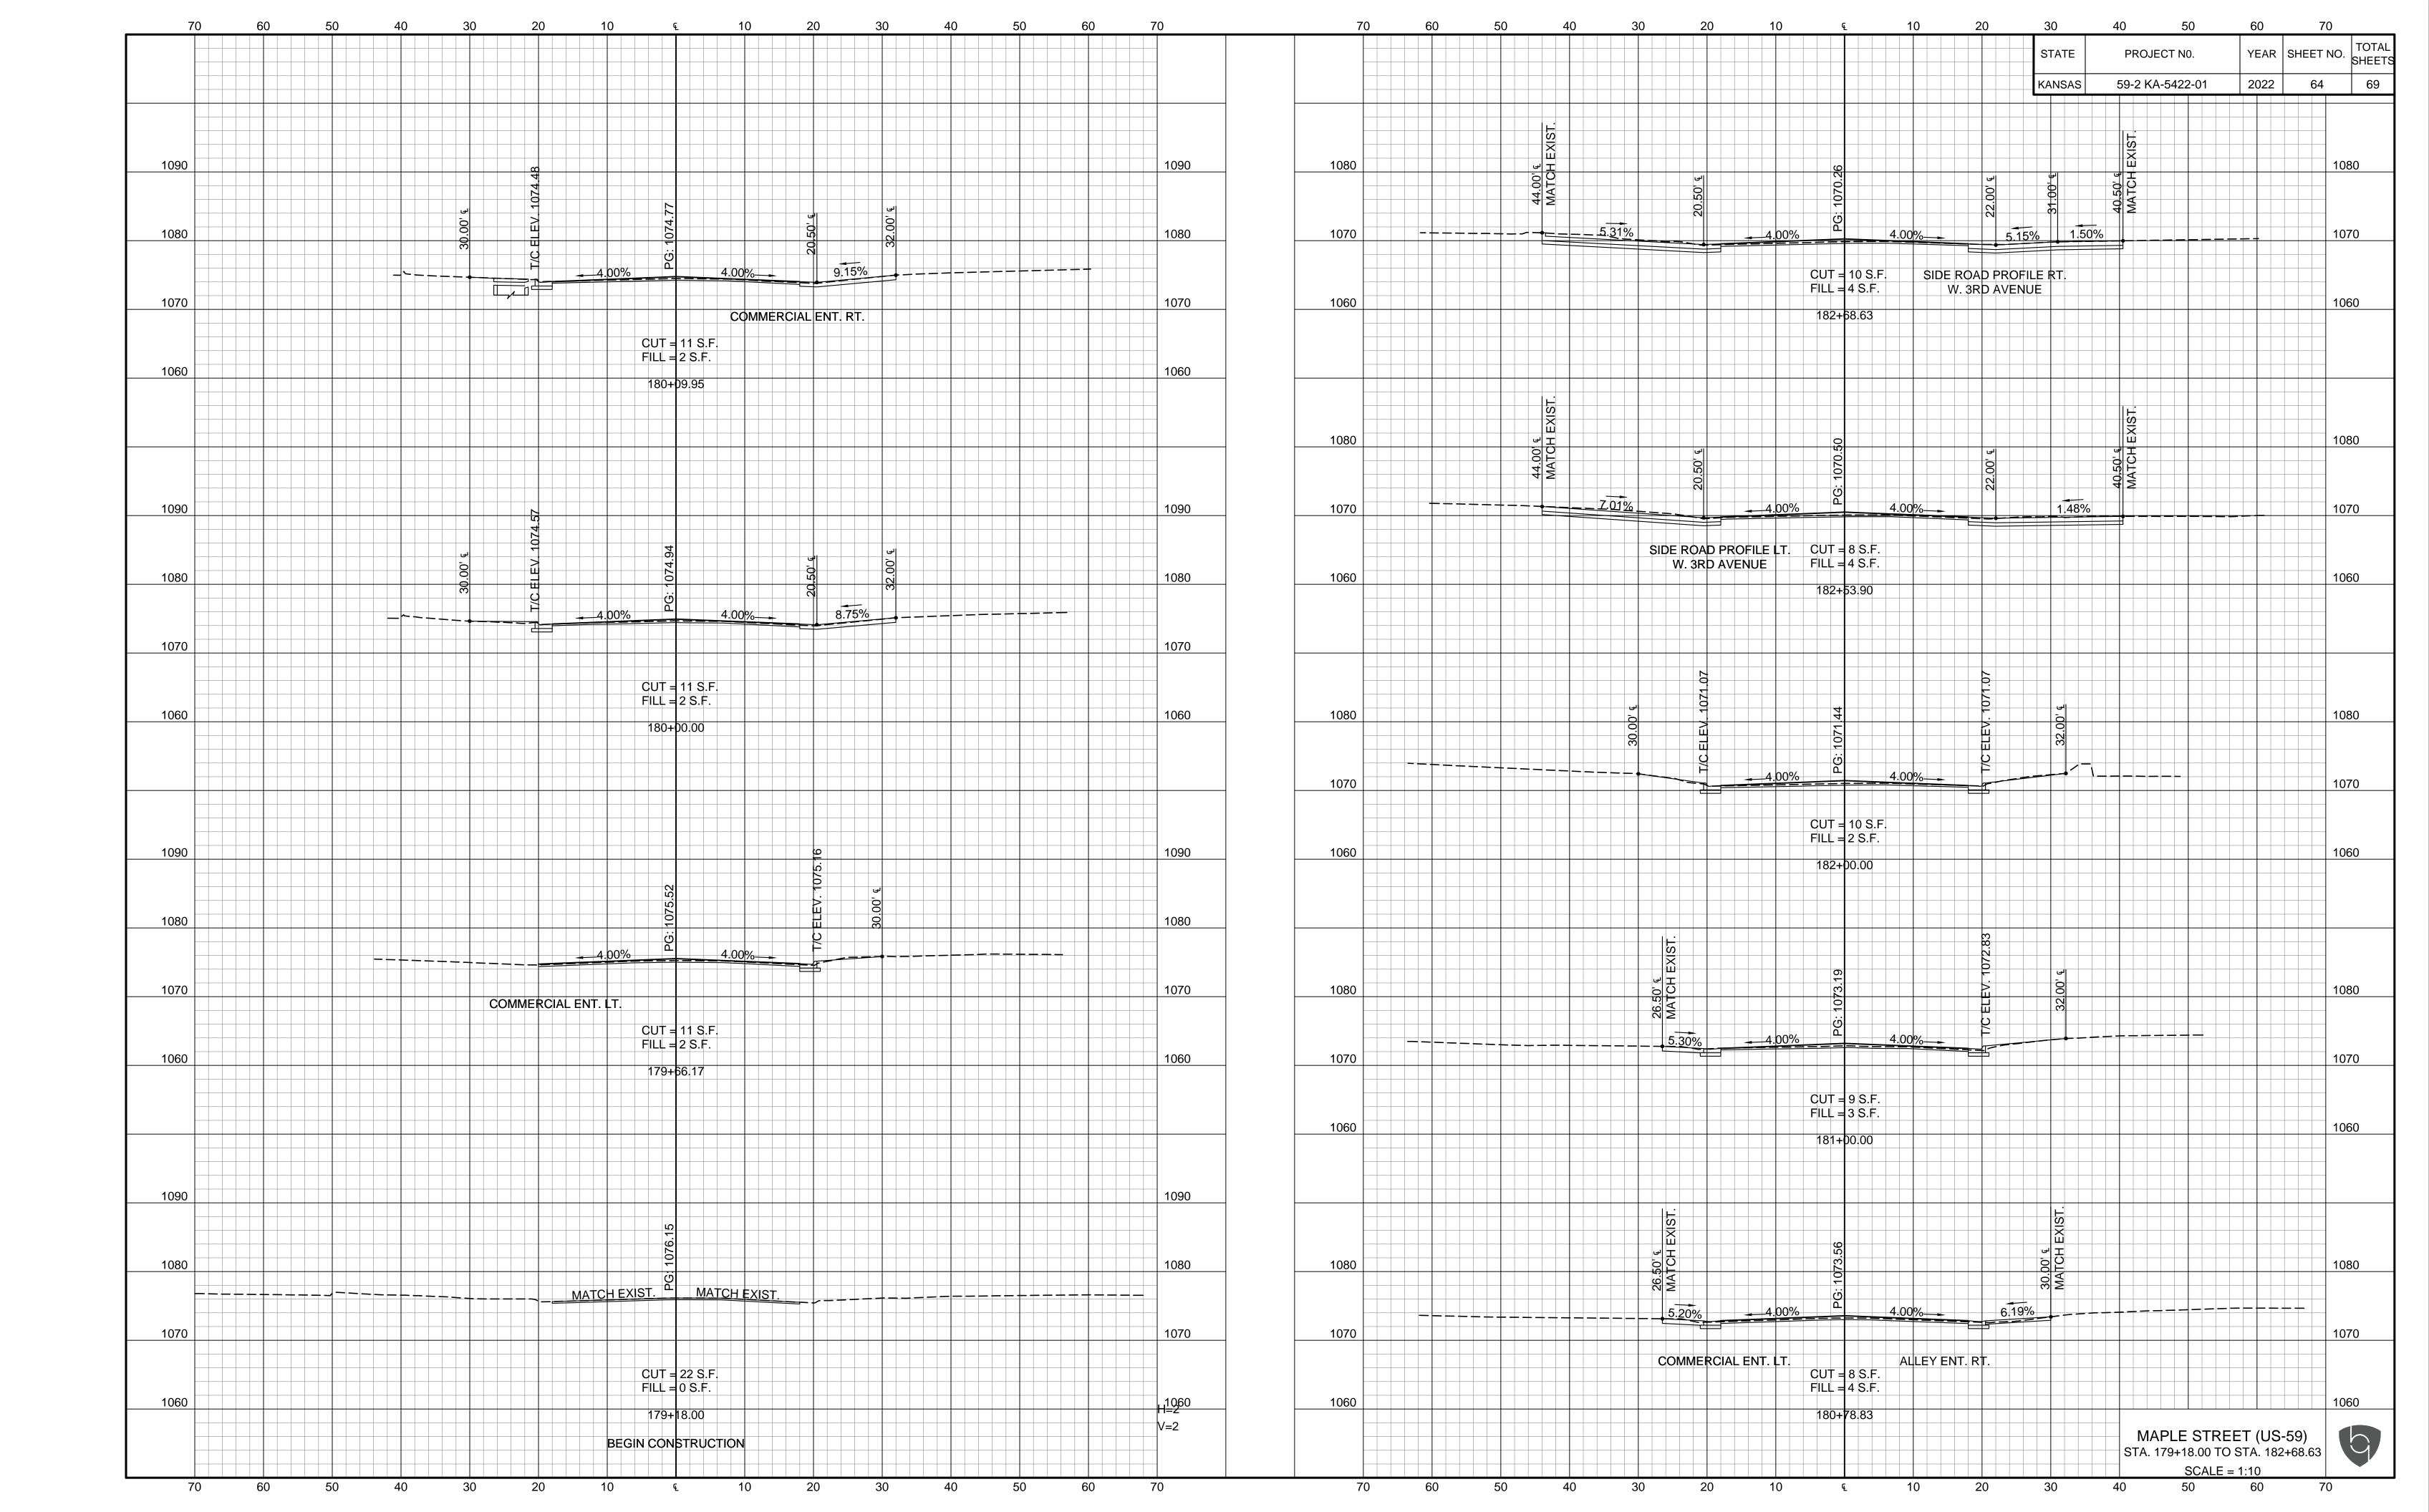


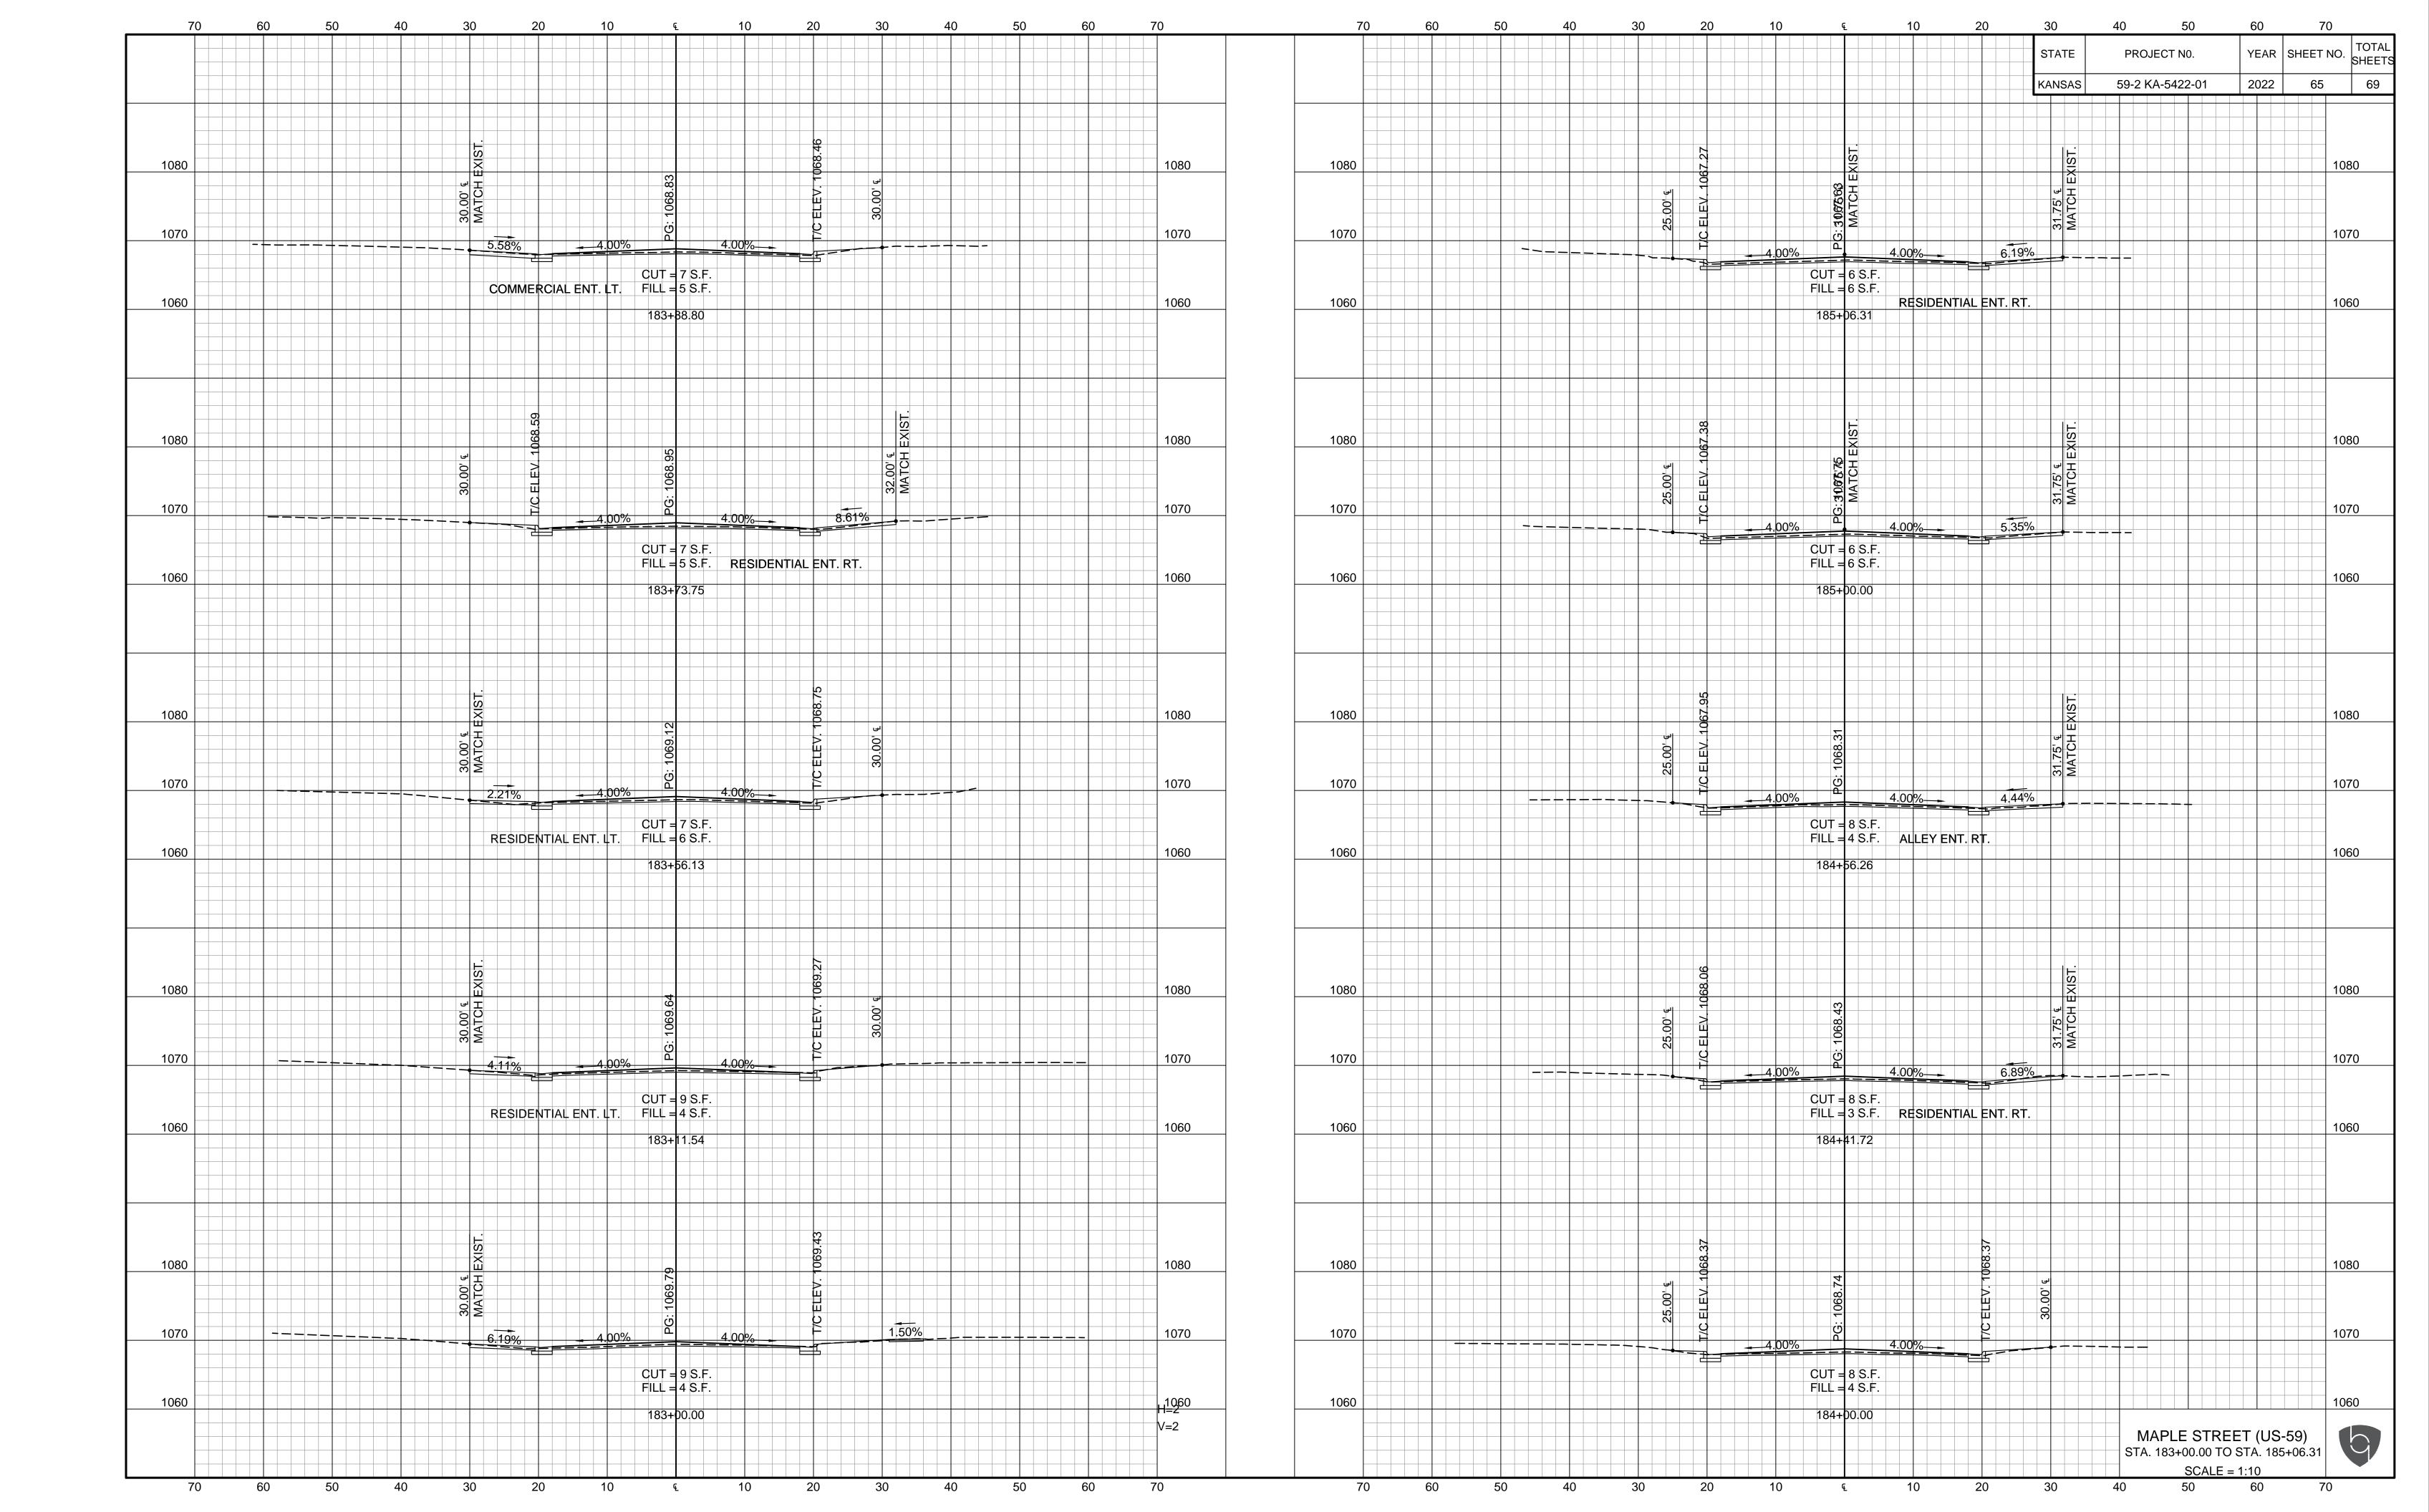

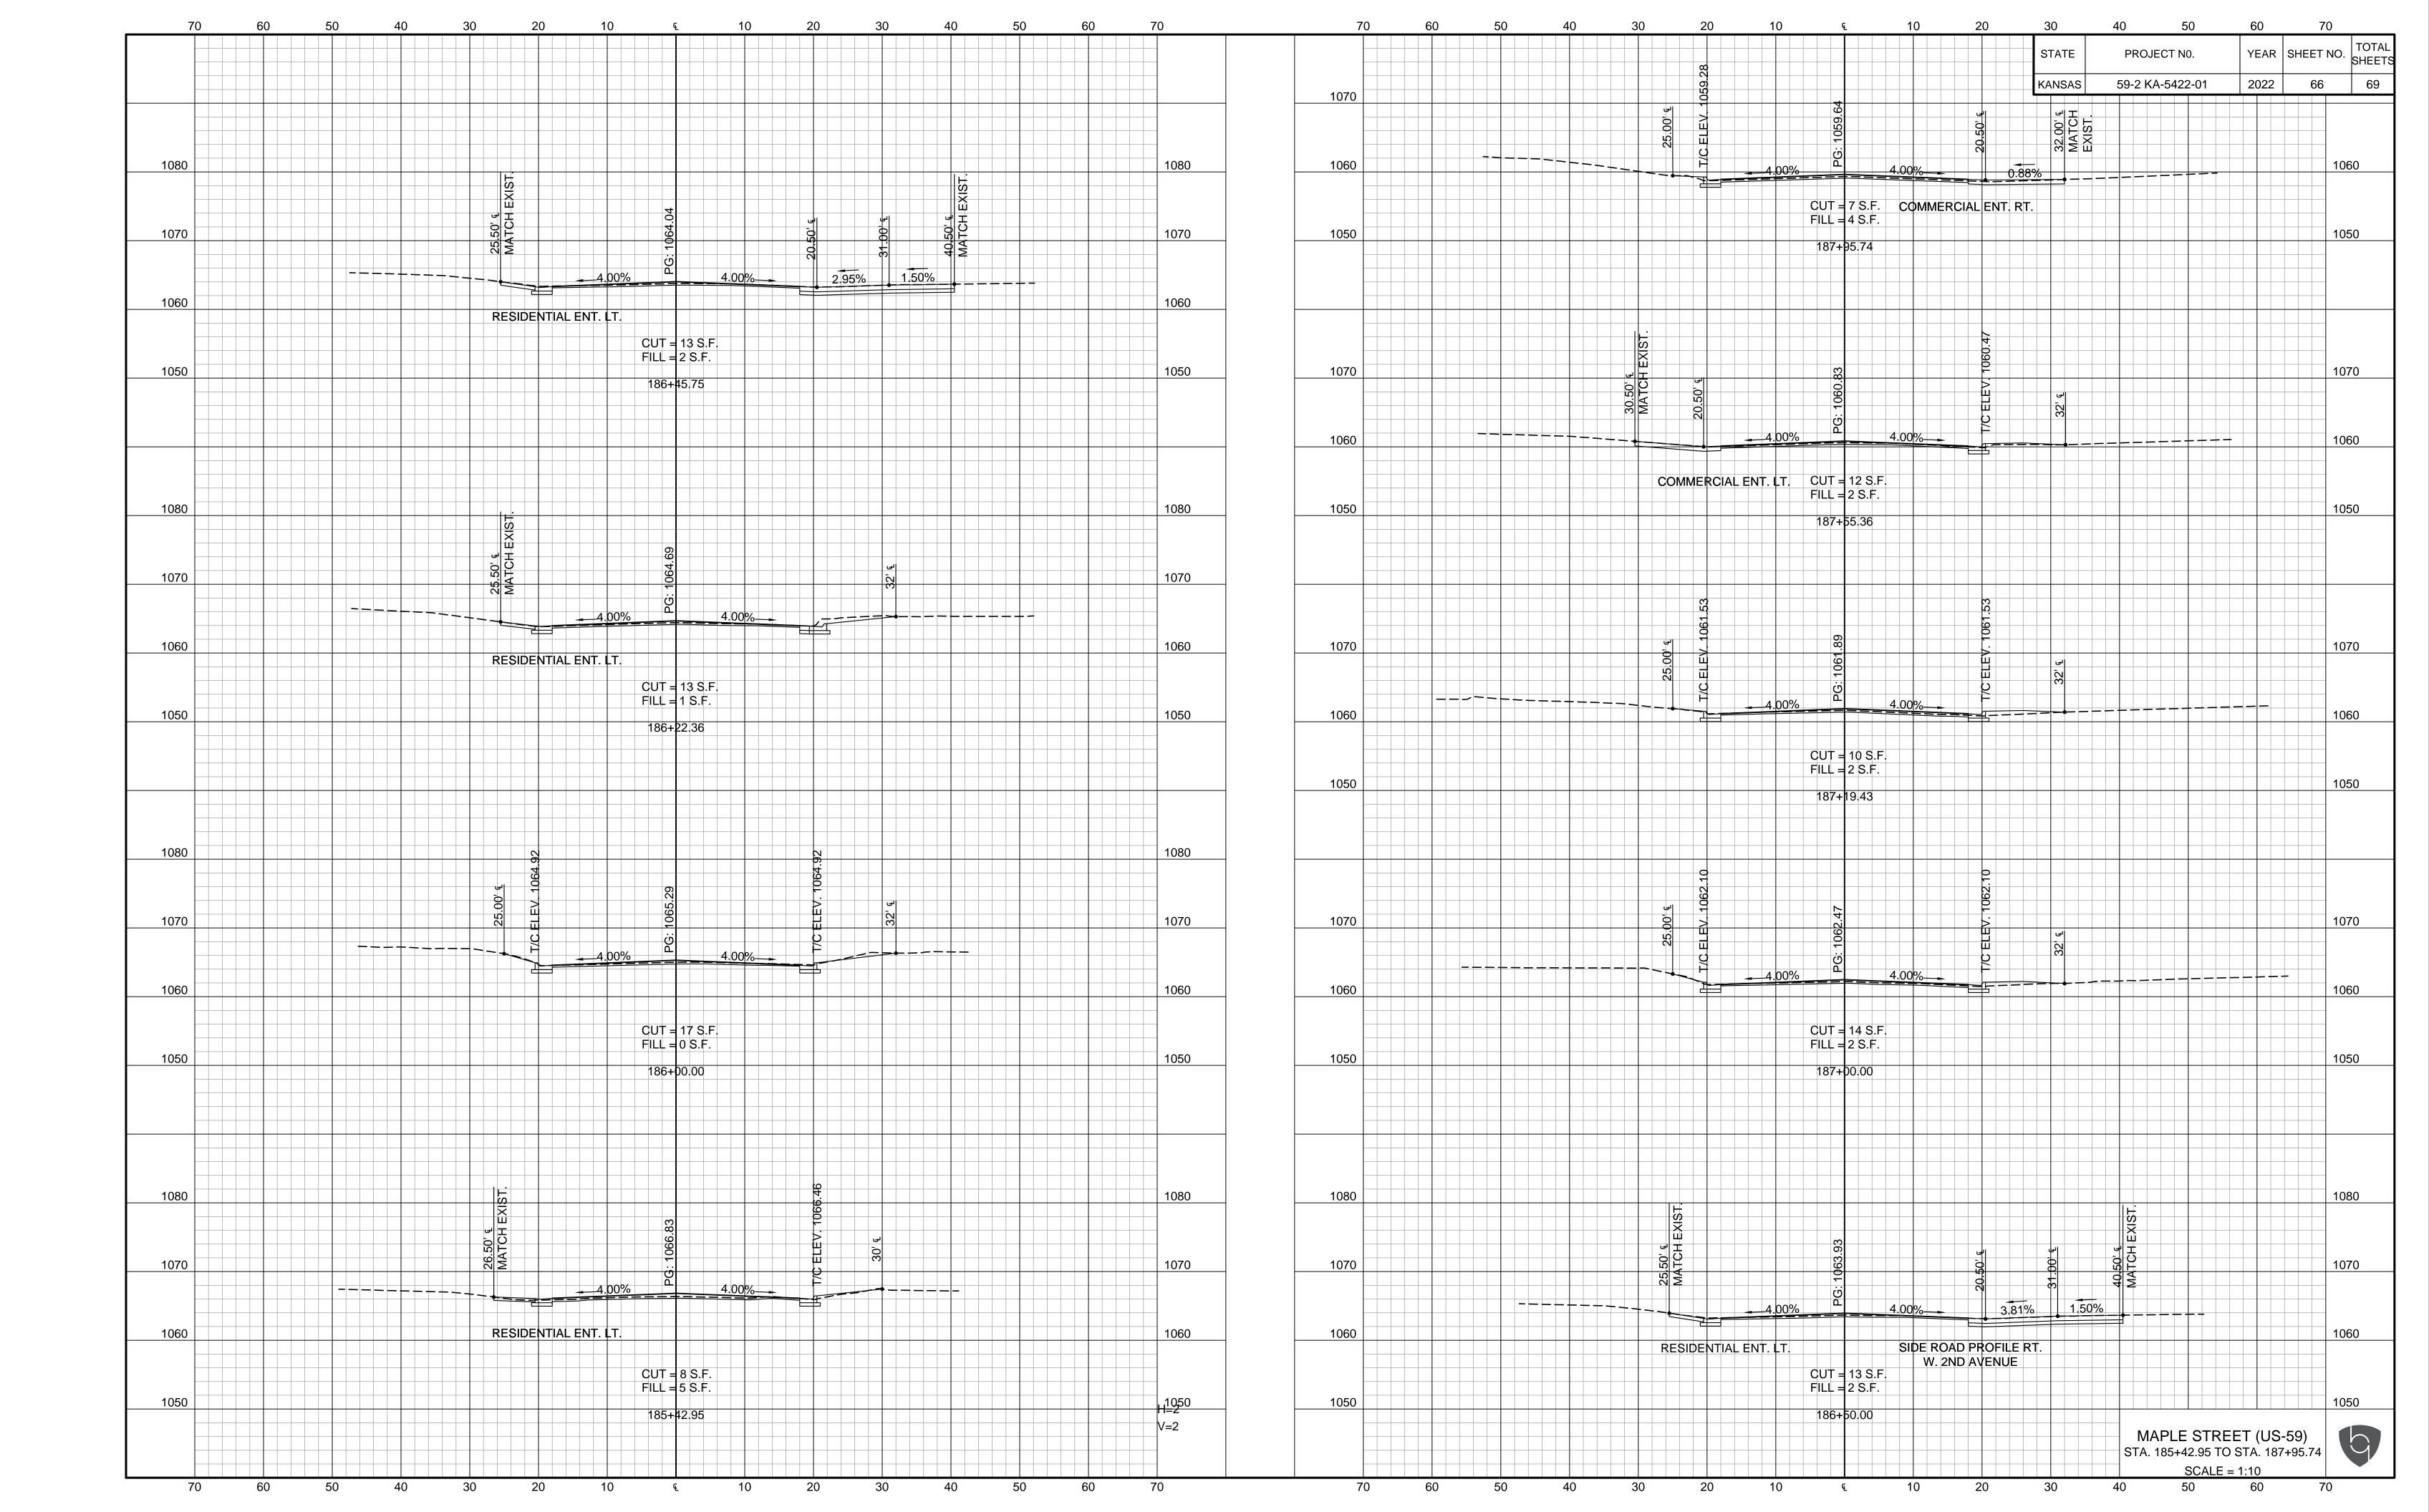

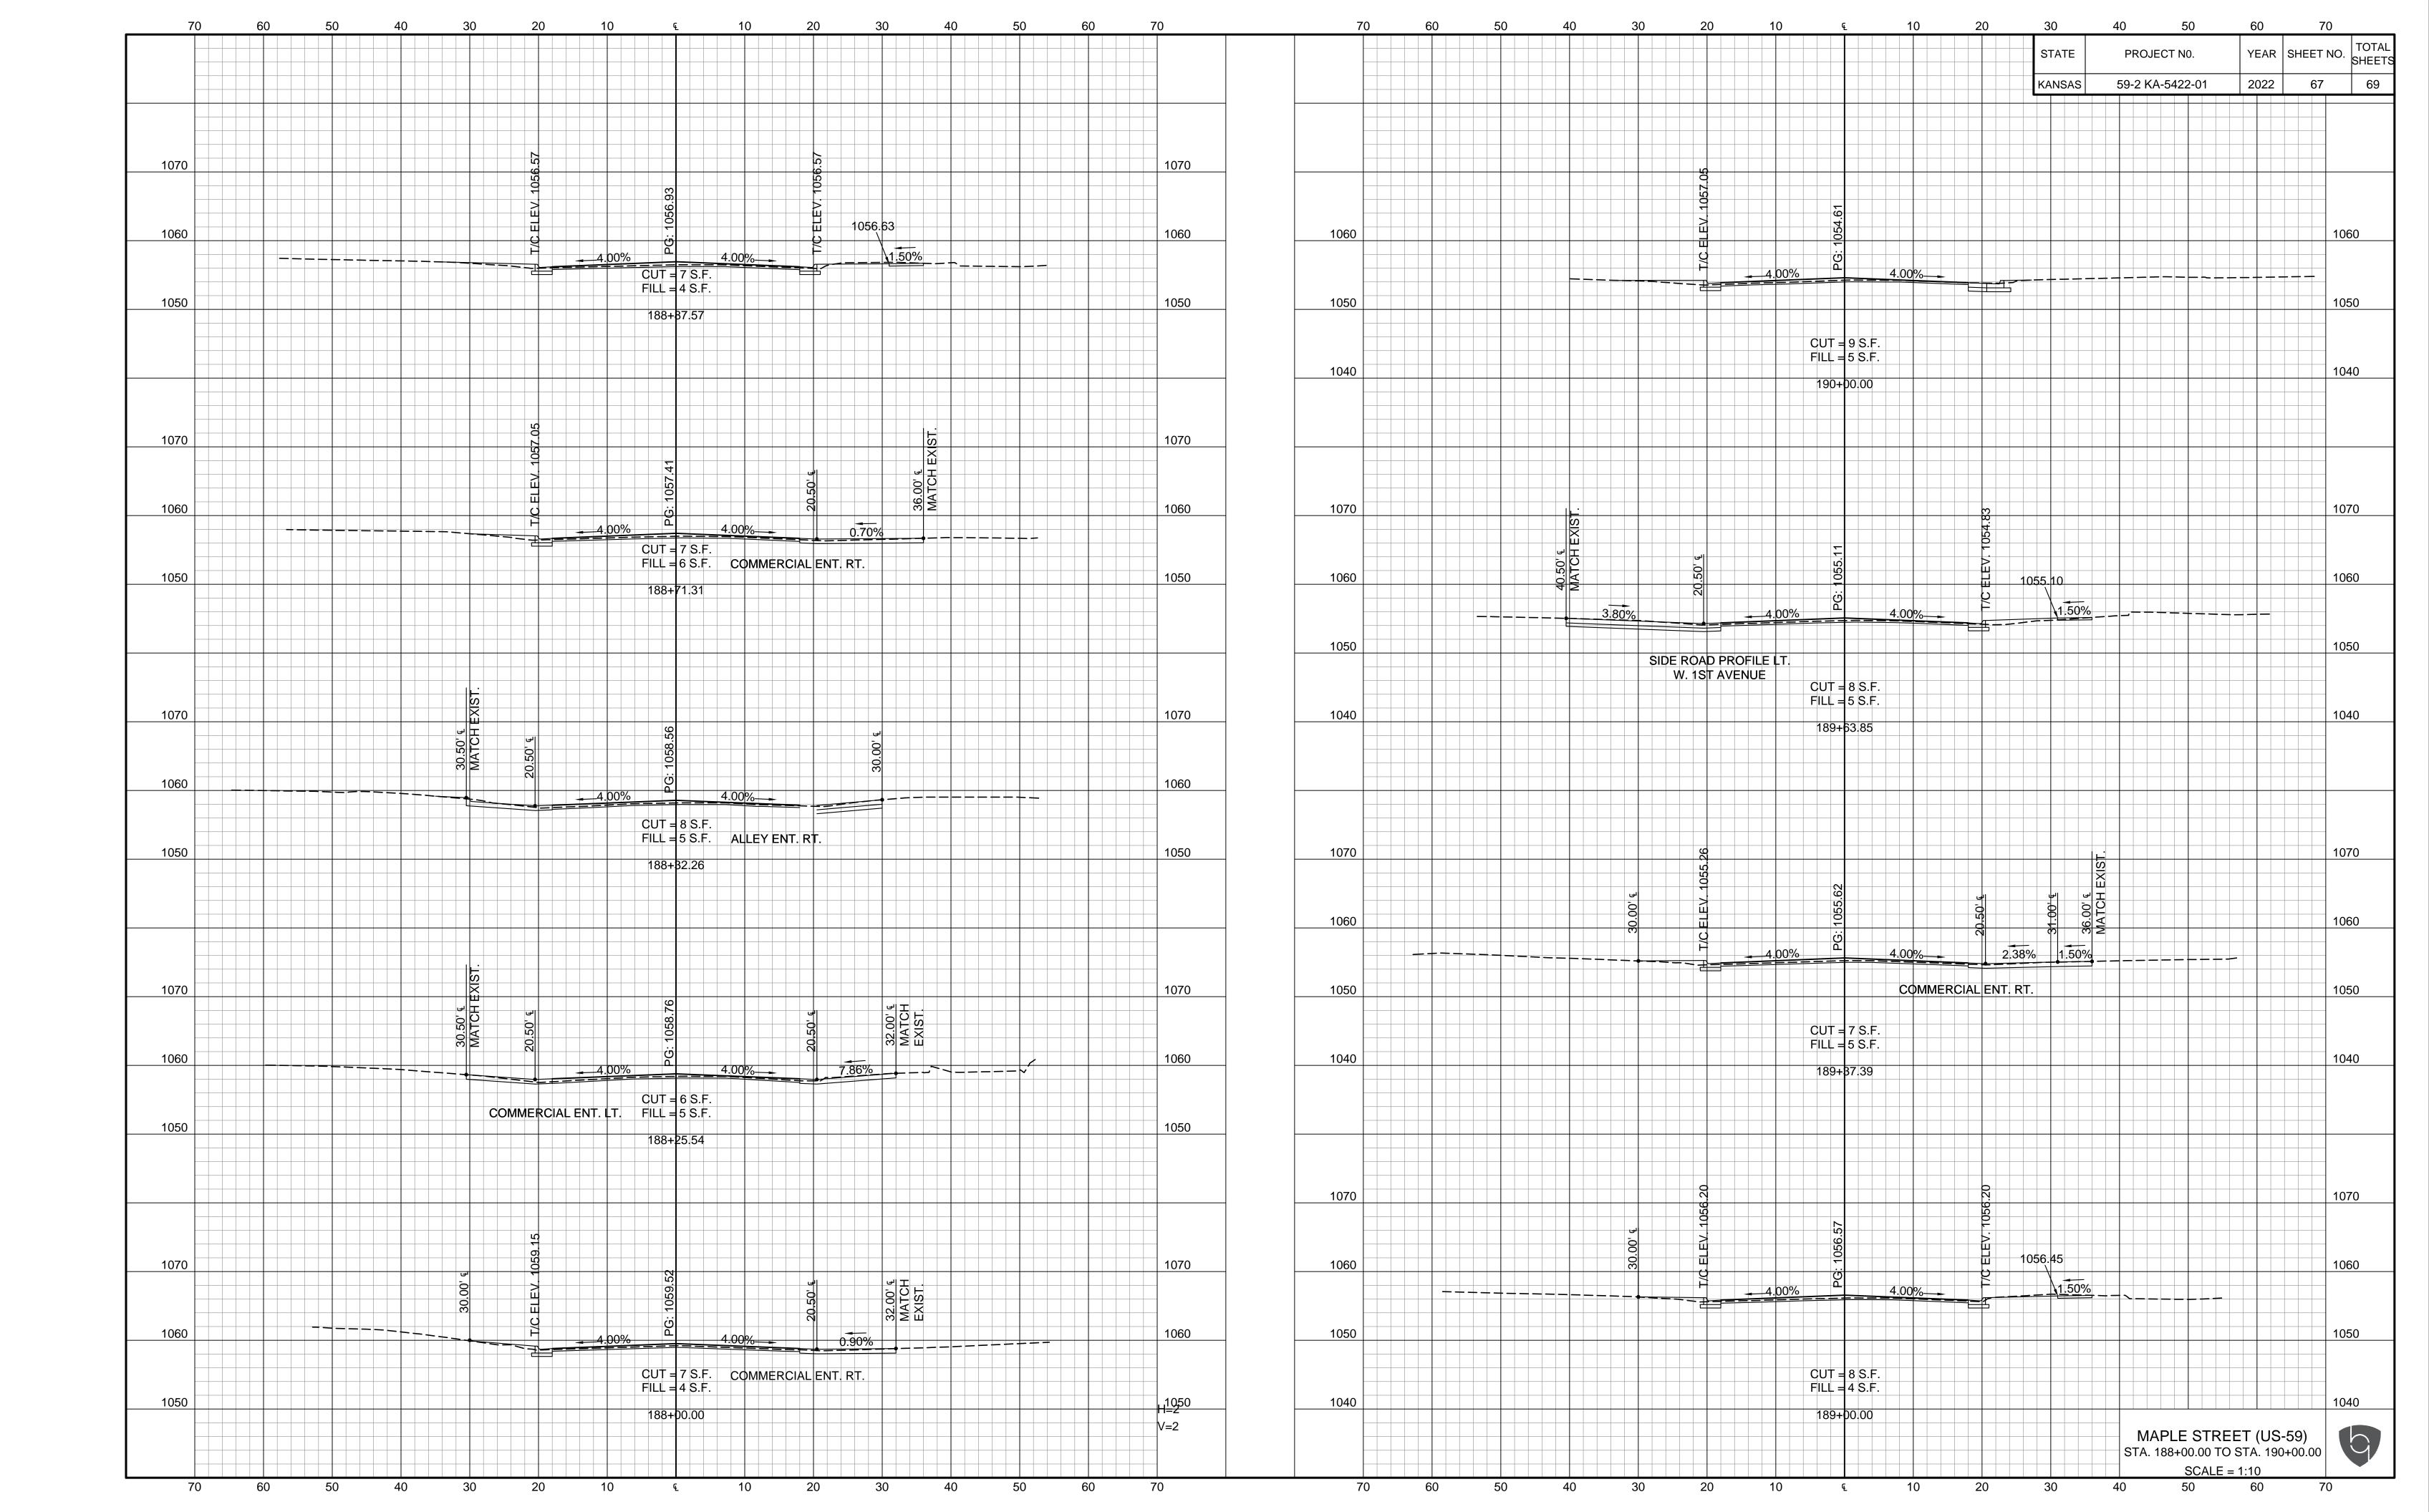

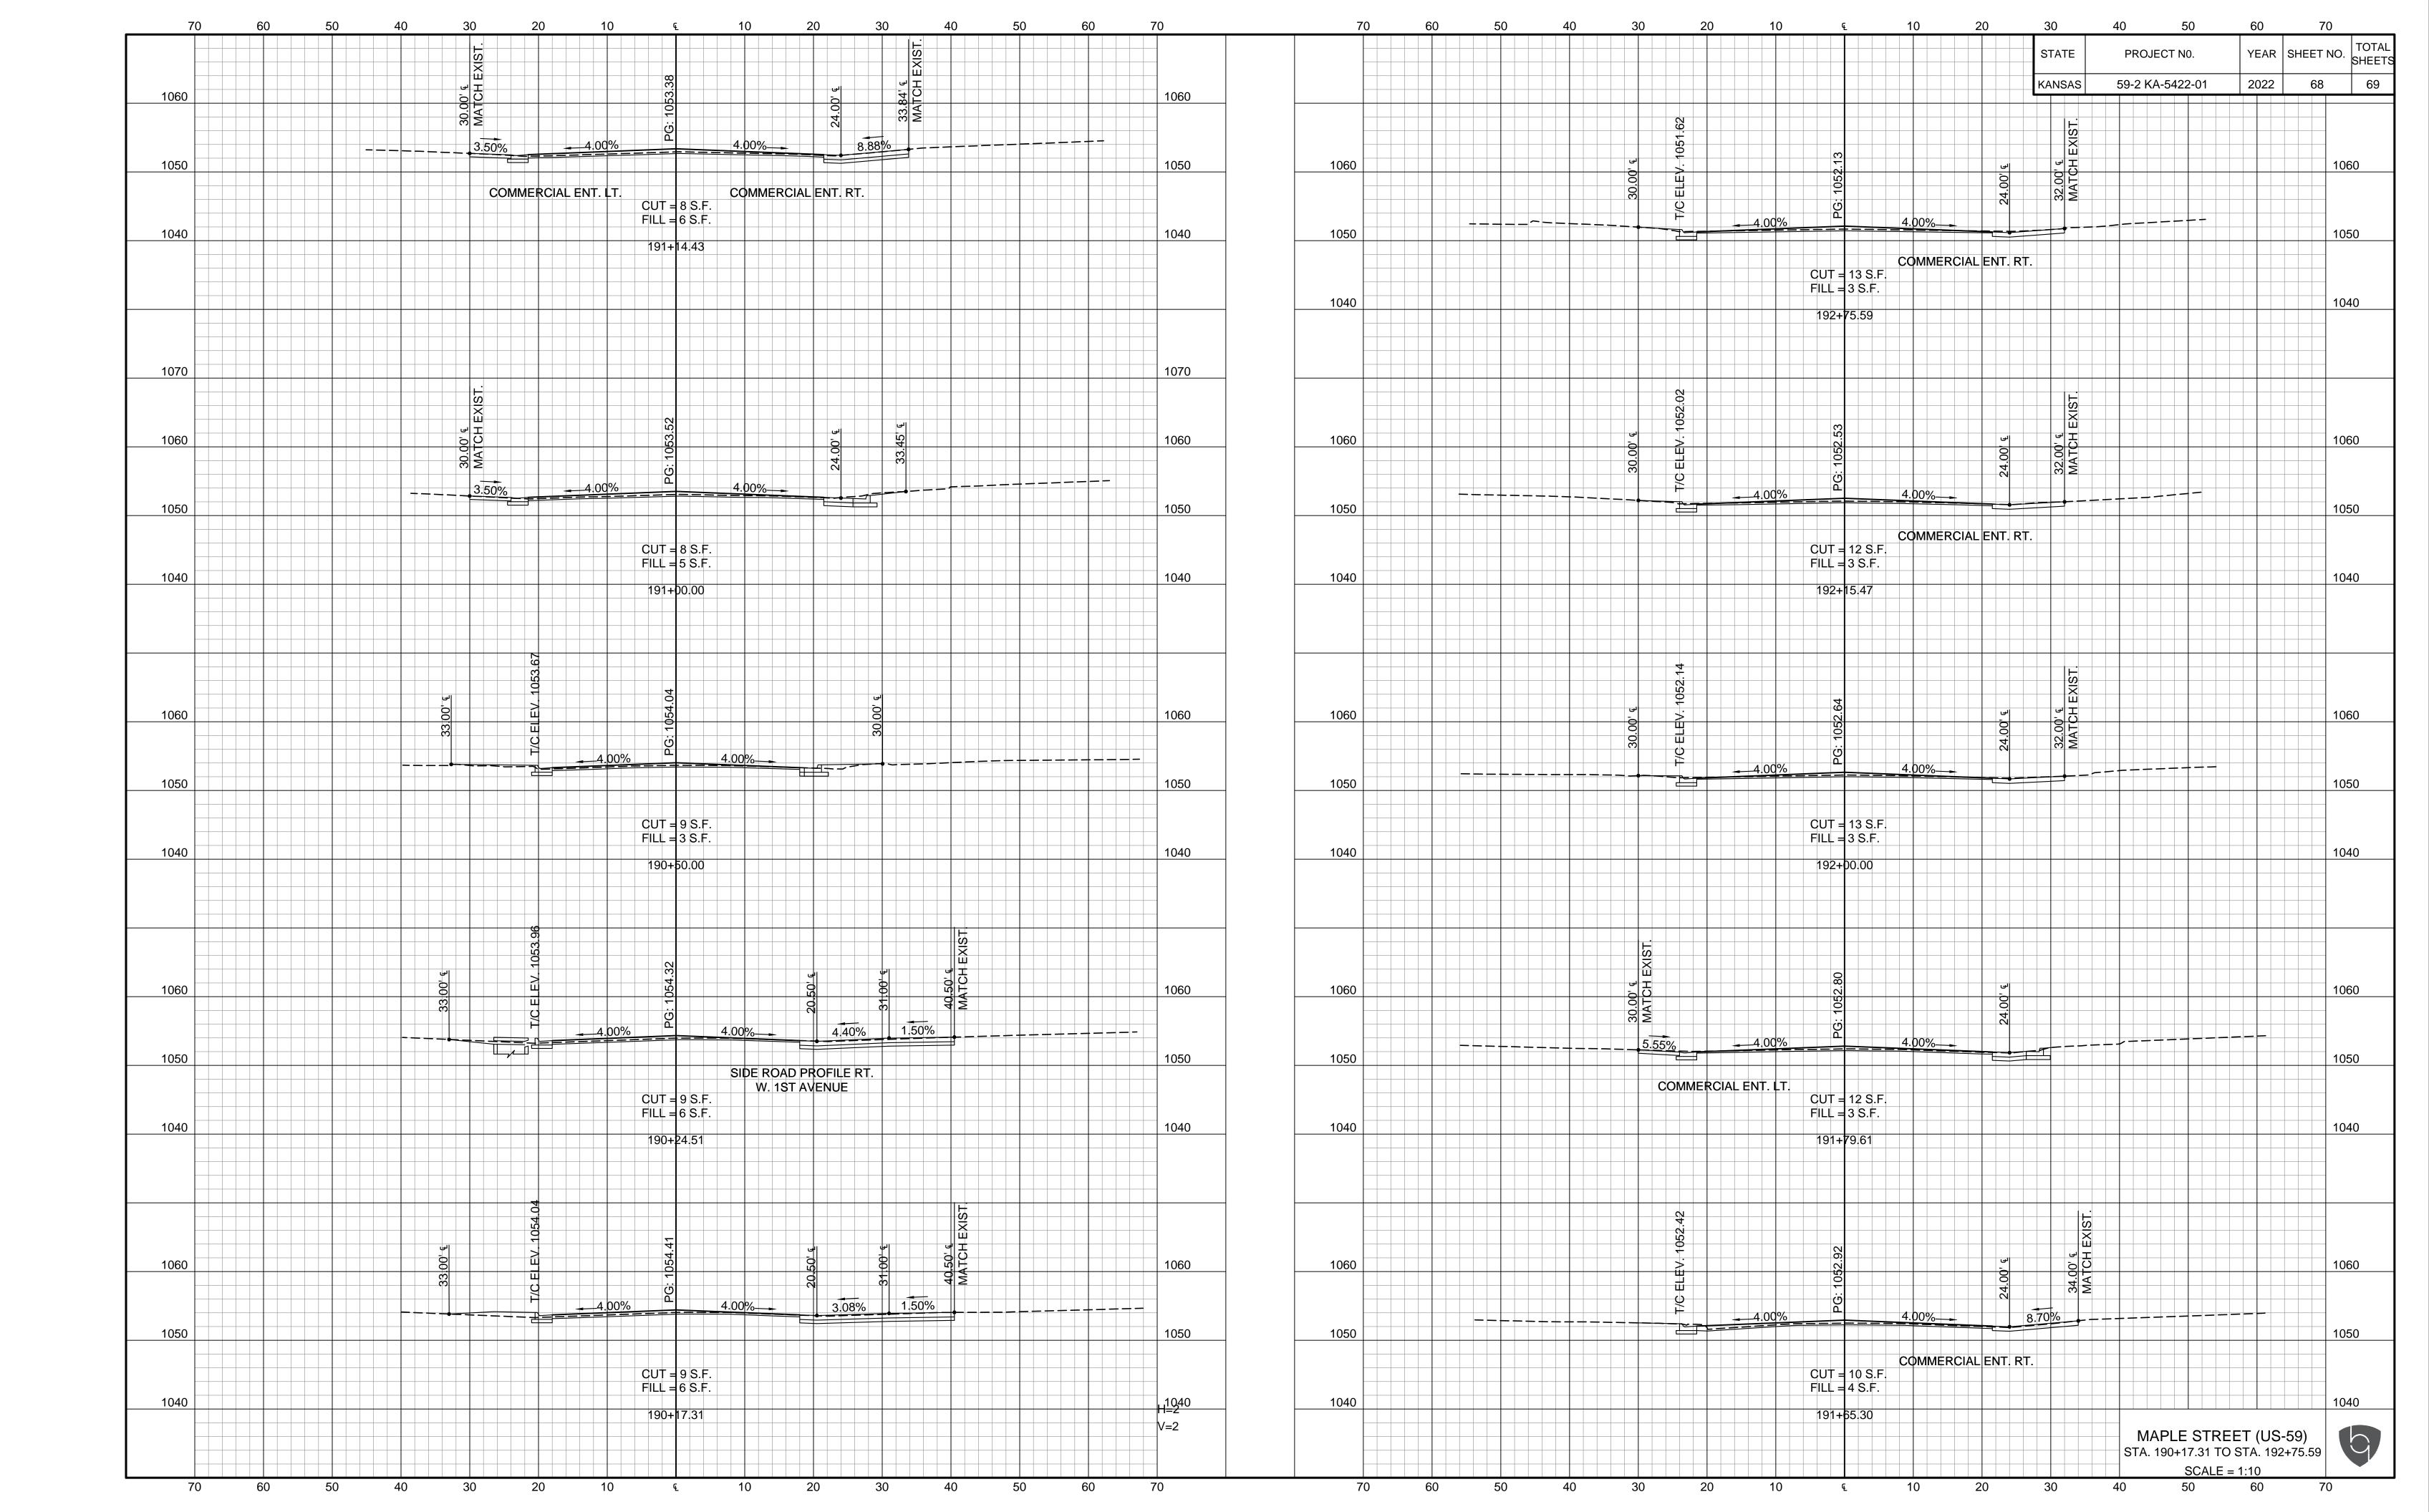

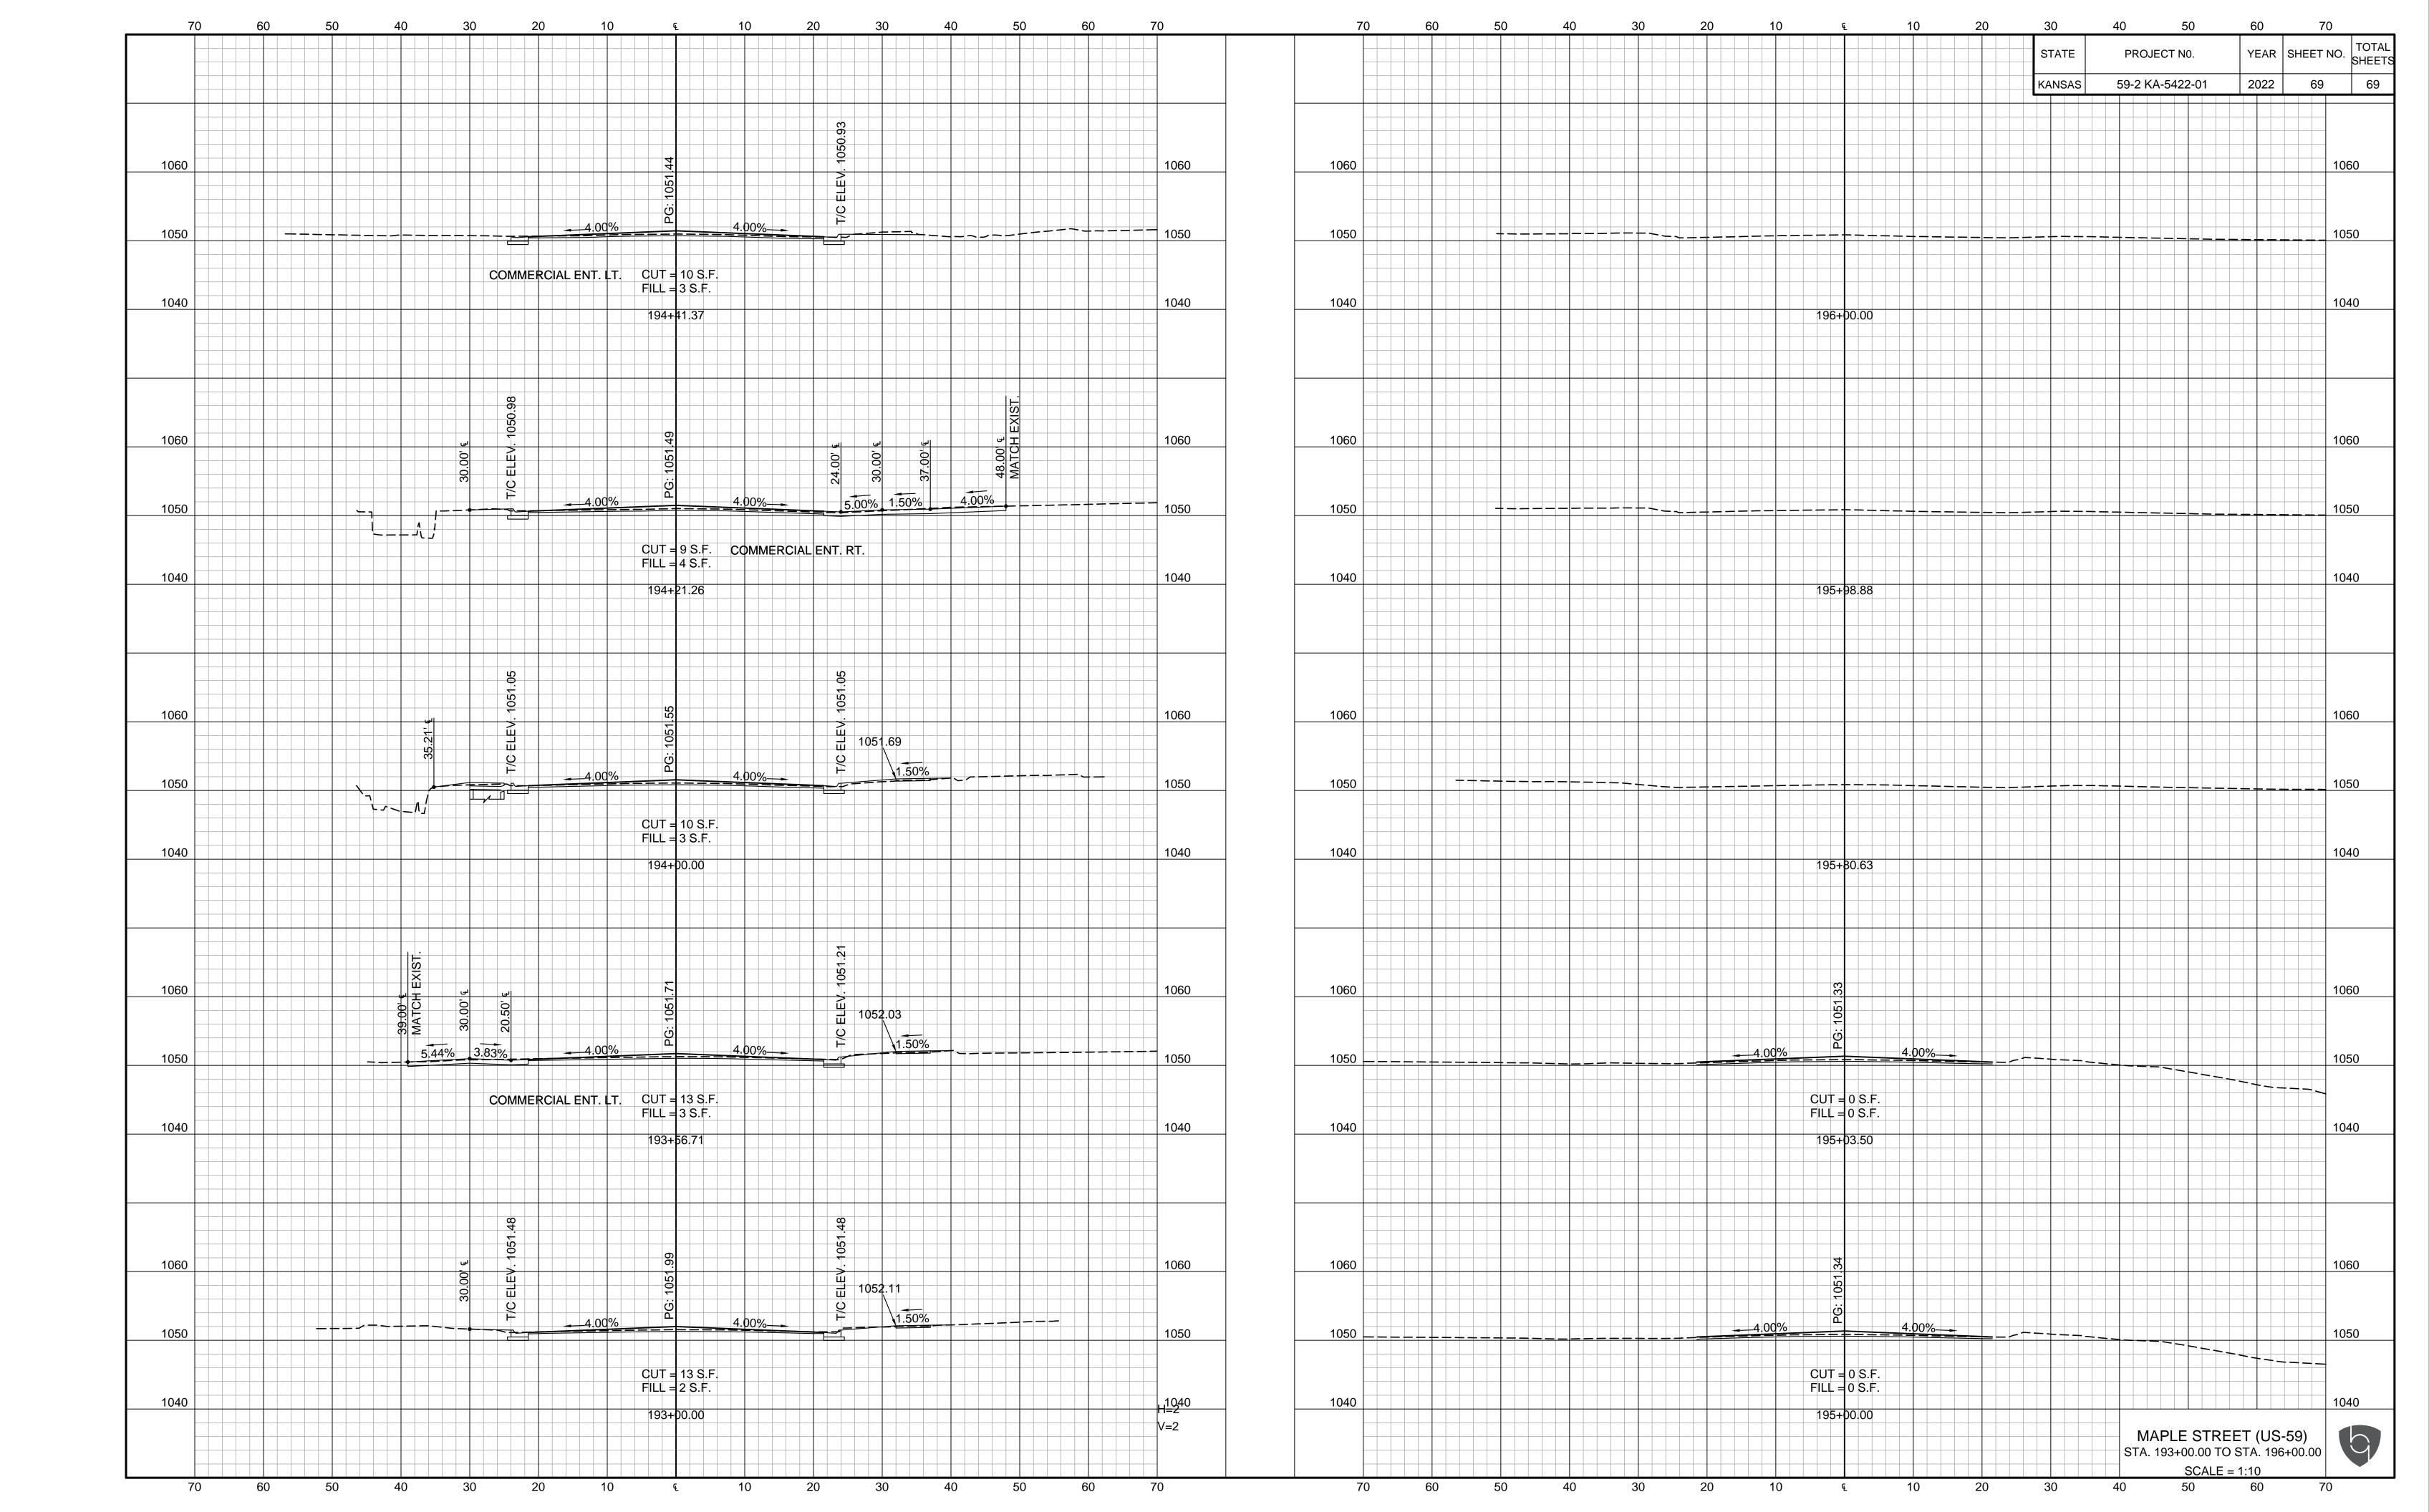



CCLIP Pavement Replacement Project (N. Maple Street (US-59) from 4th Avenue to Rosebud Ave) Engineer's Opinion of Probable Construction Costs - OFFICE CHECK

City of Garnett, Kansas

KDOT Project #: 59-2 KA-5422-01 BG Consultants, Inc. Project #19-1514L

June 3, 2022

No	Description Suite 3, 2022	Oty.	<u>Units</u>		Unit Price		Total Price
	Contractor Construction Staking	<u>Uty.</u> 1	L.S.	\$	10,000.00	\$	10,000.00
2.	Field Office and Laboratory (Type A)	1	L.S.	\$	6,500.00	\$	6,500.00
3.	Foundation Stabilization (Set Price)	1	C.Y.	\$	40.00	\$	40.00
4.	Mobilization	1	L.S.	\$	80,000.00	\$	80,000.00
5.	Mobilization (DBE)	1	L.S.	\$	5,000.00	\$	5,000.00
6.	Removal of Existing Structures	1	L.S.	\$	40,000.00	\$	40,000.00
7.	Clearing & Grubbing	1	L.S.	\$	10,000.00	\$	10,000.00
8.	Common Excavation (Urb)	225	C.Y.	\$	75.00	\$	16,875.00
9.	Rock Excavation	460	C.Y.	\$	45.00	\$	20,700.00
10.	Compaction of Earthwork (Type A)(MR-5-5)	50	C.Y.	\$	12.00	\$	600.00
11.	Water (Grading)(Set Price)	1	M. Gal.	\$	35.00	\$	35.00
12.	Inlet (Curb)(Setback)	16	Each	\$	6,500.00	\$	104,000.00
13.	Curb and Gutter, Combined (AE)	1,455	L.F.	\$	40.00	\$	58,200.00
14.	Storm Sewer (15")(RCP)	241	L.F.	\$	60.00	\$	14,460.00
15.	Storm Sewer (18")(RCP)	220	L.F.	\$	70.00	\$	15,400.00
16.	Storm Sewer (24")(RCP)	280	L.F.	\$	90.00	\$	25,200.00
17.	Storm Sewer (24")	189	L.F.	\$	100.00	\$	18,900.00
18.	Storm Sewer (30")(RCP)	652	L.F.	\$	100.00	\$	65,200.00
19.	Storm Sewer (7.0 sq. ft.)	152	L.F.	\$	125.00	\$	19,000.00
20.	Storm Sewer (10.0 sq. ft.)	368	L.F.	\$	150.00	\$	55,200.00
	Flowable Fill	47	C.Y.	\$	125.00	\$	5,875.00
	Sidewalk Construction (4")(AE)	156	S.Y.	\$	65.00	\$	10,140.00
	Sidewalk Ramp	61	S.Y.	\$	300.00	\$	18,300.00
	Concrete Pavement (6" Uniform)(AE)	245	S.Y.	\$	75.00	\$	18,375.00
	Concrete Pavement (8" Uniform)(AE)	1,091	S.Y.	\$	95.00	\$	103,645.00
	Concrete Pavement (10" Uniform)(AE)	24	S.Y.	\$	250.00	\$	6,000.00
	PCCP Patching (Full Depth)(9")(Unsound)	124	S.Y.	\$	90.00	\$	11,160.00
	Aggregate Base (AB-3)(6")	1,437	S.Y.	\$	12.00	\$	17,244.00
	Water (Aggregate Base)(Set Price)	1	M. Gal.	\$	35.00	\$	35.00
	Adjustment of Manhole	6	Each	\$	1,500.00	\$	9,000.00
	Milling	6,831	S.Y.	\$	2.50	\$	17,077.50
	HMA-Commercial Grade (Class A)	1,325	Tons	\$	125.00	\$	165,625.00
	HMA-Commercial Grade (Class A)(Patching)	150	Tons L.S.	\$	175.00	\$	26,250.00
	Erosion Control Permanent Sanding	1	L.S. L.S.	\$ \$	20,000.00 8,500.00	\$ \$	20,000.00 8,500.00
	Permanent Seeding Pavement Marking (Multi-Component)(White)(6")	149	L.F.	\$	1.00	\$	149.00
	Pavement Marking (Multi-Component)(Yellow)(4")	1,896	L.F.	\$	1.00	\$	1,896.00
	Pavement Marking (Intersection Grade)(White)(24")	64	L.F.	\$	20.00	\$	1,280.00
	Pavement Marking Symbol (intersection Grade)(White)(Left Arrow)	13	Each	\$	275.00	\$	3,575.00
	Sign Post (1 3/4" PSST)	72	L.F.	\$	20.00	\$	1,440.00
	Sign Post Footing (1 3/4" PSST)	6	Each	\$	60.00	\$	360.00
	Sign (Remove and Reset)	1	L.S.	\$	2,000.00	\$	2,000.00
	Traffic Control	1	L.S.	\$	50,000.00	\$	50,000.00
7 0.	Traine Control	'	L.O.	Ÿ	Subtotal =	\$	1,063,236.50
			+ 1 ()%	Contingency =	\$	106,324.00
			1 11	2 /0	TOTAL =	\$	
					IOIAL -	¥	.,.00,000.00



Gate Schedule for Libertfest

Susan Wettstein <susan@garnettks.net>

Sat, Jun 4, 2022 at 12:18 PM

To: Greg Gwin <ggwin@garnettks.net>, Greg Gwin <greg@gencomanufacturing.com>, Jody Cole <jcole@garnettks.net>, Jason Sheahan <jsheahan@garnettks.net>

Cc: Travis Wilson <twilson@garnettks.net>, Kris Hix <kris@garnettks.net>

Dear City Commission,

The annual Libertyfest Fireworks Celebration will take place on Saturday, July 2nd. Tentative rain date would be July 9th. We are working on getting volunteers to take donations at the entrance to the North Lake Park. Any city employees that volunteer to help do so without pay. If you would like to help for an hour please let me know. In the past we have enjoyed having the Commission help with this and hope you have too.

We have committed to the purchase of \$6,000 of fireworks, which also includes the certified shooters, their insurance, etc. This event is funded through donations, not tax dollars.

Here is the tentative schedule for gate donation takers for Saturday, July 2nd - Libertyfest:

5:00 - 6:00 p.m. -

6:00 - 7:00 p.m. -

7:00 - 8:00 p.m. -

8:00 - 9:00 p.m. -

*We can adjust if someone else wants to help! Would like to have 3-4 people each shift. Appreciate ALL the volunteer help!

If you have any questions please contact Travis or myself.

Link on City's website: https://www.simplygarnett.com/community-fireworks.html

Facebook event: https://fb.me/e/55Jecjy2S

Thank you,

Susan

Susan Wettstein

Director of Community Development & Tourism

E-mail: susan@garnettks.net



Telephone: 785.448.5496, Option 7



Fwd: Replacement Recloser

Troy Hart <troy@garnettks.net> To: Travis Wilson <twilson@garnettks.net> Wed, Jun 8, 2022 at 1:02 PM

----- Forwarded message ------

From: Josh Schmaderer < jschmaderer@kmea.com>

Date: Tue, May 10, 2022 at 9:24 AM Subject: Replacement Recloser To: Troy Hart troy@garnettks.net>

Cc: Mike Schmaderer <mschmaderer@kmea.com>, Sharon Schmaderer <sschmaderer@kmea.com>

Troy,

Our opinion of probable cost which is based on our experience with prior projects would be \$58,000 to acquire and install a new recloser on your incoming 34.5kV feed. The recloser is \$33,000 with a 26 week lead time currently. Our estimate at labor is \$25,000. However, the project will be invoiced on a time and material basis using our standard rate schedule.

Let me know if you have any question or need anything else.

Thanks,

Joshua Schmaderer