

LEGEND			
	PROPOSED CONTOURS	ø	EXISTING UTILITY POLE
	PROPOSED GRASS LINED DRAINAGE DITCH	nanazionaniananiananiananiana nonan Azarta kuutumanianianianianianiani	PROPERTY LINE (APPROX.)
200	AS-BUILT CONTOURS	<u>X</u> X X X X X	FENCE LINE
	EXISTING NATURAL CONTOURS	~~~~~~~~~~~~~~~~~~~~~~~~~~~~~~~~~~~~~~~	LIMIT OF TREES OR SHRUBS
	EXISTING SURFACE DRAINAGE		PROPOSED ACCESS ROAD
สมรัตการของการการครั้ง สมสัตภาคมายสุดการครั้งการการการการการการการการการการการการการก	LIMIT OF WASTE		EXISTING ACCESS ROAD
-	EXISTING GROUNDWATER MONITORING WELL	88299 I (88299999). I (88299999) I (88299999) I (88299	PROJECT LIMIT LINE
Ø	PROPOSED METHANE GAS VENT	DETAIL ID	<i>entification no.</i> ITIF
	TAIL IDENTIFICATION NO. WEET NO. WHERE DETAIL IS SHOWN		WHERE DETAIL IS CALLED OUT

TOWN OF UNION VALE SANITARY LANDFILL CLOSURE DUTCHESS COUNTY, NEW YORK

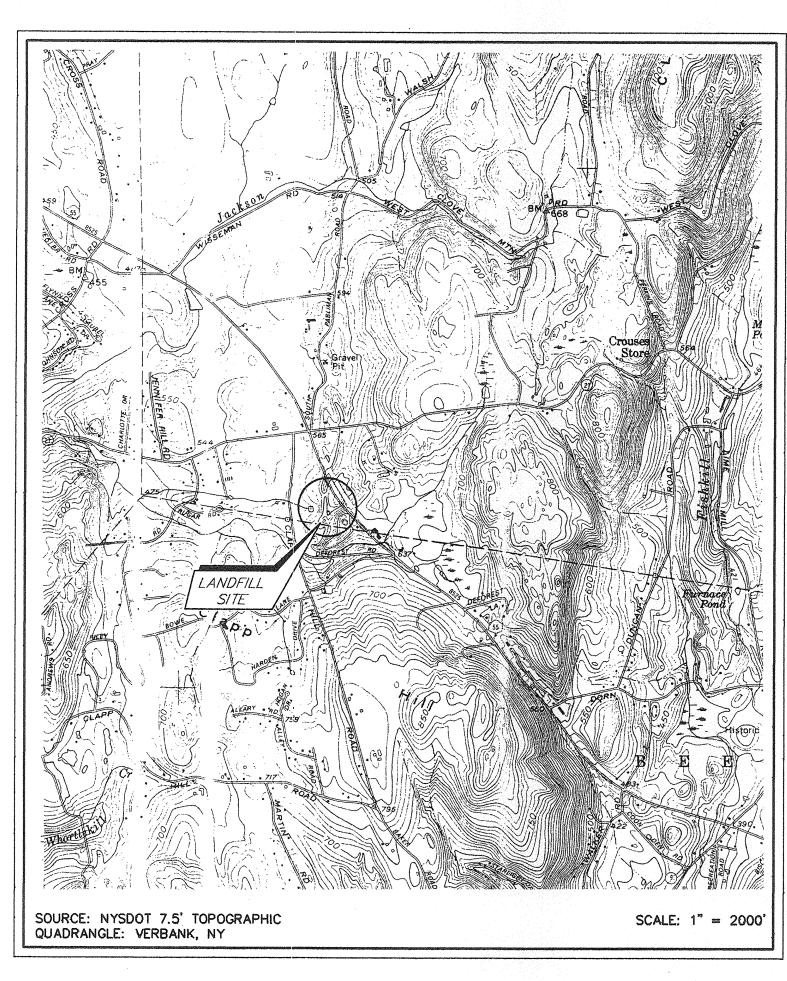

SITE LOCATION MAP

NOVEMBER 1994

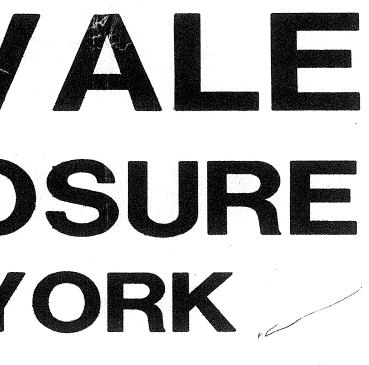

GENERAL NOTES:

- 1. IT IS RECOMMENDED THAT THE CONTRACTOR INSPECT THE SITE PRIOR TO BID SO THAT THE EXTENT OF VARIANCE OF ACTUAL GROUND FEATURES WITH THOSE SHOWN ON THE PLANS MAY BE REFLECTED IN THE BID.
- 2. CONTRACTOR SHALL LAY OUT LIMIT OF WASTE AND CONSTRUCTION GRID AS SHOWN ON THE DRAWINGS. LAYOUT TO BE VERIFIED BY THE ENGINEER IN THE FIELD.
- 3. THE CONTRACTOR SHALL CONDUCT ALL CONSTRUCTION ACTIVITIES IN SUCH A MANNER TO PROVIDE FOR RUNOFF AND PREVENT PONDING OF WATER OVER THE LANDFILL SURFACE AT ALL TIMES.
- 4. PROTECT ALL EXISTING MONITORING WELLS FROM DAMAGE DURING CONSTRUCTION. ANY DAMAGED WELLS SHALL BE REPLACED BY THE CONTRACTOR AT NO ADDITIONAL COST TO OWNER.
- 5. THE CONTRACTOR SHALL PROVIDE FOR GENERAL EROSION CONTROL DURING CONSTRUCTION IN ACCORDANCE WITH THE TECHNICAL SPECIFICATIONS. SILT FENCING AND HAY BALES SHALL BE INSTALLED AS INDICATED. HAY BALES SHALL BE TIGHTLY BOUND FRESH HAY. NO ROTTED OR MILDEWED HAY OR BINDING WILL BE ACCEPTED.
- 6. ALL COVER LAYER THICKNESSES SHALL BE MEASURED PERPENDICULAR TO THE GROUND SURFACE.
- 7. ALL INSTALLATION PROCEDURES AND QA/QC TESTING FOR MATERIALS USED IN THE CONSTRUCTION SHALL BE IN ACCORDANCE WITH THE TECHNICAL SPECIFICATIONS FOR THE PROJECT. ALL QA/QC TESTING SHALL BE PROVIDED BY THE CONTRACTOR WHO SHALL COORDINATE HIS SCHEDULE AND COOPERATE FULLY WITH ALL TESTING PROCEDURES.
- 8. ALL CONSTRUCTION SHALL BE PERFORMED UNDER THE OBSERVATION OF A REPRESENTATIVE OF A PROFESSIONAL ENGINEER LICENSED IN THE STATE OF NEW YORK.
- 9. RECORD DRAWINGS SHALL BE PREPARED BY THE CONTRACTOR FOR SUBMISSION TO THE ENGINEER IN ACCORDANCE WITH THE GENERAL REQUIREMENTS OF THIS CONTRACT.
- 10. CONTRACTOR WILL BE RESPONSIBLE FOR MAINTENANCE OF COVER SYSTEM STABILITY, EROSION CONTROL, DAMAGE, AND ESTABLISHMENT OF VEGETATIVE GROWTH FOR 12 MONTHS AFTER FINAL ACCEPTANCE OF THE PROJECT.
- 11. CONTRACTOR SHALL CLEAR AND GRUB ALL AREAS WITHIN THE PROJECT LIMIT LINE 12. OWNER SHALL OBTAIN ALL REQUIRED WORK PERMITS AND INSURANCE FOR WORK IN NYSDOT RIGHT-OF-WAY.
- 13. ALL AREAS DISTURBED DURING PERFORMANCE OF THE WORK SHALL BE TOPSOILED, SEEDED AND MULCHED IN ACCORDANCE WITH THE CONTRACT DOCUMENTS.
- 14. CONTRACTOR SHALL LIMIT THE PLAN AREA OF THE WASTE EXCAVATION AND FILL LOCATIONS AS REQUIRED TO MINIMIZE ODORS AND THE RELEASE OF VOLATILE ORGANIC
- 15. A MINIMUM OF 6 INCHES OF DAILY COVER SHALL BE PLACED ON ANY EXPOSED OR DISTURBED WASTE AT THE END OF EACH DAY.

DRAWING INDEX

COMPOUNDS.


- TOPOGRAPHIC BASE MAP G-1
- G-2 WASTE GRADING PLAN
- FINAL CLOSURE PLAN G-3
- GENERAL DETAILS G-4
- GENERAL DETAILS G-5
- GENERAL DETAILS G-6
- MPT-1 MAINTENANCE & PROTECTION OF TRAFFIC







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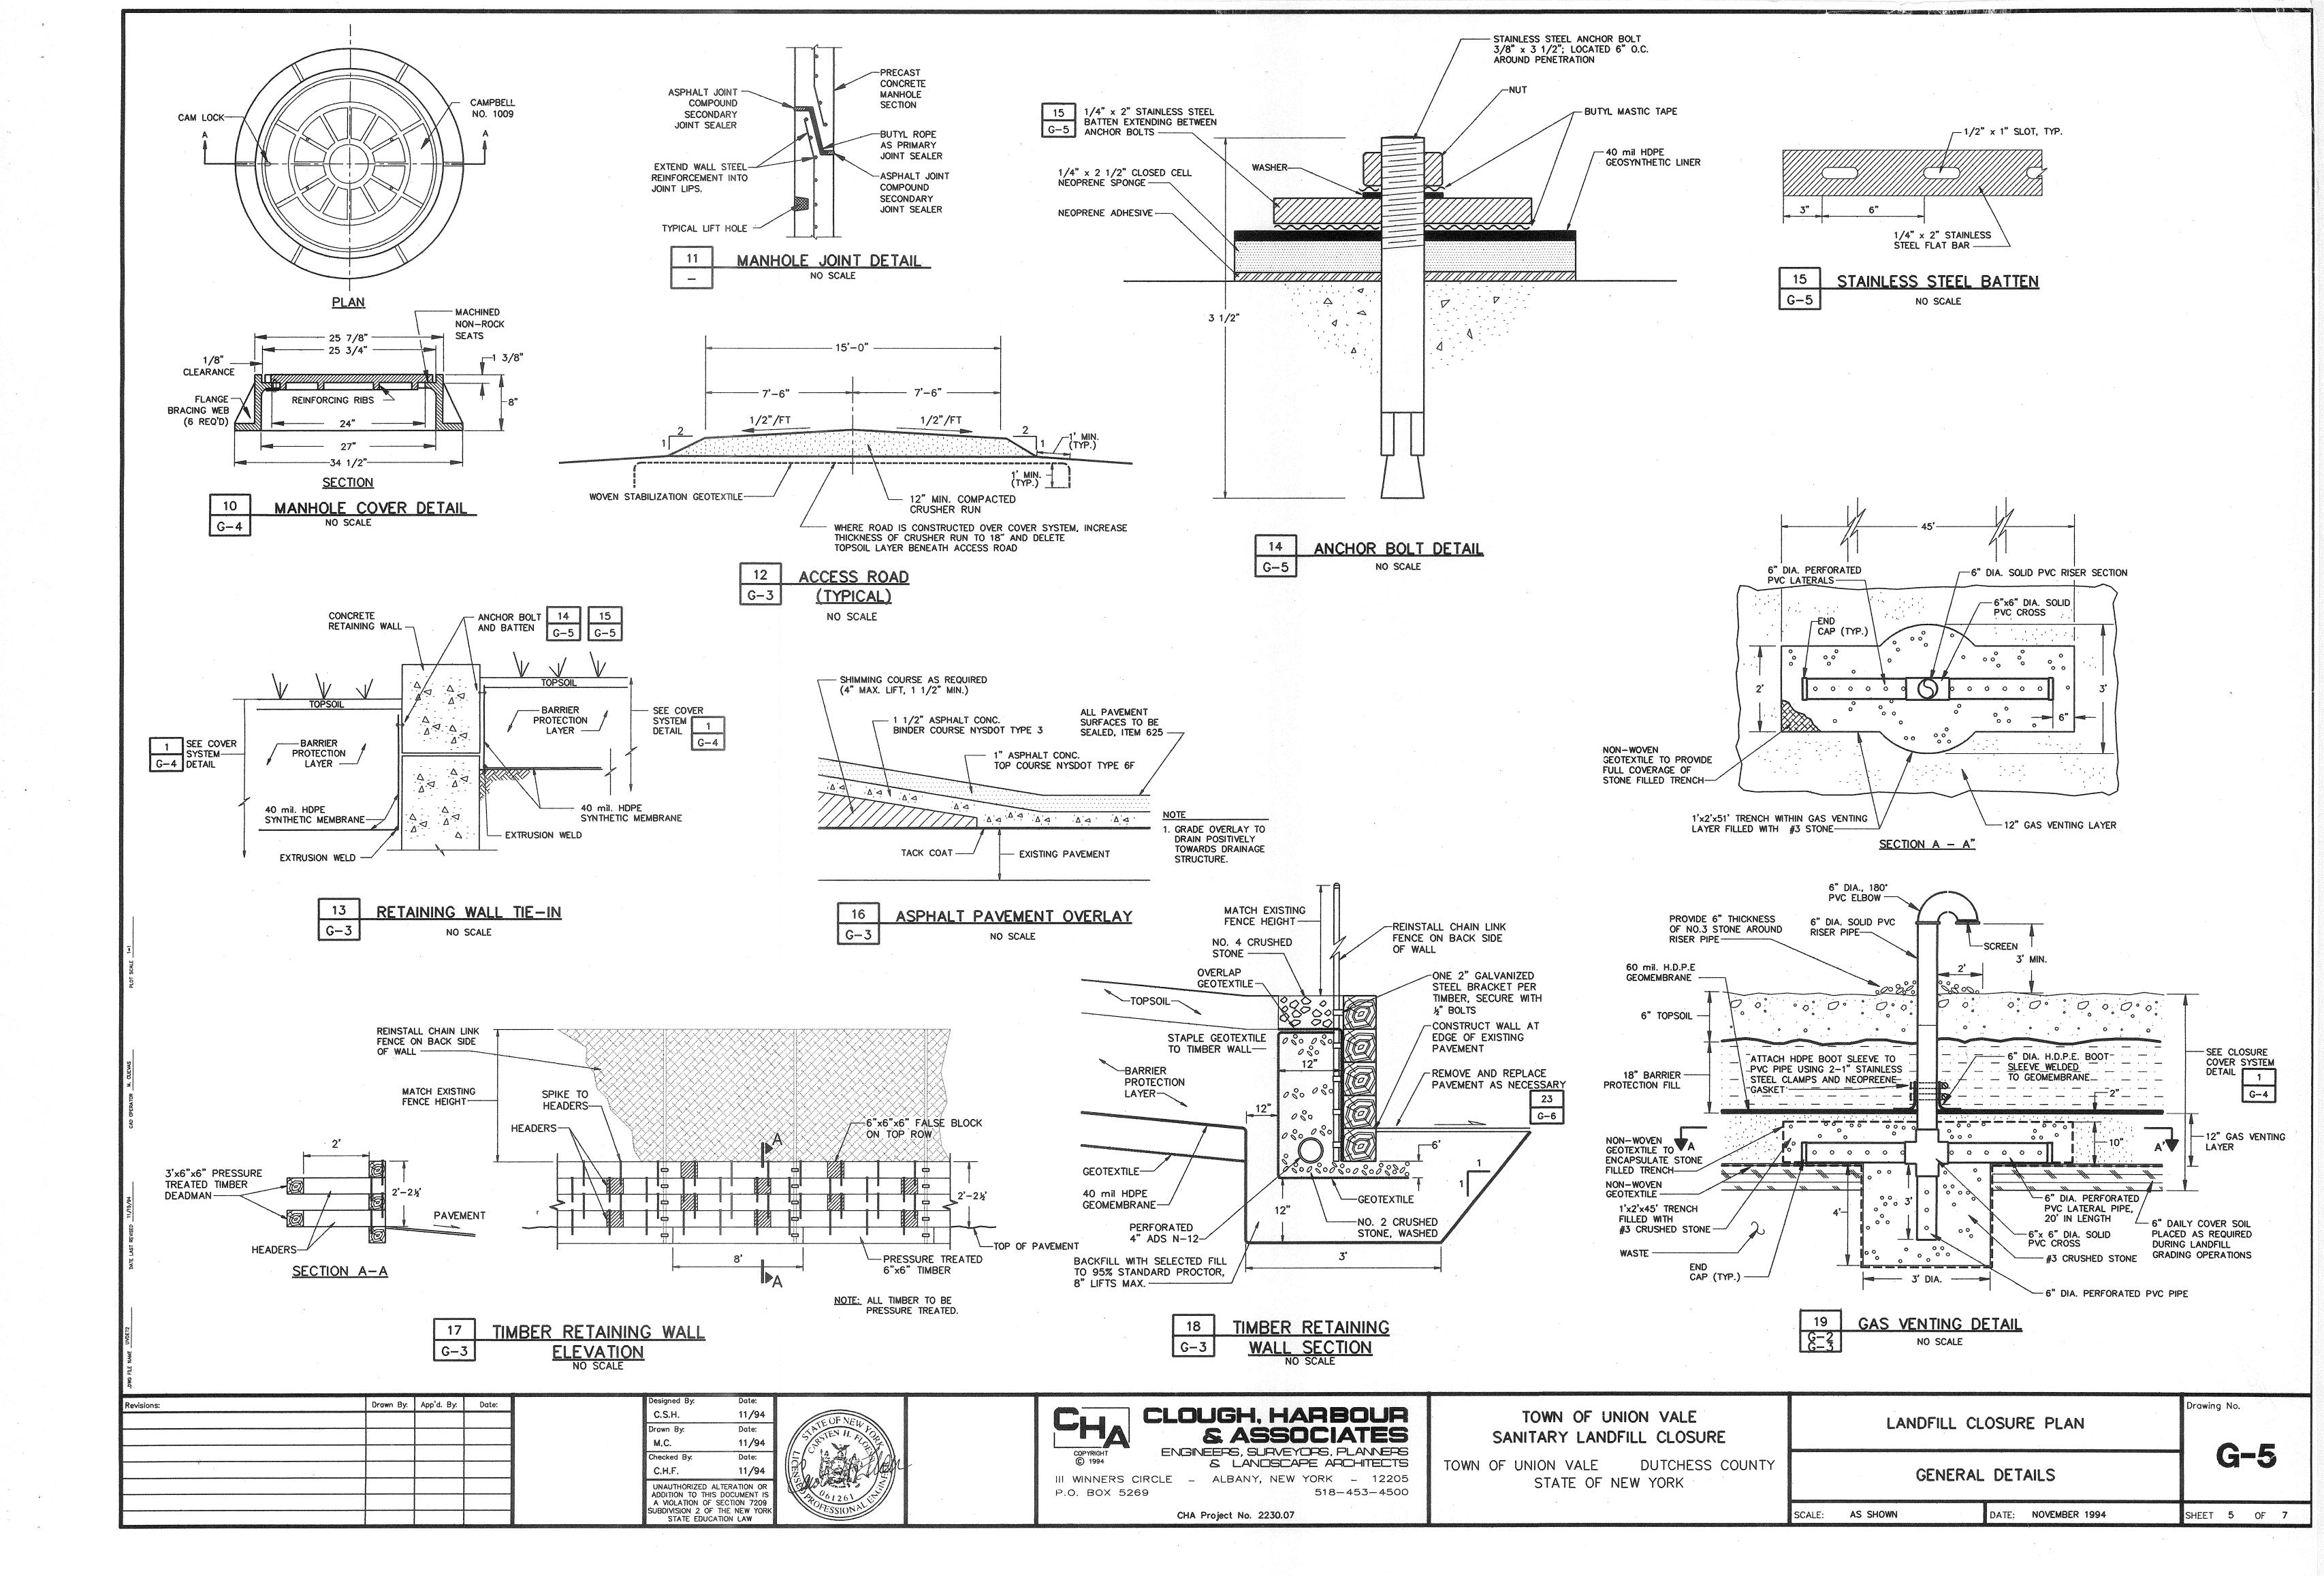
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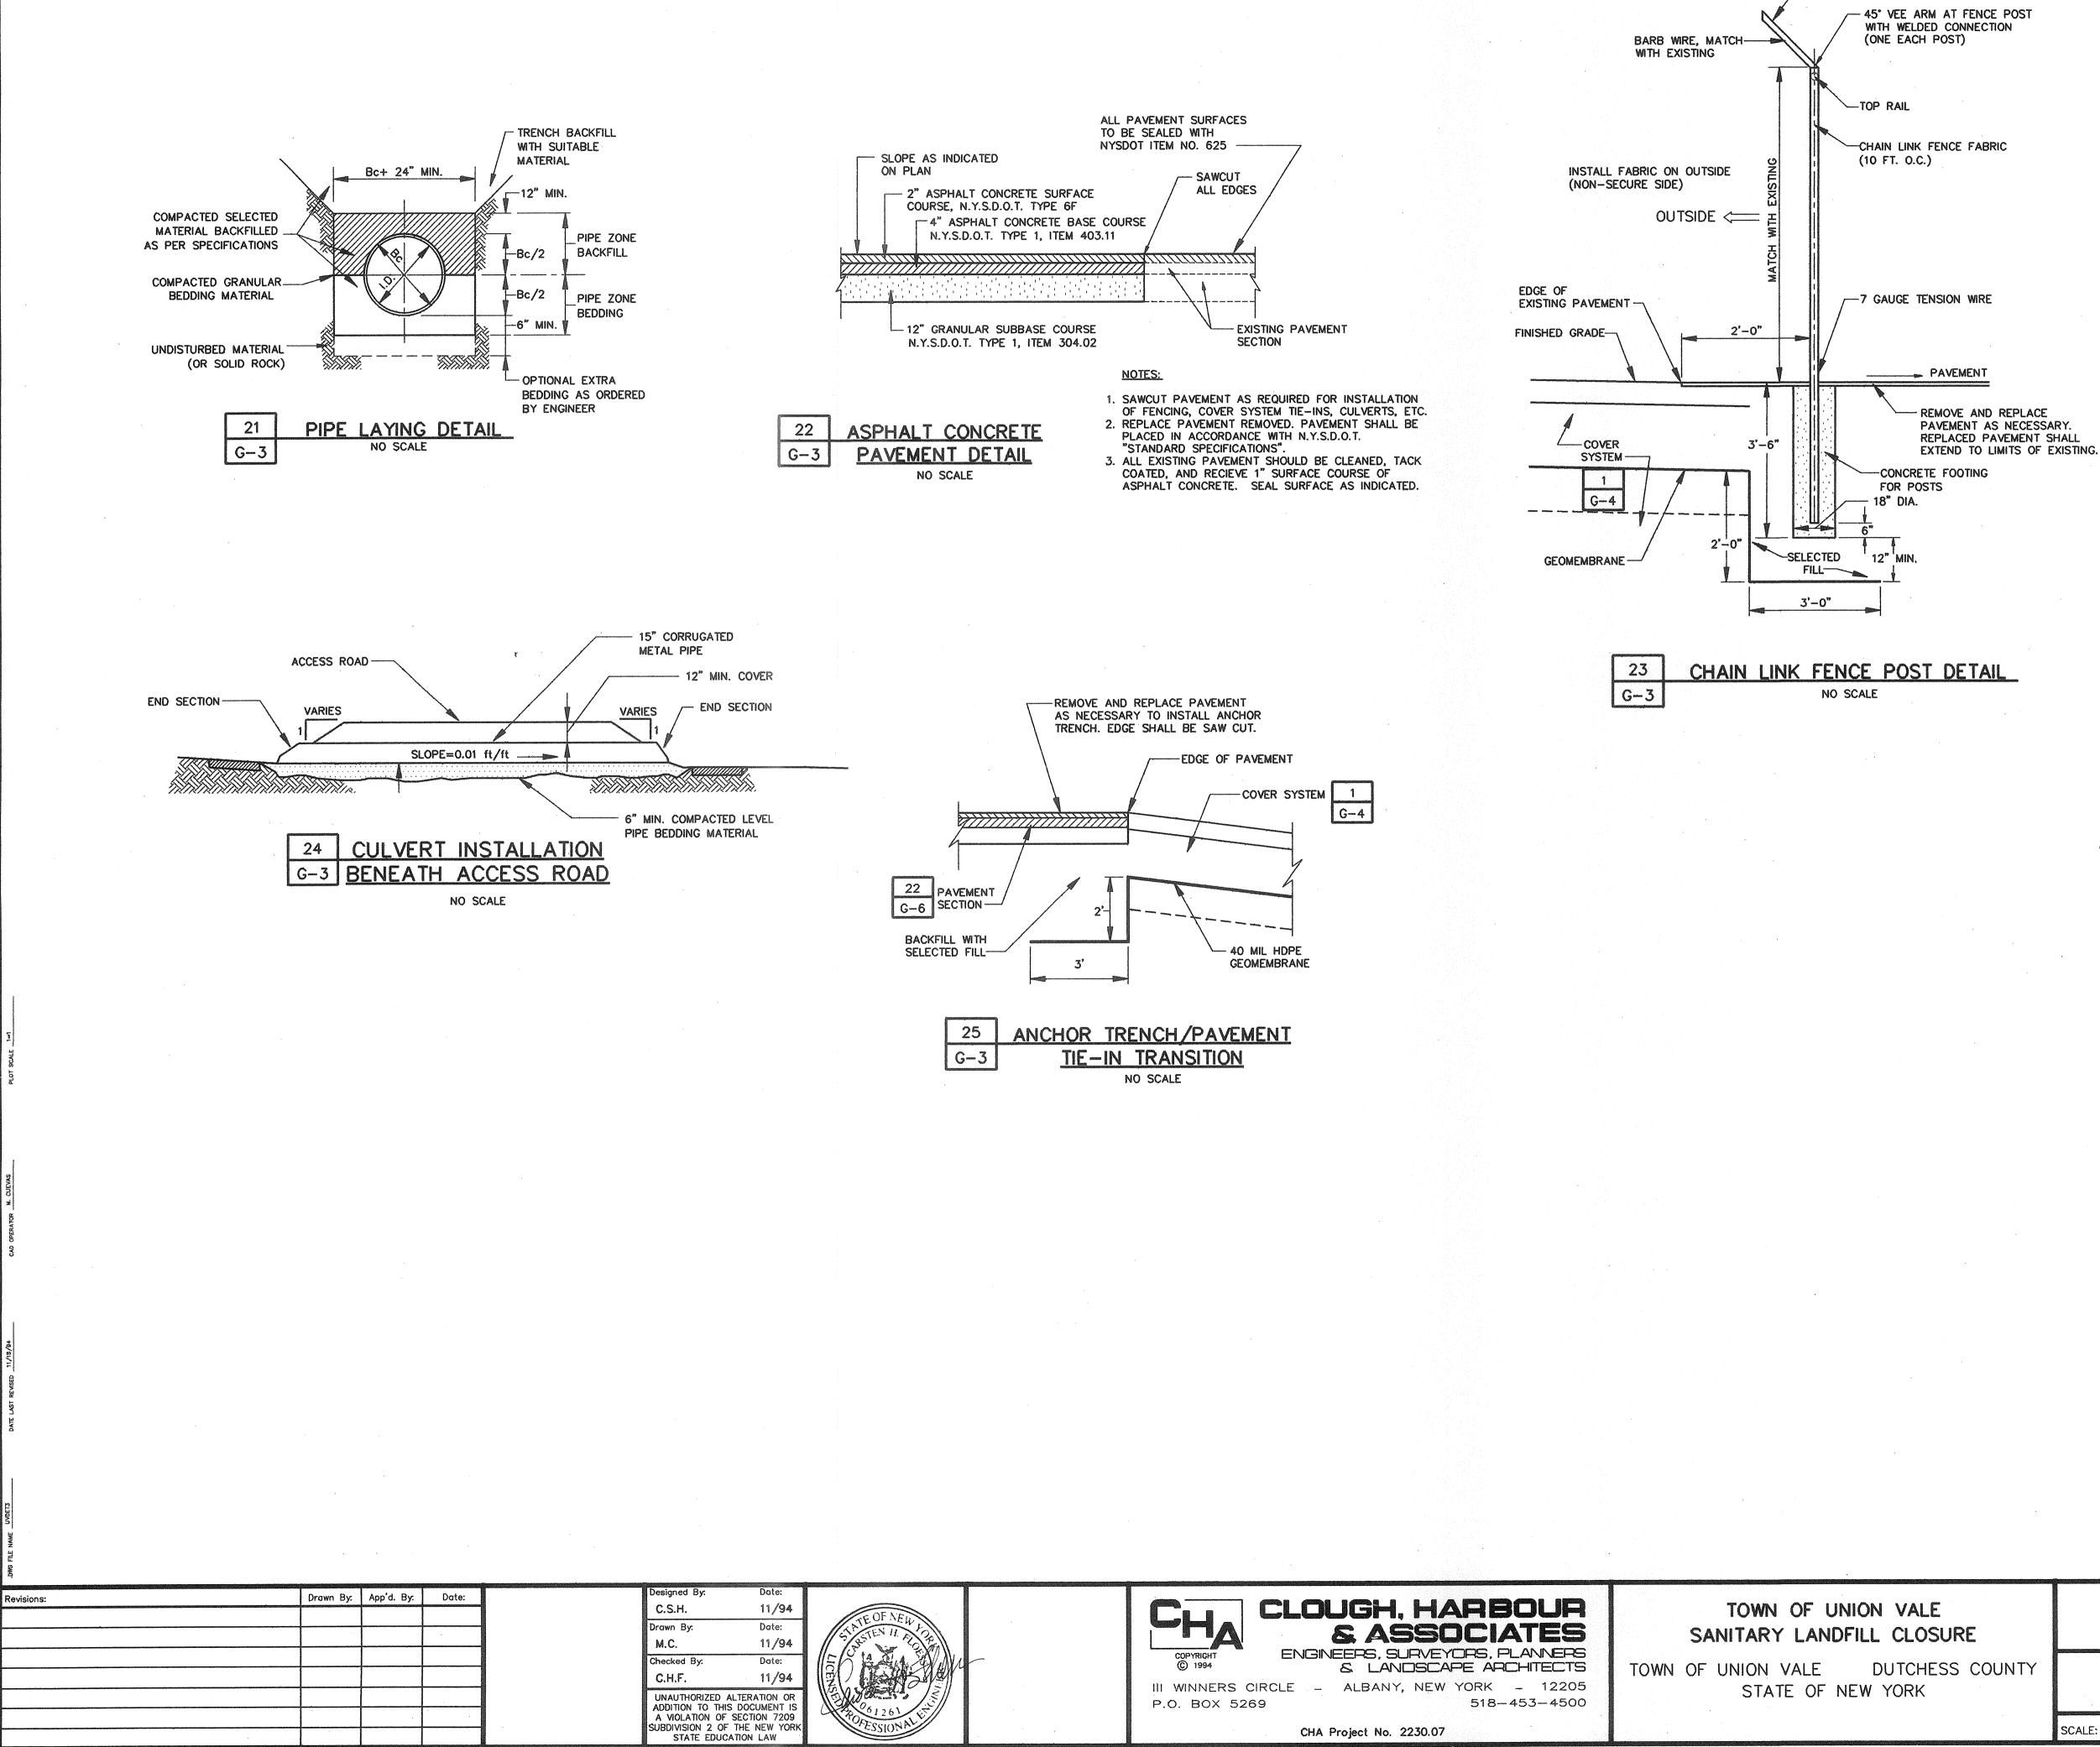



ON VALE LL CLOSURE	LANDFILL CLOSURE PLAN		Drawing No.		
DUTCHESS COUNTY W YORK	WASTE GRADING PLAN			G-2	
	SCALE:	1"=40'		DATE: NOVEMBER, 1994	SHEET 2 OF 7

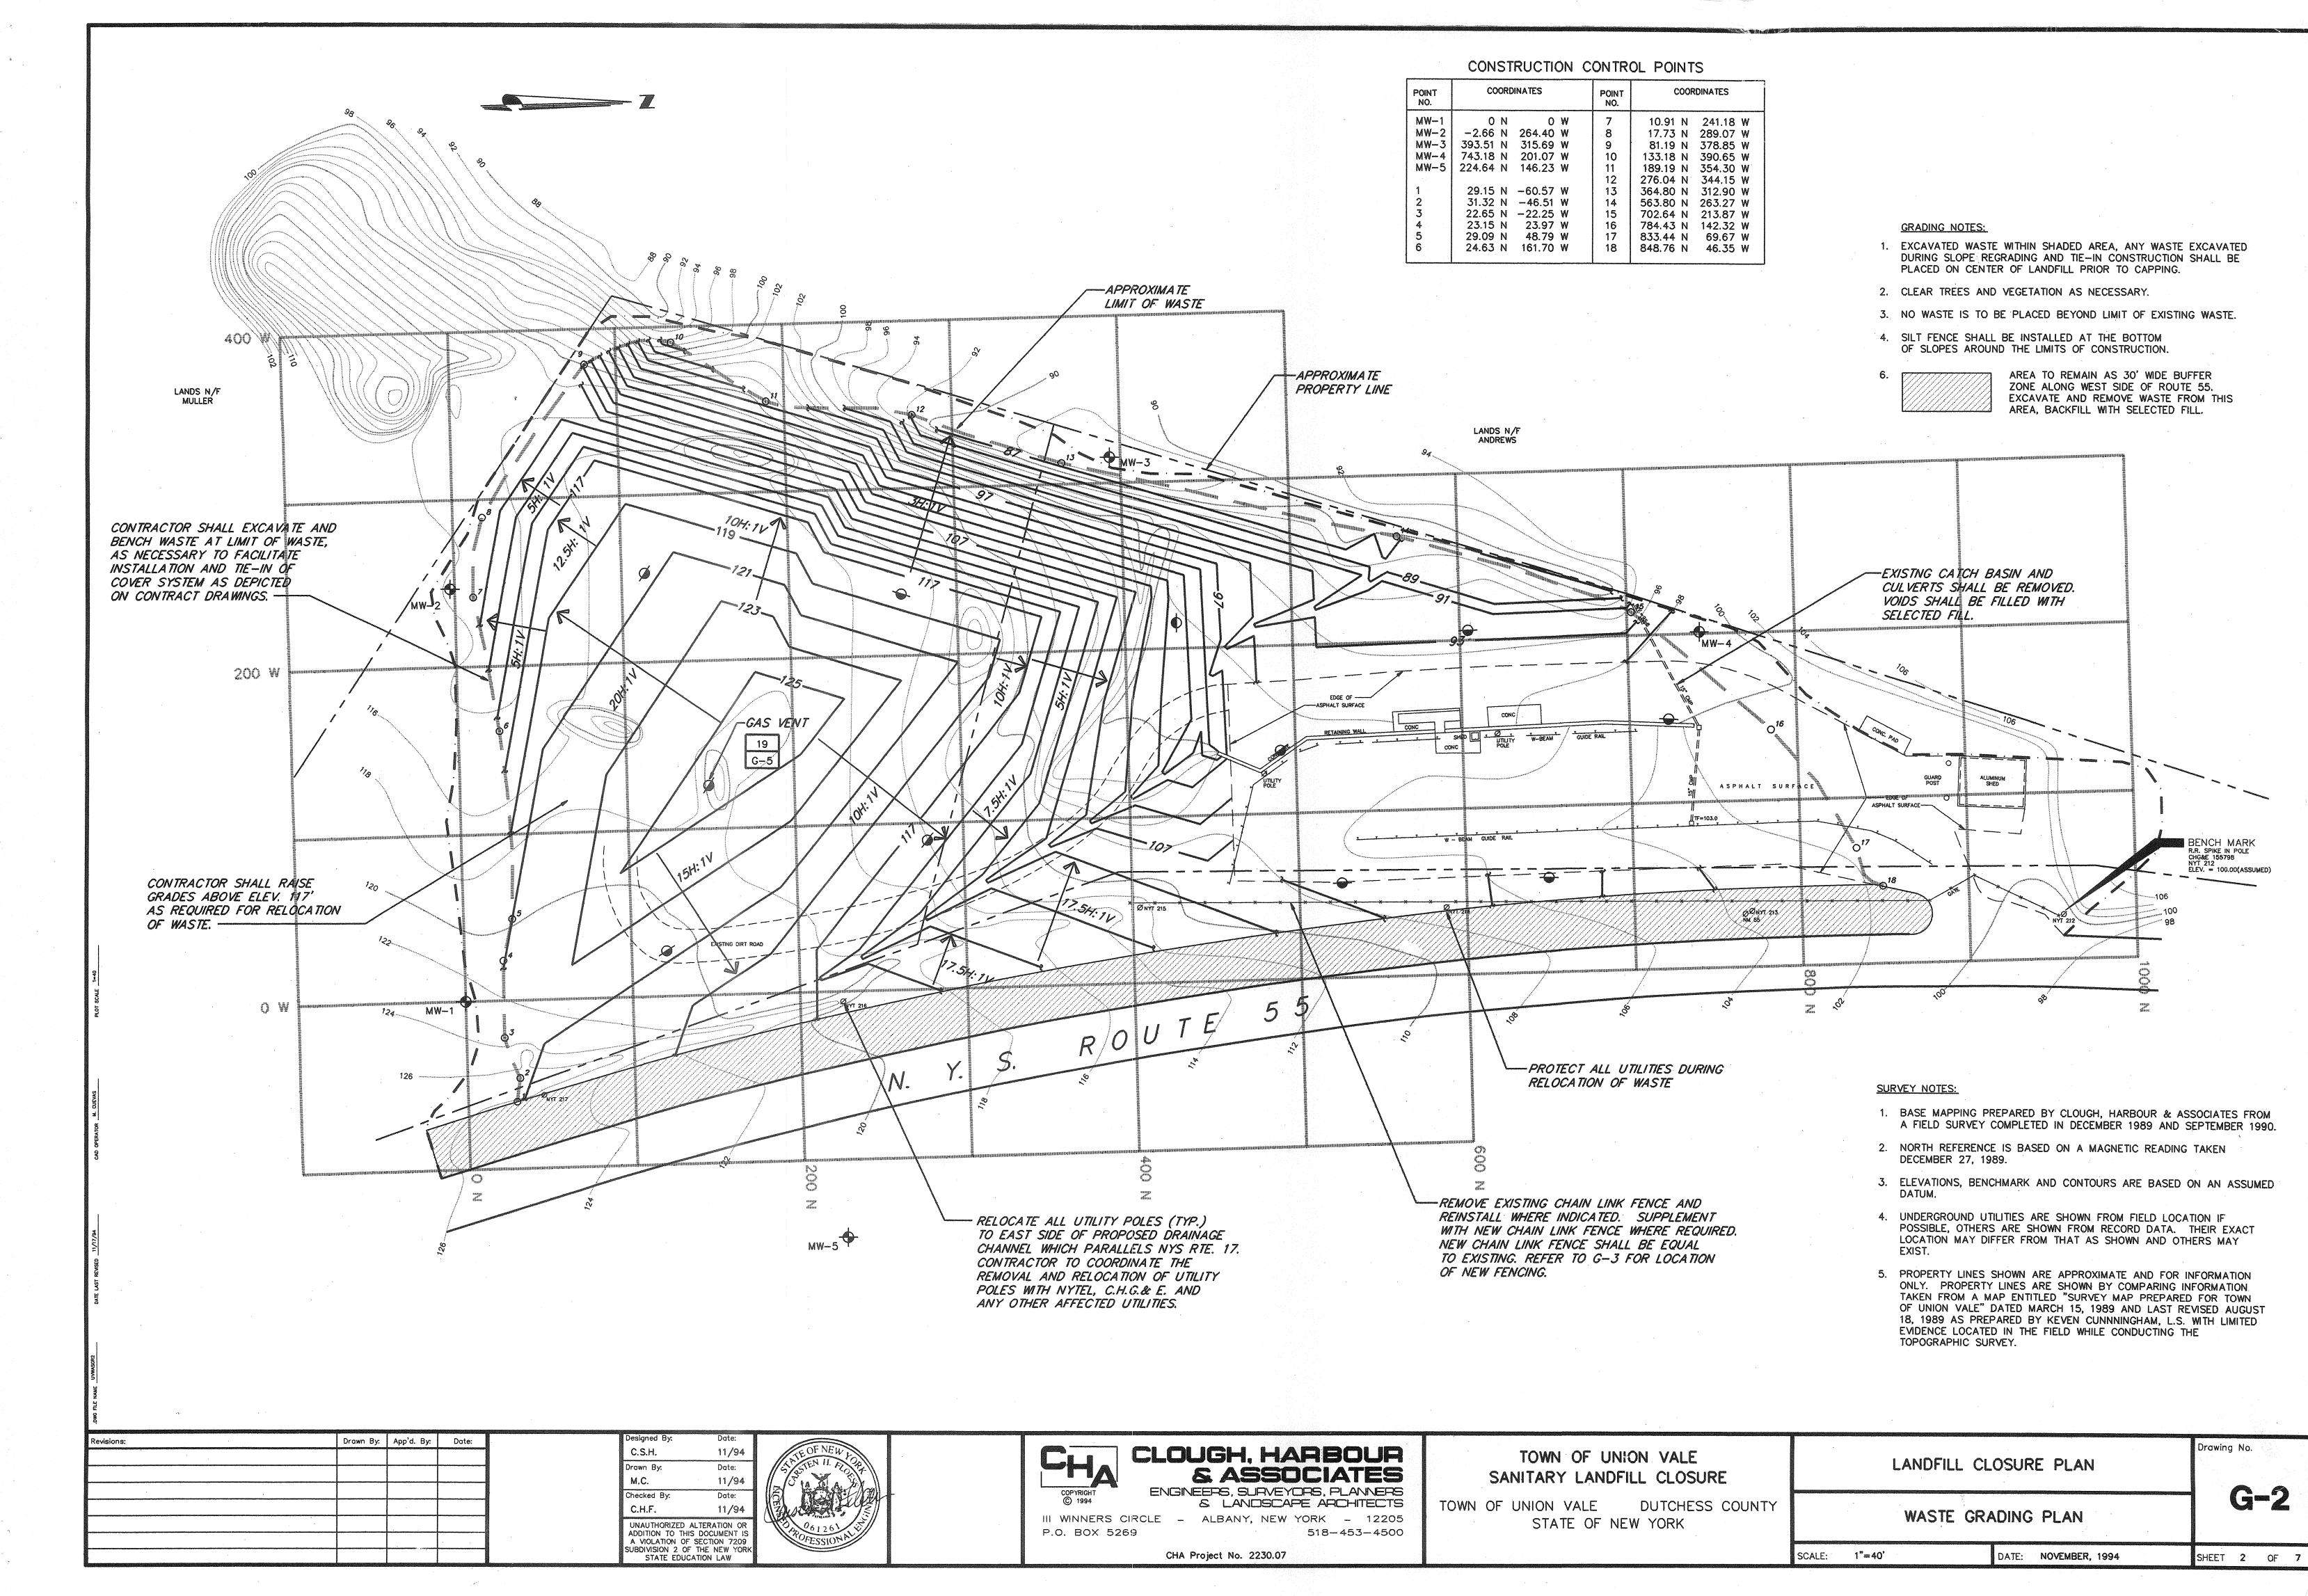



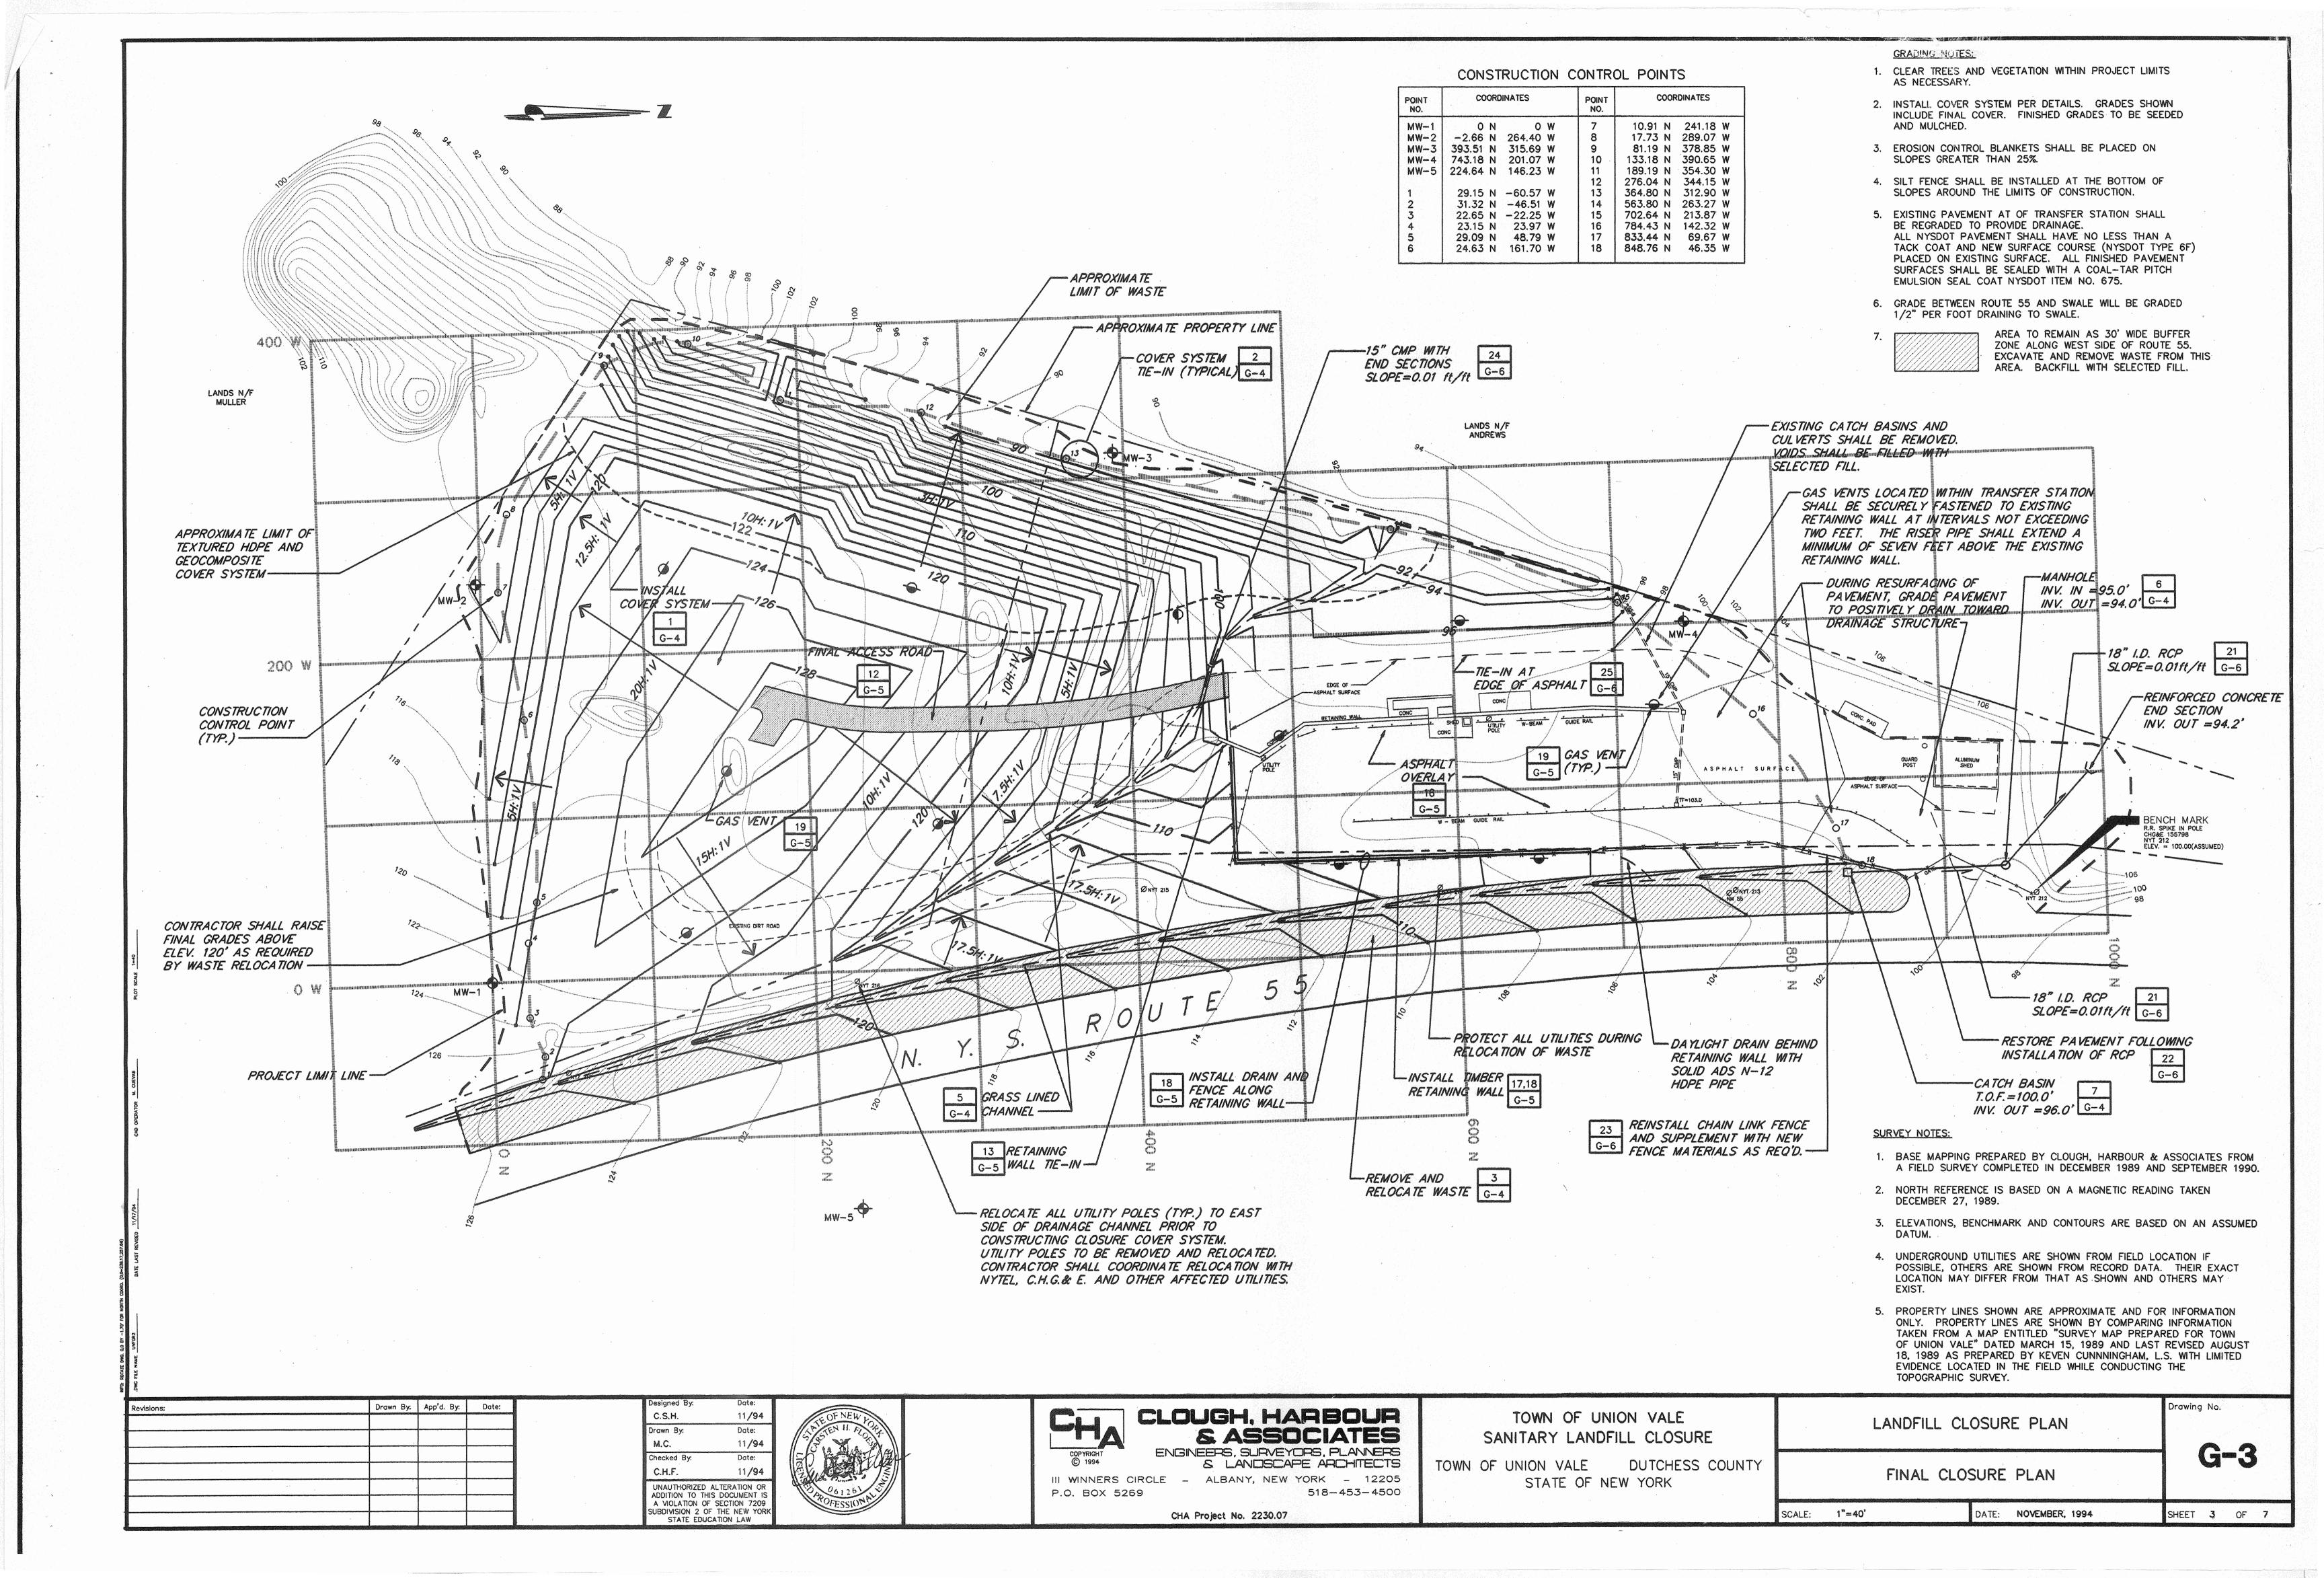

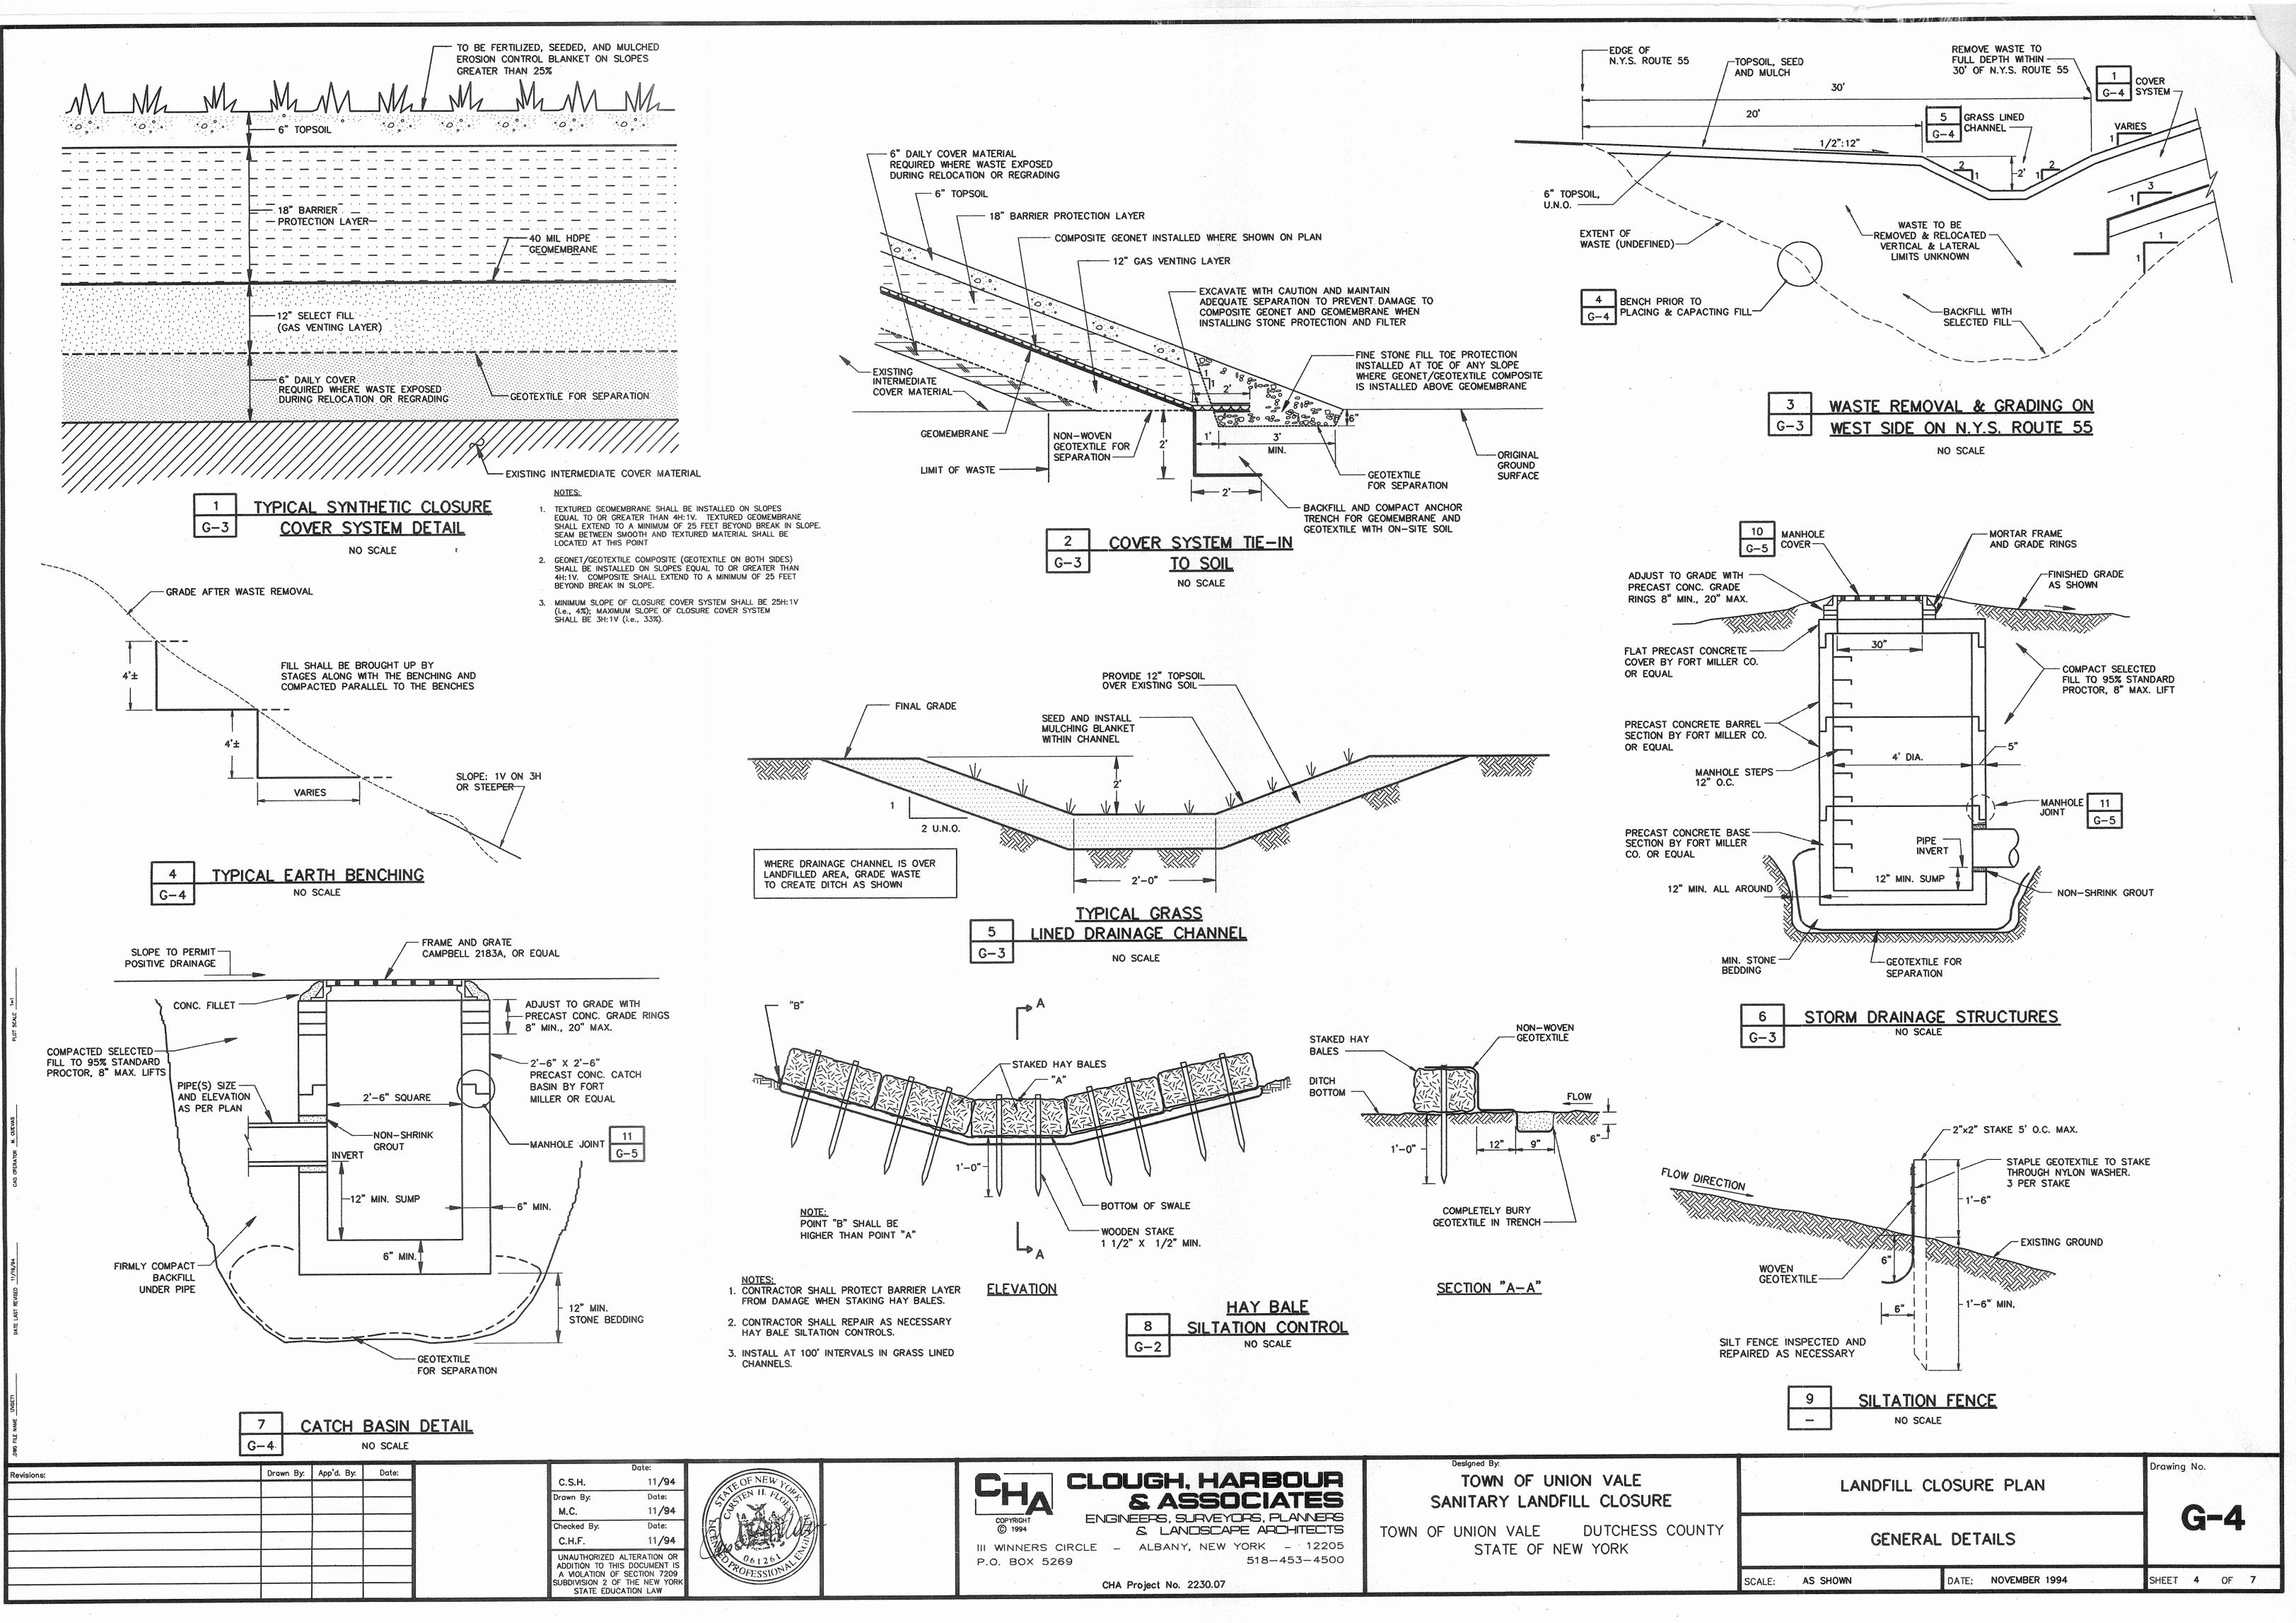

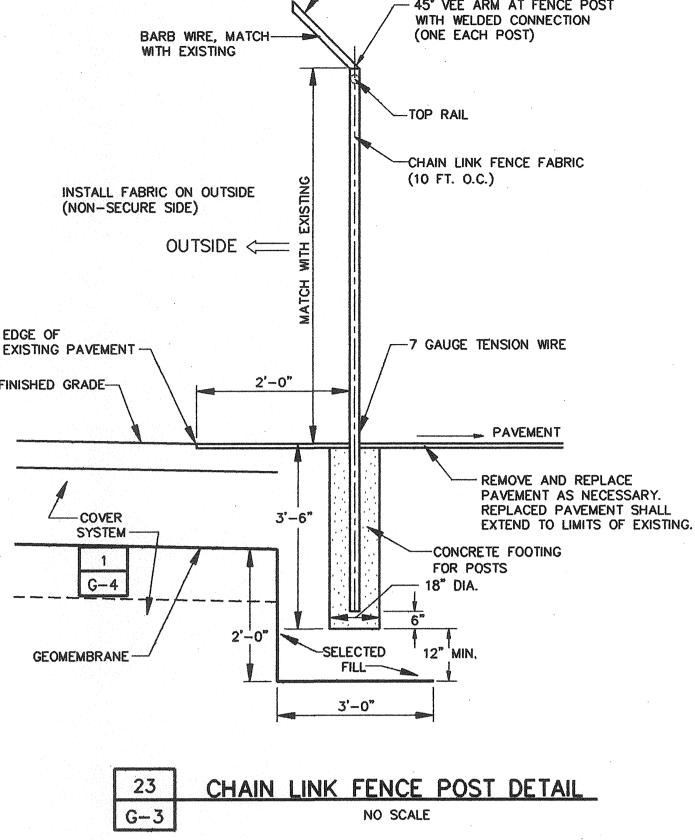

-EACH ARM, 5' 0.C.

		· ·		
ION VALE TILL CLOSURE	LANDFILL CLOSURE PLAN GENERAL DETAILS		Drawing No. G-6	
DUTCHESS COUNTY EW YORK				
	SCALE: AS SHOWN	DATE: NOVEMBER 1994	SHEET 6 OF 7	