




STLC INNSBROOK

1837 STATE HIGHWAY F
INNSBROOK, MO 63390
WARREN COUNTY



FORTUNE WIRELESS INC.

5511 WEST 79TH STREET
INDIANAPOLIS, IN 46278

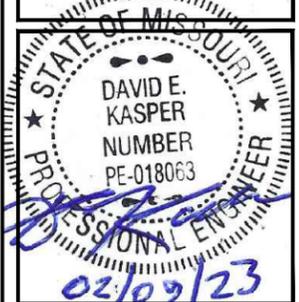

DRAWN BY: GNP

CHECKED BY: DEK

NO:	DATE:	ISSUE:
A	11/14/22	REVIEW CD
0	02/09/23	FINAL CD

NOTICE TO CONTRACTOR - ENVIRONMENTAL CONDITIONS/RESTRICTIONS:

THERE IS A FRESHWATER POND IS 135 FEET NORTHWEST OF THE PROPOSED UTILITY EASEMENT AND APPROXIMATELY 230 FEET NORTHWEST OF THE PROPOSED LEASE AREA. THERE IS A RAVINE LOCATED APPROXIMATELY 200 FEET NORTHWEST OF THE PROPOSED UTILITY EASEMENT AND APPROXIMATELY 300 FEET NORTHWEST OF THE PROPOSED LEASE AREA. THERE IS A ROADSIDE DRAINAGE DITCH EXTENDING PARALLEL TO STATE HIGHWAY F AND THROUGH THE PROPOSED ACCESS/UTILITY EASEMENT. A DRAINAGE DITCH EXTENDS THROUGH THE PROPOSED UTILITY EASEMENT, APPROXIMATELY 33 FEET NORTHEAST FROM THE PROPOSED LEASE AREA. THERE IS A CULVERT 55 FEET NORTHEAST OF THE PROPERTY. THERE IS A CULVERT 124 FEET NORTHEAST OF THE PROPERTY. A SMALL POOL OF STANDING WATER WAS LOCATED 50 FEET NORTH OF THE PROPOSED LEASE AREA.

SOIL EROSION AND SEDIMENTATION CONTROLS / BEST MANAGEMENT PRACTICES: TO PREVENT ANY NEGATIVE IMPACT TO THE SENSITIVE RECEPTORS, SEDIMENT AND EROSION CONTROL MEASURES, SUCH AS SILT FENCES, STRAW WATTLES, AND OTHER STORM-WATER BEST MANAGEMENT PRACTICES, MUST BE IMPLEMENTED PRIOR TO AND MAINTAINED THROUGHOUT CONSTRUCTION.

STAGING AND STOCKPILING RESTRICTIONS: CONSTRUCTION RELATED STAGING AND STOCKPILING OF SOILS AND EQUIPMENT MAY NOT OCCUR IN THE VICINITY OF THE SENSITIVE RECEPTORS OR IN A MANNER THAT WILL CAUSE IMPACTS.

A/C	AIR CONDITIONING	MGR	MANAGER
ADJ	ADJUSTABLE	MIN	MINIMUM
AFF	ABOVE FINISH FLOOR	MISC	MISCELLANEOUS
APPROX	APPROXIMATELY	N	NORTH
ASTM	AMERICAN SOCIETY FOR TESTING AND MATERIALS	N/A	NOT APPLICABLE
AWG	AMERICAN WIRE GAUGE	NIC	NOT IN CONTRACT
		NTS	NOT TO SCALE
BLDG	BUILDING	OC, o/c	ON CENTER
BLK	BLOCK	OD	OUTSIDE DIAMETER
BMR	BASE MOBILE RADIO	OPG	OPENING
B/S	BUILDING STANDARD	OPP	OPPOSITE
CLG	CEILING	PLYWD	PLYWOOD
CLR	CLEAR	PR	PAIR
CND	CONDUIT	PROJ	PROJECT
CONC	CONCRETE	PROP	PROPERTY
CONST	CONSTRUCTION	PT	PRESSURE TREATED
CONT	CONTINUOUS	REQ'D	REQUIRED
DBL	DOUBLE	RM	ROOM
DIA,	DIAMETER	RO	ROUGH OPENING
DIAG	DIAGONAL	S	SOUTH
DN	DOWN	SH	SHEET
DTL/DETL	DETAIL	SIM	SIMILAR
DWG	DRAWING	SPEC	SPECIFICATION
E	EAST	SQ	SQUARE
EA	EACH	SS	STAINLESS STEEL
E, ELEV	ELEVATION	STL	STEEL
ELECT	ELECTRICAL	STRUCT	STRUCTURAL
EQ	EQUAL	SUSP	SUSPENDED
EQUIP	EQUIPMENT	SV	SHEET VINYL
EW	EACH WAY	THRU	THROUGH
EXIST	EXISTING	TND	TINNED
EXT	EXTERIOR	TOC	TOP OF CONCRETE
		TOM	TOP OF MASONRY
FIN	FINISH	TYP	TYPICAL
FLUOR	FLUORESCENT	UBC	UNIFORM BUILDING CODE
FT	FOOT	UNO	UNLESS NOTED OTHERWISE
GA	GAUGE	VERT	VERTICAL
GALV	GALVANIZE(D)	VIF	VERIFY IN FIELD
GC	GENERAL CONTRACTOR	VT	VINYL TILE
GRND	GROUND	W	WEST
GWB	GYPSPUM WALL BOARD	W/	WITH
GYP BD	GYPSPUM BOARD	WIN	WINDOW
HARD'WD	HARDWOOD	W/O	WITHOUT
HORIZ	HORIZONTAL	WP	WATERPROOF
HR	HOUR		
HT	HEIGHT		
HVAC	HEATING, VENTING & AIR CONDITIONING		
ID	INSIDE DIA.		
IN	INCH		
INFO	INFORMATION		
INSUL	INSULATION		
INT	INTERIOR	∠	ANGLE
LB(S)	POUND(S)	&	CENTER LINE
		⊥	PROPERTY LINE
MAX	MAXIMUM	AT	AT
MECH	MECHANICAL	#	NUMBER
MET/MTL	METAL		
MFR	MANUFACTURER		

	REVISION		DETAIL REFERENCE
	KEY NOTE		ELEVATION REFERENCE
	ROOM NUMBER		SECTION REFERENCE
	KEYED NOTE		

ABBREVIATIONS AND SYMBOLS

ALL WORK SHALL BE PERFORMED AND MATERIALS INSTALLED IN ACCORDANCE WITH THE CURRENT EDITIONS OF THE FOLLOWING CODES AS ADOPTED BY THE LOCAL GOVERNING AUTHORITIES. NOTHING IN THESE PLANS IS TO BE CONSTRUED TO PERMIT WORK NOT CONFORMING TO THESE CODES:

CODE TYPE	CODE
BUILDING	2018 IBC OR LATEST ADOPTED BY JURISDICTION
MECHANICAL	2018 IMC OR LATEST ADOPTED BY JURISDICTION
ELECTRICAL	2017 NEC OR LATEST ADOPTED BY JURISDICTION
CONSTRUCTION TYPE: 3B	
OCCUPANCY TYPE: U	

APPLICABLE CODES

THE PROJECT INCLUDES:
NEW 11'-0" X 19'-0" EQUIPMENT PAD, 8" H-FRAME & 30KW DIESEL GENERATOR WITHIN THE PROPOSED FENCED COMPOUND (75'-0" X 65'-0" LEASED AREA), PROPOSED 305' SELF SUPPORT TOWER WITH (3) NEW ANTENNAS, (3) 4449 B5/B13, (3) 8843 B2/B4, (2) RAYCAP DEMARC BOXES, AND (2) 1-5/8" HYBRID CABLE AT THE 300' A.G.L. CENTERLINE.

PROJECT DESCRIPTION

ARCHITECTURAL AND ENGINEERING FIRM:
FORTUNE WIRELESS
DAVID KASPER
5511 WEST 79TH STREET
INDIANAPOLIS, IN 46278
PHONE: (913) 209-6512

SURVEYOR:
LOVELACE & ASSOCIATES
PHONE: (816) 347-9997

POLICE DEPARTMENT:
PHONE: 636-456-4332

FIRE DEPARTMENT:
PHONE: 636-745-2262

ELECTRICAL:
CUIVRE RIVER ELECTRIC COOP
CONTACT: ROB VONHOFFER
PHONE: 636-695-4743
OFFICE:
EMAIL: robv@cuivre.com
PREMISE #:

TELEPHONE CO:
CENTURY LINK
PHONE: 866-743-9692

SITE NAME:
STLC INNSBROOK

SITE ADDRESS:
1837 STATE HIGHWAY F
INNSBROOK,
MO 63390
WARREN COUNTY

LOCATION NO.:
449382

PROJECT NO.:
20171596557

FUZE PROJECT NO.:
2505770

SITE LAT/LON ELEV:
LATITUDE - N 38° 45' 57.78"
- N 38.76605
LONGITUDE - W 91° 02' 28.35"
- W 91.041208
ELEVATION 767' AMSL

LANDLORD:
INNSBROOK CORP
#1 ASPEN CIRCLE DR.
VILLAGE OF INNSBROOK, MO 63390
PHONE: (636) 928-3366 X9227

APPLICANT:
VERIZON WIRELESS
MANAGER-NETWORK REAL ESTATE
PHONE: 913-344-2896

CALL 3 WORKING DAYS BEFORE YOU DIG


CONSULTANT TEAM

RF ENGINEER	STEVE FALLON
OPERATIONS MANAGER	
CONSTRUCTION ENGINEER	BRYAN WIDMAN
CONSTRUCTION MANAGER	JEFF DILLEY
REAL ESTATE MANAGER	DANIEL FAGAN
	INITIALS DATE

VERIZON WIRELESS DEPARTMENT APPROVALS

SIGNATURE	PRINTED NAME	DATE
LESSOR / LICENSOR: PLEASE CHECK THE APPROPRIATE BOX BELOW		
<input type="checkbox"/>	NO CHANGES	<input type="checkbox"/>
<input type="checkbox"/>	CHANGES NEEDED. SEE COMMENTS ON PLANS	

LESSOR / LICENSOR APPROVAL

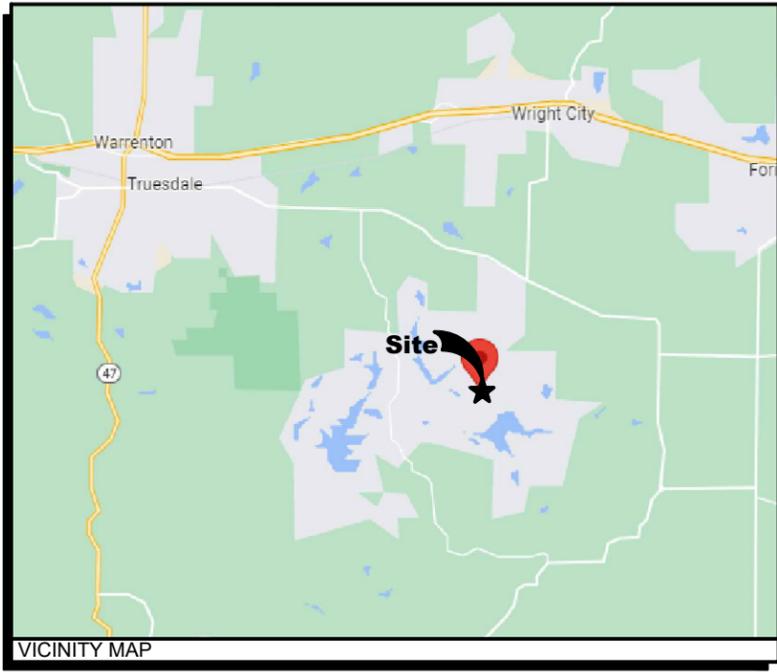

DRAWING INDEX

SHEET #	SHEET DESCRIPTION
T-1	TITLE SHEET
-	SURVEY
C-1	OVERALL SITE PLAN
C-2	ENLARGED SITE PLAN
C-3	ENLARGED SITE PLAN
C-4	EROSION CONTROL DETAIL
C-5	ELEVATION & ANTENNA DETAIL
C-6	CIVIL DETAILS
C-7	CIVIL DETAILS
C-8	PLUMBING DIAGRAM
EQ-1	EQUIPMENT PLAN
EQ-2	EQUIPMENT ELEVATIONS
EQ-3	EQUIPMENT FOUNDATION
E-0	UTILITY SITE PLAN
E-1	CARRIER DETAILS
G-1	GROUNDING PLAN & NOTES
G-2	GROUNDING DETAILS

ALL DRAWINGS CONTAINED HEREIN ARE FORMATTED FOR 11x17. CONTRACTOR SHALL VERIFY ALL PLANS AND EXISTING DIMENSIONS AND CONDITIONS ON THE JOB SITE AND SHALL IMMEDIATELY NOTIFY THE ENGINEER IN WRITING OF ANY DISCREPANCIES BEFORE PROCEEDING WITH THE WORK OR BE RESPONSIBLE FOR SAME.

VERIZON COLOR STANDARDS

Gray (200,200,200) - EXISTING EASEMENT	
PURPLE #1 (240,231,243) - LEASE AREA	
BLUE GRAY #1 (231,241,243) - ACCESS/UTILITY EASEMENT	
BLUE #1 (5,130,255) - HYBRID CABLES/COAX	
BLUE #2 (215,235,255) - RRHS	
GREEN (219,247,210) - DC POWER	
ORANGE (244,186,142) - FIBER	
TAN (223,211,198) - ANTENNAS	
RED (241,14,14) - PENETRATIONS	
UMBER (255,238,191) - NEW WORK/UTILITY EASEMENT	
GRAY (80,80,80) - WALL HATCH	
GREY (200,200,200) - EXISTING	

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STLC INNSBROOK
LOCATION #: 2505770
FUZE PROJECT #:
2505770
1837 STATE HWY F
INNSBROOK,
MO 63390 WARREN
COUNTY

SHEET TITLE:
TITLE SHEET

SHEET NUMBER:
T-1
DO NOT SCALE DRAWINGS

STLC INNSBROOK
PART OF THE NE 1/4,
SECTION 8, T46N, R1W,
IN WARREN COUNTY, MISSOURI

Notes:

Bearings shown hereon are referenced to Grid North of the Missouri State Plane Coordinate System of 1983 (NAD 83), (2011 ADJ.), East Zone. Obtained by static GPS observations and Rinex File submittals for NGS Opus solutions.

Vertical Datum = NAVD88 using GEOID12B

The purpose of this survey is to establish and describe a Premises and associated Easements. This is not a boundary survey of the Parent Parcel.

**** An utility locate was requested on 09-20-22, as Ticket No. 222632315.**

The utilities as shown on this drawing were developed from the information available (existing utility maps, aboveground observations and/or surface markings placed on the ground by the utility company or a representative thereof). This company has made no attempt to excavate or go below surface to locate utilities and does not extend or imply a guaranty or warranty as to the exact location of or complete inventory of utilities in this area. It shall be the contractors responsibility to verify the location and depth of all utilities (whether shown or not) prior to excavation or construction and to protect said utilities from damage.

PROPERTY DESCRIPTION: LESSEE'S PROPOSED PREMISES (AS SURVEYED)

A 65 foot by 75 foot Premises, situated in land described in Deed in Book 484, Page 11, part of the Northeast Quarter of Section 8, Township 46 North, Range 1 West, in Warren County, Missouri, more particularly described as follows:

COMMENCING at the Southwest Corner of land described in said Deed; thence along the South line thereof, South 88°19'45" East, a distance of 149.27 feet; thence leaving said South line, North 13°26'04" East, a distance of 69.05 feet to the POINT OF BEGINNING; thence continuing North 13°26'04" East, a distance of 75.00 feet; thence South 76°33'56" East, a distance of 65.00 feet; thence South 13°26'04" West, a distance of 75.00 feet; thence North 76°33'56" West, a distance of 65.00 feet to the POINT OF BEGINNING. Containing 4,875 square feet.

PROPERTY DESCRIPTION: LESSEE'S PROPOSED NON-EXCLUSIVE ACCESS/UTILITY EASEMENT (AS SURVEYED)

A 20 foot wide Access/Utility Easement, situated in land described in Deed in Book 484, Page 11, part of the Northeast Quarter of Section 8, Township 46 North, Range 1 West, in Warren County, Missouri, lying 10.00 feet on each side of the following described centerline:

COMMENCING at the Southwest Corner of land described in said Deed; thence along the South line thereof, South 88°19'45" East, a distance of 149.27 feet; thence leaving said South line, North 13°26'04" East, a distance of 59.05 feet to the POINT OF BEGINNING of said centerline; thence South 76°33'56" East, a distance of 35.00 feet to a point hereinafter referred to as POINT "A"; thence South 13°26'04" West, a distance of 30.00 feet to the POINT OF TERMINATION; BEGINNING at aforementioned POINT "A"; thence South 76°33'56" East, a distance of 32.54 feet; thence South 48°00'45" East, a distance of 17.77 feet to the West Right of Way line of STATE HWY F (Public Right of Way) and the POINT OF TERMINATION.

PROPERTY DESCRIPTION: LESSEE'S PROPOSED NON-EXCLUSIVE UTILITY EASEMENT (AS SURVEYED)

A 10 foot wide Utility Easement, situated in land described in Deed in Book 484, Page 11, part of the Northeast Quarter of Section 8, Township 46 North, Range 1 West, in Warren County, Missouri, lying 5.00 feet on each side of the following described centerline:

COMMENCING at the Southwest Corner of land described in said Deed; thence along the South line thereof, South 88°19'45" East, a distance of 149.27 feet; thence leaving said South line, North 13°26'04" East, a distance of 59.05 feet; thence continuing North 13°26'04" East, a distance of 5.00 feet to the POINT OF BEGINNING of said centerline; thence North 76°33'56" West, a distance of 12.28 feet; thence North 10°54'01" East, a distance of 174.61 feet to the POINT OF TERMINATION.

PROPERTY DESCRIPTION: PARENT PARCEL (AS PROVIDED)

Property located in Warren County, Missouri

A Tract of Land being part of the Northeast Quarter of the Northeast Quarter of Section Eight (8), Township Forty-Six (46) North, Range One (1) West and described as follows: Beginning at the Northwest corner of said Northeast Quarter of the Northeast Quarter of Section 8; thence South 89° 16' East 614.70 feet to the West right-of-way line of State Highway "F"; thence along the said West right-of-way line as follows: Along a curve South 14° 30' West Ch. length 343.90 feet to point of tangent; thence South 30° 07' West 190.75 feet to point of curve; thence along curve South 35° 43' West with length 222.50 feet to point of tangent; thence South 41° 10' West 237.75 feet; thence South 40° 56' West 161.60 feet to point of curve; thence South 35° 10' West 83.70 feet to the West line of said Northeast Quarter of the Northeast Quarter of Section 8; thence leaving said West right-of-way line of State Highway "F" North 0° 30' East 1056.01 feet to the place of beginning and containing 9.154 acres.

Except a tract of land being part of the Northeast Quarter of the Northeast Quarter of Section 8, Township 46 North, Range 1 West, Warren County, Missouri and being described as follows: Commencing at an angle iron at the Northwest Corner of said Northeast Quarter of the Northeast Quarter; thence along the West line of said Northeast Quarter of the Northeast Quarter, South 1° 25' West 792.40 feet to an iron rod at the place of beginning of said tract; thence leaving said West line, South 88° 17' East 213.37 feet to an iron rod on the West right-of-way line of State Highway "F"; thence along said right-of-way line South 42° 02' West 253.63 feet to a right-of-way marker; thence South 36° 00' West 85.02 feet to a rock post on the West line of said Northeast Quarter of the Northeast Quarter, and said rock post is North 1° 25' East 274.29 feet from an iron pipe at the Southwest Corner of said Northeast Quarter of the Northeast Quarter; thence leaving said West right-of-way line and along the West line of said Northeast Quarter of the Northeast Quarter, North 1° 25' East 263.61 feet to the place of beginning and containing 0.62 acres, more or less.

AND BEING the same property conveyed to The Innsbrook Corporation, a Missouri corporation from June L. Wobbe and June L. Wobbe as personal representative of the Estate of Warren G. Wobbe, an undivided one half interest and Edmund J. Boyce and Kirsten O. Boyce, an undivided one half interest by General Warranty Deed dated January 31, 1990 and recorded May 15, 1990 in Deed Book 484, Page 11.

Tax Parcel No. 1108000002000000

Property information shown hereon was provided by Fidelity National Title, Order No. 37888961, issued September 23, 2022.


Schedule B-II information:

- Right-of-Way Easement in favor of Cuivre River Electric Cooperative, Inc., a cooperative corporation set forth in instrument recorded on May 6, 1977 in Deed Book 203, Page 346. (Exact location is undefined, not shown hereon)
- Easement Deed in favor of The Innsbrook Corporation, a Missouri corporation set forth in instrument recorded on September 25, 1990 in Deed Book 497, Page 77. (Blanket in nature, not shown hereon)
- Terms and conditions of Memorandum of Lease dated September 17, 2003 by and between The Innsbrook Corporation, and VoiceStream PCS II Corporation, a Delaware corporation, recorded on March 10, 2004 in Deed Book 1240, Page 836. (Not the type to be depicted hereon)
- Notice of Leasehold Interest recorded on May 21, 2007 in Instrument No. 200703923. (Shown hereon)
- Terms and conditions of Memorandum of Lease dated June 1, 2010 by and between The Innsbrook Corporation, a Missouri corporation, and New Cingular Wireless PCS, LLC, a Delaware limited liability company, recorded on November 16, 2010 in Instrument No. 201006075. (Exact location of lease is undefined, not shown hereon)

PREMISES DATA
 Center of Premises
 Lat 38°45'57.78" North
 Long 91°02'28.35" West
 Ground Elevation = 767ft

BENCH MARK
 Top of 1/2" Iron Bar w/
 Control Cap at CP-1
 Elevation = 772.46ft

OWNER: KAUBLE LESLIE HOWARD
 PARCEL NO.: 11050000022000000

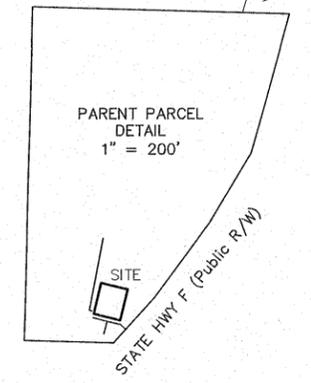


OWNER: ASPENHOF CORP
 PARCEL NO.: 11050000024000000

OWNER: THE INNSBROOK CORPORATION,
 A MISSOURI CORPORATION
 PARCEL NO.: 11080000020000000
 DEED: 484-11


OWNER: ASPENHOF CORP
 PARCEL NO.: 11080001013001000

Barbed Wire Fence


PARENT PARCEL LINE

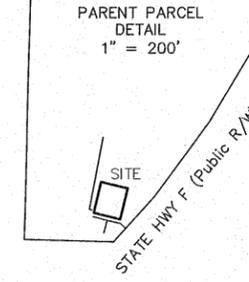


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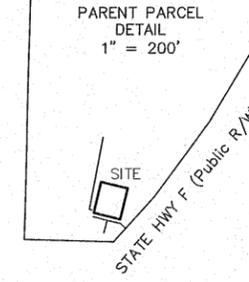
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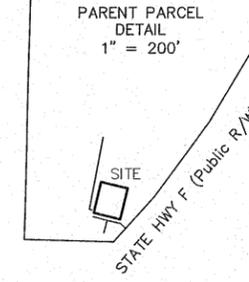
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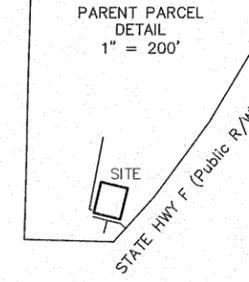
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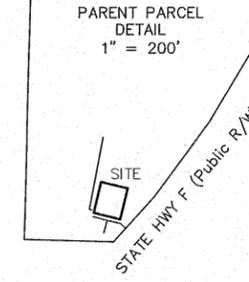
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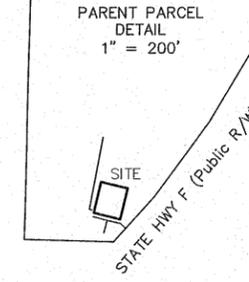
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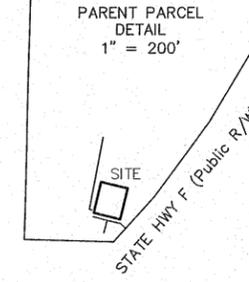
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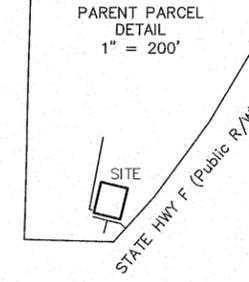
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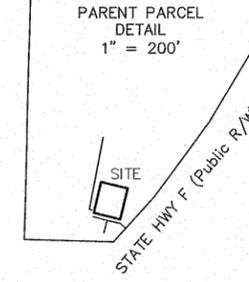
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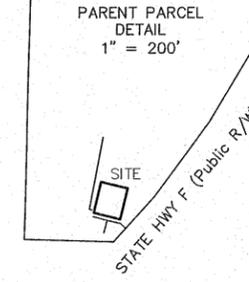
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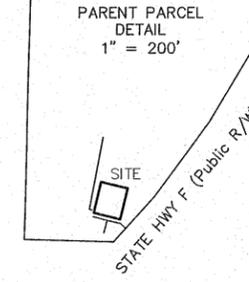
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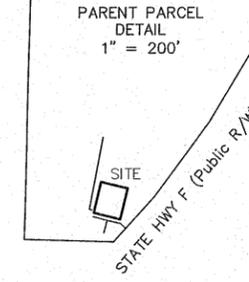
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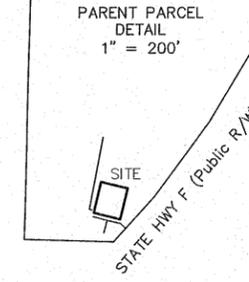
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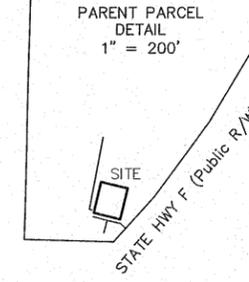
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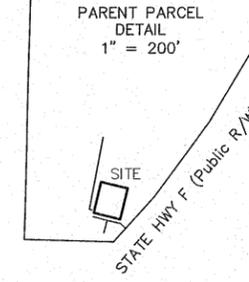
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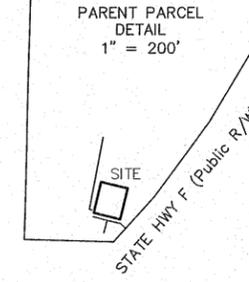
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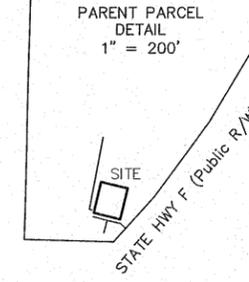
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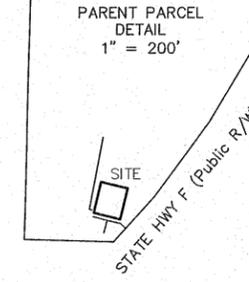
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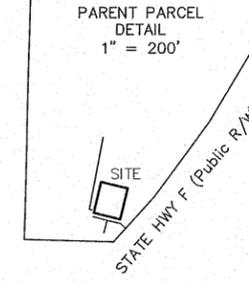
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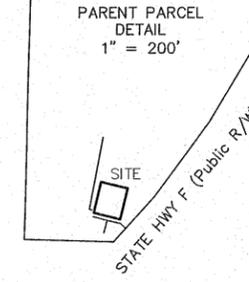
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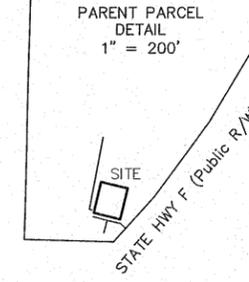
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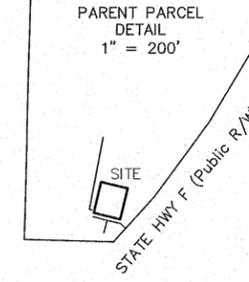
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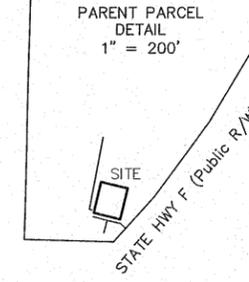
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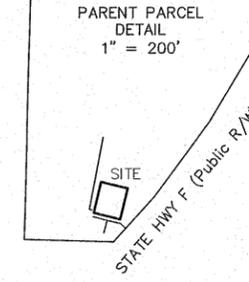
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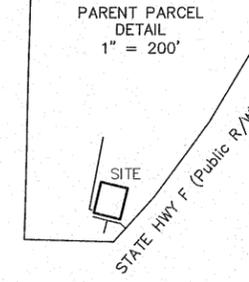
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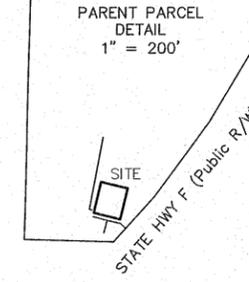
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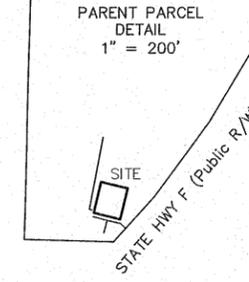
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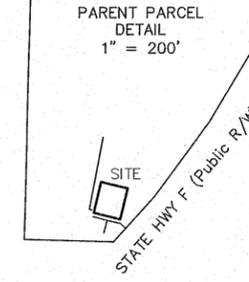
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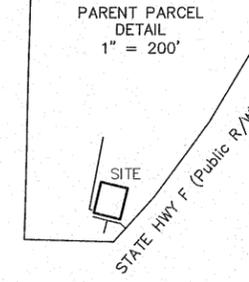
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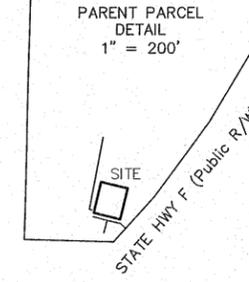
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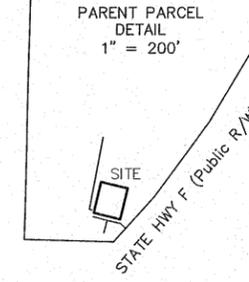
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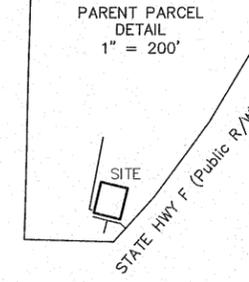
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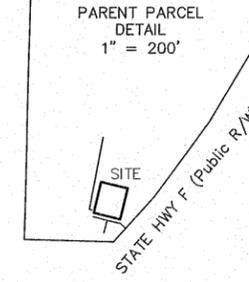
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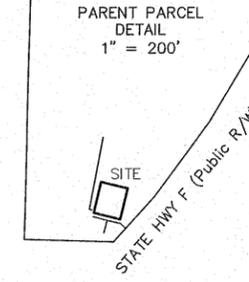
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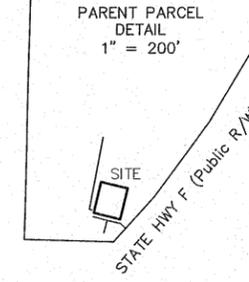
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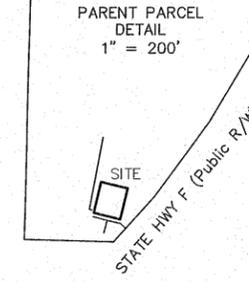
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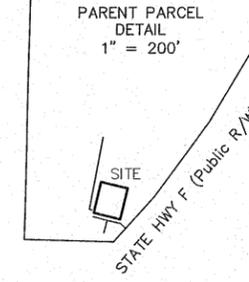
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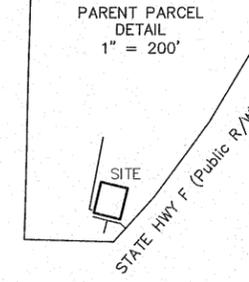
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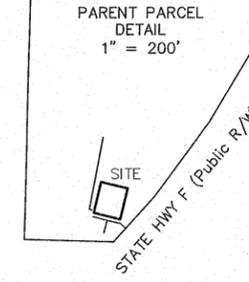
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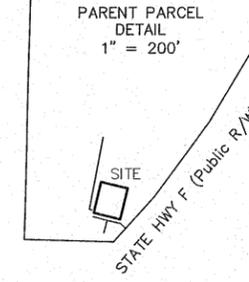
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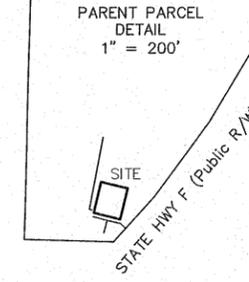
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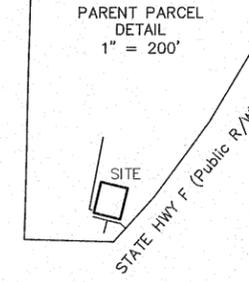
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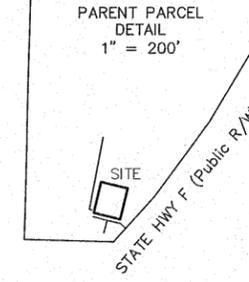
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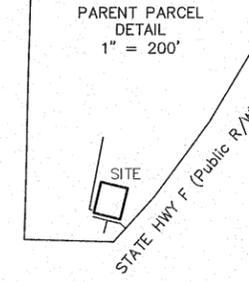
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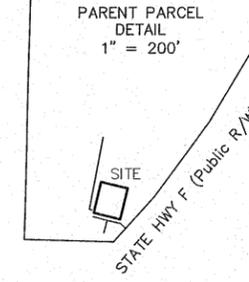
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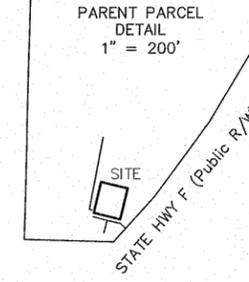
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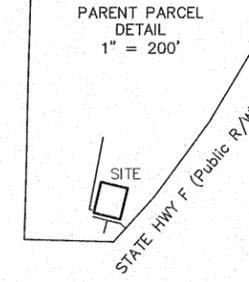
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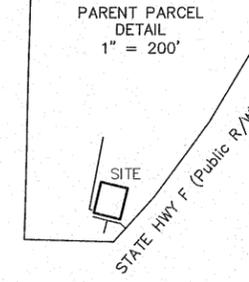
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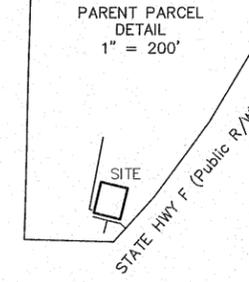
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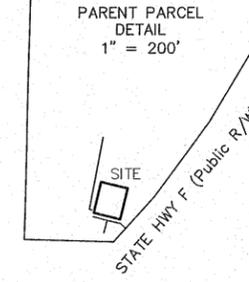
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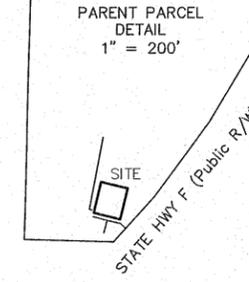
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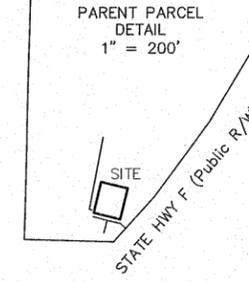
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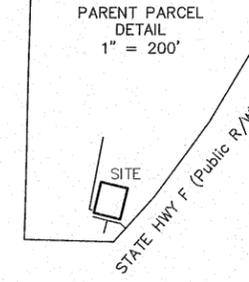
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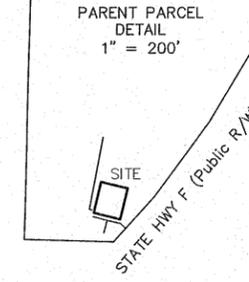
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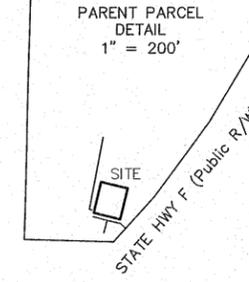
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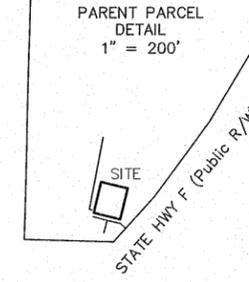
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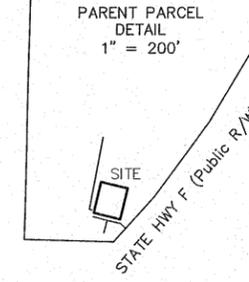
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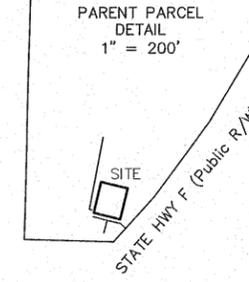
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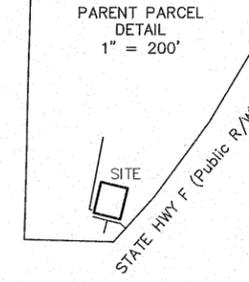
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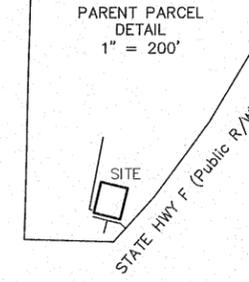
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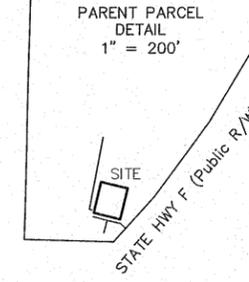
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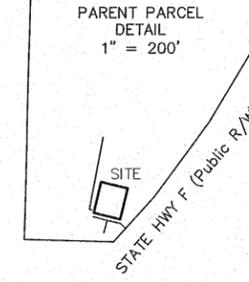
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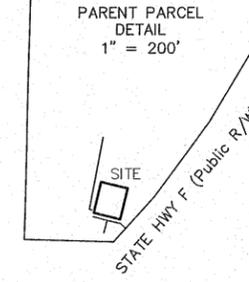
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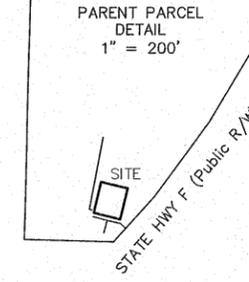
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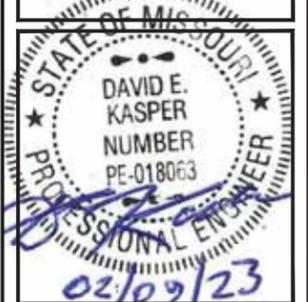


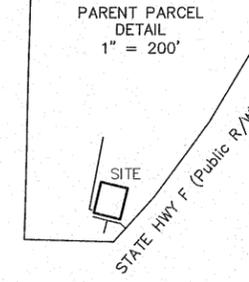OWNER: KAUBLE LESLIE HOWARD
 PARCEL NO.: 11050000022000000

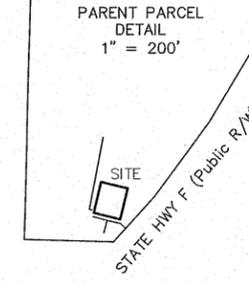

FORTUNE WIRELESS INC.

5511 WEST 79TH STREET
INDIANAPOLIS, IN 46278

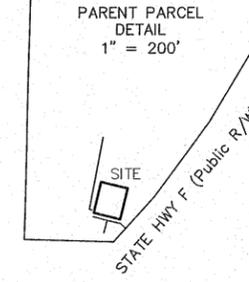

DRAWN BY: GNP

CHECKED BY: DEK

NO:	DATE:	ISSUE:
A	11/14/22	REVIEW CD
0	02/09/23	FINAL CD


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STLC INNSBROOK
LOCATION #: 2505770
FUZE PROJECT #:
2505770
1837 STATE HWY F
INNSBROOK,
MO 63390 WARREN
COUNTY

SHEET TITLE:
OVERALL SITE PLAN

SHEET NUMBER:
C-1

DO NOT SCALE DRAWINGS

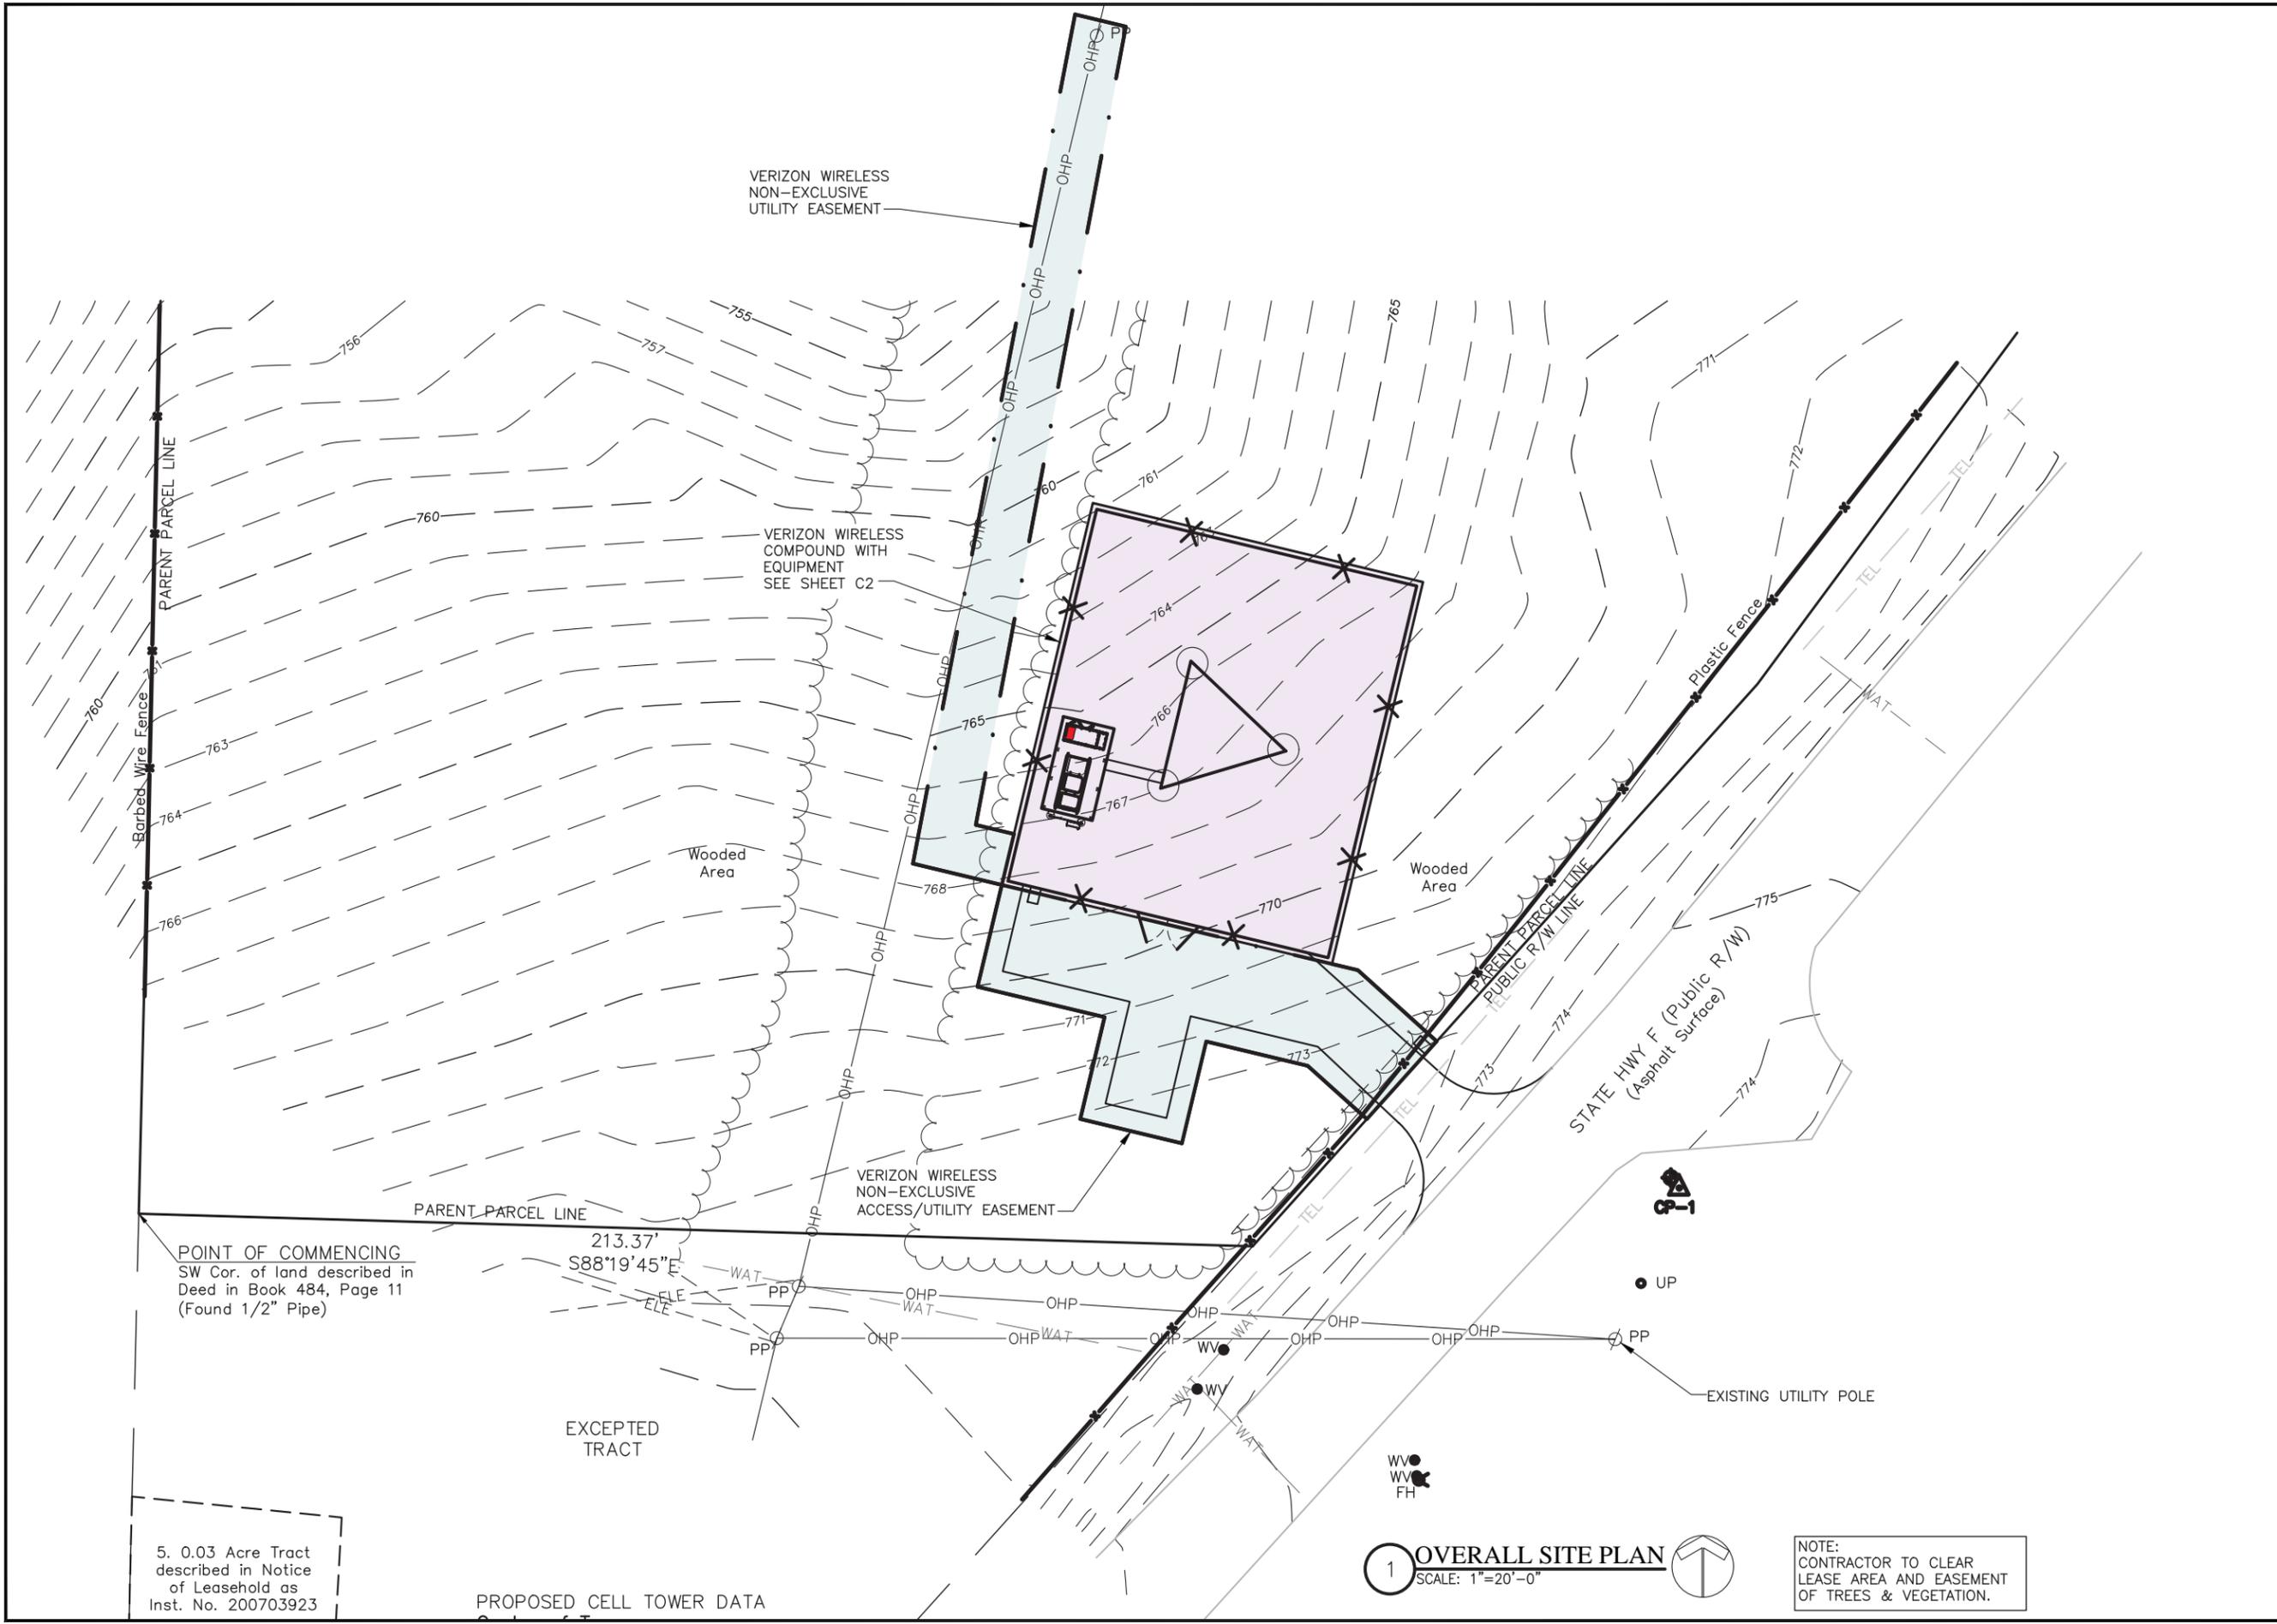

POINT OF COMMENCING
SW Cor. of land described in
Deed in Book 484, Page 11
(Found 1/2" Pipe)

213.37'
S88°19'45"E

5. 0.03 Acre Tract
described in Notice
of Leasehold as
Inst. No. 200703923

PROPOSED CELL TOWER DATA

1 OVERALL SITE PLAN
SCALE: 1"=20'-0"

NOTE:
CONTRACTOR TO CLEAR
LEASE AREA AND EASEMENT
OF TREES & VEGETATION.

VERIZON WIRELESS
NON-EXCLUSIVE
UTILITY EASEMENT

VERIZON WIRELESS
NON-EXCLUSIVE
ACCESS/UTILITY EASEMENT

TOWER FOUNDATION NOTE:
IF INSTALLING PAD TOWER FOUNDATION, THE DIMENSIONS
PER THE T&F DESIGN ARE WITHIN THE LEASE AREA AND
WILL NOT AFFECT EQUIPMENT PLACEMENT. GROUND RODS
TO BE INSTALLED OUTSIDE OF PAD FOUNDATION.

AGGREGATE BASE TO
EXTEND 12" BEYOND
FENCE SEE DETAIL
2/C-8

305'-0"
SELF SUPPORT TOWER
ON CONCRETE FOUNDATION

VERIZON EQUIPMENT PAD,
& 30KW DIESEL GENERATOR
SEE EQ SHEETS

73'-0"x63'-0"
CHAIN LINK FENCED AREA
SEE DETAIL 1/C-6

VERIZON WIRELESS
75'-0"x65'-0"
LAND SPACE

Wooded
Area

12' GATE SEE
DETAIL 1/C-6

ACCESS DRIVE
SEE DETAIL 4/C-7

1 ENLARGED SITE PLAN
SCALE: 1"=10'-0"



FORTUNE WIRELESS INC.
5511 WEST 79TH STREET
INDIANAPOLIS, IN 46278
(317) 832-1171

STATE OF MISSOURI
DAVID E. KASPER
NUMBER PE-018063
PROFESSIONAL ENGINEER
02/09/23

DRAWN BY: GNP

CHECKED BY: DEK

NO:	DATE:	ISSUE:
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2505770
1837 STATE HWY F
INNSBROOK,
MO 63390 WARREN
COUNTY


SHEET TITLE:
ENLARGED SITE PLAN

SHEET NUMBER:
C-2

DO NOT SCALE DRAWINGS



FORTUNE WIRELESS INC.
 5511 WEST 79TH STREET
 INDIANAPOLIS, IN 46278

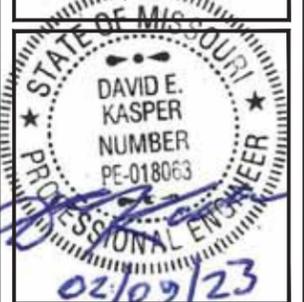

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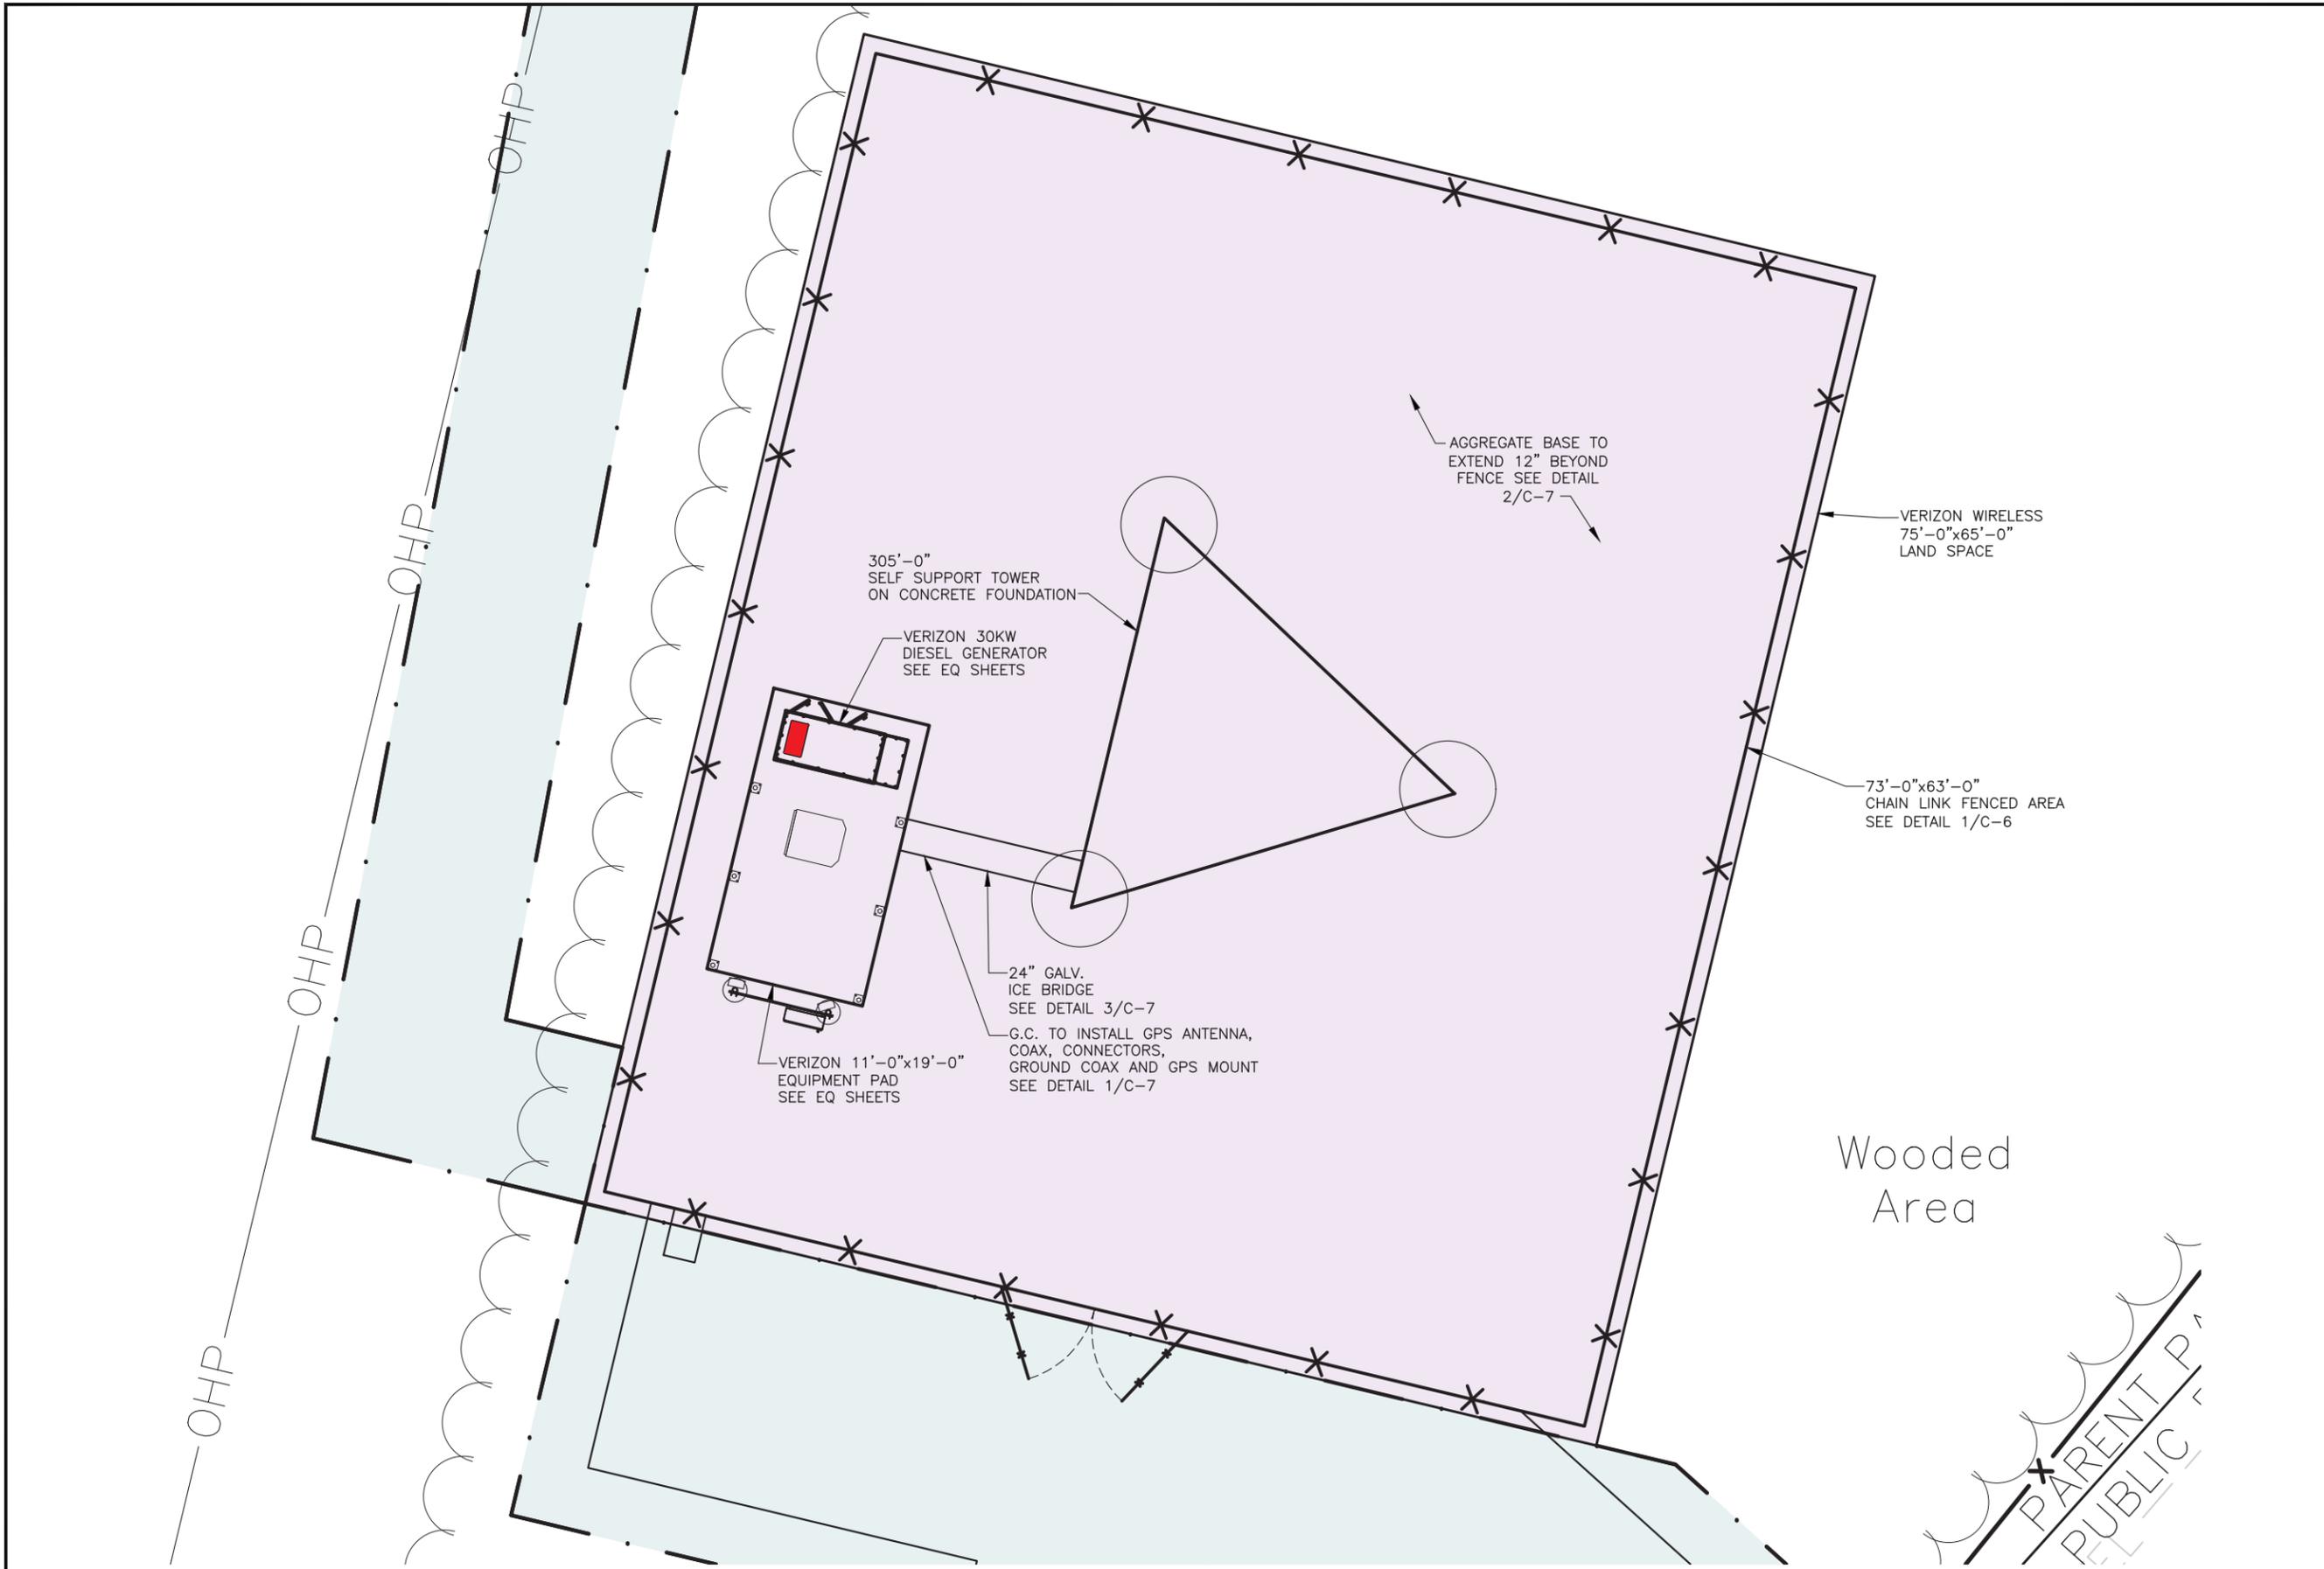
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STLC INNSBROOK
 LOCATION #: 2505770
 FUZE PROJECT #:
 2505770
 1837 STATE HWY F
 INNSBROOK,
 MO 63390 WARREN
 COUNTY

SHEET TITLE:
ENLARGED SITE PLAN

SHEET NUMBER:
C-3




1 ENLARGED SITE PLAN
 SCALE: 1"=10'-0"

PARENT P
 PUBLIC P



FORTUNE WIRELESS INC.
5511 WEST 79TH STREET
INDIANAPOLIS, IN 46278

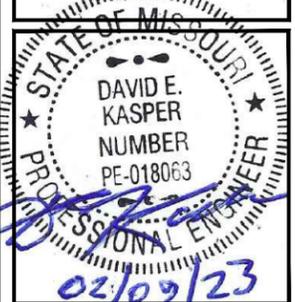

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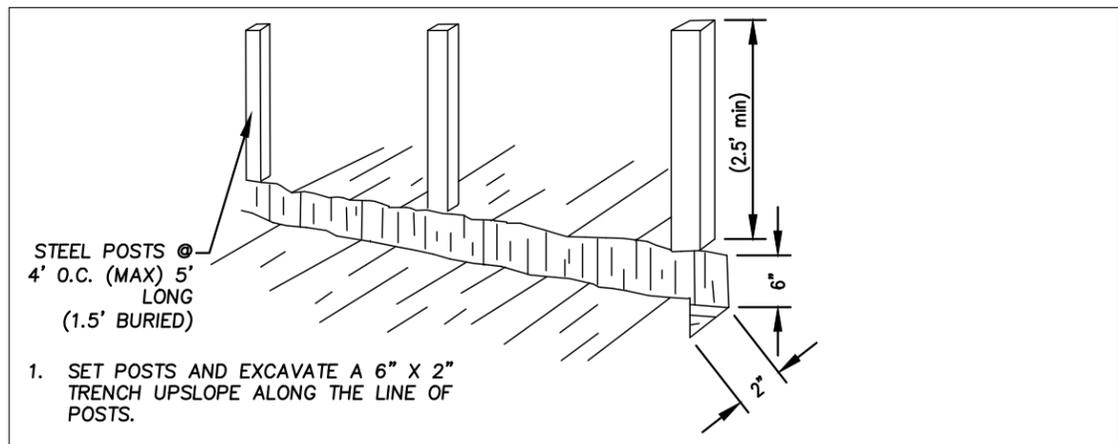
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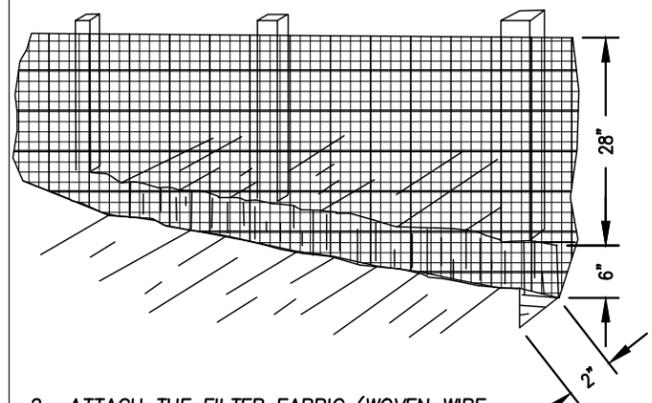
SHEET TITLE:
EROSION CONTROL DETAIL

SHEET NUMBER:
C-4


DO NOT SCALE DRAWINGS



1. SET POSTS AND EXCAVATE A 6" X 2" TRENCH UPSLOPE ALONG THE LINE OF POSTS.




2. ATTACH THE FILTER FABRIC (WOVEN WIRE BACKING) TO THE POSTS AND EXTEND IT INTO THE TRENCH. FILTER FABRIC SHALL MEET THE REQUIREMENTS OF THE DEPARTMENT OF TRANSPORTATION, STATE OF MISSOURI, STANDARD SPECIFICATION (MOST RECENT EDITION). FABRIC SHALL BE ON THE DOT APPROVAL PRODUCTS LIST.

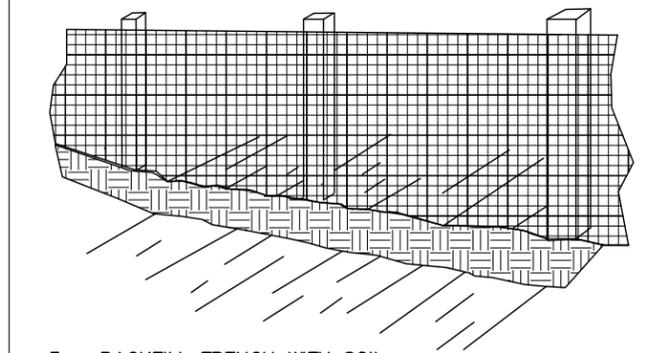

3. BACKFILL TRENCH WITH SOIL.

TYPE "C" FENCE
TENSILE STRENGTH (lbs. MIN.) WARP-260 (ASTM D-4632/FILL-180)
ELONGATION (% MAX.) 40 (ASTM D-4632)
AOS (APPARENT OPENING SIZE) #30 (MAX. SIEVE SIZE) (ASTM D 4751)
FLOW RATE (GAL./MIN./SQ.FT) 70 (GDT-87)
ULTRAVIOLET STABILITY 80 (ASTM D-4632 AFTER 300 HOURS WEATHERING IN ACCORDANCE WITH ASTM D-4355)
BURSTING STRENGTH (PSI MIN.) 175 (ASTM D-3786 DIAPHRAGM BURSTING STRENGTH TESTER)
MINIMUM FABRIC WIDTH (INCHES) 36

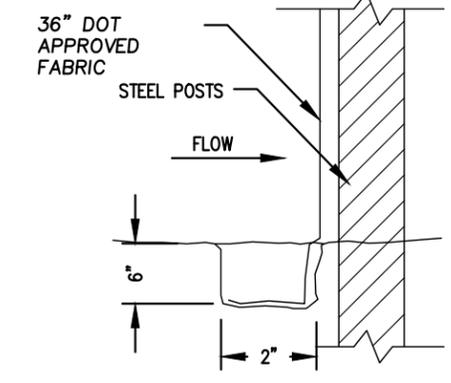


SILT FENCE SECTION

MAINTENANCE REQUIREMENTS

SEDIMENT SHALL BE REMOVED ONCE IT HAS ACCUMULATED TO ONE-HALF THE ORIGINAL HEIGHT OF THE BARRIER. FILTER FABRIC SHALL BE REPLACED WHENEVER IT HAS DETERIORATED TO SUCH AN EXTENT THAT THE EFFECTIVENESS OF THE FABRIC IS REDUCED (APPROXIMATELY 6 MONTHS). TEMPORARY SEDIMENT BARRIERS SHALL REMAIN IN PLACE UNTIL DISTURBED AREAS HAVE BEEN PERMANENTLY STABILIZED. ALL SEDIMENT ACCUMULATED AT THE BARRIER SHALL BE REMOVED AND PROPERLY DISPOSED OF BEFORE THE BARRIER IS REMOVED.

Sd1-C TYPE C SILT FENCE
N.T.S.

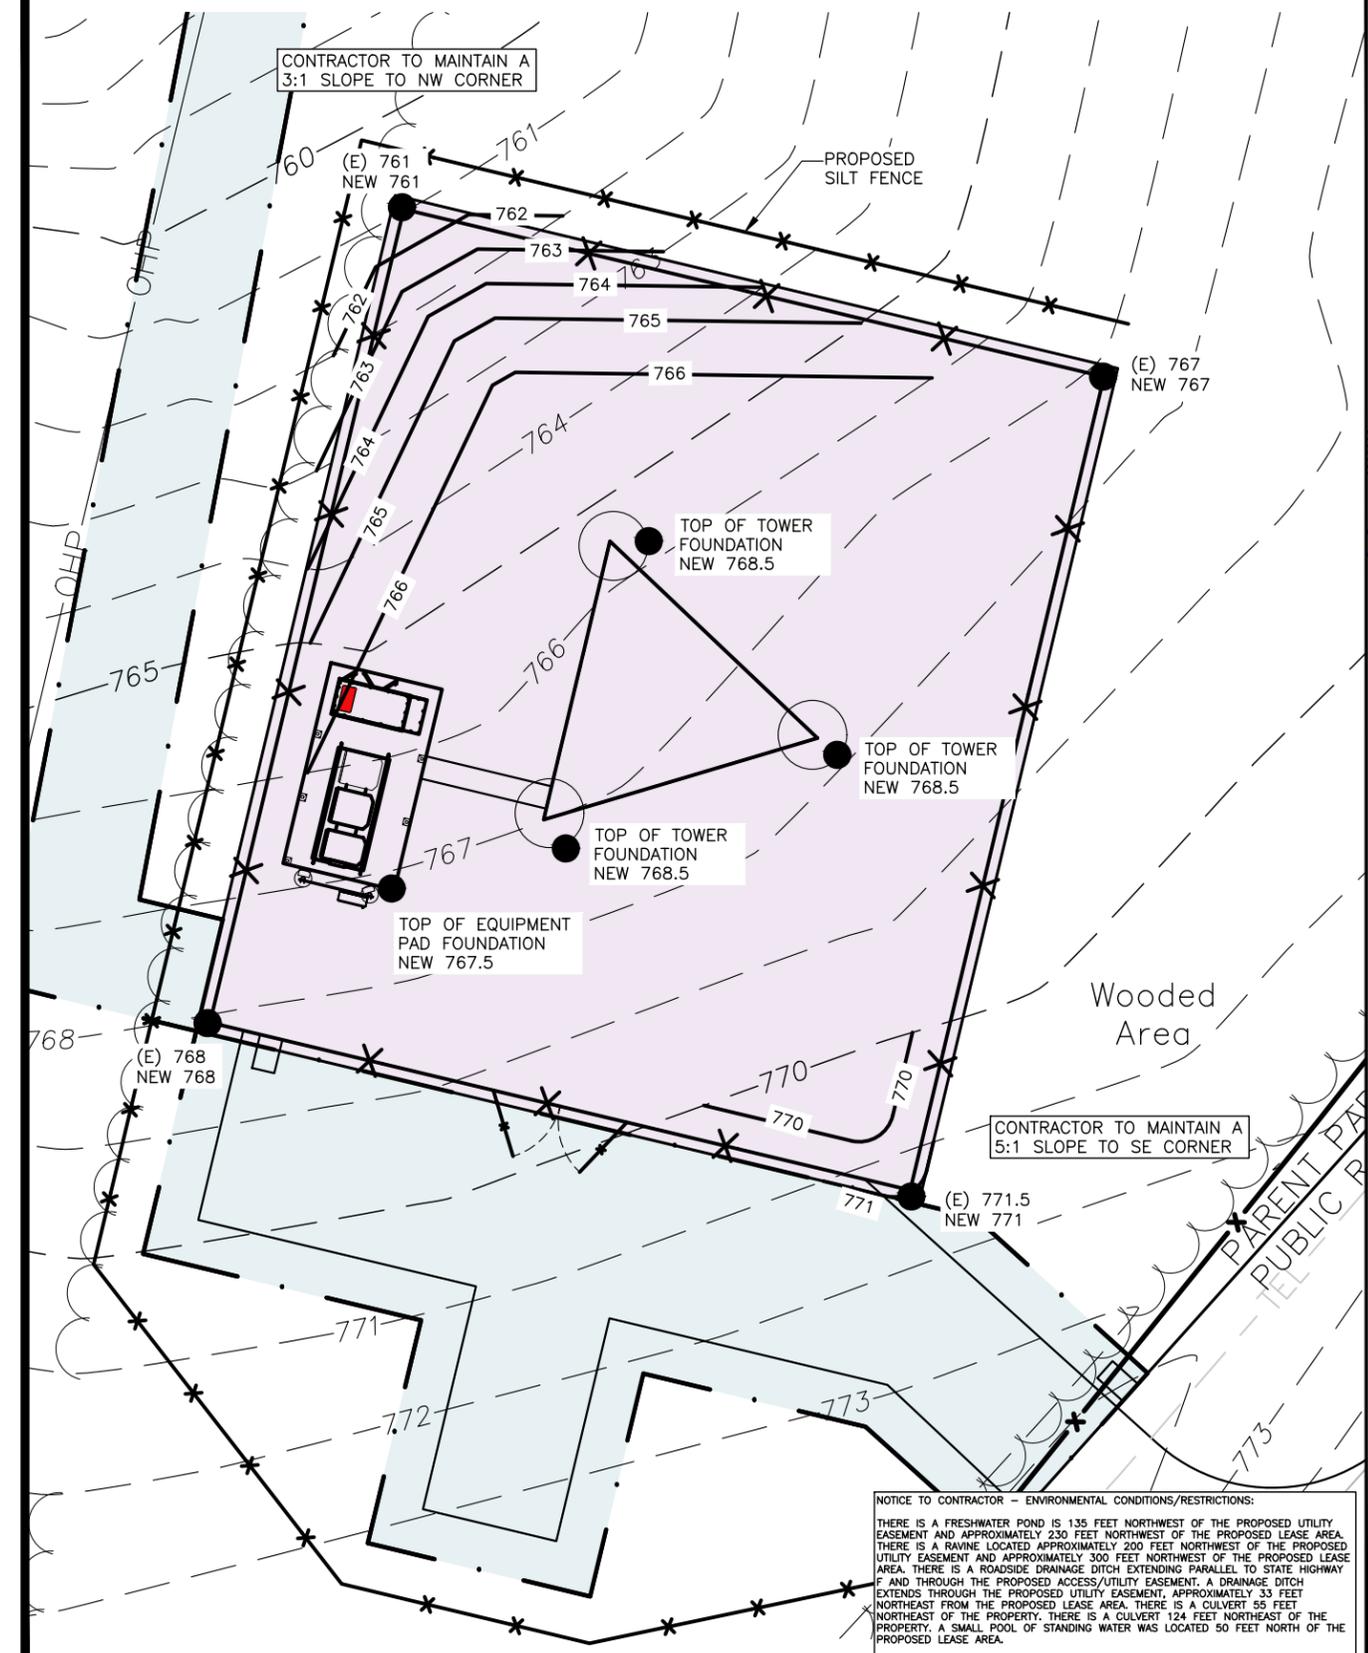

CONTRACTOR TO MAINTAIN A 3:1 SLOPE TO NW CORNER

PROPOSED SILT FENCE

TOP OF TOWER FOUNDATION NEW 768.5

TOP OF TOWER FOUNDATION NEW 768.5

TOP OF TOWER FOUNDATION NEW 768.5

TOP OF EQUIPMENT PAD FOUNDATION NEW 767.5


Wooded Area

CONTRACTOR TO MAINTAIN A 5:1 SLOPE TO SE CORNER


NOTICE TO CONTRACTOR - ENVIRONMENTAL CONDITIONS/RESTRICTIONS:
THERE IS A FRESHWATER POND 135 FEET NORTHWEST OF THE PROPOSED UTILITY EASEMENT AND APPROXIMATELY 230 FEET NORTHWEST OF THE PROPOSED LEASE AREA. THERE IS A RAVINE LOCATED APPROXIMATELY 200 FEET NORTHWEST OF THE PROPOSED UTILITY EASEMENT AND APPROXIMATELY 300 FEET NORTHWEST OF THE PROPOSED LEASE AREA. THERE IS A ROADSIDE DRAINAGE DITCH EXTENDING PARALLEL TO STATE HIGHWAY F AND THROUGH THE PROPOSED ACCESS/UTILITY EASEMENT. A DRAINAGE DITCH EXTENDS THROUGH THE PROPOSED UTILITY EASEMENT, APPROXIMATELY 33 FEET NORTHEAST FROM THE PROPOSED LEASE AREA. THERE IS A CULVERT 55 FEET NORTHEAST OF THE PROPERTY. THERE IS A CULVERT 124 FEET NORTHEAST OF THE PROPERTY. A SMALL POOL OF STANDING WATER WAS LOCATED 50 FEET NORTH OF THE PROPOSED LEASE AREA.

SOIL EROSION AND SEDIMENTATION CONTROLS / BEST MANAGEMENT PRACTICES:
TO PREVENT ANY NEGATIVE IMPACT TO THE SENSITIVE RECEPTORS, SEDIMENT AND EROSION CONTROL MEASURES, SUCH AS SILT FENCES, STRAW WATTLES, AND OTHER STORM-WATER BEST MANAGEMENT PRACTICES, MUST BE IMPLEMENTED PRIOR TO AND MAINTAINED THROUGHOUT CONSTRUCTION.
STAGING AND STOCKPILING RESTRICTIONS:
CONSTRUCTION RELATED STAGING AND STOCKPILING OF SOILS AND EQUIPMENT MAY NOT OCCUR IN THE VICINITY OF THE SENSITIVE RECEPTORS OR IN A MANNER THAT WILL CAUSE IMPACTS.


1 GRADING PLAN
SCALE: 1"=20'-0"

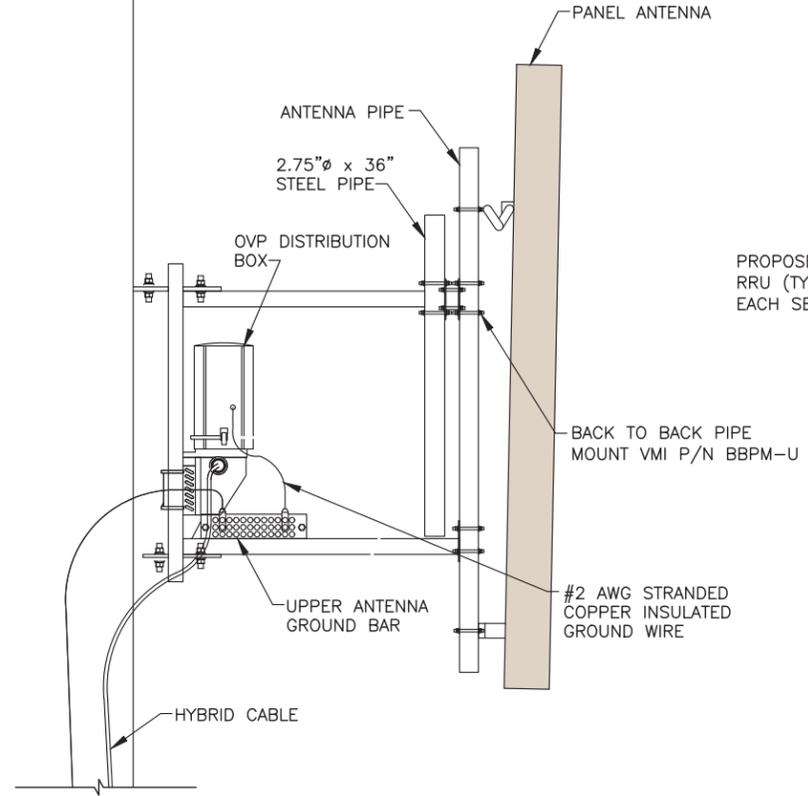

3 ANTENNA & OVP JUNCTION BOX MOUNTING DETAIL
SCALE: N.T.S.

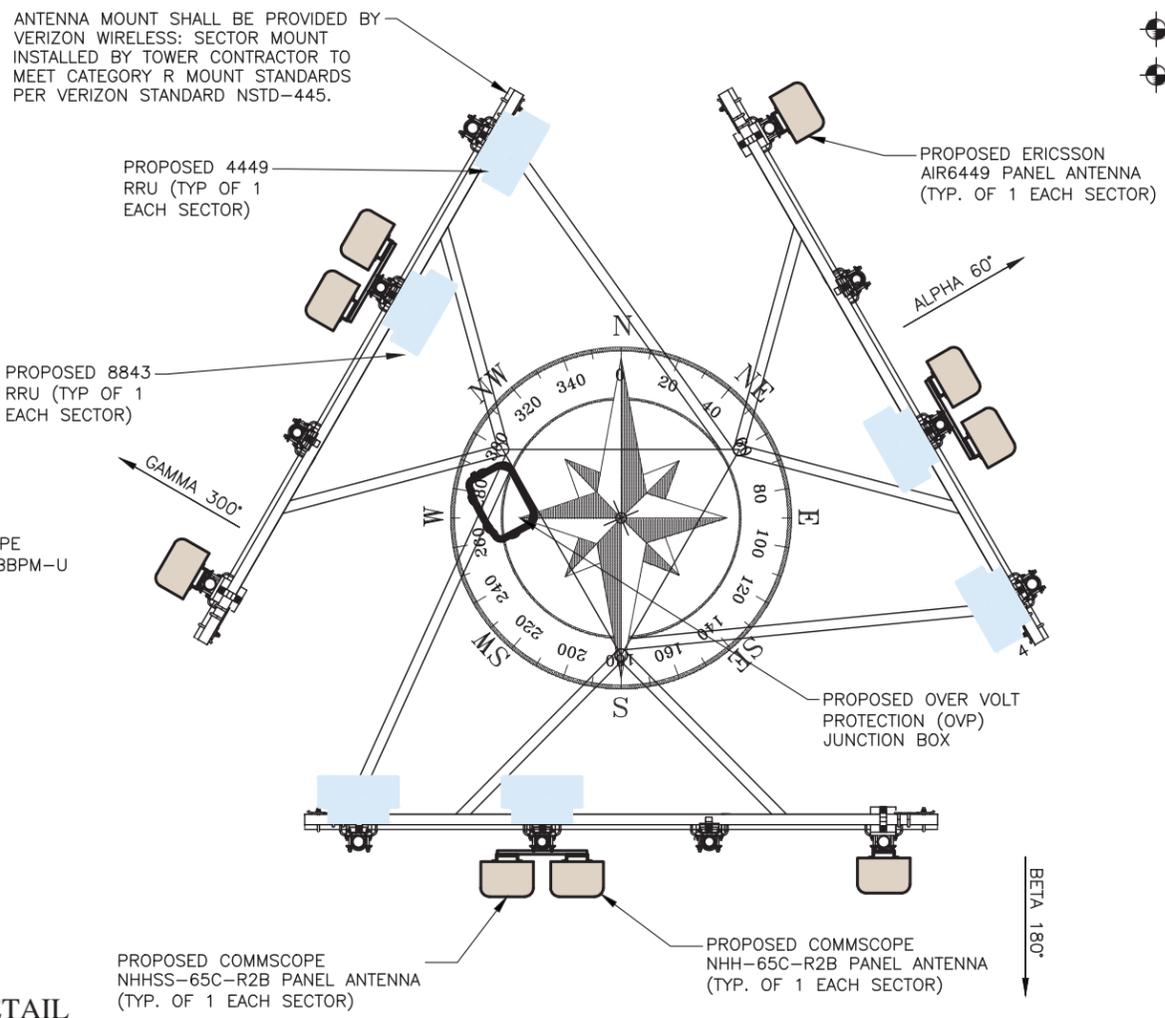

2 PROPOSED ANTENNA LAYOUT
SCALE: N.T.S.

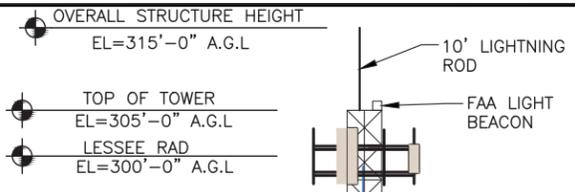

1 NEW TOWER ELEVATION
SCALE: N.T.S.

NOTE:

1. TOWER TO BE EQUIPPED WITH APPROPRIATE ANTI-CLIMBING DEVICES AND CLEARLY MARKED NO TRESPASSING.
2. TOWER & FOUNDATION TO BE DESIGNED BY OTHERS
3. TOWER MOUNTS & SECTOR FRAME BY TOWER MANUFACTURER TO MEET CATEGORY R SPECIFICATIONS PER VERIZON NTSD-445 SECTIONS 8&9.

TOWER INFORMATION ON DRAWINGS IS FOR ILLUSTRATIVE PURPOSES ONLY. IT IS UNDERSTOOD BY FORTUNE WIRELESS THAT THE TOWER DESIGN AND CALCULATIONS FOR THE TOWER FOUNDATION, STRUCTURE, AND MOUNTS HAS BEEN PERFORMED BY OTHERS. FORTUNE WIRELESS HAS NOT PERFORMED INVESTIGATIONS AND CALCULATIONS FOR THE STRUCTURE AND TAKES NO RESPONSIBILITY FOR THE STRUCTURAL INTEGRITY OF THE TOWER, FOUNDATION, OR ANTENNA MOUNTS. CONTRACTOR IS TO OBTAIN STRUCTURAL ANALYSIS AND INSTALLATION SPECIFICATIONS FROM THE TOWER OWNER AND SHALL NOTIFY FORTUNE WIRELESS IMMEDIATELY IF THE SPECIFICATIONS ARE NOT AVAILABLE FROM THE TOWER OWNER.

ANTENNA NOTES:

- 1: CONTRACTOR TO CALL PROJECT MANAGER TO SCHEDULE ANTENNA AND LINE SWEEP.
- 2: ANTENNAS SHALL BE DESIGNED FROM RIGHT TO LEFT. FACING THE ASSEMBLY FROM THEN GROUND. LEFT TO RIGHT FACING THE BACK OF THE ANTENNA.
- 3: CONTRACTOR SHALL FIELD VERIFY THE EXACT TMA'S (IF REQUIRED) PER THE OPERATIONS MANAGER.
- 4: COAX CABLES TO BE SUPPORTED EVERY 3' ON PLATFORM WITH STAINLESS STEEL HANGERS.
- 5: JUMPERS TO BE SUPPORTED EVERY 18" W/ STAINLESS STEEL HANGERS.
- 6: EACH COAX SHALL BE SUPPORTED WITH COLUMN GRIP HUNG FROM A J-HOOK AT TOP OF TOWER
- 7: ALL ANTENNAS TO BE SET TO TRUE NORTH USING ANTENNA ALIGNMENT TOOL.
- 8: CONTRACTOR TO REFER TO CONSTRUCTION MANAGER FOR FINAL CARRIER RFDS & EQUIPMENT SPECIFICATIONS FOR FINAL TOWER & BASE CONFIGURATION DETAILS.



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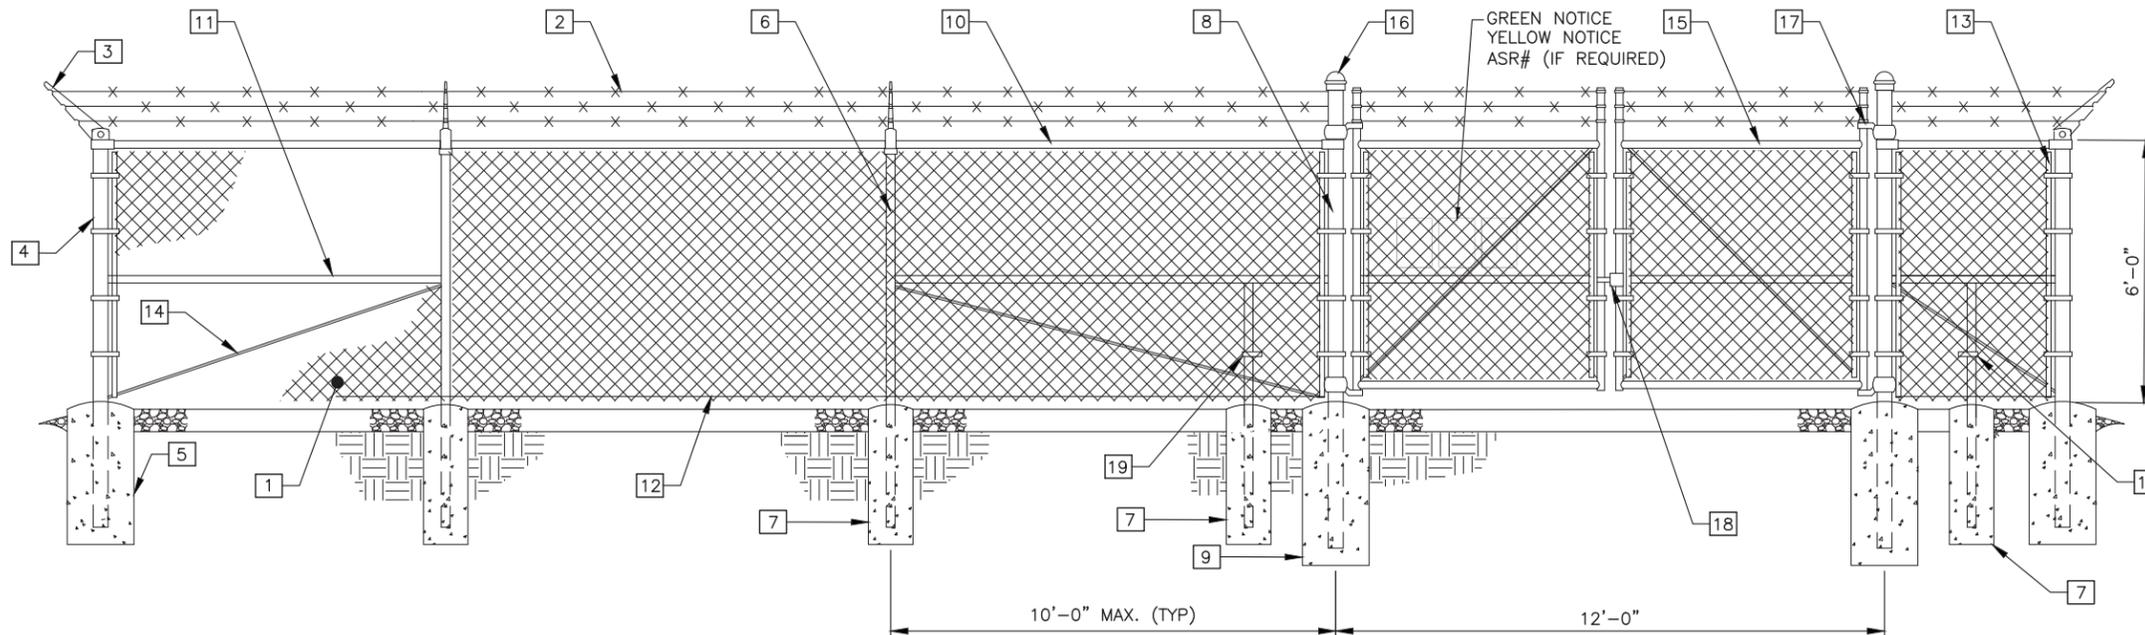
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STLC INNSBROOK
LOCATION #: 2505770
FUZE PROJECT #:
2505770
1837 STATE HWY F
INNSBROOK,
MO 63390 WARREN
COUNTY

SHEET TITLE:
**ELEVATION & ANTENNA
DETAIL**

SHEET NUMBER:
C-5

DO NOT SCALE DRAWINGS




1 TYPICAL FENCE SECTION
SCALE: N.T.S.

KEYNOTE LEGEND:

- | | |
|---|--|
| 1 FABRIC: 6FT. HEIGHT, 9 GAUGE, 2" MESH, ASTM A392. | 11 MIDDLE RAILS: 1-1/2"Ø PIPE SCH. 40 (GALV.) ASTM F1083 |
| 2 BARBED WIRE: 12 GAUGE WIRE, 4 POINT (3 RUNS), FINISH TO MATCH FABRIC, ASTM A121. | 12 BOTTOM TENSION WIRE: 0.177"Ø METALLIC-COATED STEEL (GALV.), MARCELLED, ASTM A824 |
| 3 EXTENSION ARMS: STAMPED STEEL WITH MALLEABLE IRON BASE, FINISH TO MATCH FENCE FRAMEWORK, ASTM F626. | 13 TENSION BARS: 3/16"x3/4", FULL HEIGHT OF FABRIC, FINISH TO MATCH FENCE FRAMEWORK. |
| 4 END AND CORNER POSTS: 3"Ø PIPE SCH. 40 (GALV.) ASTM F1083 | 14 TENSION ROD: 3/8"Ø WITH ADJ. TIGHTNER, FINISH TO MATCH FENCE FRAMEWORK. |
| 5 CONCRETE FOUNDATION: 36"x12"Ø (3000 PSI) | 15 GATE FRAME: 2"Ø SCH. 40 (GALV.) ASTM F1083 |
| 6 LINE POSTS: 2"Ø PIPE SCH. 40 (GALV.) ASTM F1083 | 16 POST CAPS: PER POST DIAMETER. |
| 7 CONCRETE FOUNDATION: 36"x10"Ø (3000 PSI) | 17 GATE HINGES: NON-LIFT-OFF TYPE, OFFSET TO PERMIT 180 DEGREE SWING. |
| 8 GATE POSTS: 4"Ø PIPE SCH. 40 (GALV.) ASTM F1083 | 18 STRONG ARM GATE LATCH |
| 9 CONCRETE FOUNDATION: 48"x12"Ø (3000 PSI) | 19 DUCK BILL OPEN GATE HOLDER. VERIFY LOCATION IN FIELD BEFORE INSTALLATION |
| 10 TOP RAIL & BRACE RAIL: 1-1/2"Ø PIPE SCH. 40 (GALV.) ASTM F1083 | |

FENCE NOTES:

- REFER TO PROJECT SPECIFICATIONS FOR INFORMATION NOT SHOWN IN THE DRAWING.
- FENCE FABRIC SHALL CONFORM TO CHAIN LINK FENCE MANUFACTURERS INSTITUTE (CLFMI) PRODUCT MANUAL.
- INSTALL FENCE IN COMPLIANCE WITH ASTM F 567.
- INSTALL SWING GATES IN COMPLIANCE WITH ASTM F 900.
- DO NOT BEGIN INSTALLATION AND ERECTION BEFORE FINAL GRADING IS COMPLETED, UNLESS OTHERWISE PERMITTED. INSTALL FENCING ON BOUNDARY LINES INSIDE OF PROPERTY LINE ESTABLISHED BY SURVEY.
- DRILL OR HAND-EXCAVATE (USING POST - HOLE DIGGER) HOLES FOR POSTS TO DIAMETERS AND SPACING INDICATED, IN FIRM, UNDISTURBED OR COMPACTED SOIL. IF NOT INDICATED ON DRAWINGS, EXCAVATE HOLES FOR EACH POST TO MINIMUM DIAMETER RECOMMENDED BY FENCE MANUFACTURER, BUT NOT LESS THAN (4) TIMES LARGEST GROSS-SECTION OF POST.
- REMOVE POST HOLE SPOILS FROM SITE. DO NOT SET SPOILS ON AGGREGATE WITHOUT ADEQUATE PROTECTION.
- PROTECT PORTION OF POSTS ABOVE GROUND FROM CONCRETE SPLATTER. PLACE CONCRETE AROUND POSTS AND VIBRATE OR TAMP FOR CONSOLIDATION. CHECK EACH POST FOR VERTICAL AND TOP ALIGNMENT AND HOLD IN POSITION DURING PLACEMENT AND FINISHING OPERATIONS, UNLESS OTHERWISE SHOWN, EXTEND CONCRETE FOOTING 1 INCH ABOVE GRADE AND TROWEL TO A CROWN TO SHED WATER.
- INSTALL BARBED WIRE IN ACCORDANCE WITH MANUFACTURER'S INSTRUCTIONS.
- APPLY FABRIC TO OUTSIDE OF FRAMEWORK.

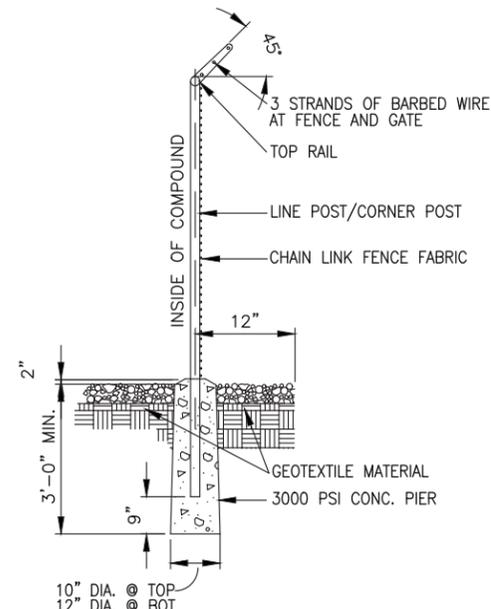

2 FENCE DETAIL
SCALE: N.T.S.




3 STRONG ARM GATE LATCH
SCALE: N.T.S.



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STLC INNSBROOK
LOCATION #: 2505770
FUZE PROJECT #:
2505770
1837 STATE HWY F
INNSBROOK,
MO 63390 WARREN
COUNTY

SHEET TITLE:

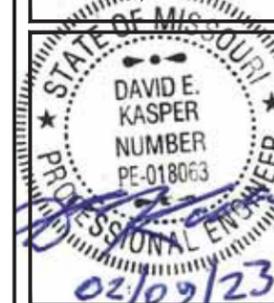CIVIL DETAILS

SHEET NUMBER:


C-6

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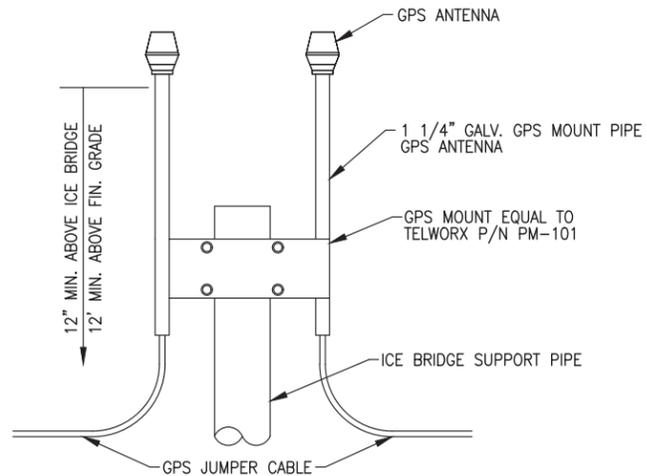
STLC INNSBROOK
LOCATION #: 2505770
FUZE PROJECT #:
2505770
1837 STATE HWY F
INNSBROOK,
MO 63390 WARREN
COUNTY

SHEET TITLE:


CIVIL DETAILS

SHEET NUMBER:

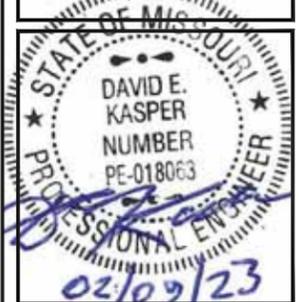C-7




1 DUAL GPS MOUNT DETAIL
SCALE: N.T.S.

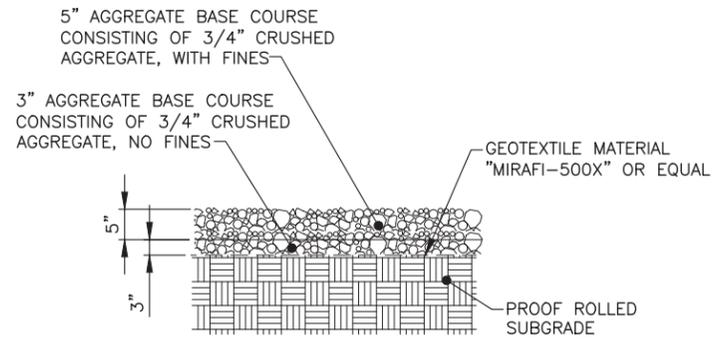


NOTE:
IT IS THE RESPONSIBILITY OF THE G.C. TO VERIFY THAT THE LIMESTONE IS UNIFORMLY WHITE IN COLOR AFTER PLACEMENT

2 SITE SURFACING DETAIL
SCALE: N.T.S.

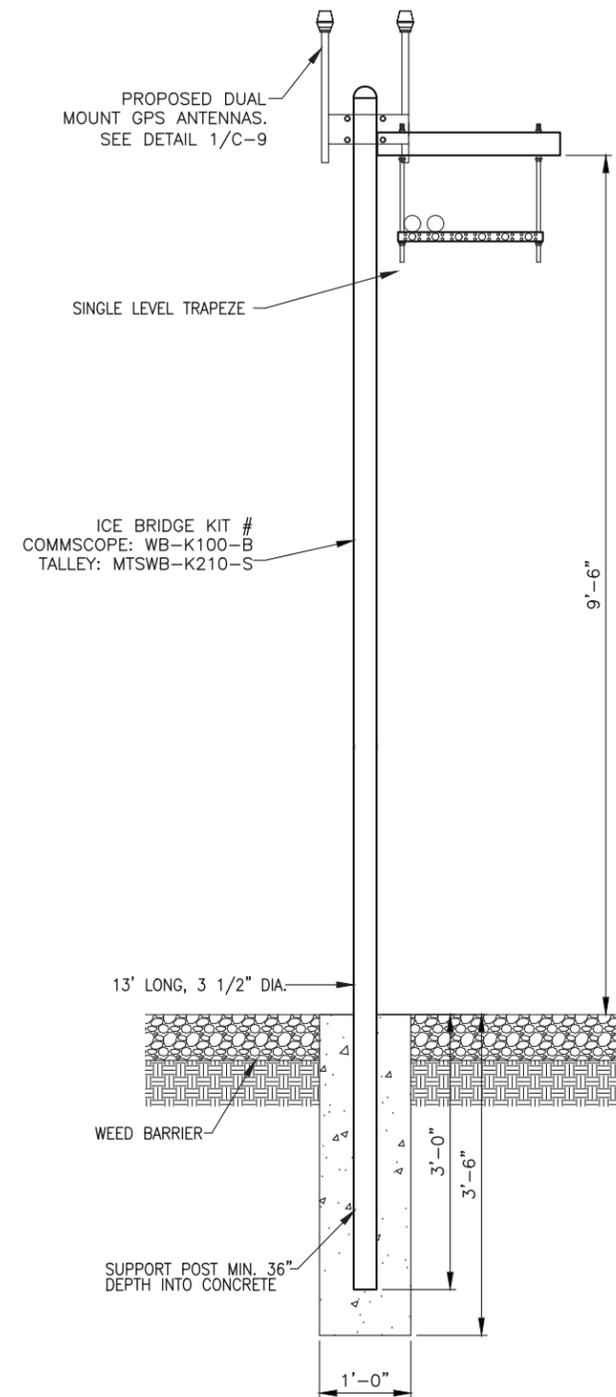

3 ICE BRIDGE SECTION
SCALE: N.T.S.

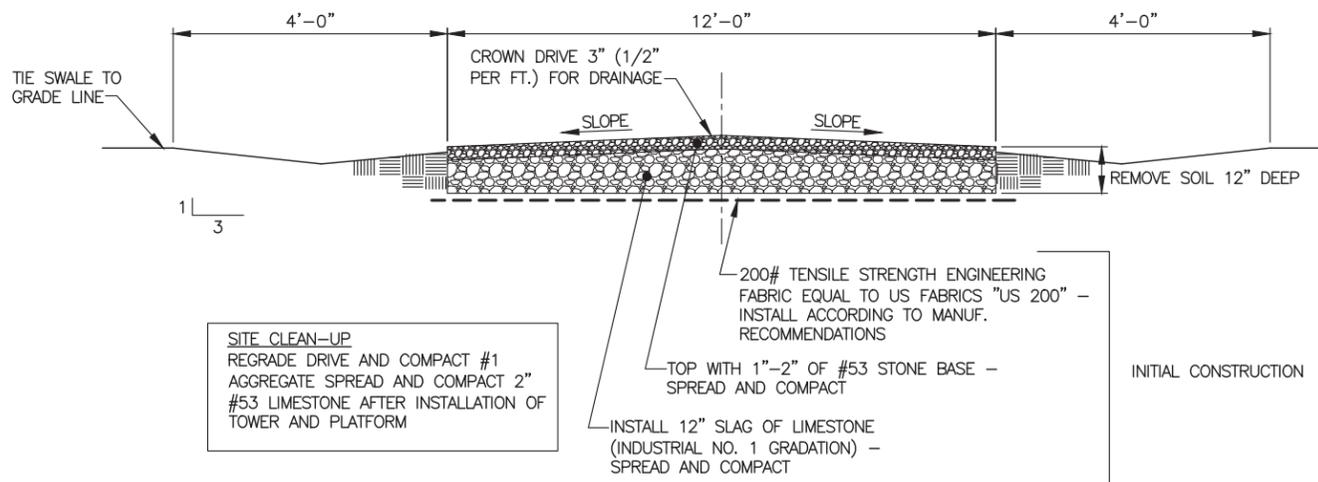


SITE CLEAN-UP
REGRADE DRIVE AND COMPACT #1 AGGREGATE SPREAD AND COMPACT 2\"/>

4 ACCESS DRIVE DETAIL
SCALE: N.T.S.



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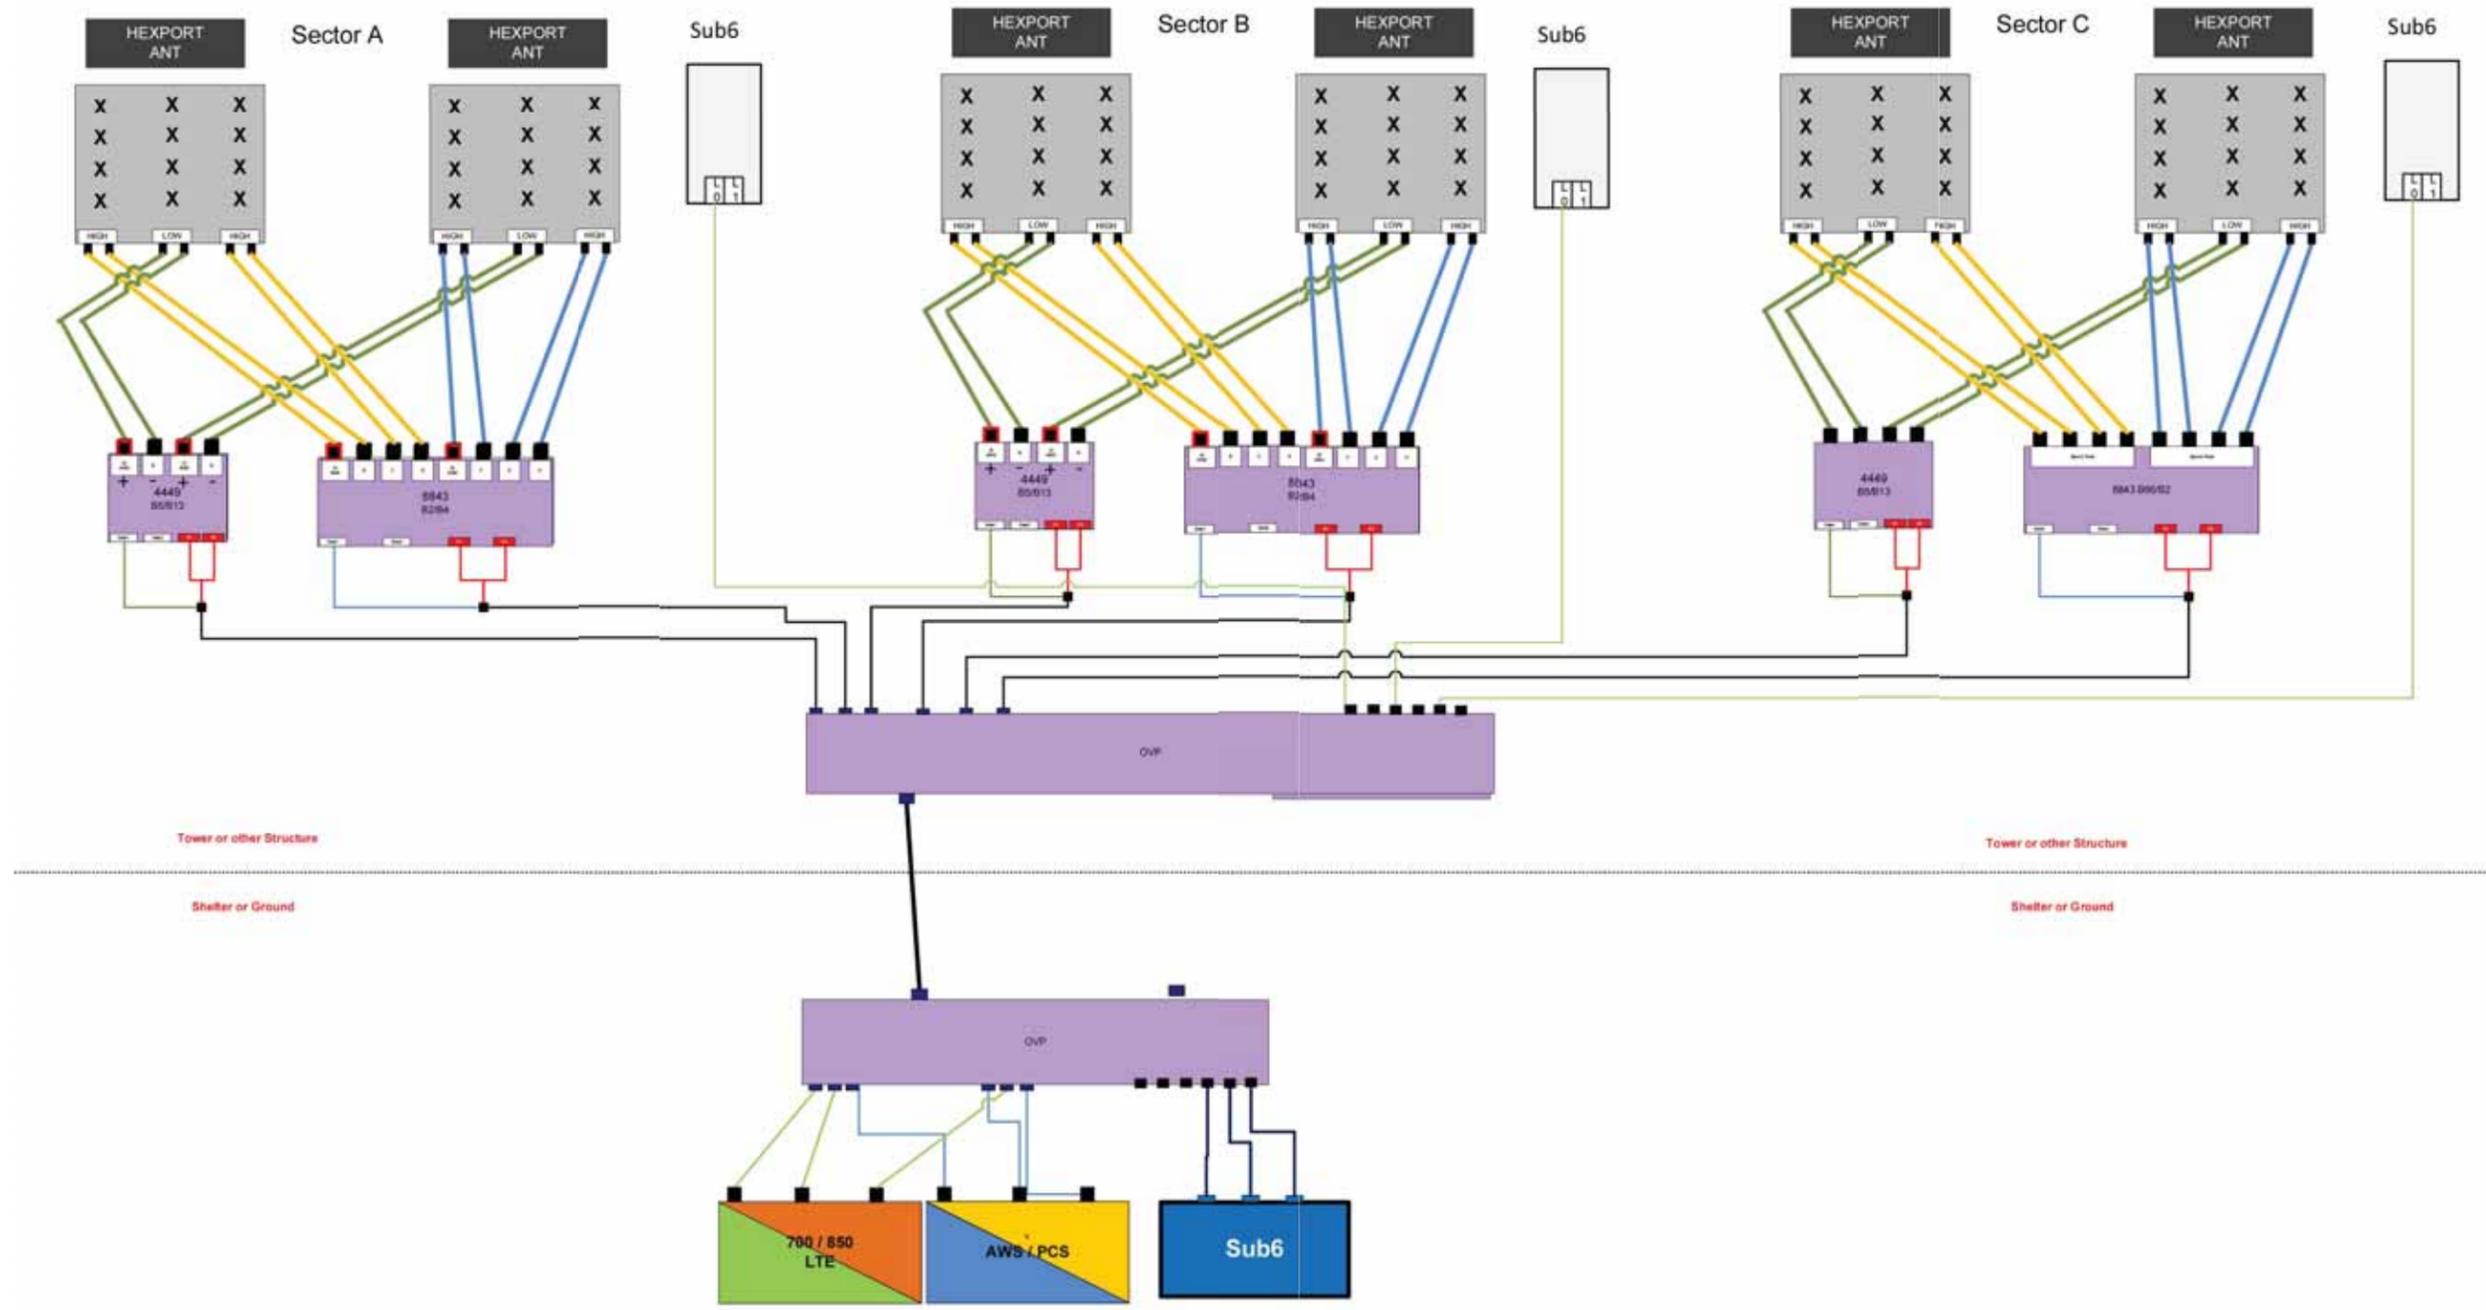
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LOCATION #: 2505770
FUZE PROJECT #:
2505770
1837 STATE HWY F
INNSBROOK,
MO 63390 WARREN
COUNTY

SHEET TITLE:
PLUMBING DIAGRAM

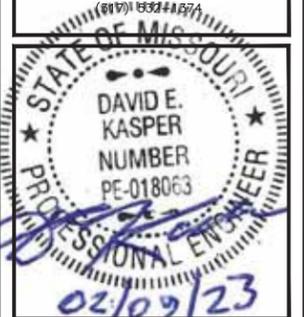
SHEET NUMBER:
C-8





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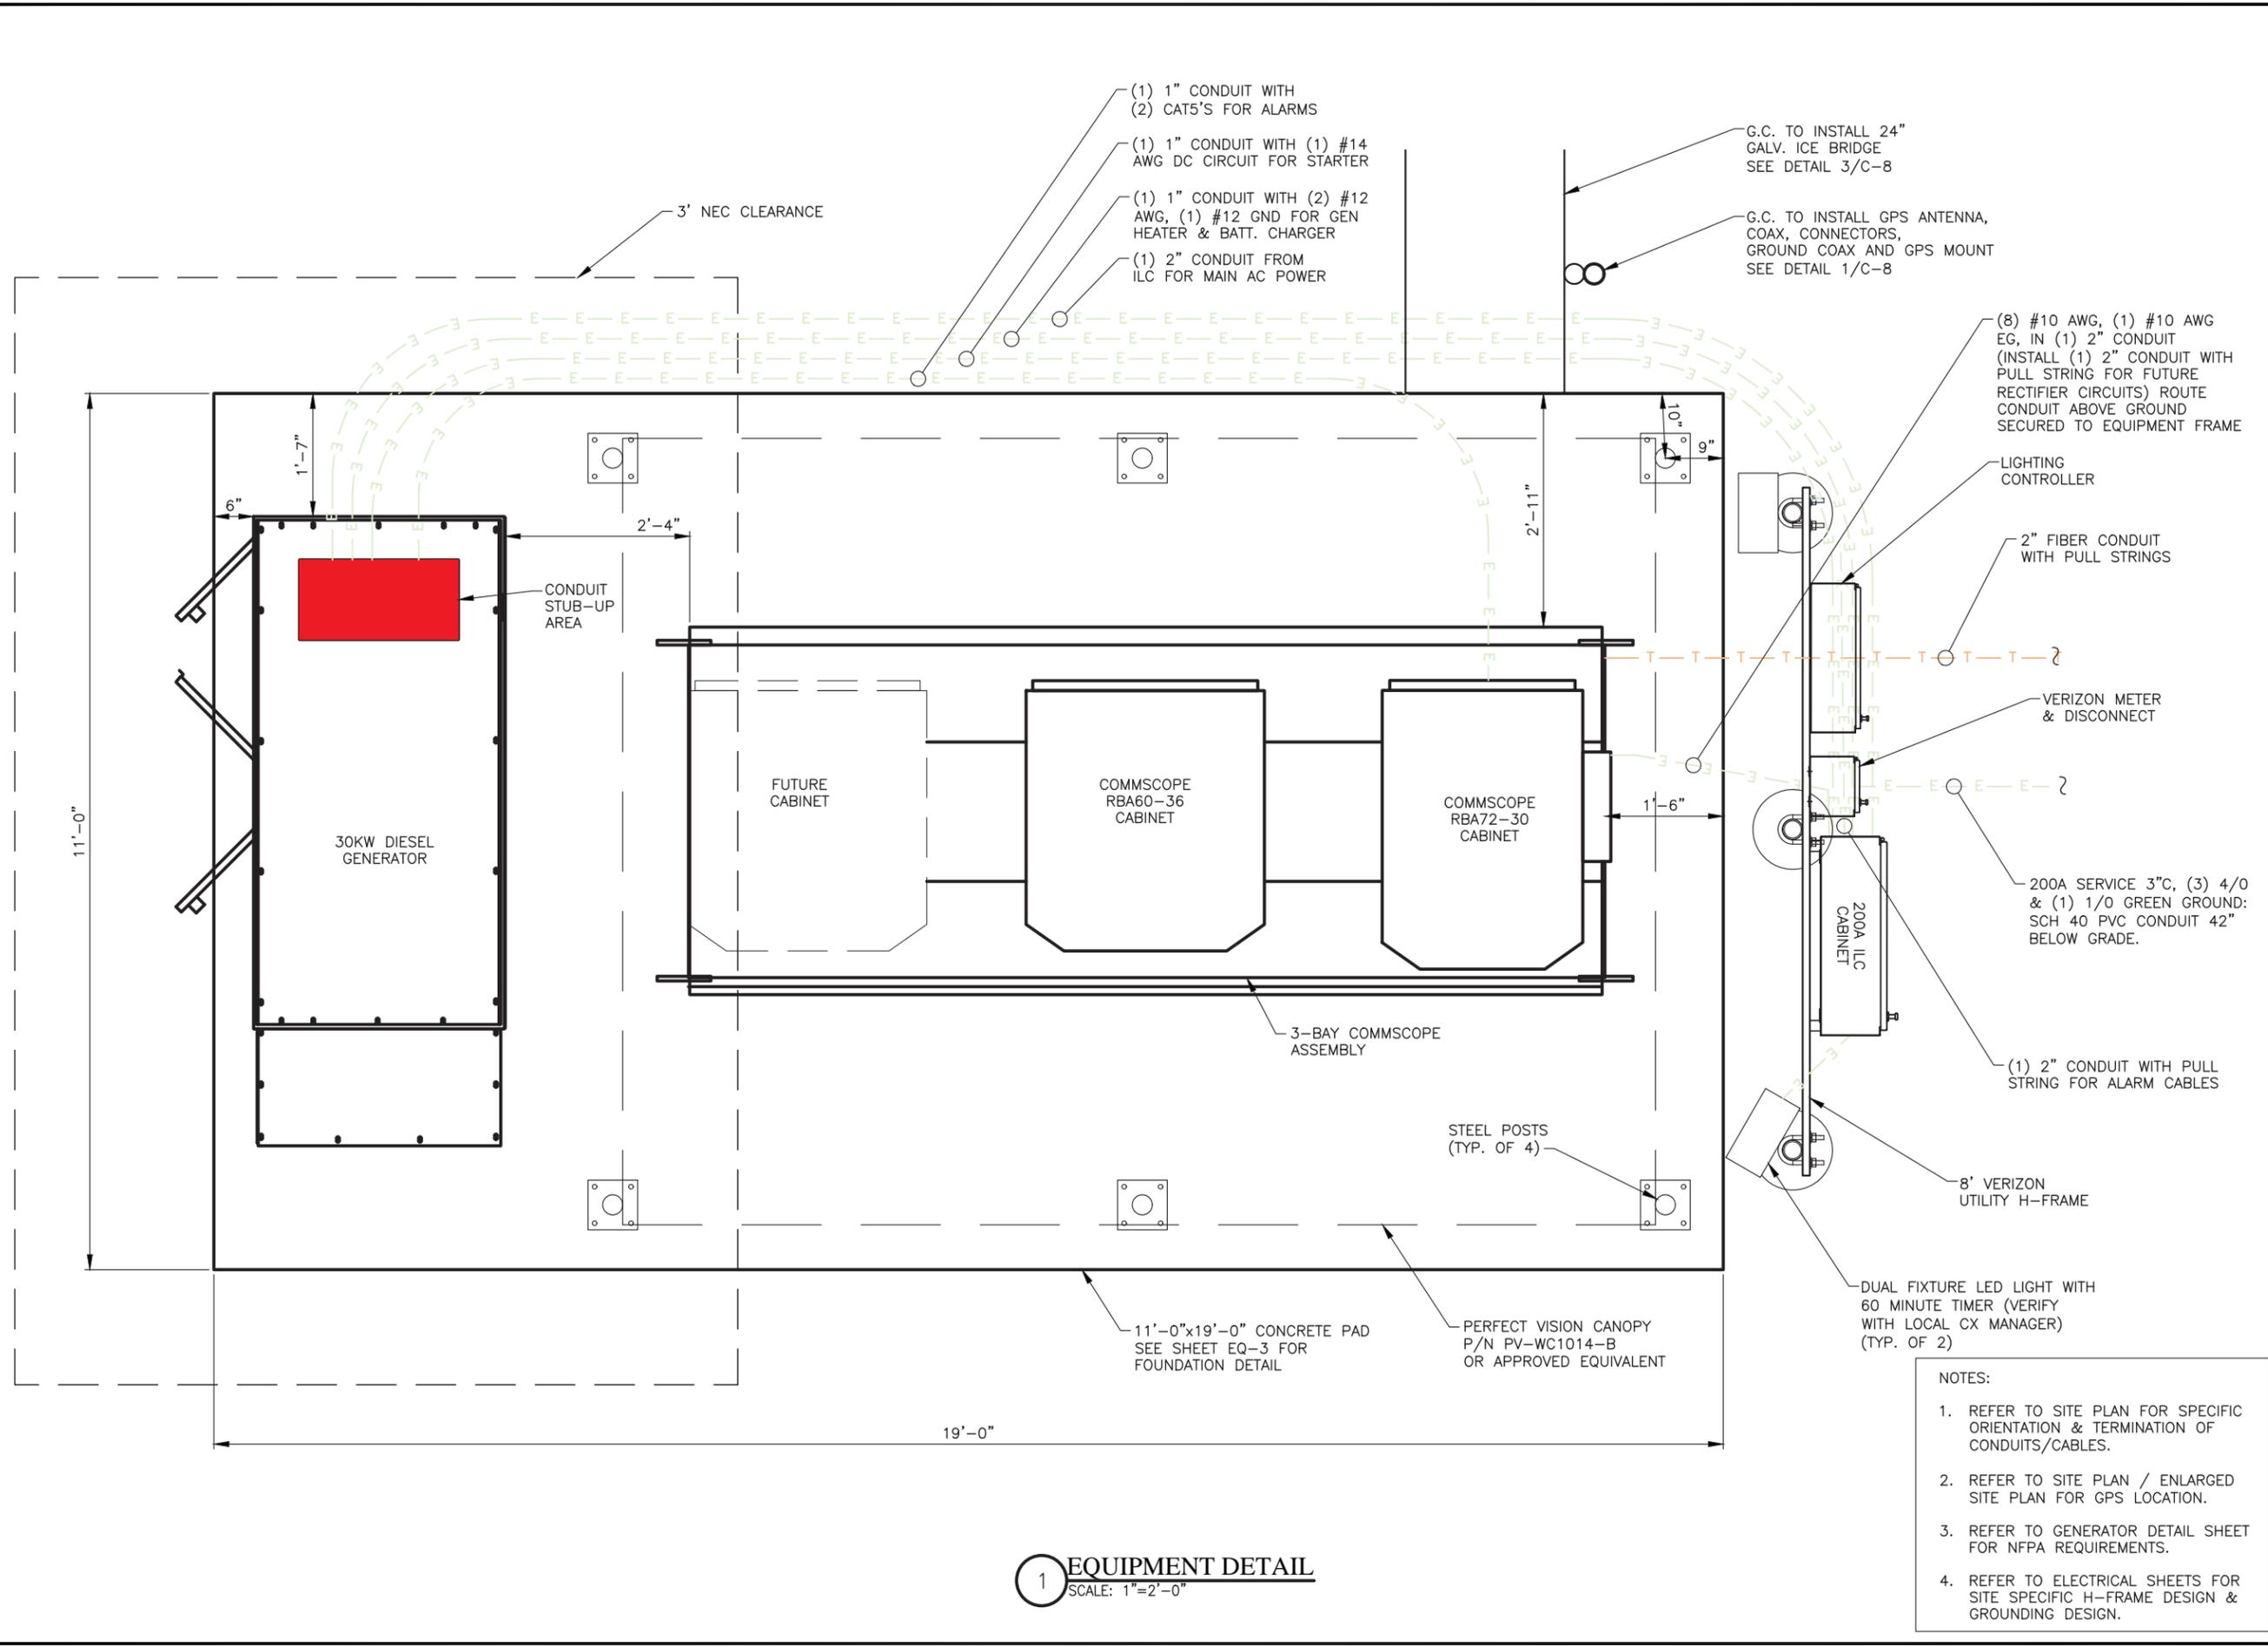
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FUZE PROJECT #:
2505770
1837 STATE HWY F
INNSBROOK,
MO 63390 WARREN
COUNTY

SHEET TITLE:
EQUIPMENT PLAN

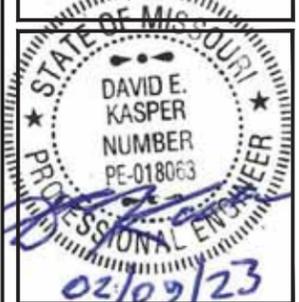SHEET NUMBER:
EQ-1

DO NOT SCALE DRAWINGS



- NOTES:
- REFER TO SITE PLAN FOR SPECIFIC ORIENTATION & TERMINATION OF CONDUITS/CABLES.
 - REFER TO SITE PLAN / ENLARGED SITE PLAN FOR GPS LOCATION.
 - REFER TO GENERATOR DETAIL SHEET FOR NFPA REQUIREMENTS.
 - REFER TO ELECTRICAL SHEETS FOR SITE SPECIFIC H-FRAME DESIGN & GROUNDING DESIGN.


1 EQUIPMENT DETAIL
SCALE: 1"=2'-0"

- NOTES:
1. REFER TO SITE PLAN FOR SPECIFIC ORIENTATION & TERMINATION OF CONDUITS/CABLES.
 2. REFER TO GENERATOR DETAIL SHEET FOR NFPA REQUIREMENTS.
 3. REFER TO ELECTRICAL SHEETS FOR SITE SPECIFIC H-FRAME DESIGN & GROUNDING DESIGN.



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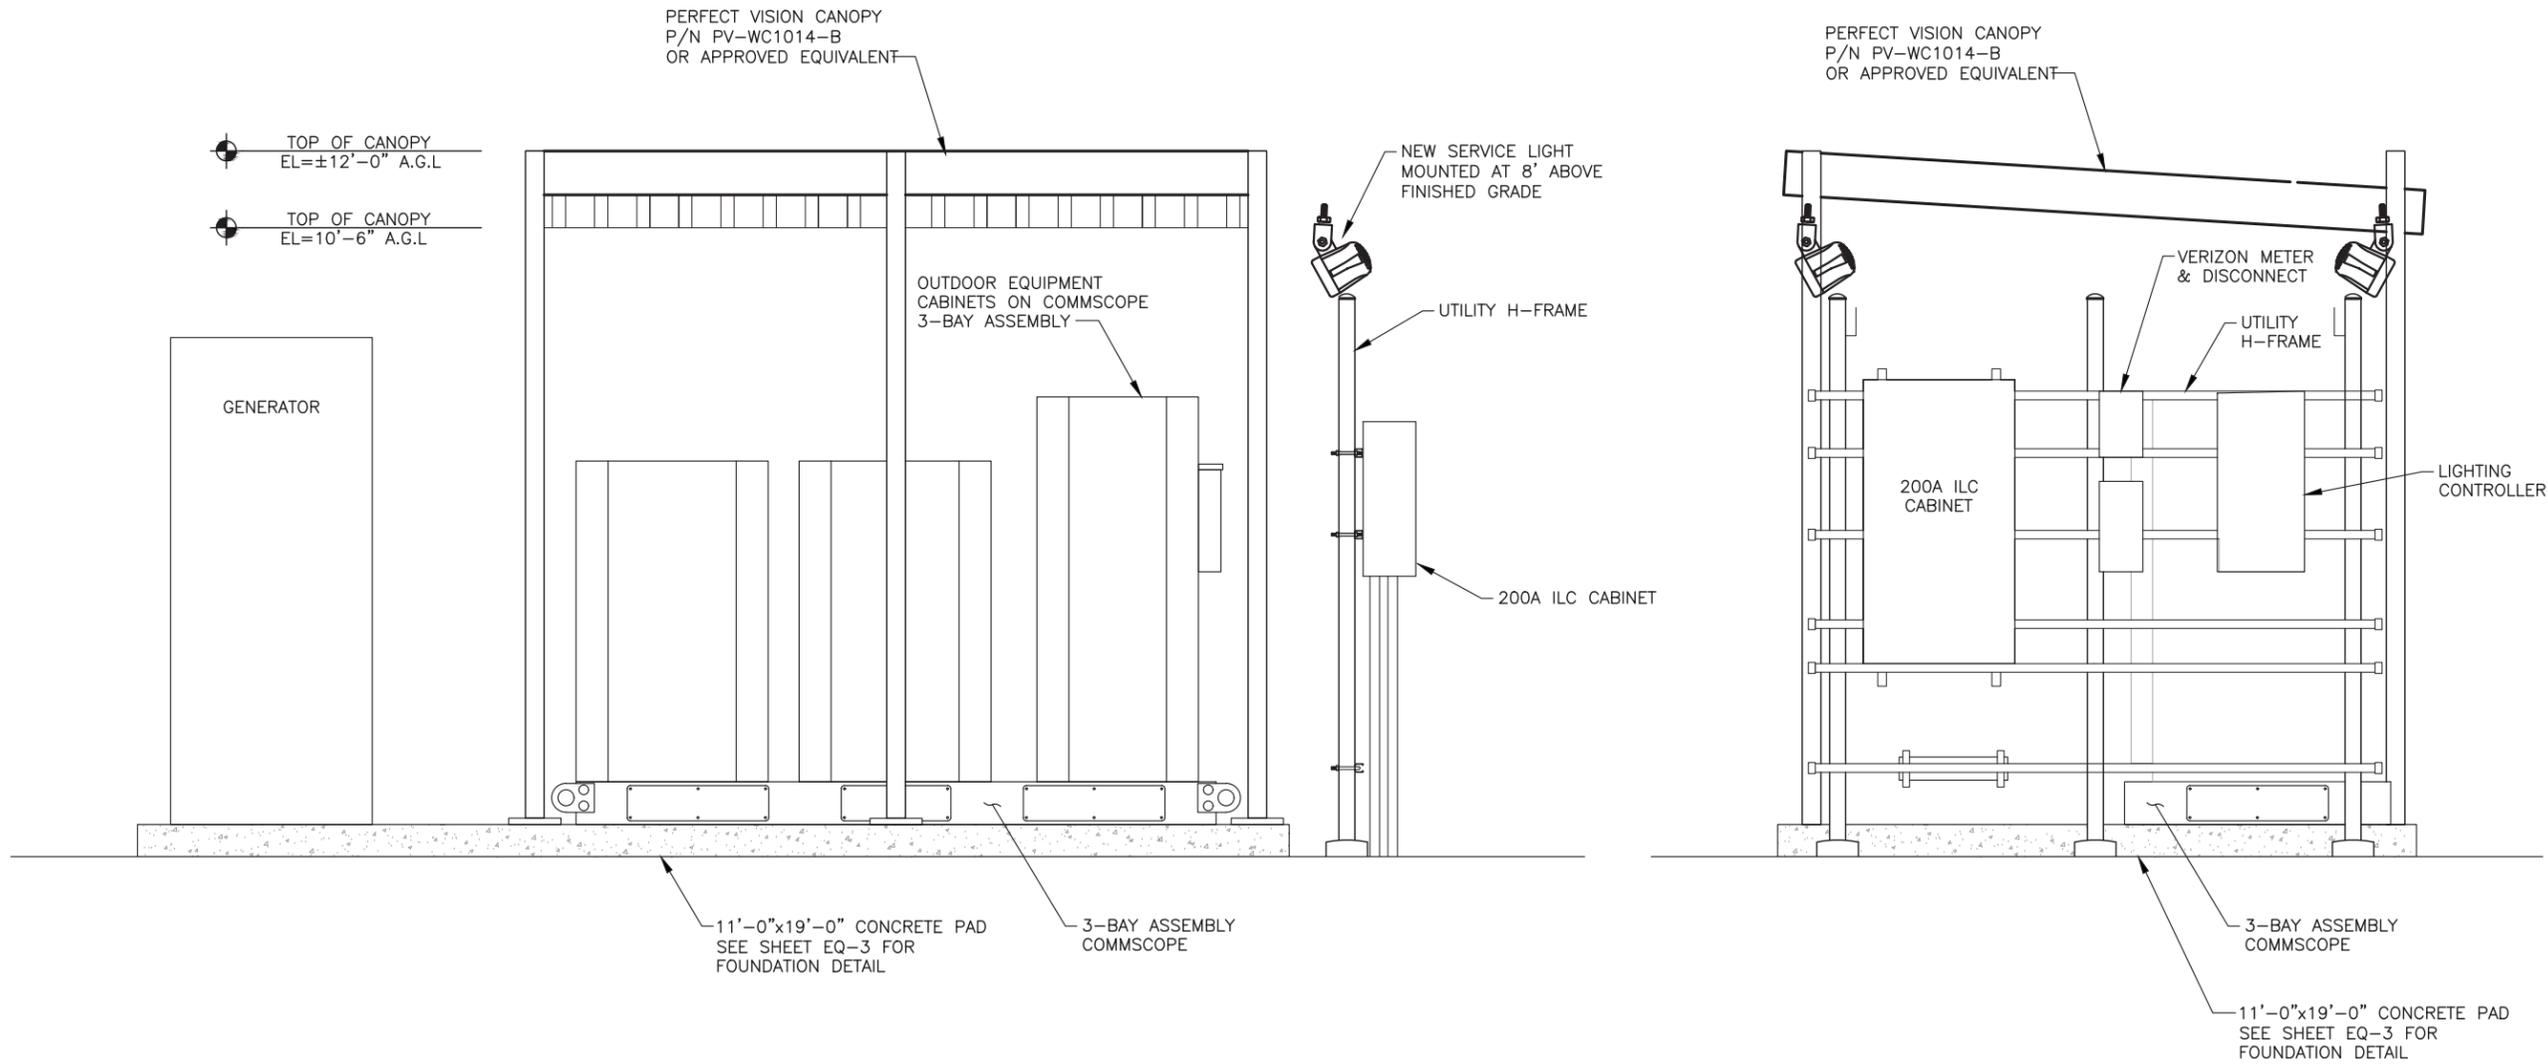
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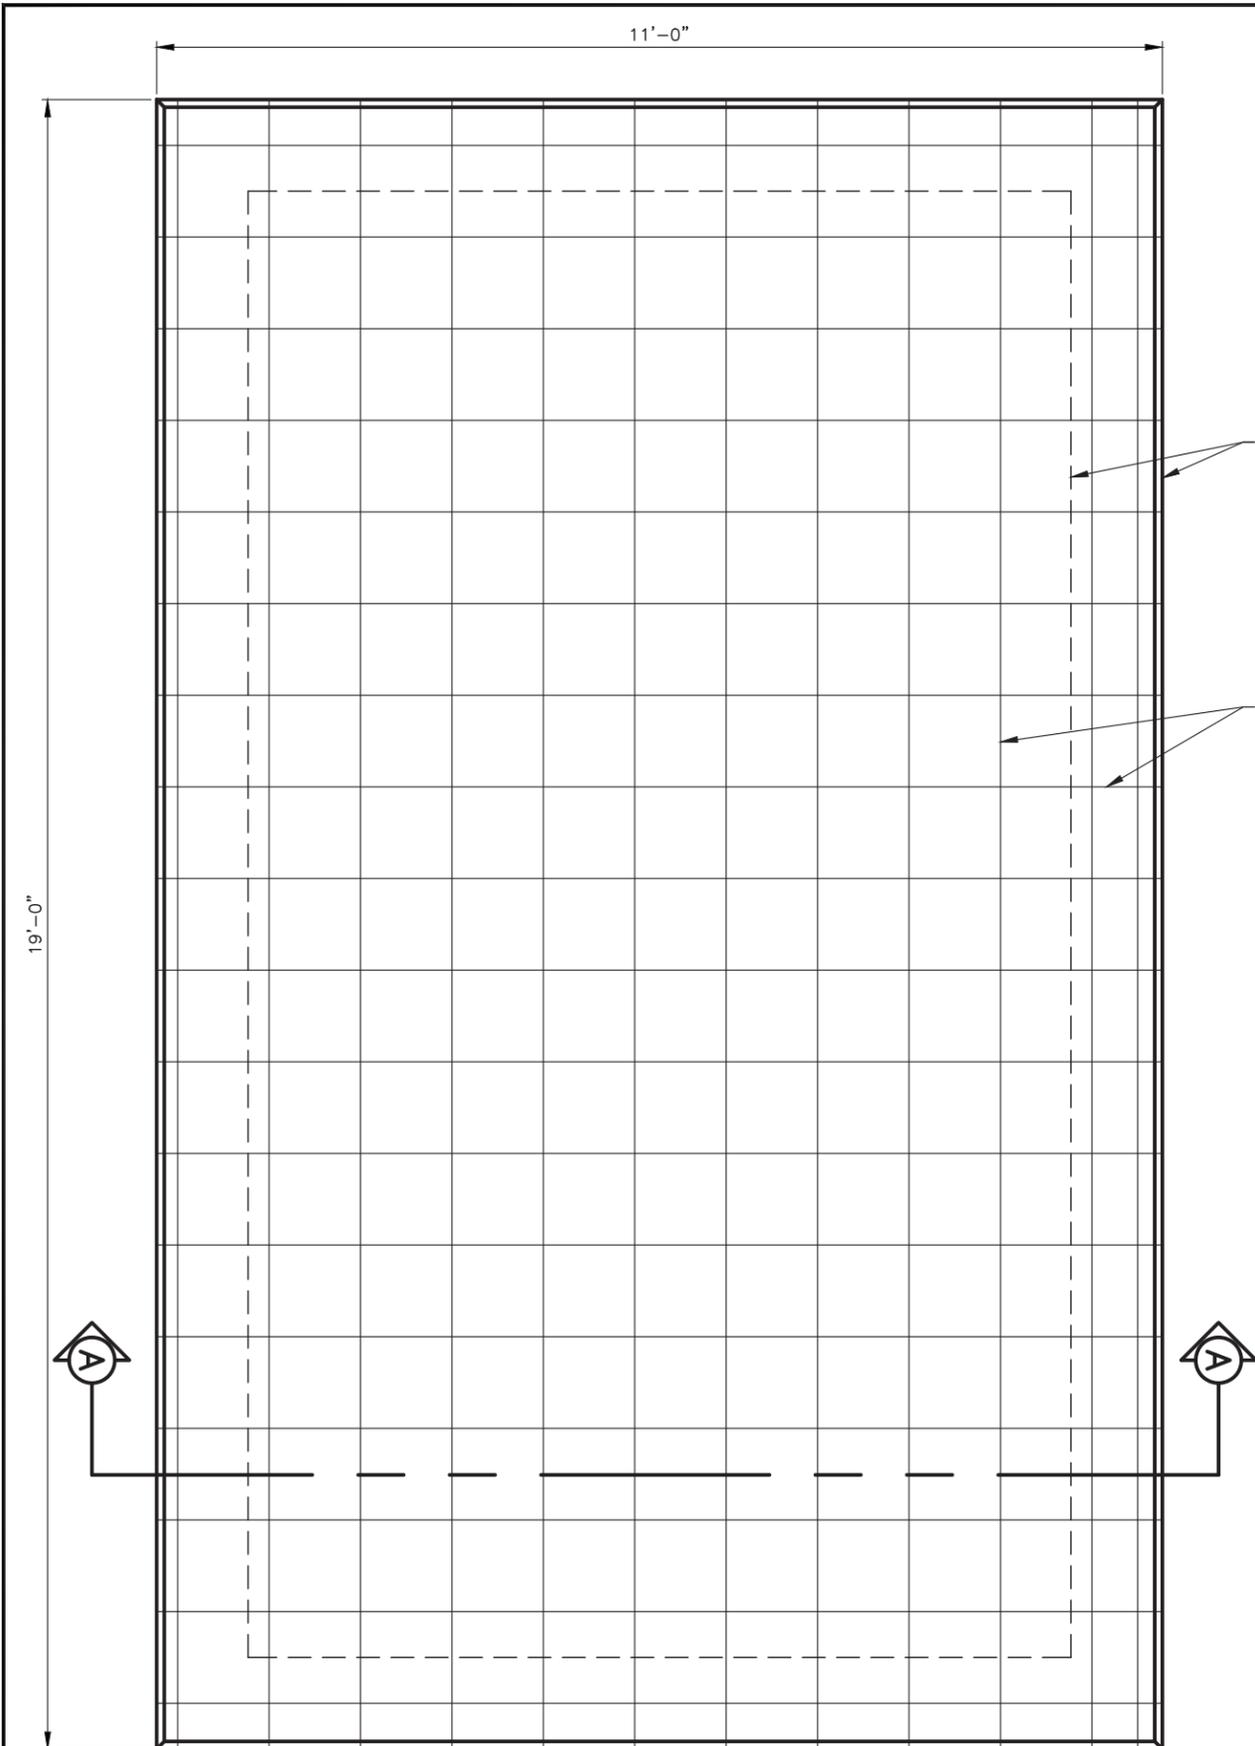
STLC INNSBROOK
LOCATION #: 2505770
FUZE PROJECT #:
2505770
1837 STATE HWY F
INNSBROOK,
MO 63390 WARREN
COUNTY

SHEET TITLE:
EQUIPMENT ELEVATIONS

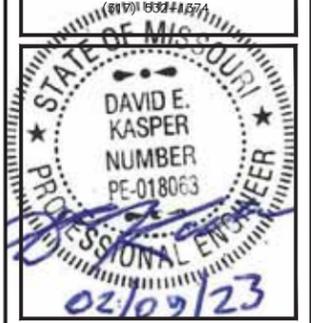SHEET NUMBER:
EQ-2

DO NOT SCALE DRAWINGS






1 FOUNDATION PLAN
SCALE: 1"=2'-0"

NOTES:

- ALL CONCRETE WORK SHALL CONFIRM TO THE REQUIREMENTS OF THE LATEST EDITIONS OF ACI 318 & ACI 301. THESE REFERENCES SHALL BE AVAILABLE IN THE FIELD OFFICE.
- REINFORCING STEEL SHALL BE GRADE 60 & CONFORM TO A615.
- UNLESS OTHERWISE NOTED, CONCRETE SHALL HAVE 28-DAY COMPRESSING STRENGTH GREATER OR EQUAL TO 4,000 PSI. ALL EXTERIOR CONCRETE SHALL BE AIR ENTRAINED WITH 6% AIR CONTENT.
- CONCRETE MIX SHALL BE SUBMITTED TO CONSTRUCTION MANAGER FOR REVIEW.
- CONTACT CITY BUILDING INSPECTOR AFTER EXCAVATION & PLACEMENT OF REBAR & PRIOR TO PLACEMENT OF CONCRETE (AS REQUIRED BY JURISDICTION).

CONTINUOUS FROST FOOTING

#4 BARS 12" O.C. EACH WAY TOP & BOTTOM

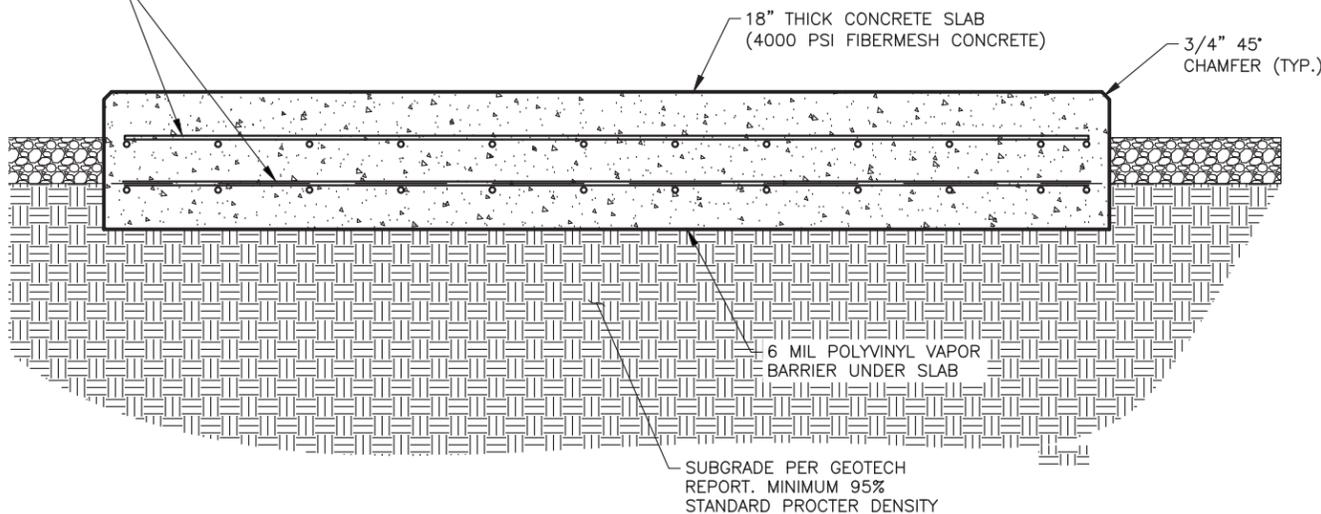


2 FOUNDATION SECTION A-A
SCALE: 1"=2'-0"



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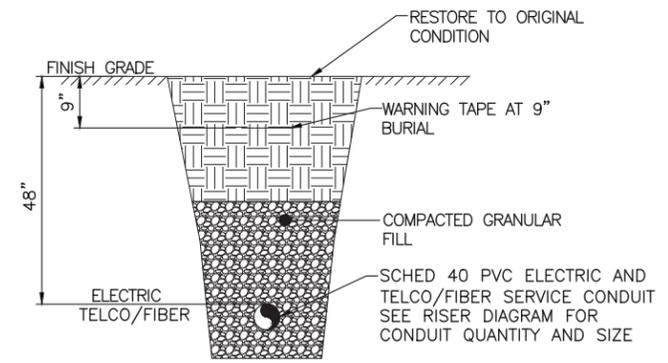
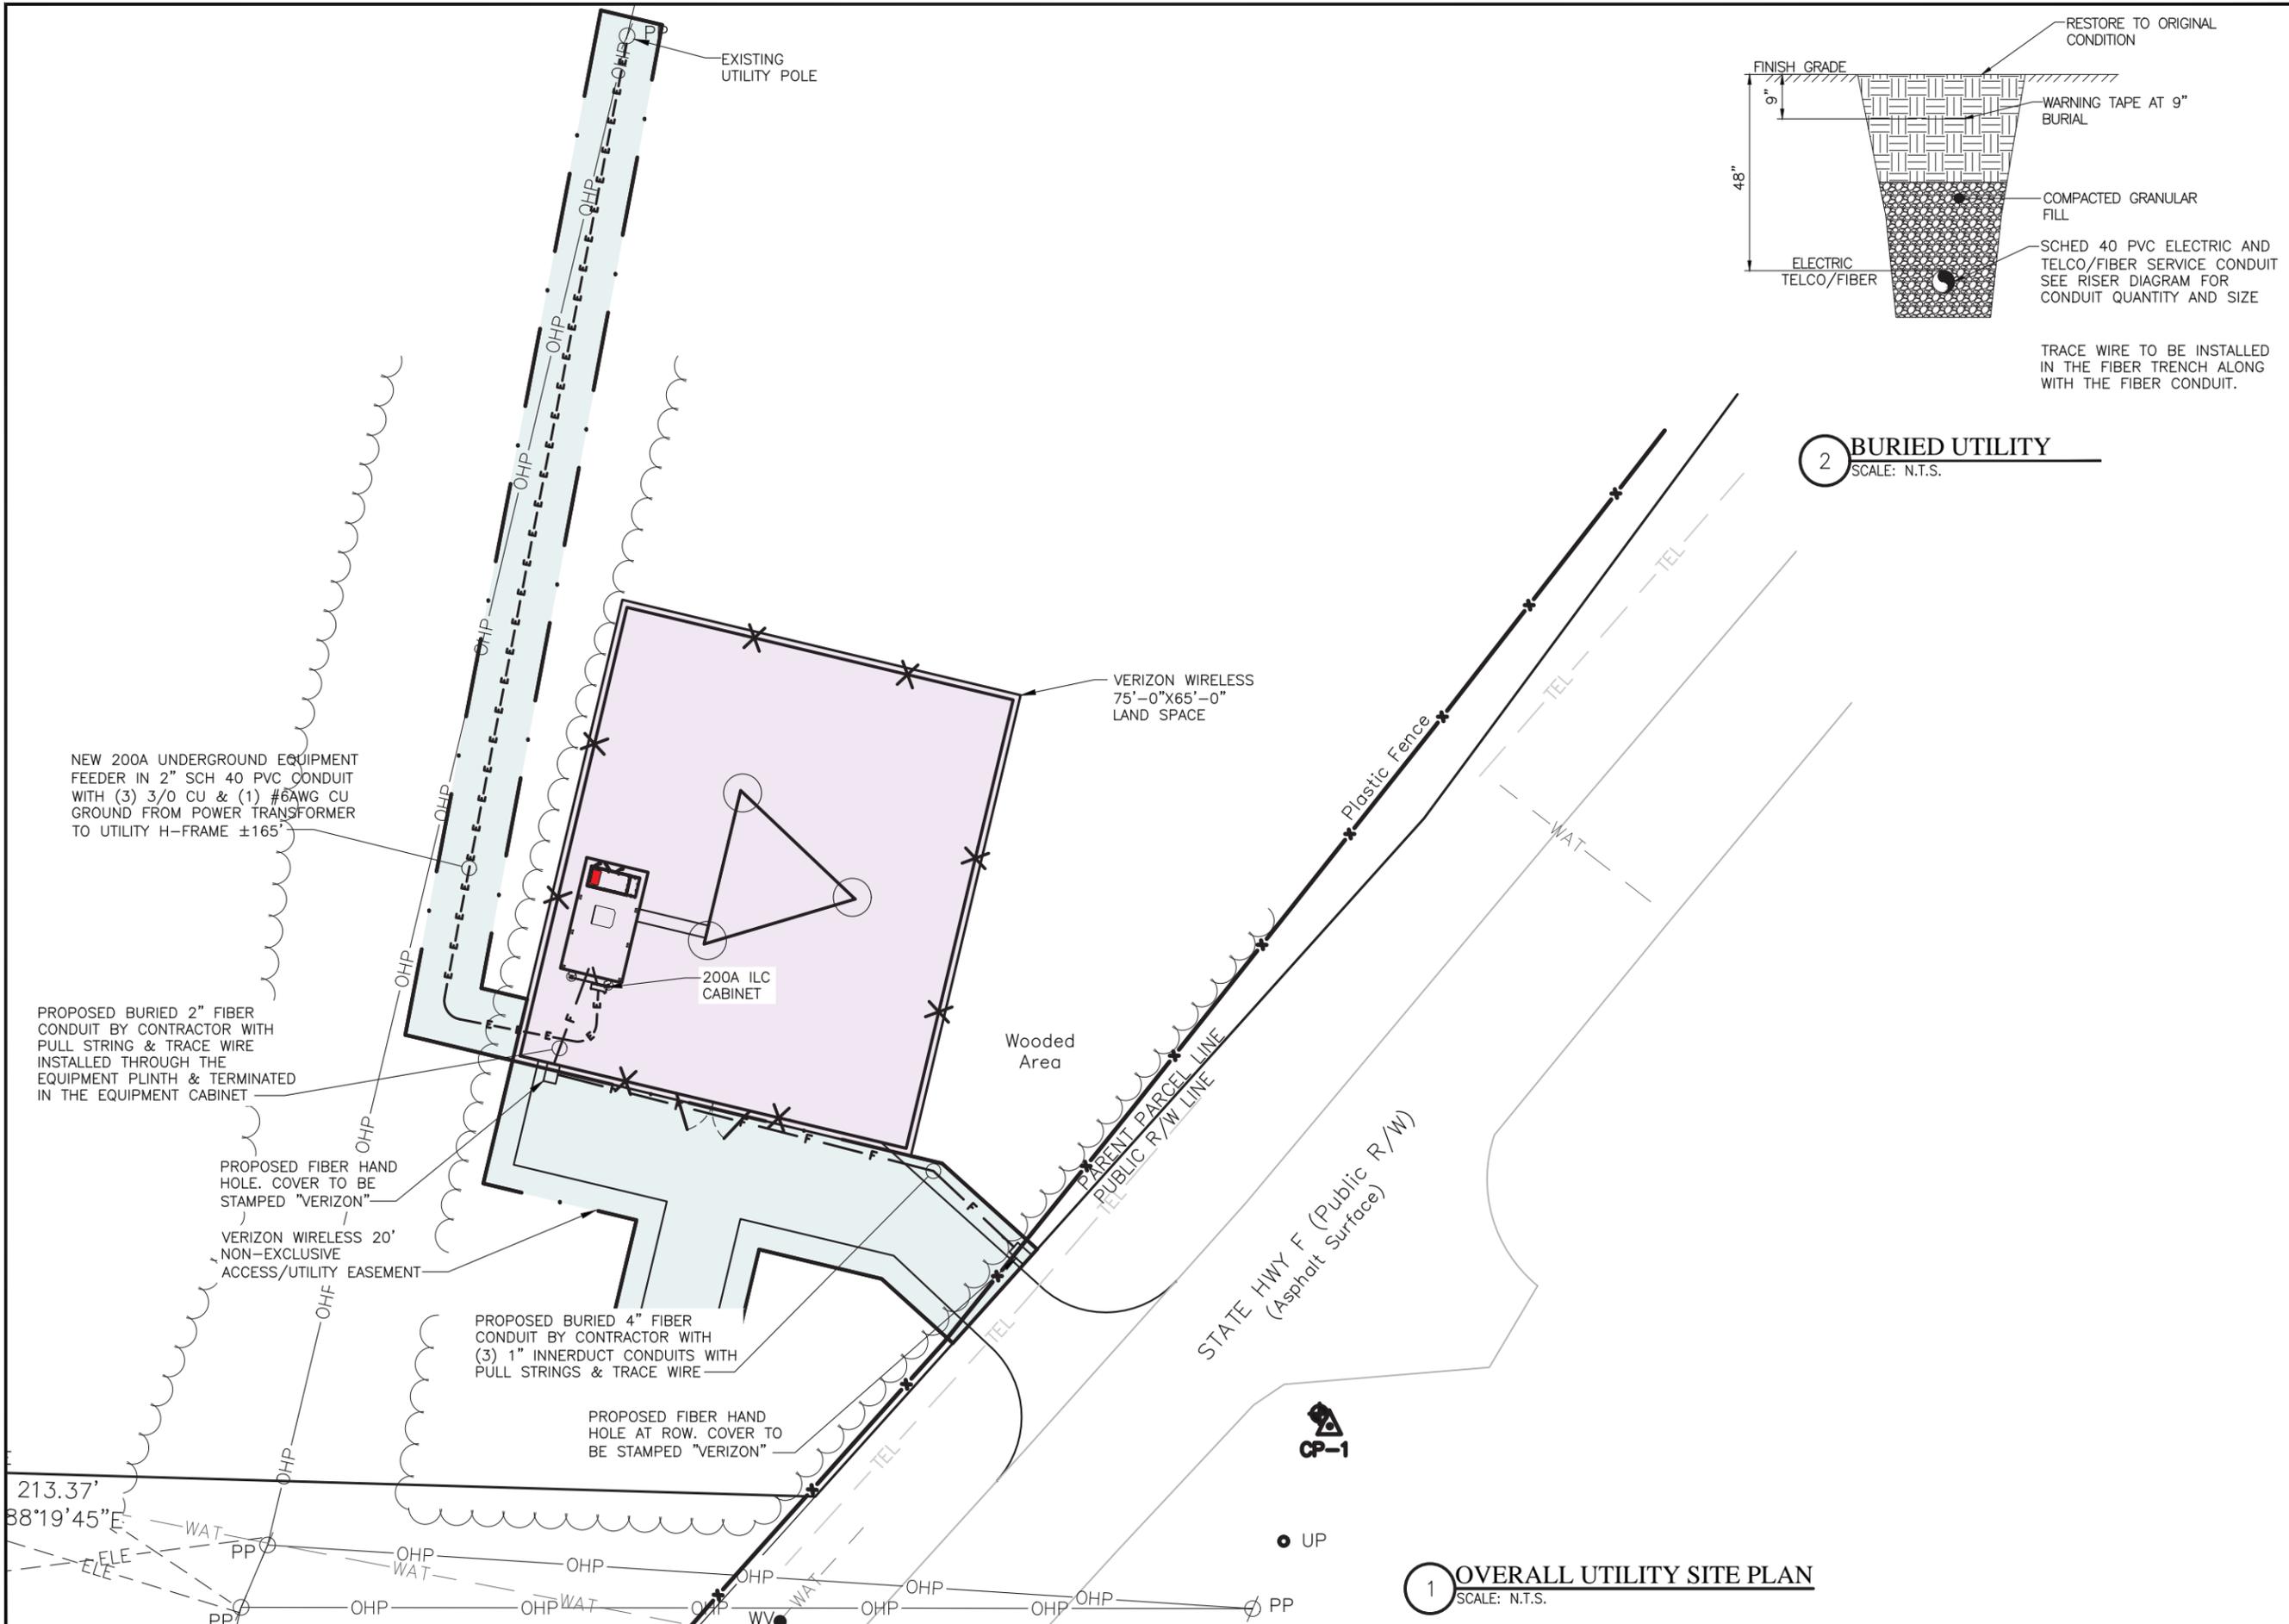
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STLC INNSBROOK
LOCATION #: 2505770
FUZE PROJECT #:
2505770
1837 STATE HWY F
INNSBROOK,
MO 63390 WARREN
COUNTY

SHEET TITLE:
EQUIPMENT FOUNDATION

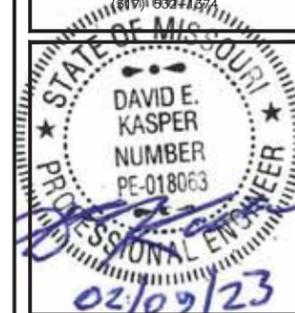SHEET NUMBER:
EQ-3



2 BURIED UTILITY
SCALE: N.T.S.

1 OVERALL UTILITY SITE PLAN
SCALE: N.T.S.



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(317) 832-1171



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STLC INNSBROOK
LOCATION #: 2505770
FUZE PROJECT #:
2505770
1837 STATE HWY F
INNSBROOK,
MO 63390 WARREN
COUNTY

SHEET TITLE:
UTILITY SITE PLAN


SHEET NUMBER:
E-0
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COMMON VzW DC PLANT RECTIFIER REQUIREMENTS			
RECTIFIER	INPUT FLA CURRENT AT 240 VAC (EACH RECTIFIER)	2 RECT / BRANCH CIRCUIT ALTERNATE APPROACH	1 RECT / BRANCH CIRCUIT ALTERNATE APPROACH
VERTIV 3500W (R48-2000e3 OR SIM)	15.5 AMPS	40A/2P (OR 45A/2P) # 8 THHN	30A/2P # 10 THHN
GE 75A (NE075AC48xxxx OR SIM)	22 AMPS (MAX.)	60A/2P # 6 THHN	30A/2P # 10 THHN
OTHER - COORD W/ VENDOR	REFER TO CUT SHEETS	REFER TO CUT SHEETS	REFER TO CUT SHEETS

LOAD CALCULATION	
LOAD	AMPS
PROPOSED LOAD:	140.0
TOTAL DEMAND:	140.0
VOLTAGE: 120/240V SINGLE PHASE 3W 200A	

NOTE:
 PANEL SCHEDULE AND SINGLE LINE DIAGRAM REPRESENT A SITE WITH A NEW GE POWER PLANT, 30 KW DIESEL GENERATOR, AND TWO SOURCE ILC (THREE SOURCE ILC OPTIONAL AS NEEDED). ADJUST AS NECESSARY PER LOCAL SITE CONDITIONS

PRIOR TO ELECTRICAL INSPECTION, IF REQUIRED, CONTRACTOR SHALL COORDINATE TRANSFER SWITCH MODIFICATION WITH LESSEE CONSTRUCTION ENGINEER AND SWITCH VENDOR.

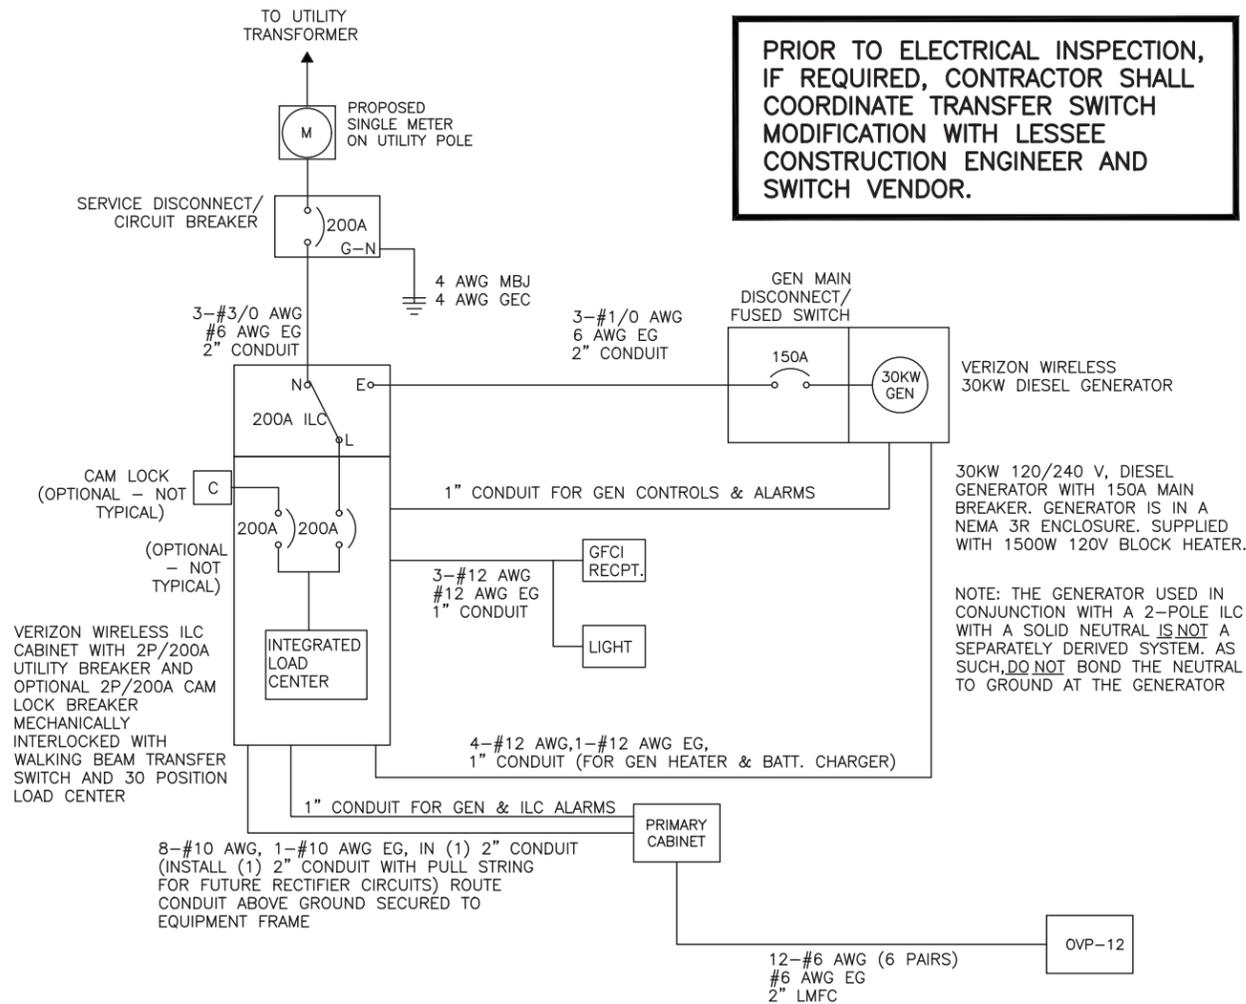


ELECTRICAL SINGLE LINE DIAGRAM

- NOTES:**
- ALL EQUIPMENT SHALL BE NEMA 3R RATED.
 - ALL EQUIPMENT SHALL BE LIGHTNING PROTECTED IN ACCORDANCE WITH TIA-222-G AND VERIZON WIRELESS STANDARDS.
 - CONDUCTOR SIZES AND DISTANCES HAVE BEEN SIZED FOR 3% MAX VOLTAGE DROP (TOTAL SYSTEM VOLTAGE DROP ON BOTH FEEDERS AND BRANCH CIRCUITS TO THE FARTHEST DEMAND SHALL NOT EXCEED 5%).
 - WIRE SIZING AND MAXIMUM DISTANCE FROM GENERATOR TO ILC ASSUMES POWER FACTOR OF 0.9.
 - BELOW GRADE CONDUIT SHALL BE SCHEDULE 80 PVC. ABOVE GRADE CONDUIT SHALL BE GALVANIZED RIGID CONDUIT. BELOW GRADE PVC CONDUIT SHALL TRANSITION TO GRC PRIOR TO RISING ABOVE GRADE. ALL BENDS SHALL HAVE A MINIMUM 24" RADIUS. ALL FITTINGS SHALL BE SUITABLE FOR USE WITH THREADED RIGID CONDUIT. VERIFY CONDUIT TYPE WITH LOCAL CONSTRUCTION MANAGER AND ADJUST IF NECESSARY. ALL CONDUIT SHALL MEET NEC, STATE, AND LOCAL CODE REQUIREMENTS AS REQUIRED.

PANEL NAME:		VZW ILC		MODEL NUMBER:		INTERSECT AA300G-1PH-3R									
RATED VOLTAGE:		240	120	VOLTS		PHASE/WIRE: 1 3									
MAIN BREAKER:		200 AMPS		BUS RATING:		200									
MOUNT:		SURFACE		NEUTRAL BAR:		YES									
ENCLOSURE TYPE:		NEMA 3R		AIC:		65K									
POS	USAGE FACTOR	BUS AMPS		LOAD	POLES	AMPS	L1	L2	AMPS	POLES	LOAD	BUS AMPS		USAGE FACTOR	POS
		L1	L2									L1	L2		
1	1	18		RECTIFIER	2	30A			30A	2	FUTURE RECTIFIER	18		1	2
3	1	18											18	1	4
5	1	18		RECTIFIER	2	30A			30A	2	FUTURE RECTIFIER	18		1	6
7	1	18											18	1	8
9	1	18		RECTIFIER	2	30A								1	10
11	1	18												1	12
13	1	18		RECTIFIER	2	30A									14
15	1	18													16
17	1.25	16		GFI RECEPT. /LIGHT	1	20A									18
19	1	16		BLOCK HEATER	1	20A									20
21	1	16		BATT. CHARGER	1	20A									22
23															24
25															26
27															28
29															30
		104	88	:SUB TOTAL AMPS								SUB TOTAL AMPS: 36 36			
												FACTORED TOTAL AMPS: 140 124			

- NOTES:**
- ALL CONDUCTORS ARE TYPE THWN (75°C) COPPER.
 - MAXIMUM LENGTH OF RUN FOR RECTIFIER CIRCUITS IS 50FT.
 - INTERSECT/ GENERAC INTEGRATED LOAD CENTER INCLUDES 200 AMP MAIN DISCONNECT AND TRANSFER SWITCH FOR PORTABLE OR PERMANENT GENERATOR.
 - RECTIFIER LOADS ARE CONSIDERED TO BE NON-CONTINUOUS.
 - IF ADDITIONAL FUTURE LOADS ARE ADDED WHICH CAUSE TOTAL DEMAND TO EXCEED GENERATOR BREAKER SIZE, BACKUP POWER SYSTEM SHALL BE EVALUATED AND UPGRADED AS NECESSARY.

PANEL SCHEDULE

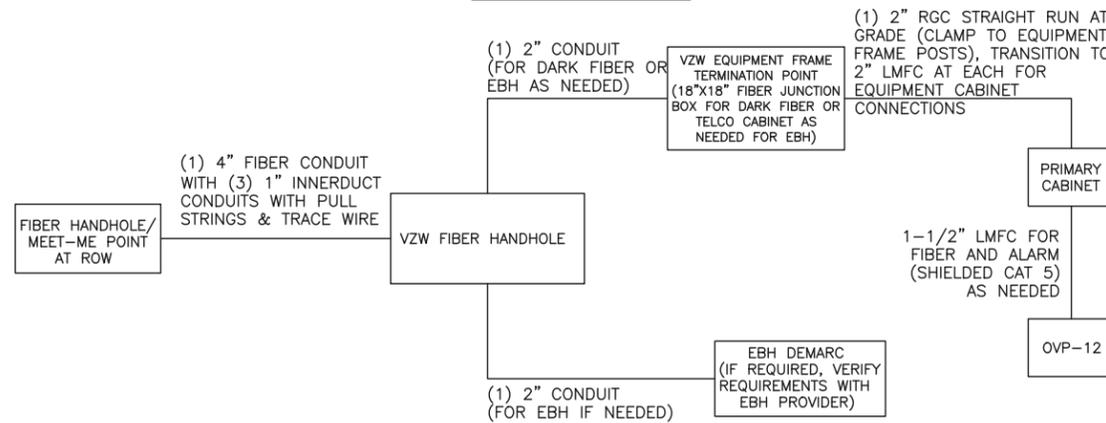

FIBER SINGLE LINE DIAGRAM


- NOTES:**
- * ADD (1) ADDITIONAL 2" CONDUIT FOR DARK FIBER (2 TOTAL) IF REQUIRED BY LOCAL MARKET FACILITIES, VERIFY PRIOR TO CONSTRUCTION. (ADD 2 PULL STRINGS TO EACH CONDUIT)
 - ** VERIFY EBH REQUIREMENTS WITH TELCO PROVIDER PRIOR TO CONSTRUCTION. (ADD 2 PULL STRINGS TO EACH CONDUIT)

ELECTRICAL DETAILS



FORTUNE WIRELESS INC.

5511 WEST 79TH STREET
 INDIANAPOLIS, IN 46278

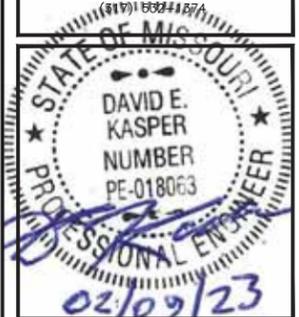

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STLC INNSBROOK
 LOCATION #: 2505770
 FUZE PROJECT #:
 2505770
 1837 STATE HWY F
 INNSBROOK,
 MO 63390 WARREN
 COUNTY

SHEET TITLE:
CARRIER DETAILS


SHEET NUMBER:
E-1

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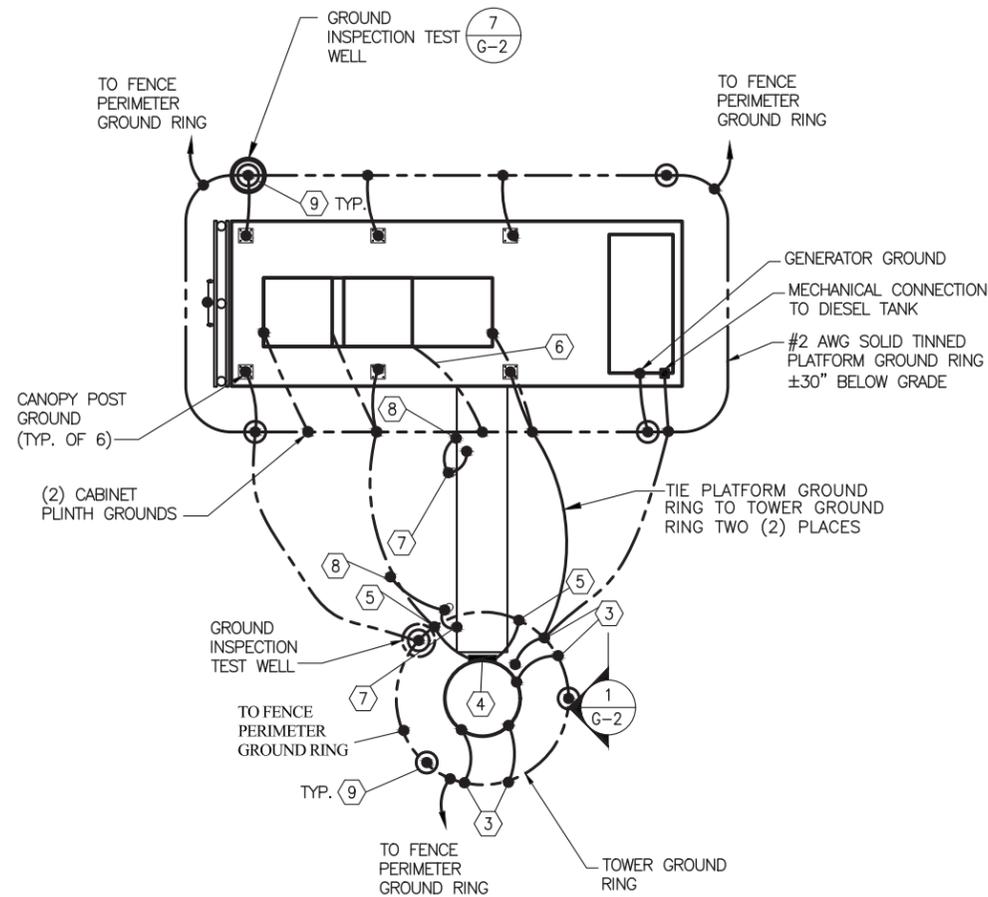
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LOCATION #: 2505770
FUZE PROJECT #:
2505770
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INNSBROOK,
MO 63390 WARREN
COUNTY


SHEET TITLE:
GROUNDING PLAN & NOTES

SHEET NUMBER:
G-1

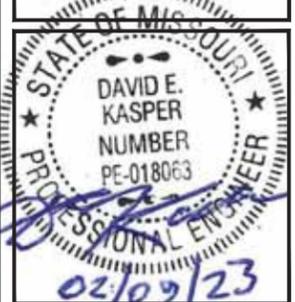


1 GROUNDING SCHEMATIC
SCALE: N.T.S.

NOTE:
FENCE POSTS WITHIN
6' OF A GROUNDED
STRUCTURE/CABINET
TO BE GROUNDED TO
THE GROUND RING.

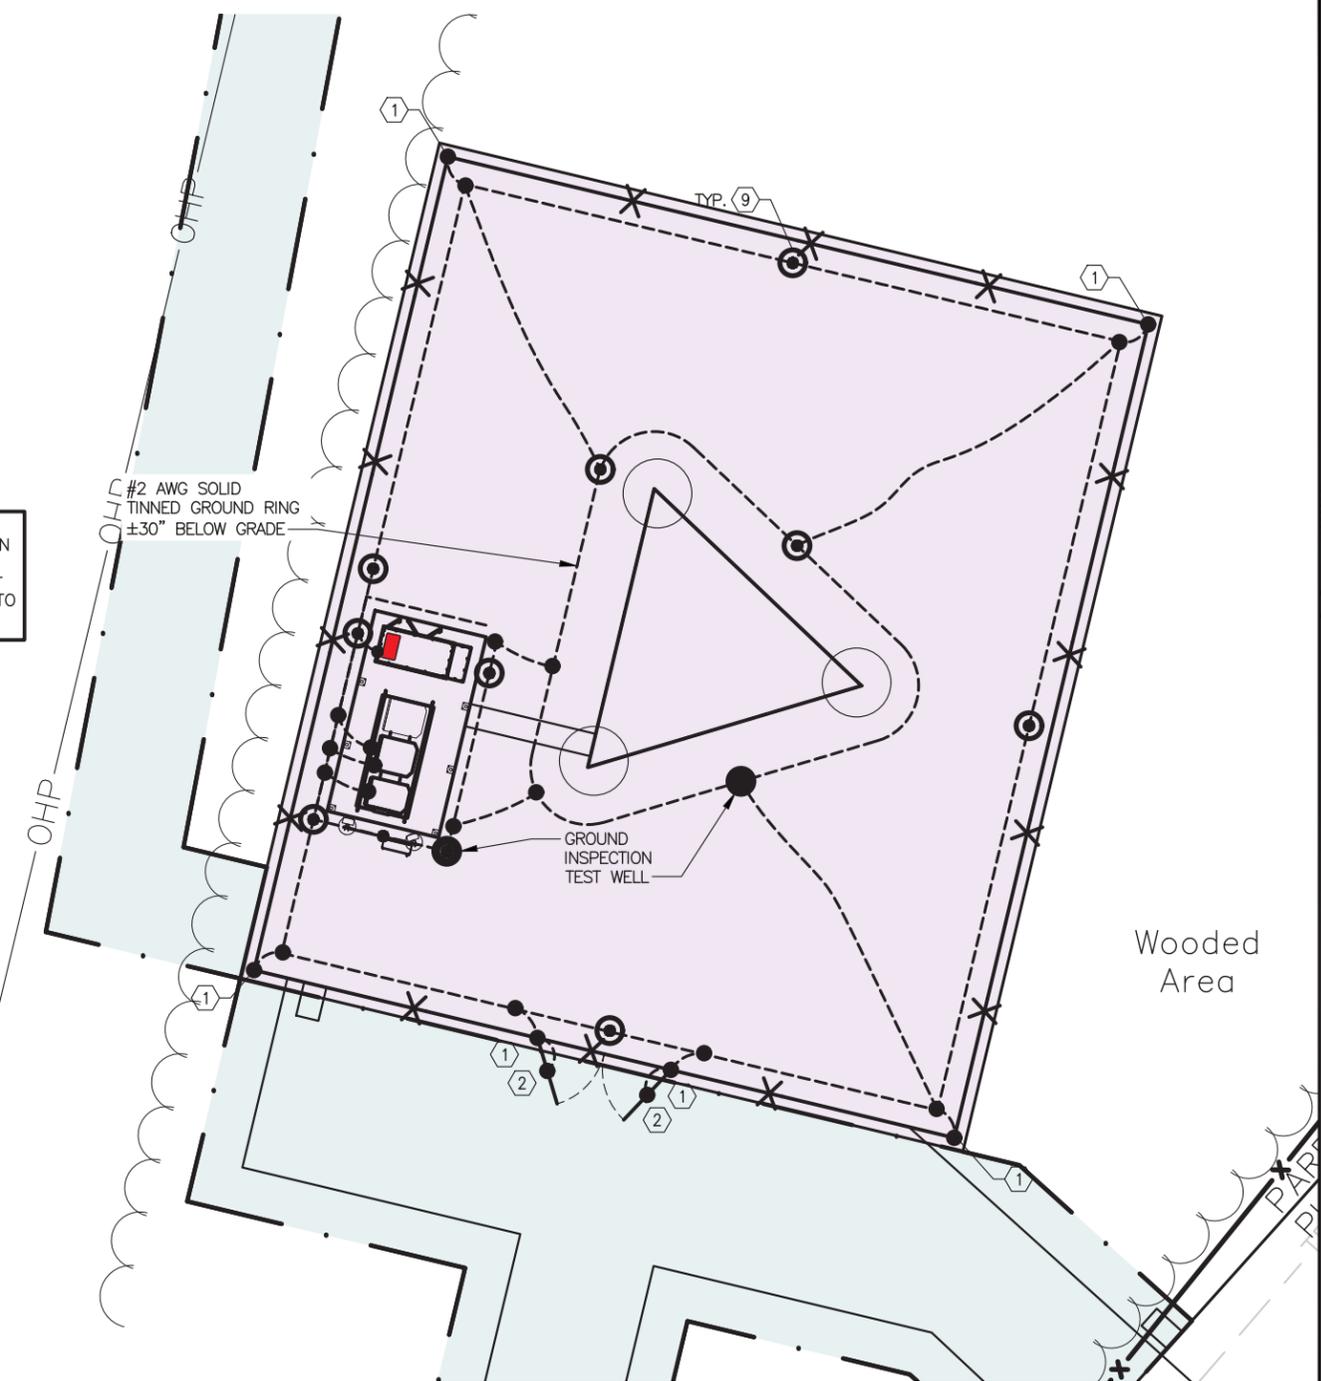

2 GROUNDING SITE PLAN
SCALE: N.T.S.

- ① FENCE GROUND: E.C. TO FURNISH AND INSTALL #2 AWG BARE SOLID TINNED COPPER GROUND WIRE AT FENCE POST. GROUND WIRE TO BE ROUTED ALONG FENCE POST AND CADWELDED FOUR (4) PLACES, TOP RAIL, TOP AND BOTTOM OF CORNER POST, AND GROUND RING.
- ② GATE GROUND: SIMILAR TO FENCE GROUND (FG), E.C. SHALL ALSO FURNISH AND INSTALL #2 BRAIDED GATE JUMPER WIRE BETWEEN THE GATE FRAME AND THE GATE POST. CONNECTIONS AT GATE FRAME AND GATE POST TO BE CADWELDED.
- ③ TOWER GROUND: E.C. TO FURNISH AND INSTALL TWO (2) #2 AWG BARE SOLID TINNED COPPER GROUND WIRES FROM BASE OF TOWER OR TOWER LEGS TO TOWER GROUND RING. ALL CONNECTIONS TO BE CADWELDED.
- ④ TOWER GROUND BAR: E.C. TO FURNISH AND INSTALL TWO (2) 20"x4"x1/4" TINNED COPPER GROUND BARS ON THE TOWER. ONE TO BE LOCATED AT ANTENNA MOUNT ELEVATION (ATTACHED TO TOWER STEEL), THE OTHER AT THE BASE OF THE TOWER ADJACENT TO THE ICE BRIDGE (ISOLATED FROM TOWER STEEL).
- ⑤ TOWER COAX GROUND: E.C. TO FURNISH AND INSTALL TWO (2) #2 AWG BARE SOLID TINNED COPPER GROUND WIRES FROM TOWER GROUND BAR (TGB) TO GROUND RING. ALL CONNECTIONS TO BE CADWELDED.
- ⑥ CABINET GROUND: E.C. TO FURNISH & INSTALL (2) #2 AWG BARE SOLID TINNED COPPER GROUND WIRES FROM EACH CABINET TO GROUND RING. ALL CONNECTIONS TO BE CADWELDED.
- ⑦ ICE BRIDGE CHANNEL GROUND: E.C. TO FURNISH AND INSTALL ONE (1) #2 AWG BARE SOLID TINNED COPPER GROUND JUMPER WIRE FROM ICE BRIDGE CHANNEL TO ICE BRIDGE SUPPORT POST. ALL CONNECTIONS TO BE CADWELDED.
- ⑧ ICE BRIDGE SUPPORT GROUND: E.C. TO FURNISH AND INSTALL ONE (1) #2 AWG BARE SOLID TINNED COPPER GROUND WIRE FROM ICE BRIDGE SUPPORT POST TO GROUND RING. ALL CONNECTIONS TO BE CADWELDED.
- ⑨ 5/8" DIA. x 10' LONG TINNED COPPER CLAD STEEL GROUND ROD DRIVEN VERTICAL TOP OF ROD 30" MIN. BELOW GRADE. SPACING OF GROUND RODS 10' MAX. ALL CONNECTIONS TO BE CADWELDED.

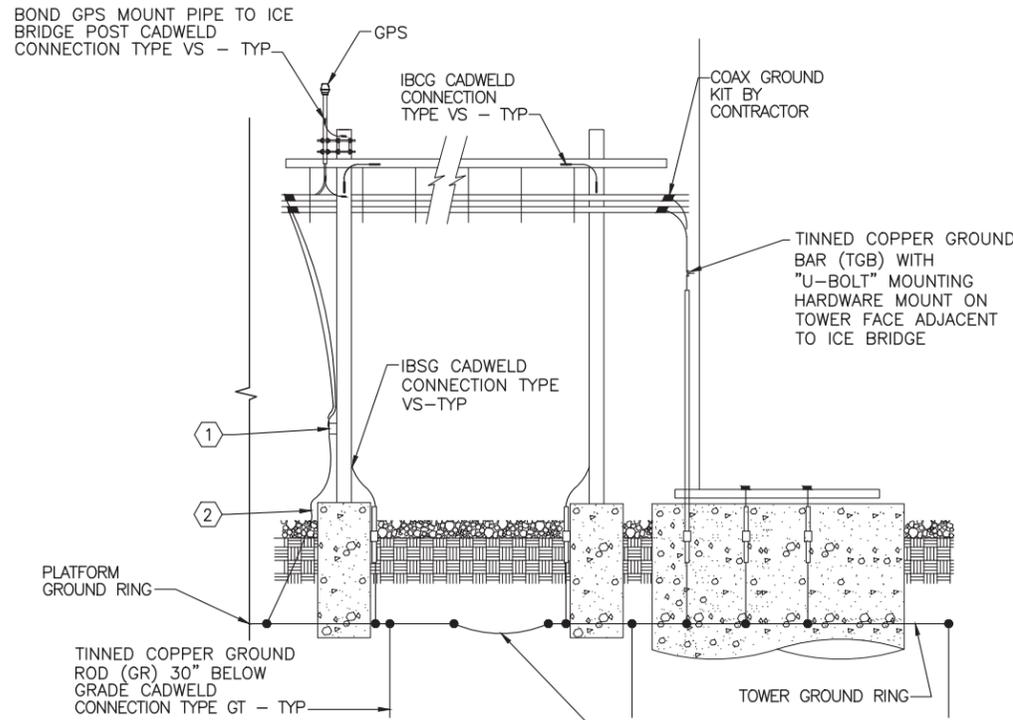


PLAN NOTES:


- ① MASTER GROUND BAR GROUND: E.C. TO EXTEND TWO (2) #2 AWG BARE SOLID TINNED COPPER GROUND WIRES FROM THE MASTER GROUND BAR (MGB) TO GROUND RING. ALL CONNECTIONS TO BE CADWELD.
- ② COAX ENTRY GROUND: E.C. TO FURNISH AND INSTALL TWO (2) #2 AWG BARE SOLID TINNED COPPER GROUND JUMPER WIRE FROM COAX MASTER GROUND BAR (MGB). ALL CONNECTIONS TO BE CADWELD.

TIE PLATFORM GROUND RING TO TOWER GROUND RING TWO (2) PLACES CADWELD CONNECTION TYPE TA - TYP


1 ICE BRIDGE/TOWER GROUNDING SCHEMATIC
SCALE: N.T.S.

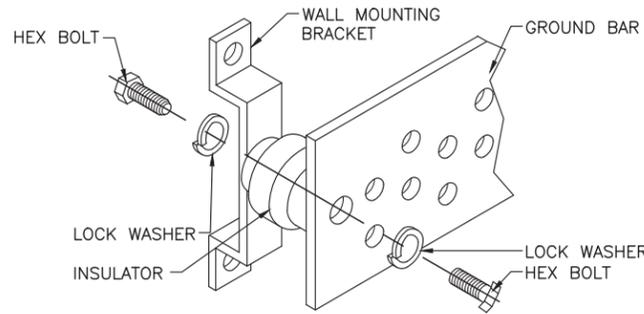

2 GROUND BAR INSTALLATION
SCALE: N.T.S.

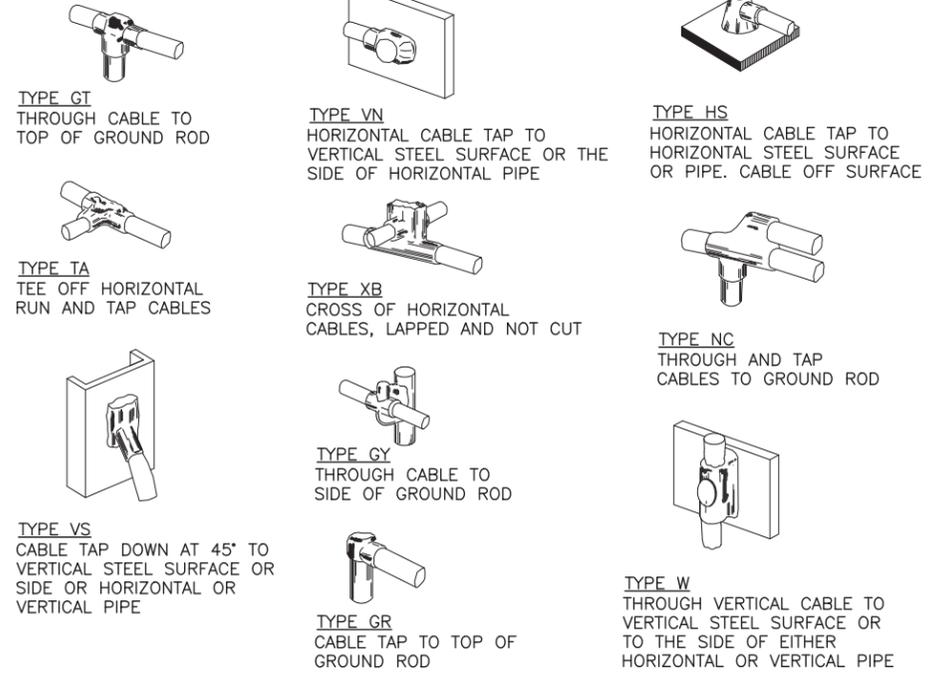


3 EXOTHERMIC WELD DETAILS
SCALE: N.T.S.

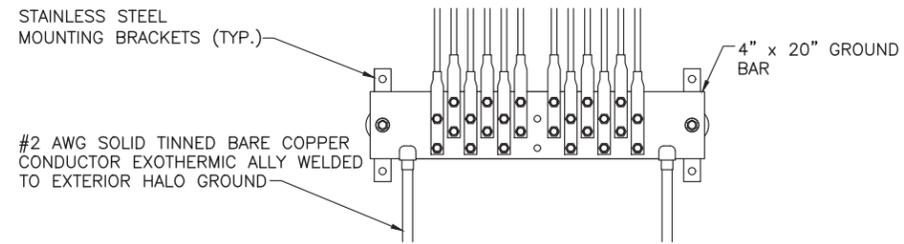


4 TOWER GROUND BAR (TGB)
SCALE: N.T.S.


HARGER P/N GJX2S16 JUMPER WITH EXOTHERMIC CONNECTION (HARGER ULTRAWELD No. VT2S1.54B CONNECTION AT FENCE POST AND HD2S1.54B AT TOP RAIL AND No. UWM115 WELD METAL OR APPROVED EQUAL)

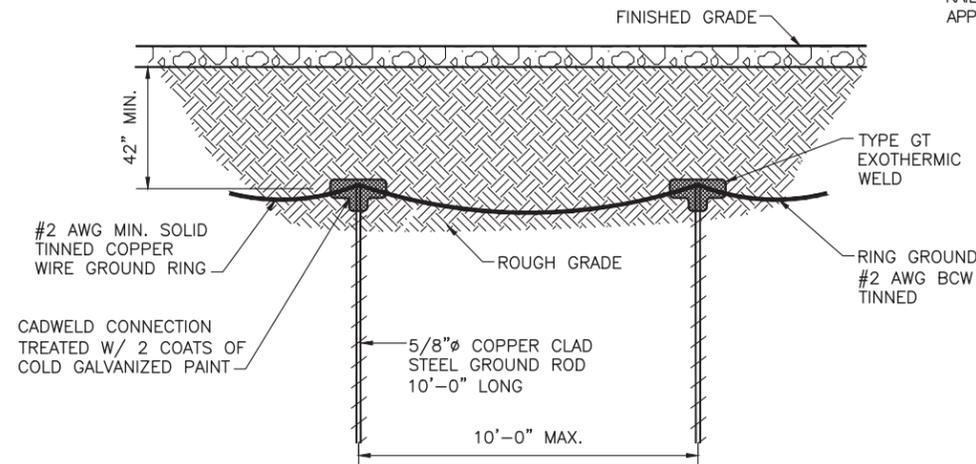

5 GROUND ROD DETAIL
SCALE: N.T.S.

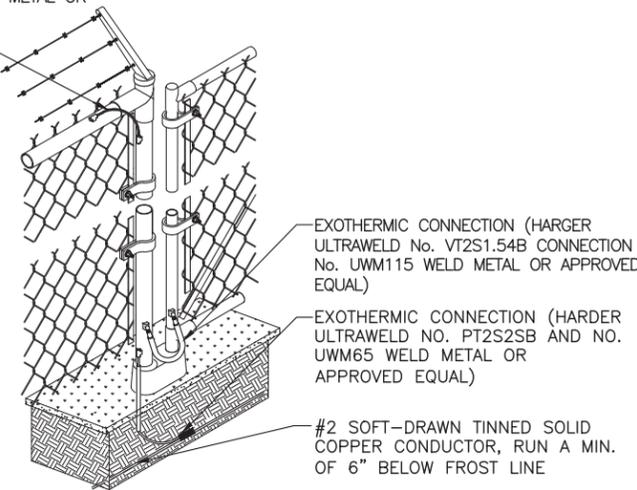

6 FENCE GROUNDING DETAIL
SCALE: N.T.S.

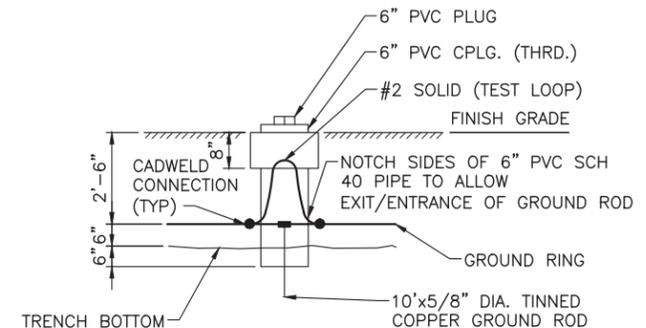

7 GROUND TEST WELL DETAIL
SCALE: N.T.S.



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SHEET TITLE:
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SHEET NUMBER:
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