

NIX ROAD RENOVATIONS 2018

FOR PHIL CAMPBELL HOUSING AUTHORITY PHIL CAMBELL, ALABAMA

JOANNE HOLIFIELD EXECUTIVE DIRECTOR

PROJECT TEAM INDEX

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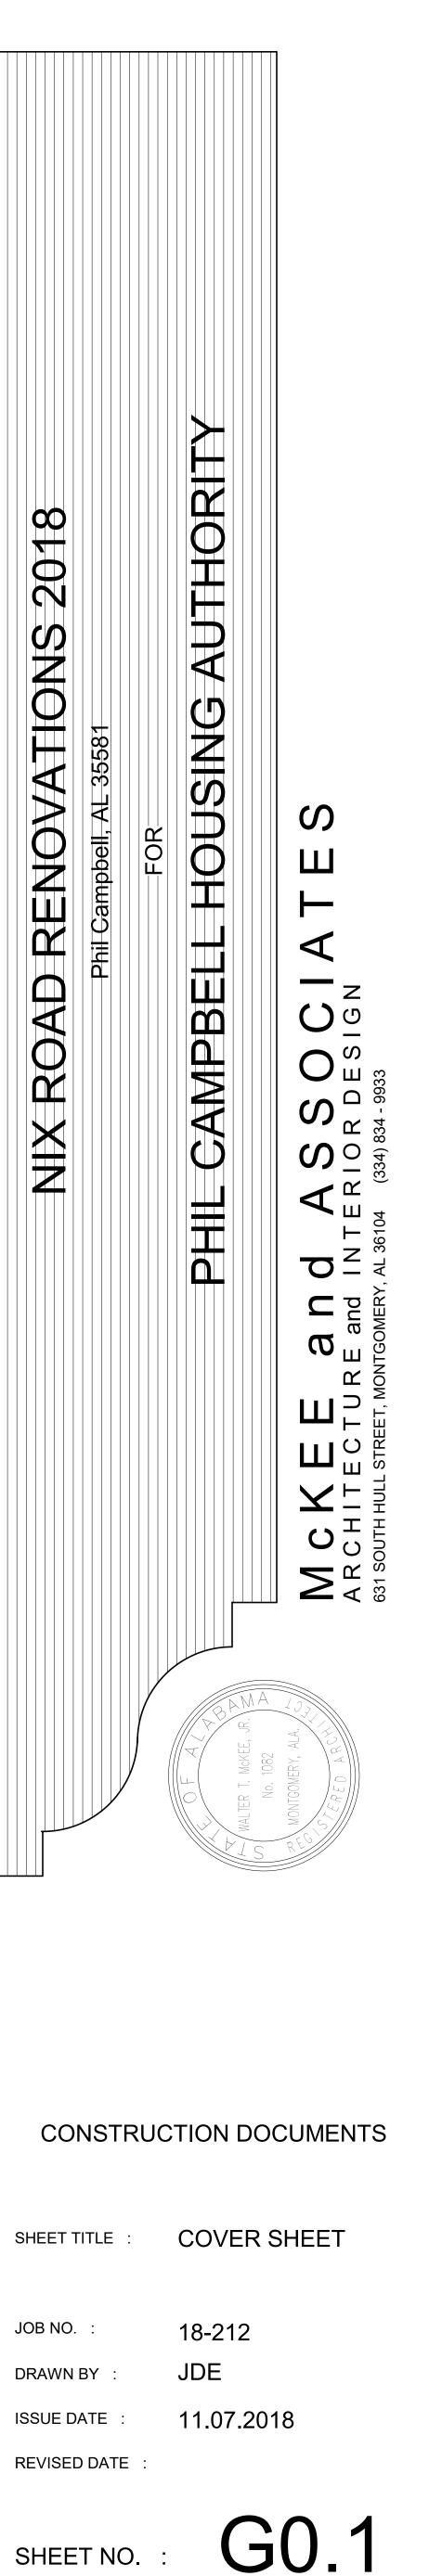



NIX ROAD, PHIL CAMBELL, AL 35581

MORELL ENGINEERING **CIVIL ENGINEERING** ATHENS, AL (256) 206-8146

LOCATION MAP

SHEET INDEX				
Sheet Number	Sheet Name	Sheet Issue Date	Current Revision Date	Current Revision Issued
G0.1	COVER SHEET	11.07.2018		No
C1.0 C2.0	CIVIL DEMO PLAN CIVIL SITE & GRADING PLAN	11.07.2018		No
				No
A1.0	ARCHITECTURAL SITE PLAN	11.07.2018		No
A1.1	FLOOR PLAN BUILDING TYPE 2X2Y (ADA)	11.07.2018		No
A2.0	EXTERIOR CONCRETE IMPROVEMENTS	11.07.2018		No
P1	PLUMBING FLOOR PLAN, SCHEDULE & NOTES	11.07.2018		No
E-1	ELECTRICAL FLOOR PLAN & LIGHTING	11.07.2018		No




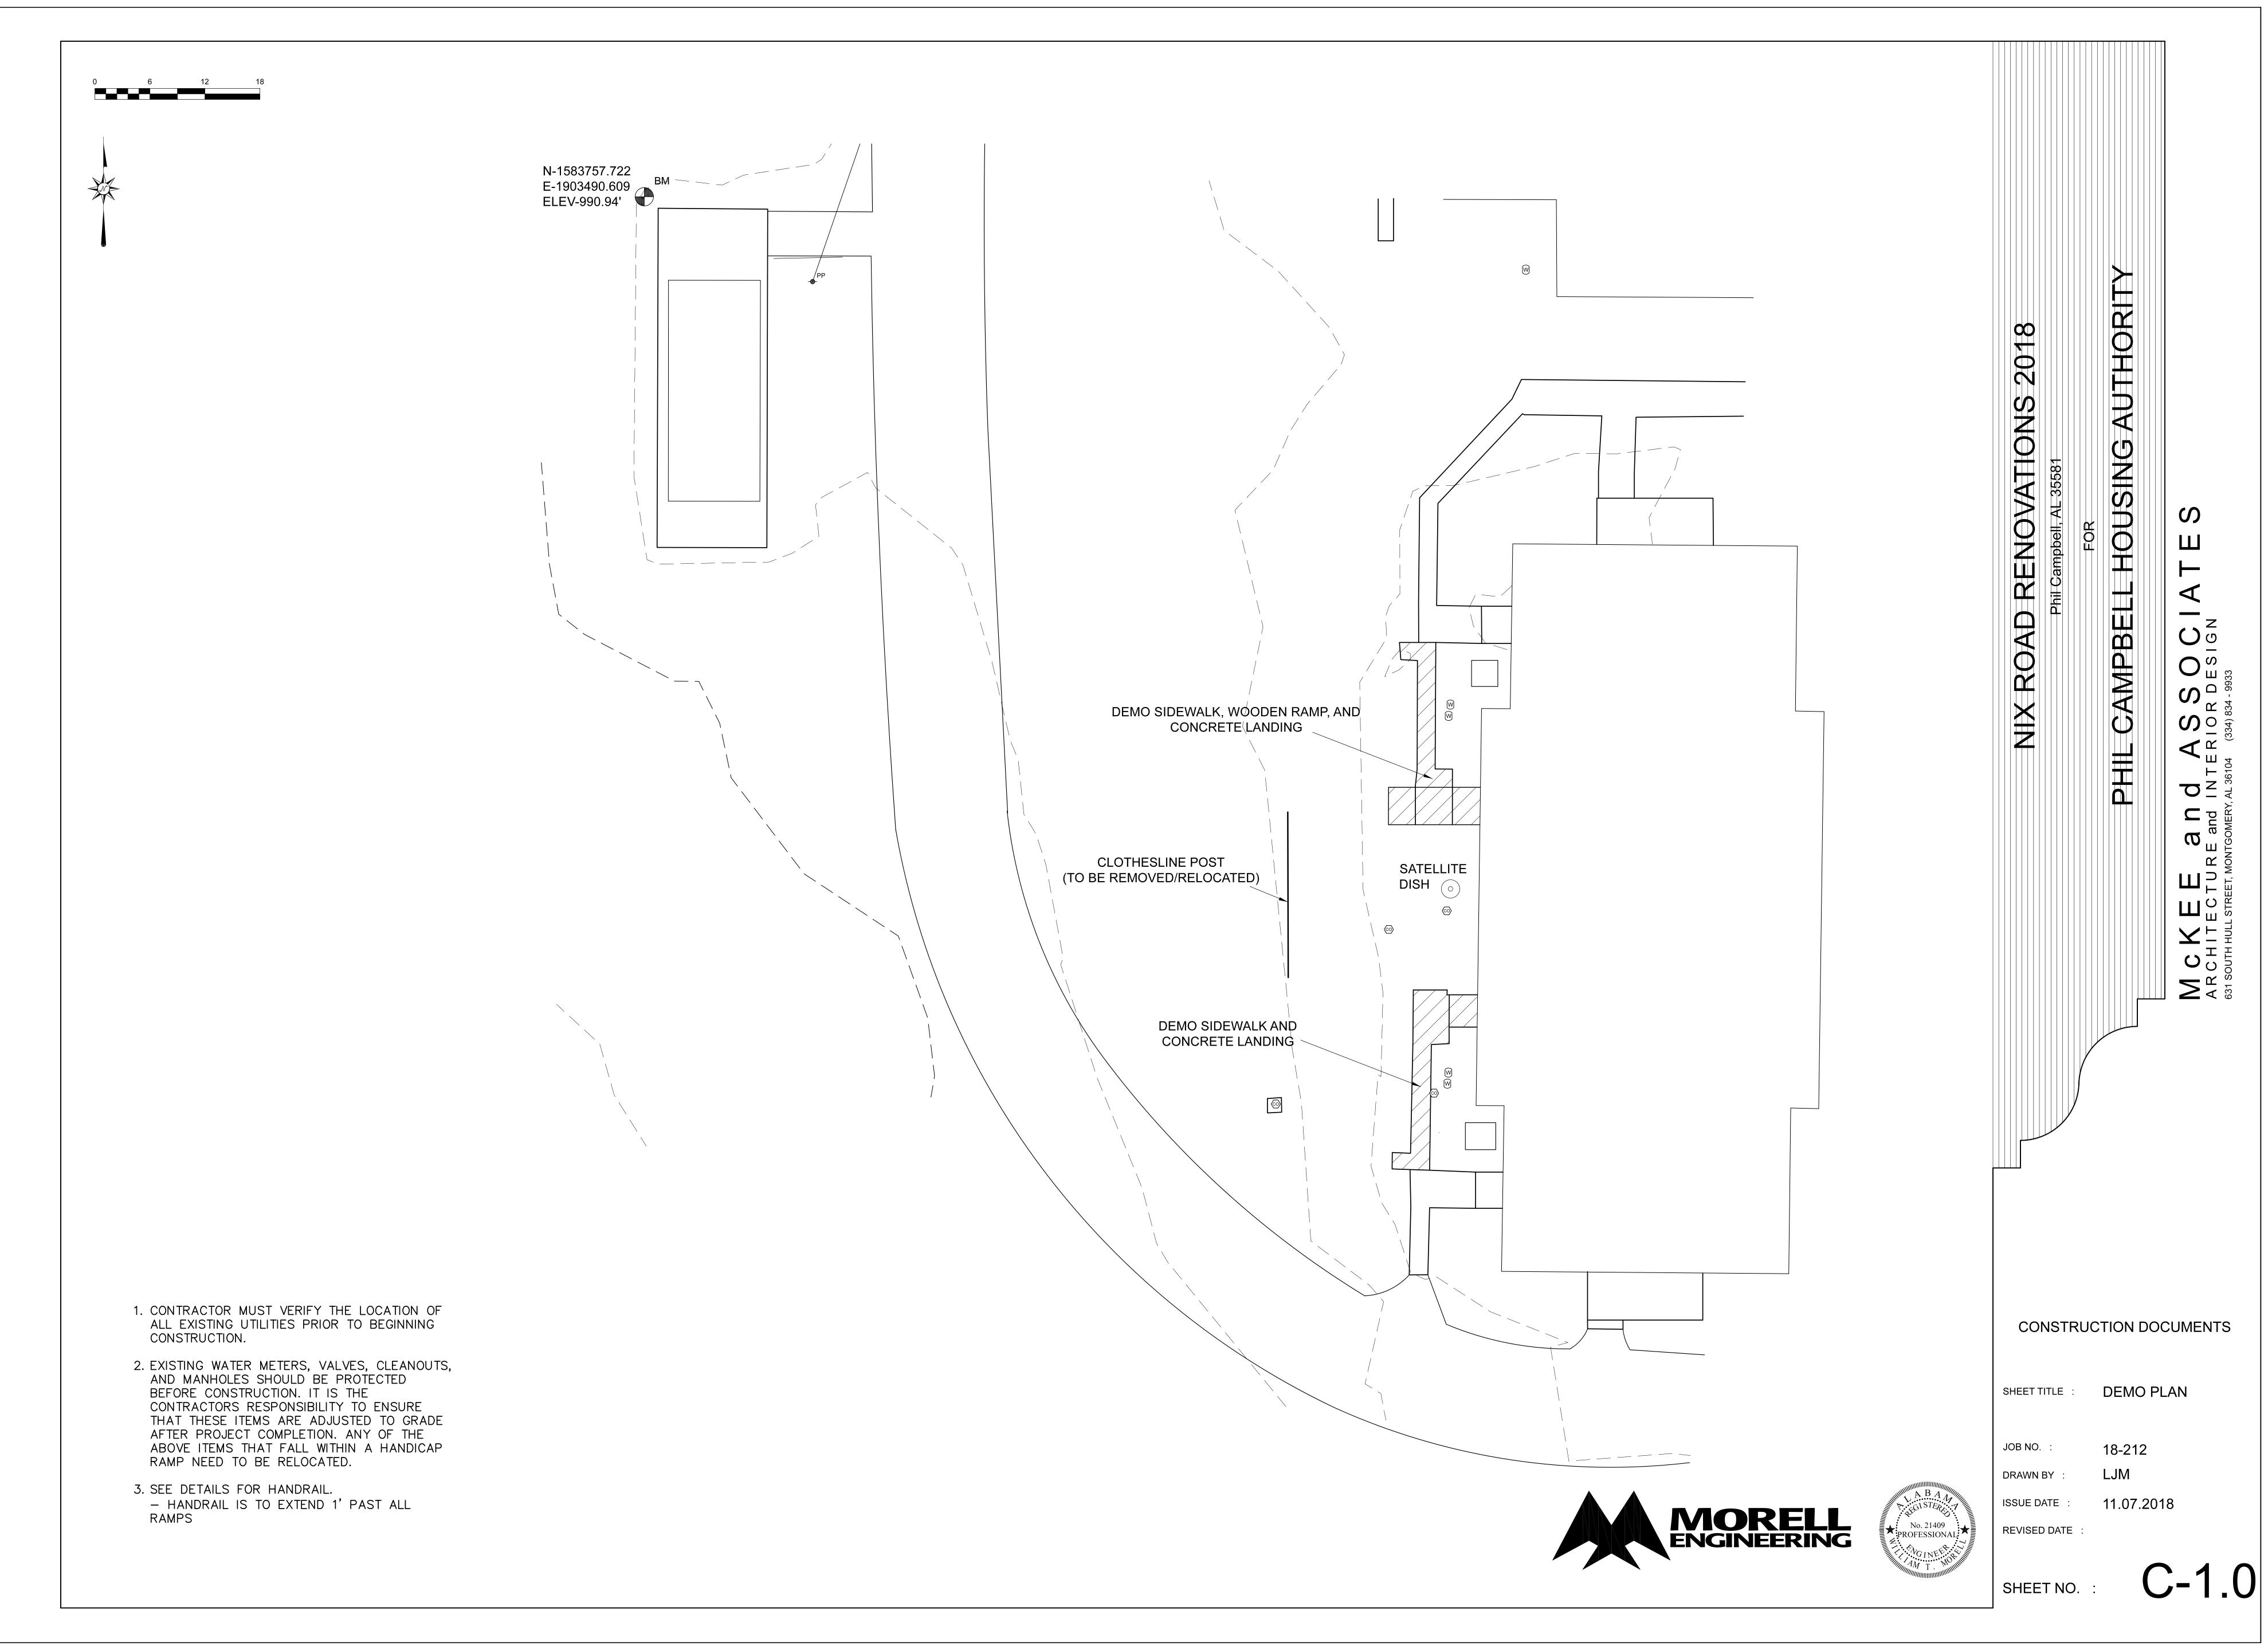


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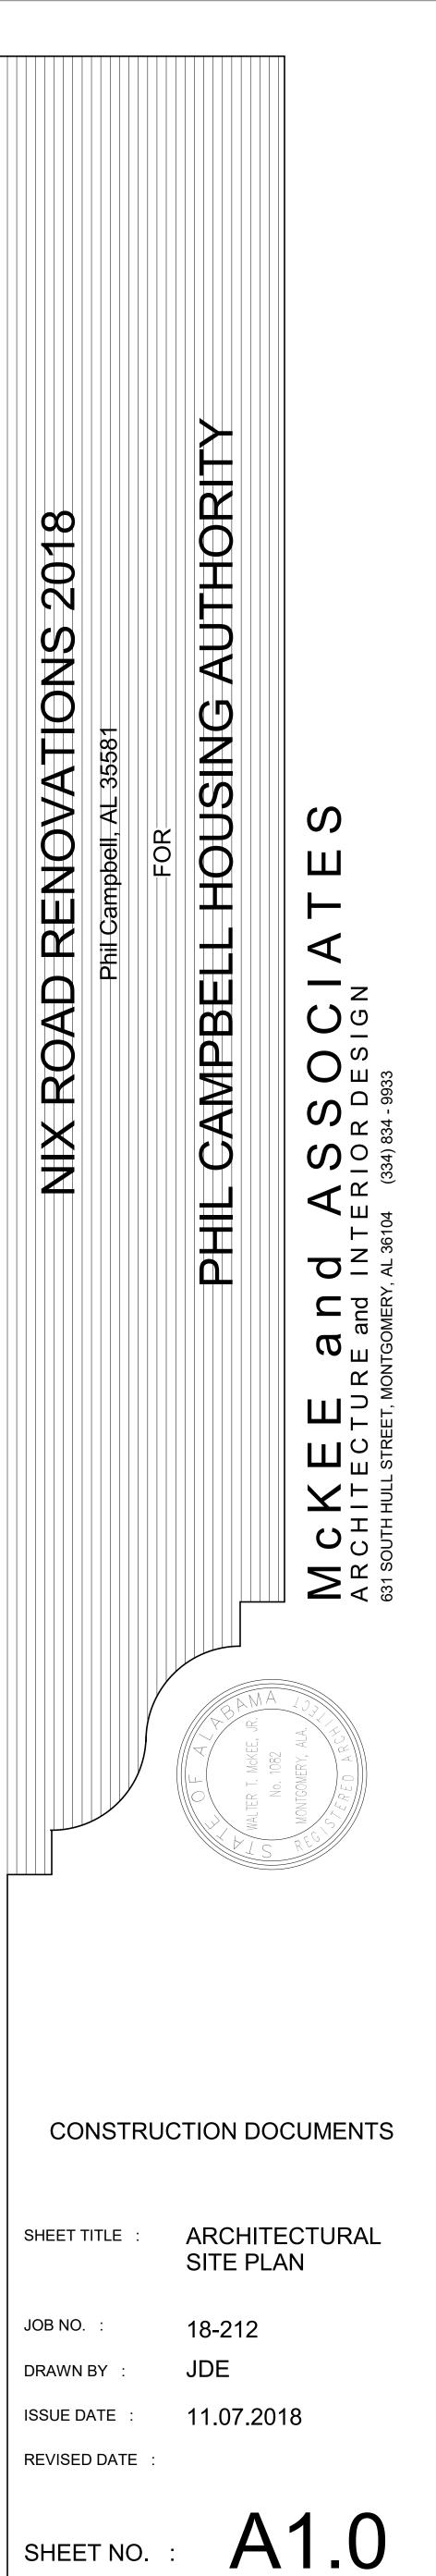
	N-1583757.7 E-1903490.6 ELEV-990.94
 CONTRACTOR MUST VERIFY THE LOCATION OF ALL EXISTING UTILITIES PRIOR TO BEGINNING CONSTRUCTION. EXISTING WATER METERS, VALVES, CLEANOUTS, AND MANHOLES SHOULD BE PROTECTED BEFORE CONSTRUCTION. IT IS THE CONTRACTORS RESPONSIBILITY TO ENSURE THAT THESE ITEMS ARE ADJUSTED TO GRADE AFTER PROJECT COMPLETION. ANY OF THE ABOVE ITEMS THAT FALL WITHIN A HANDICAP RAMP NEED TO BE RELOCATED. SEE DETAILS FOR HANDRAIL. – HANDRAIL IS TO EXTEND 1' PAST ALL RAMPS 	


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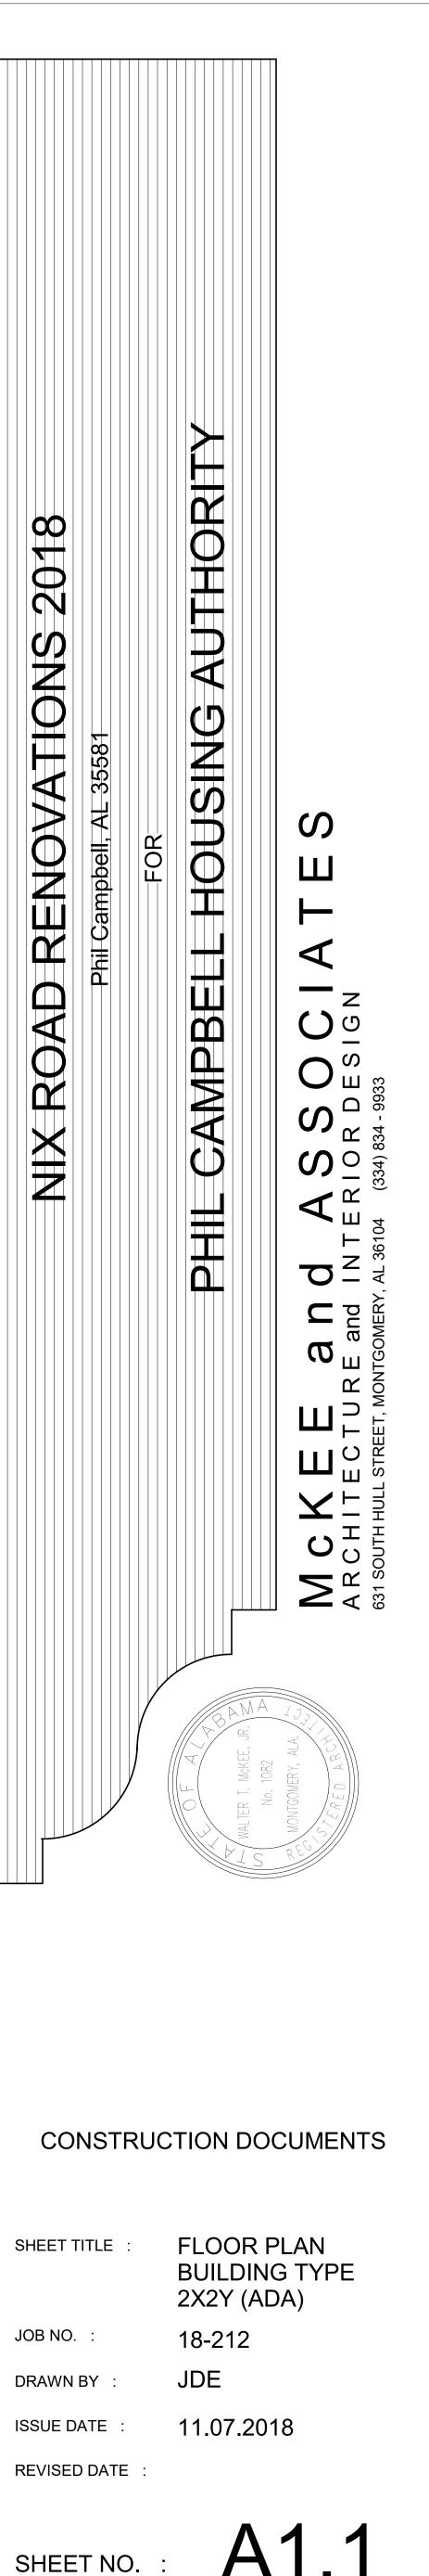


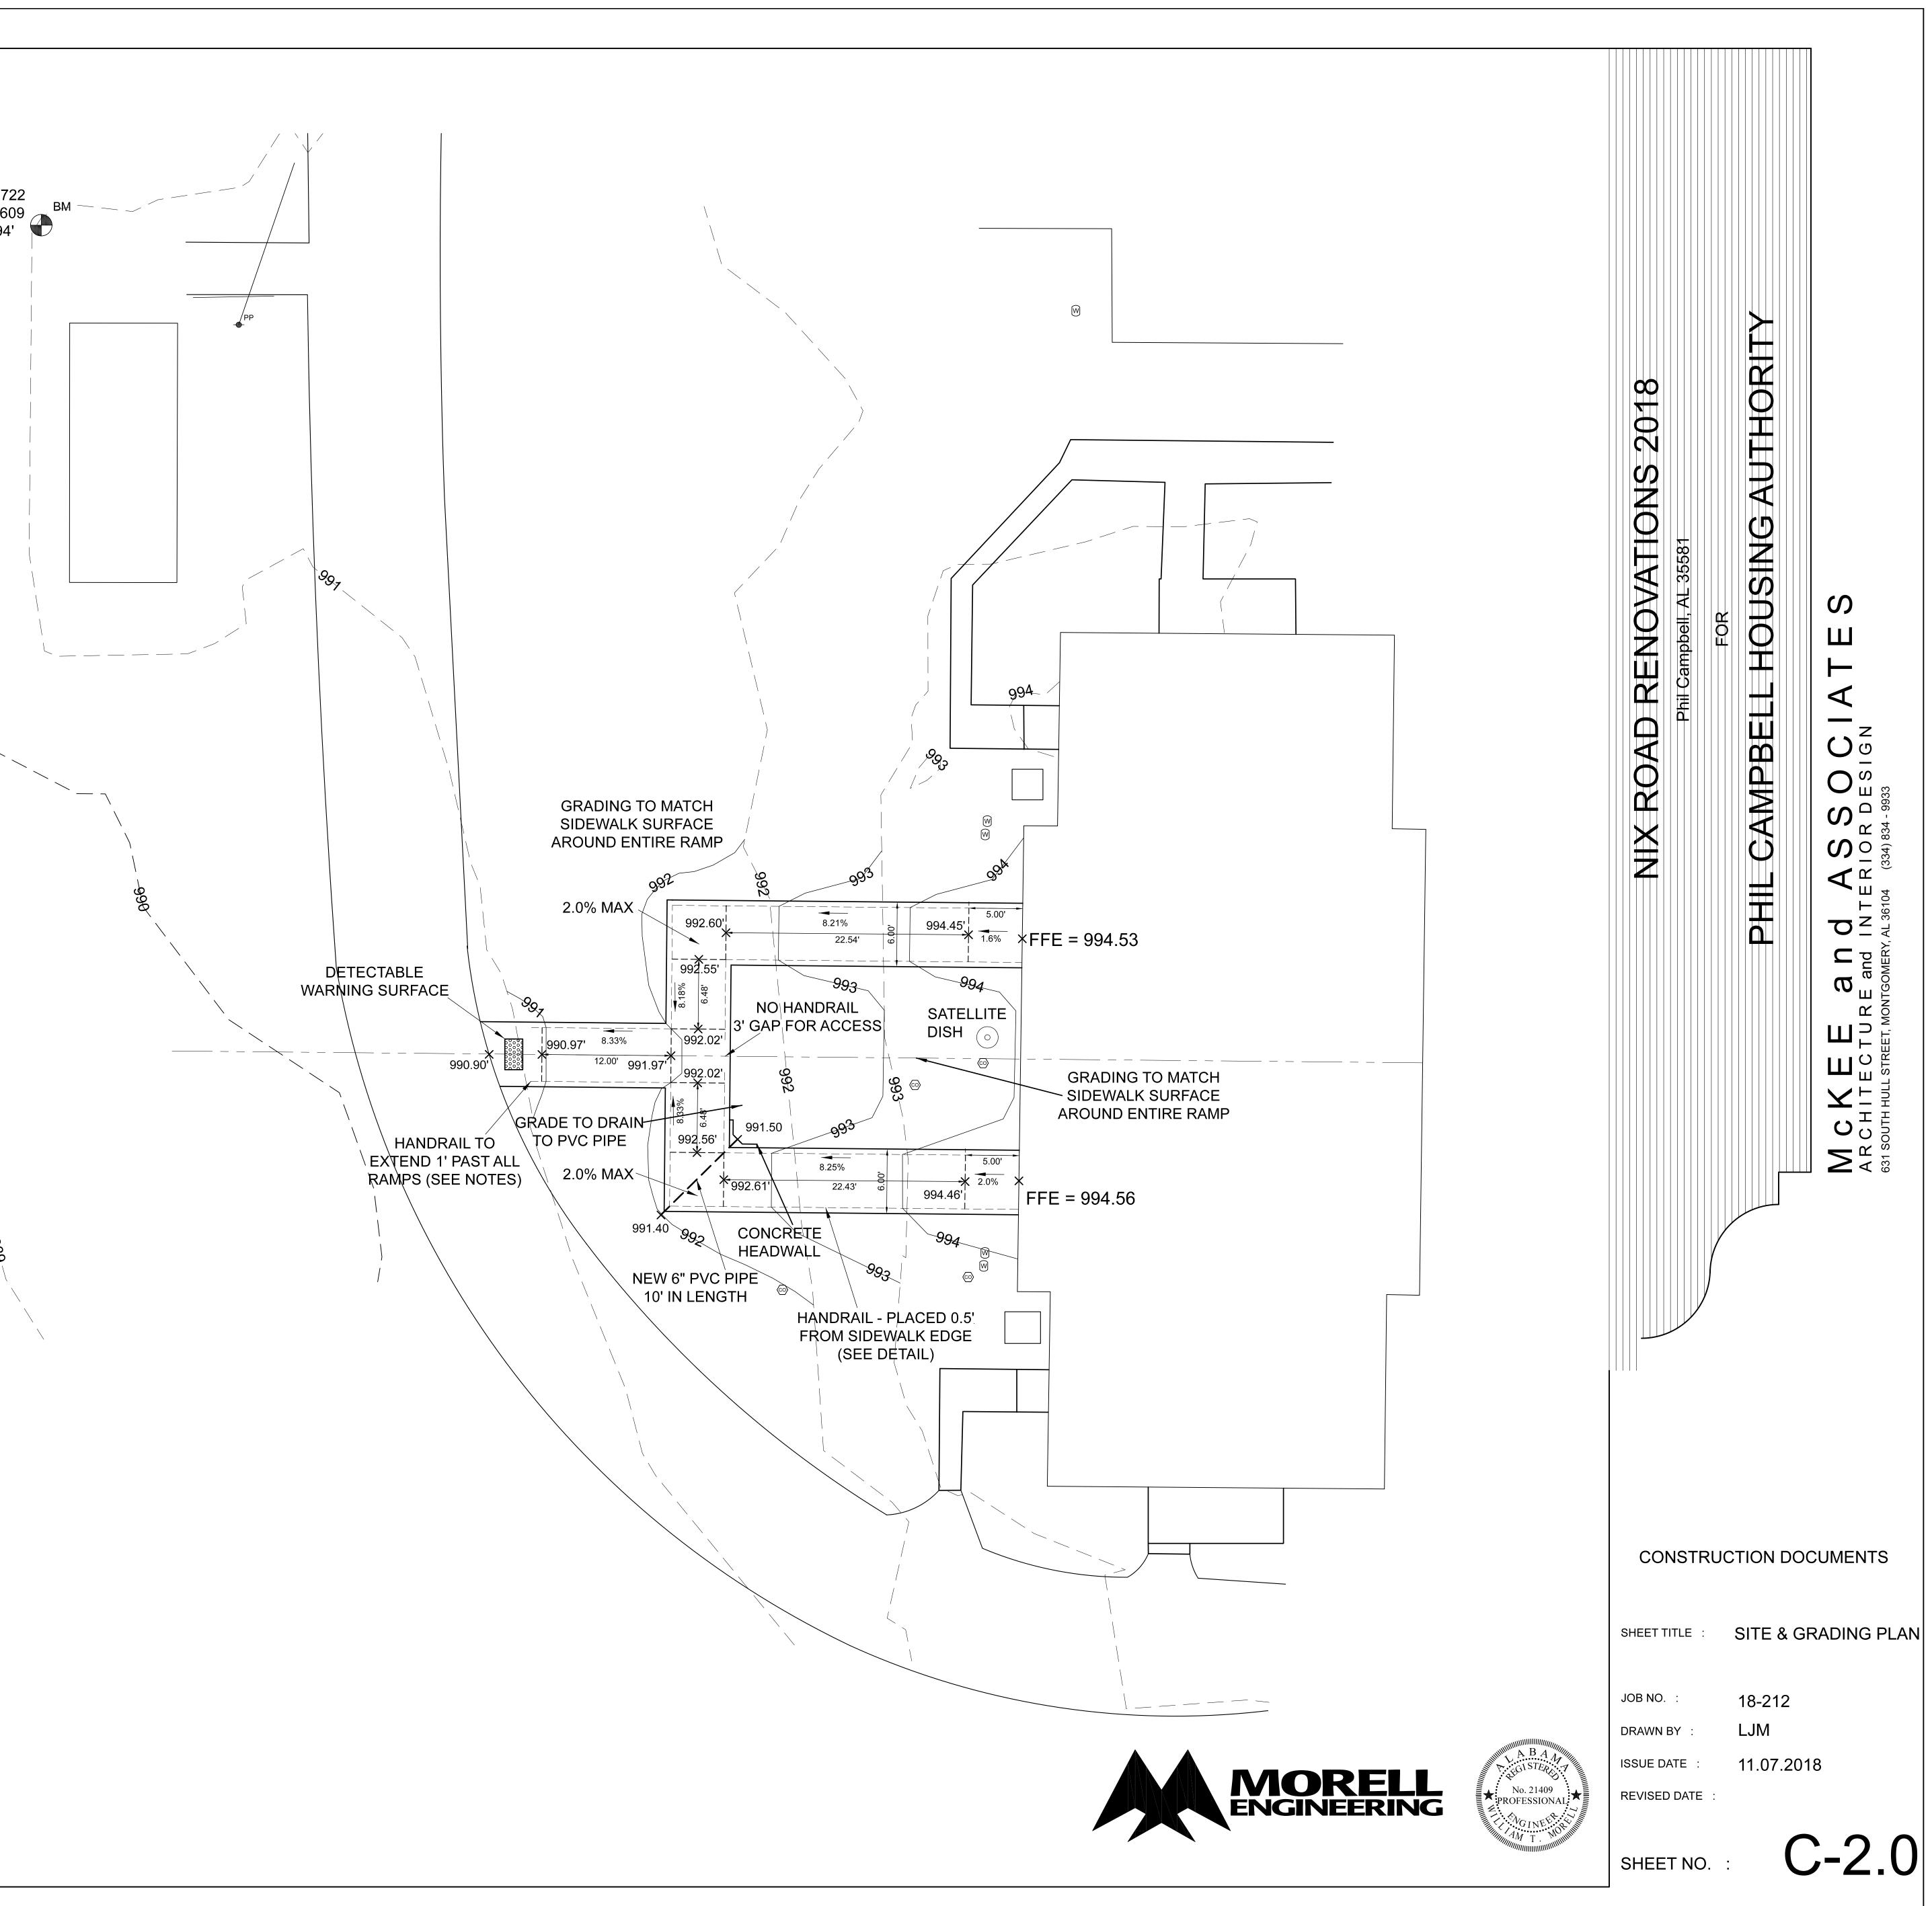



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96 C / 5 97 98 B / 6 99	
TE PLAN LEGEND	
A / 1 99 APPARTMENT NUMBER	
BUILDING NUMBER	
	I

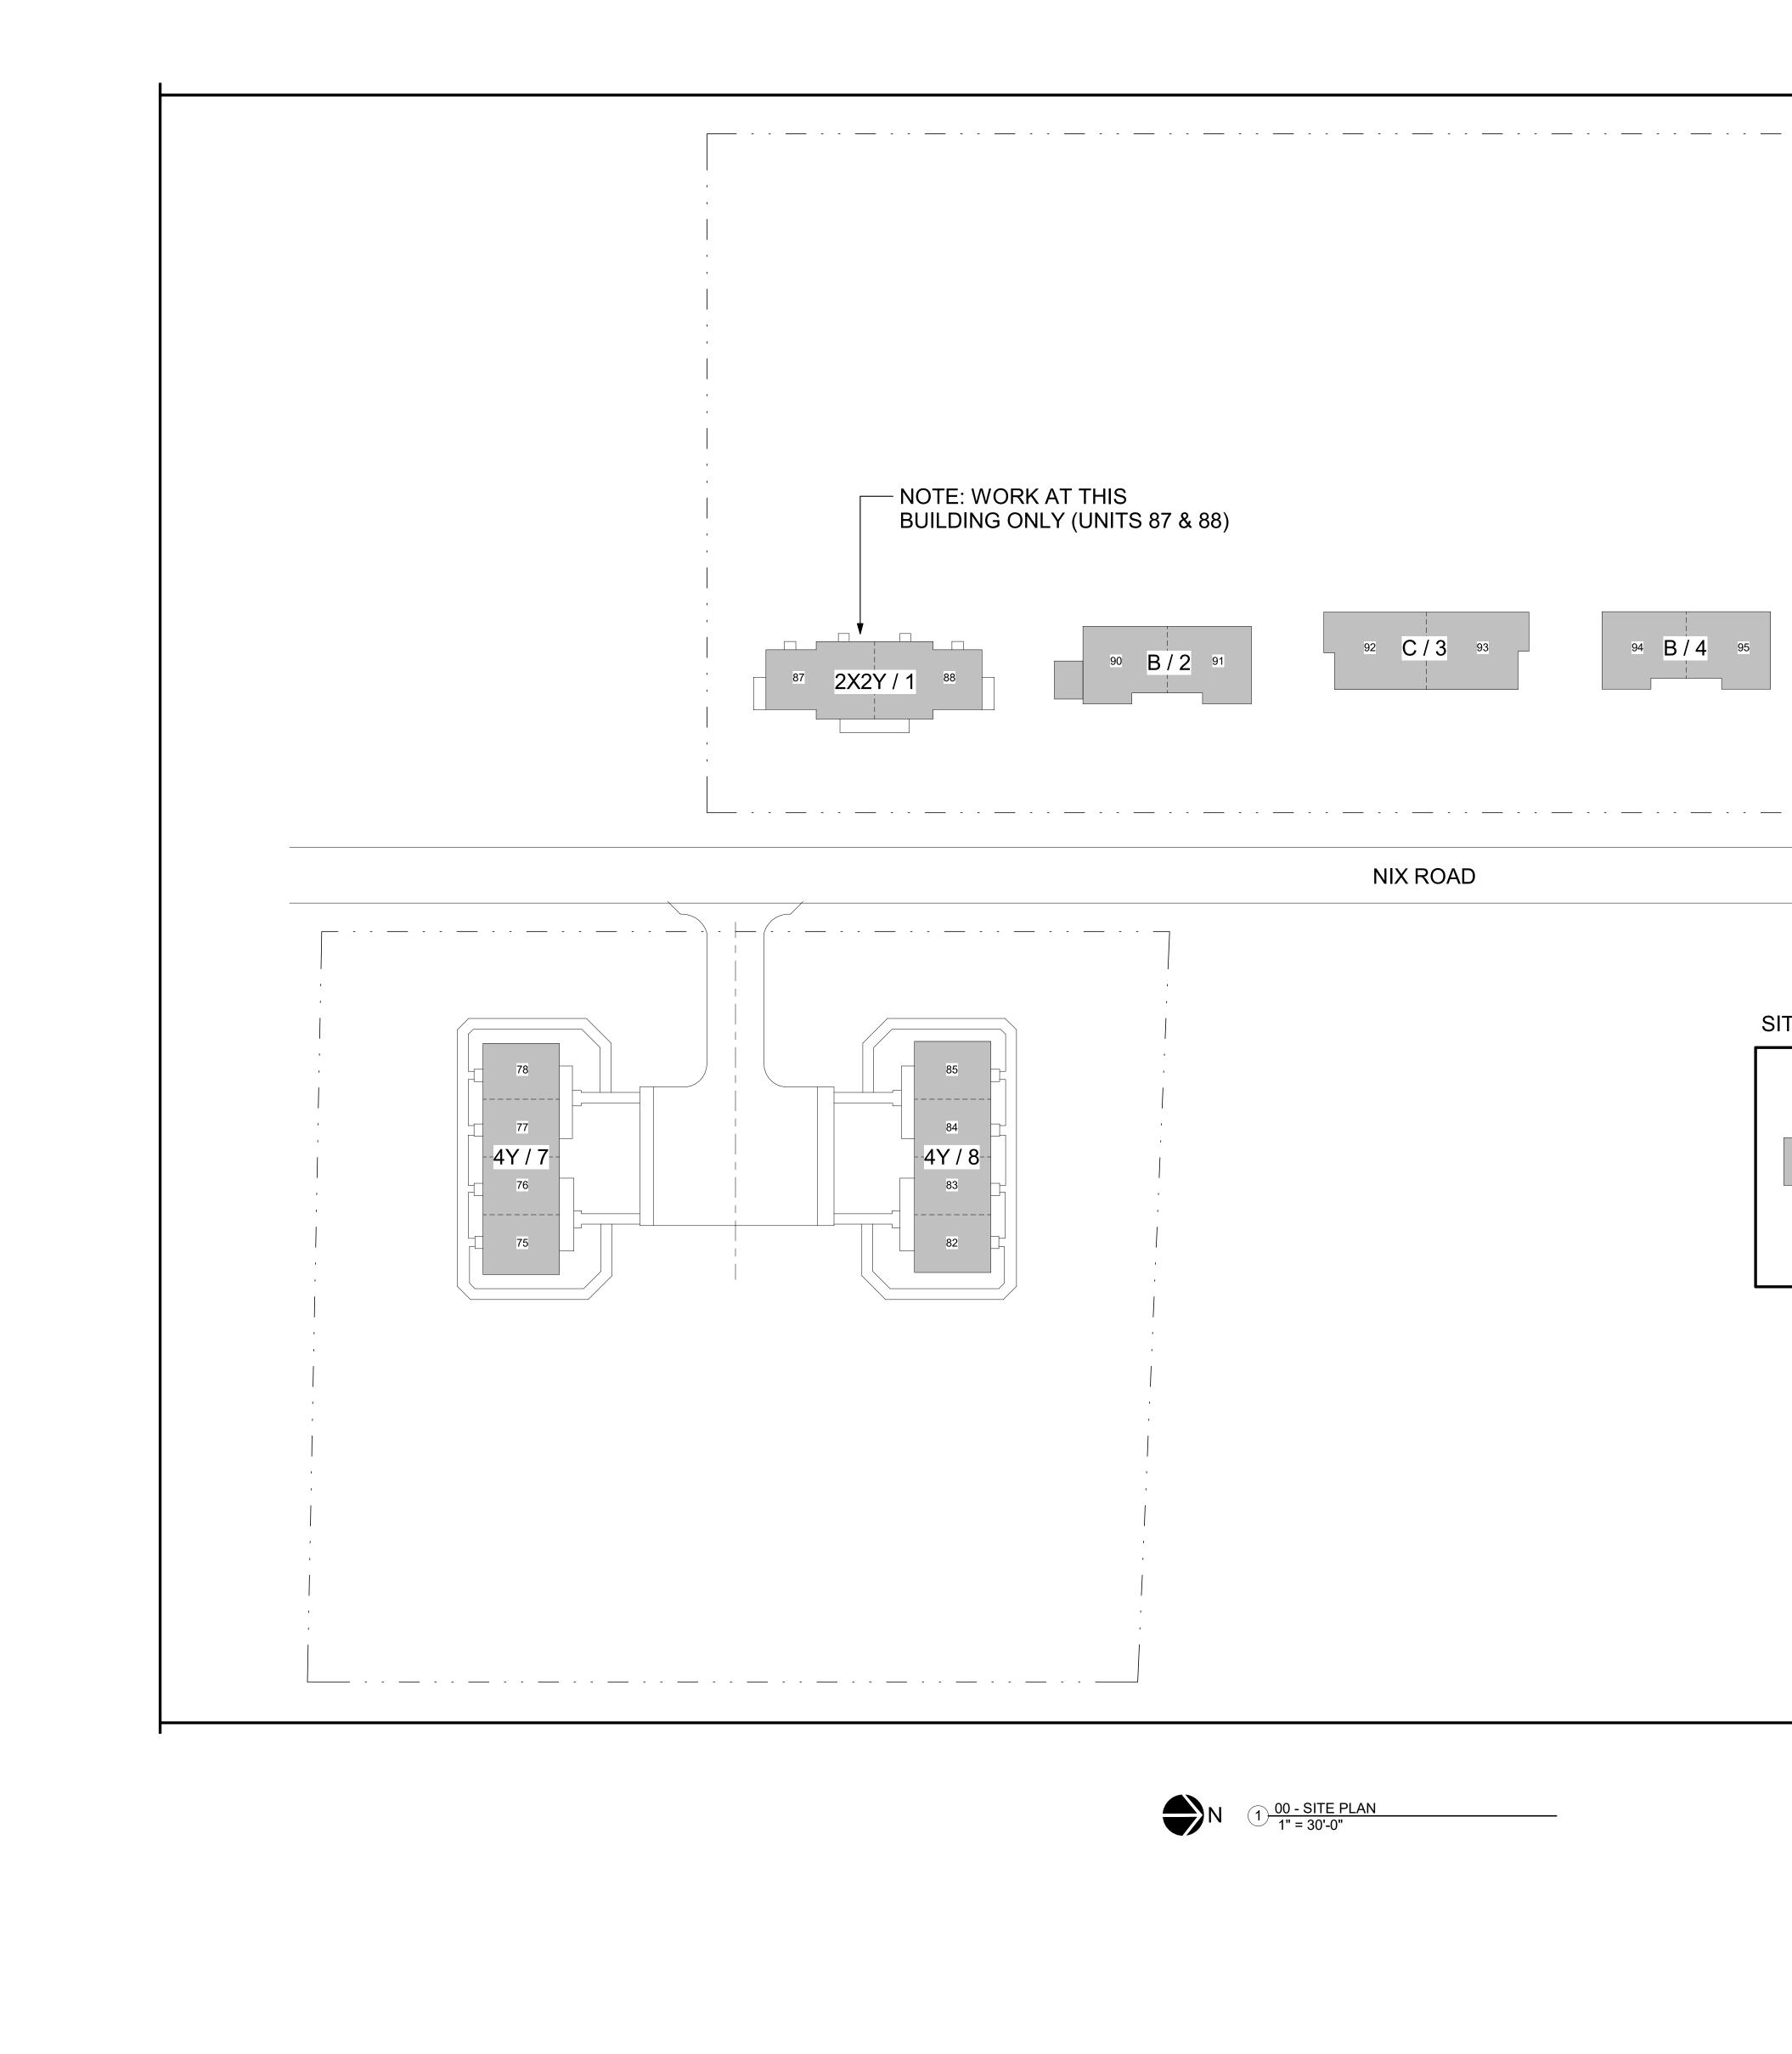




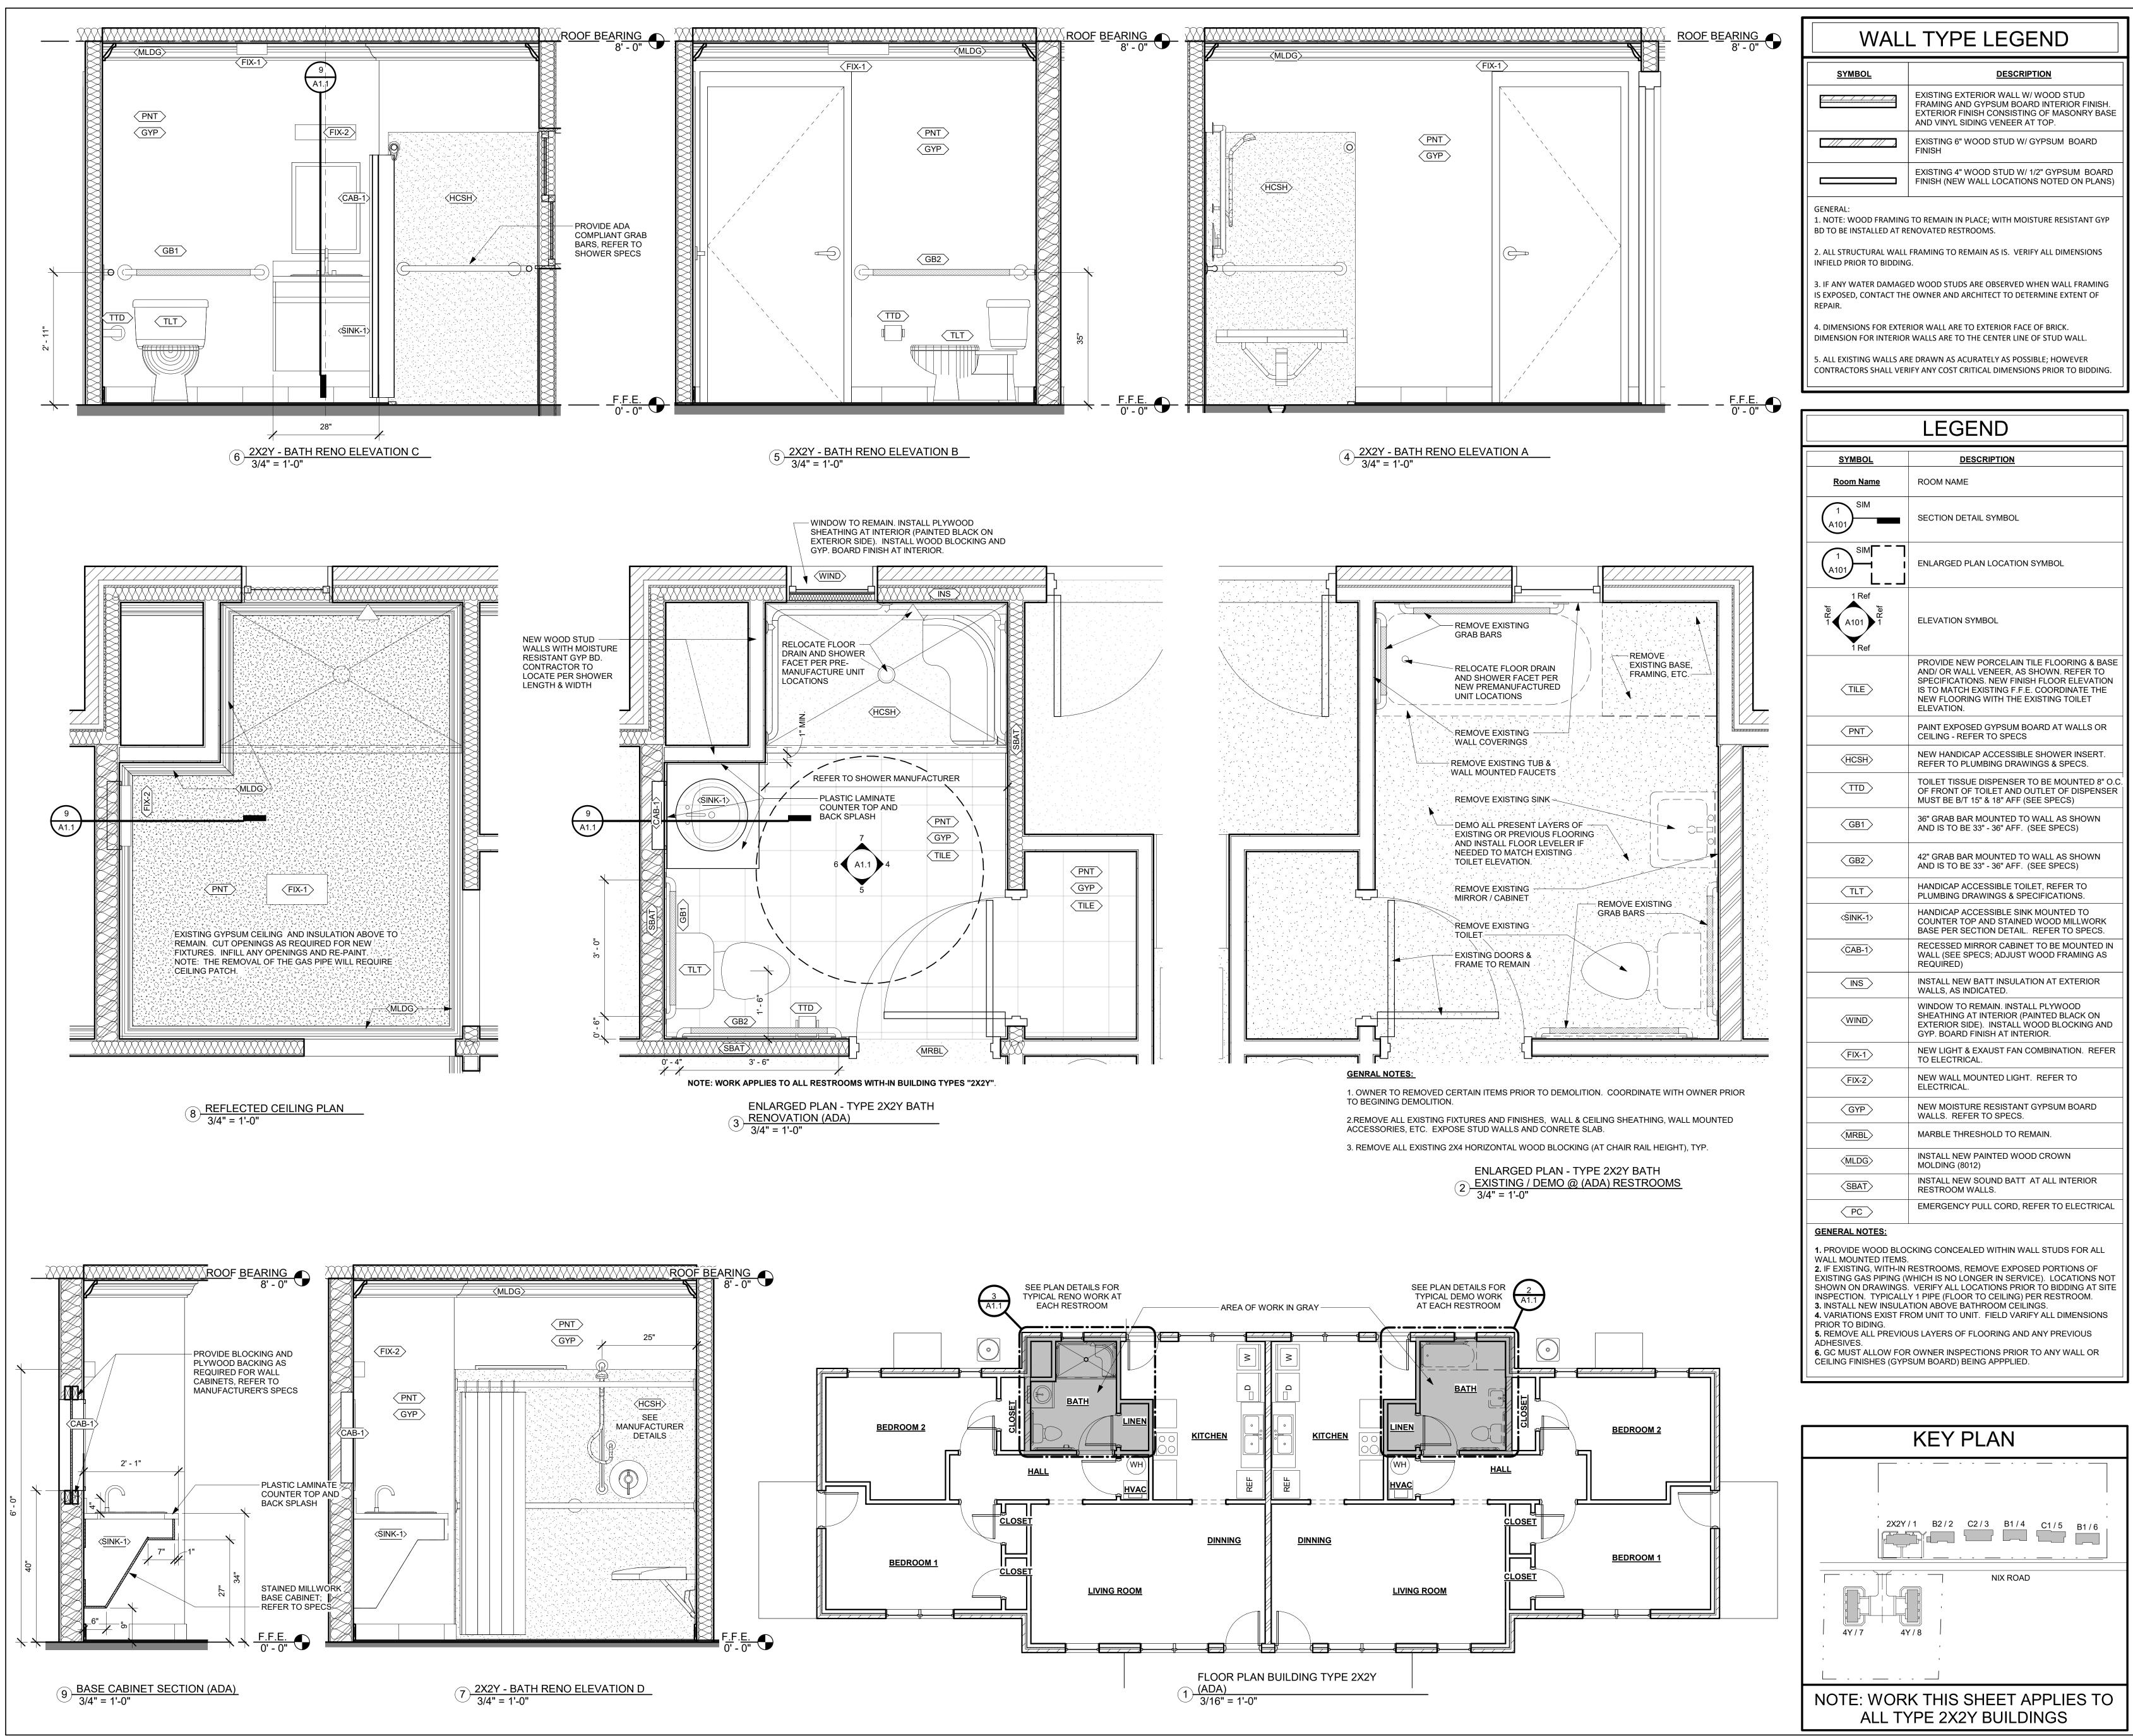

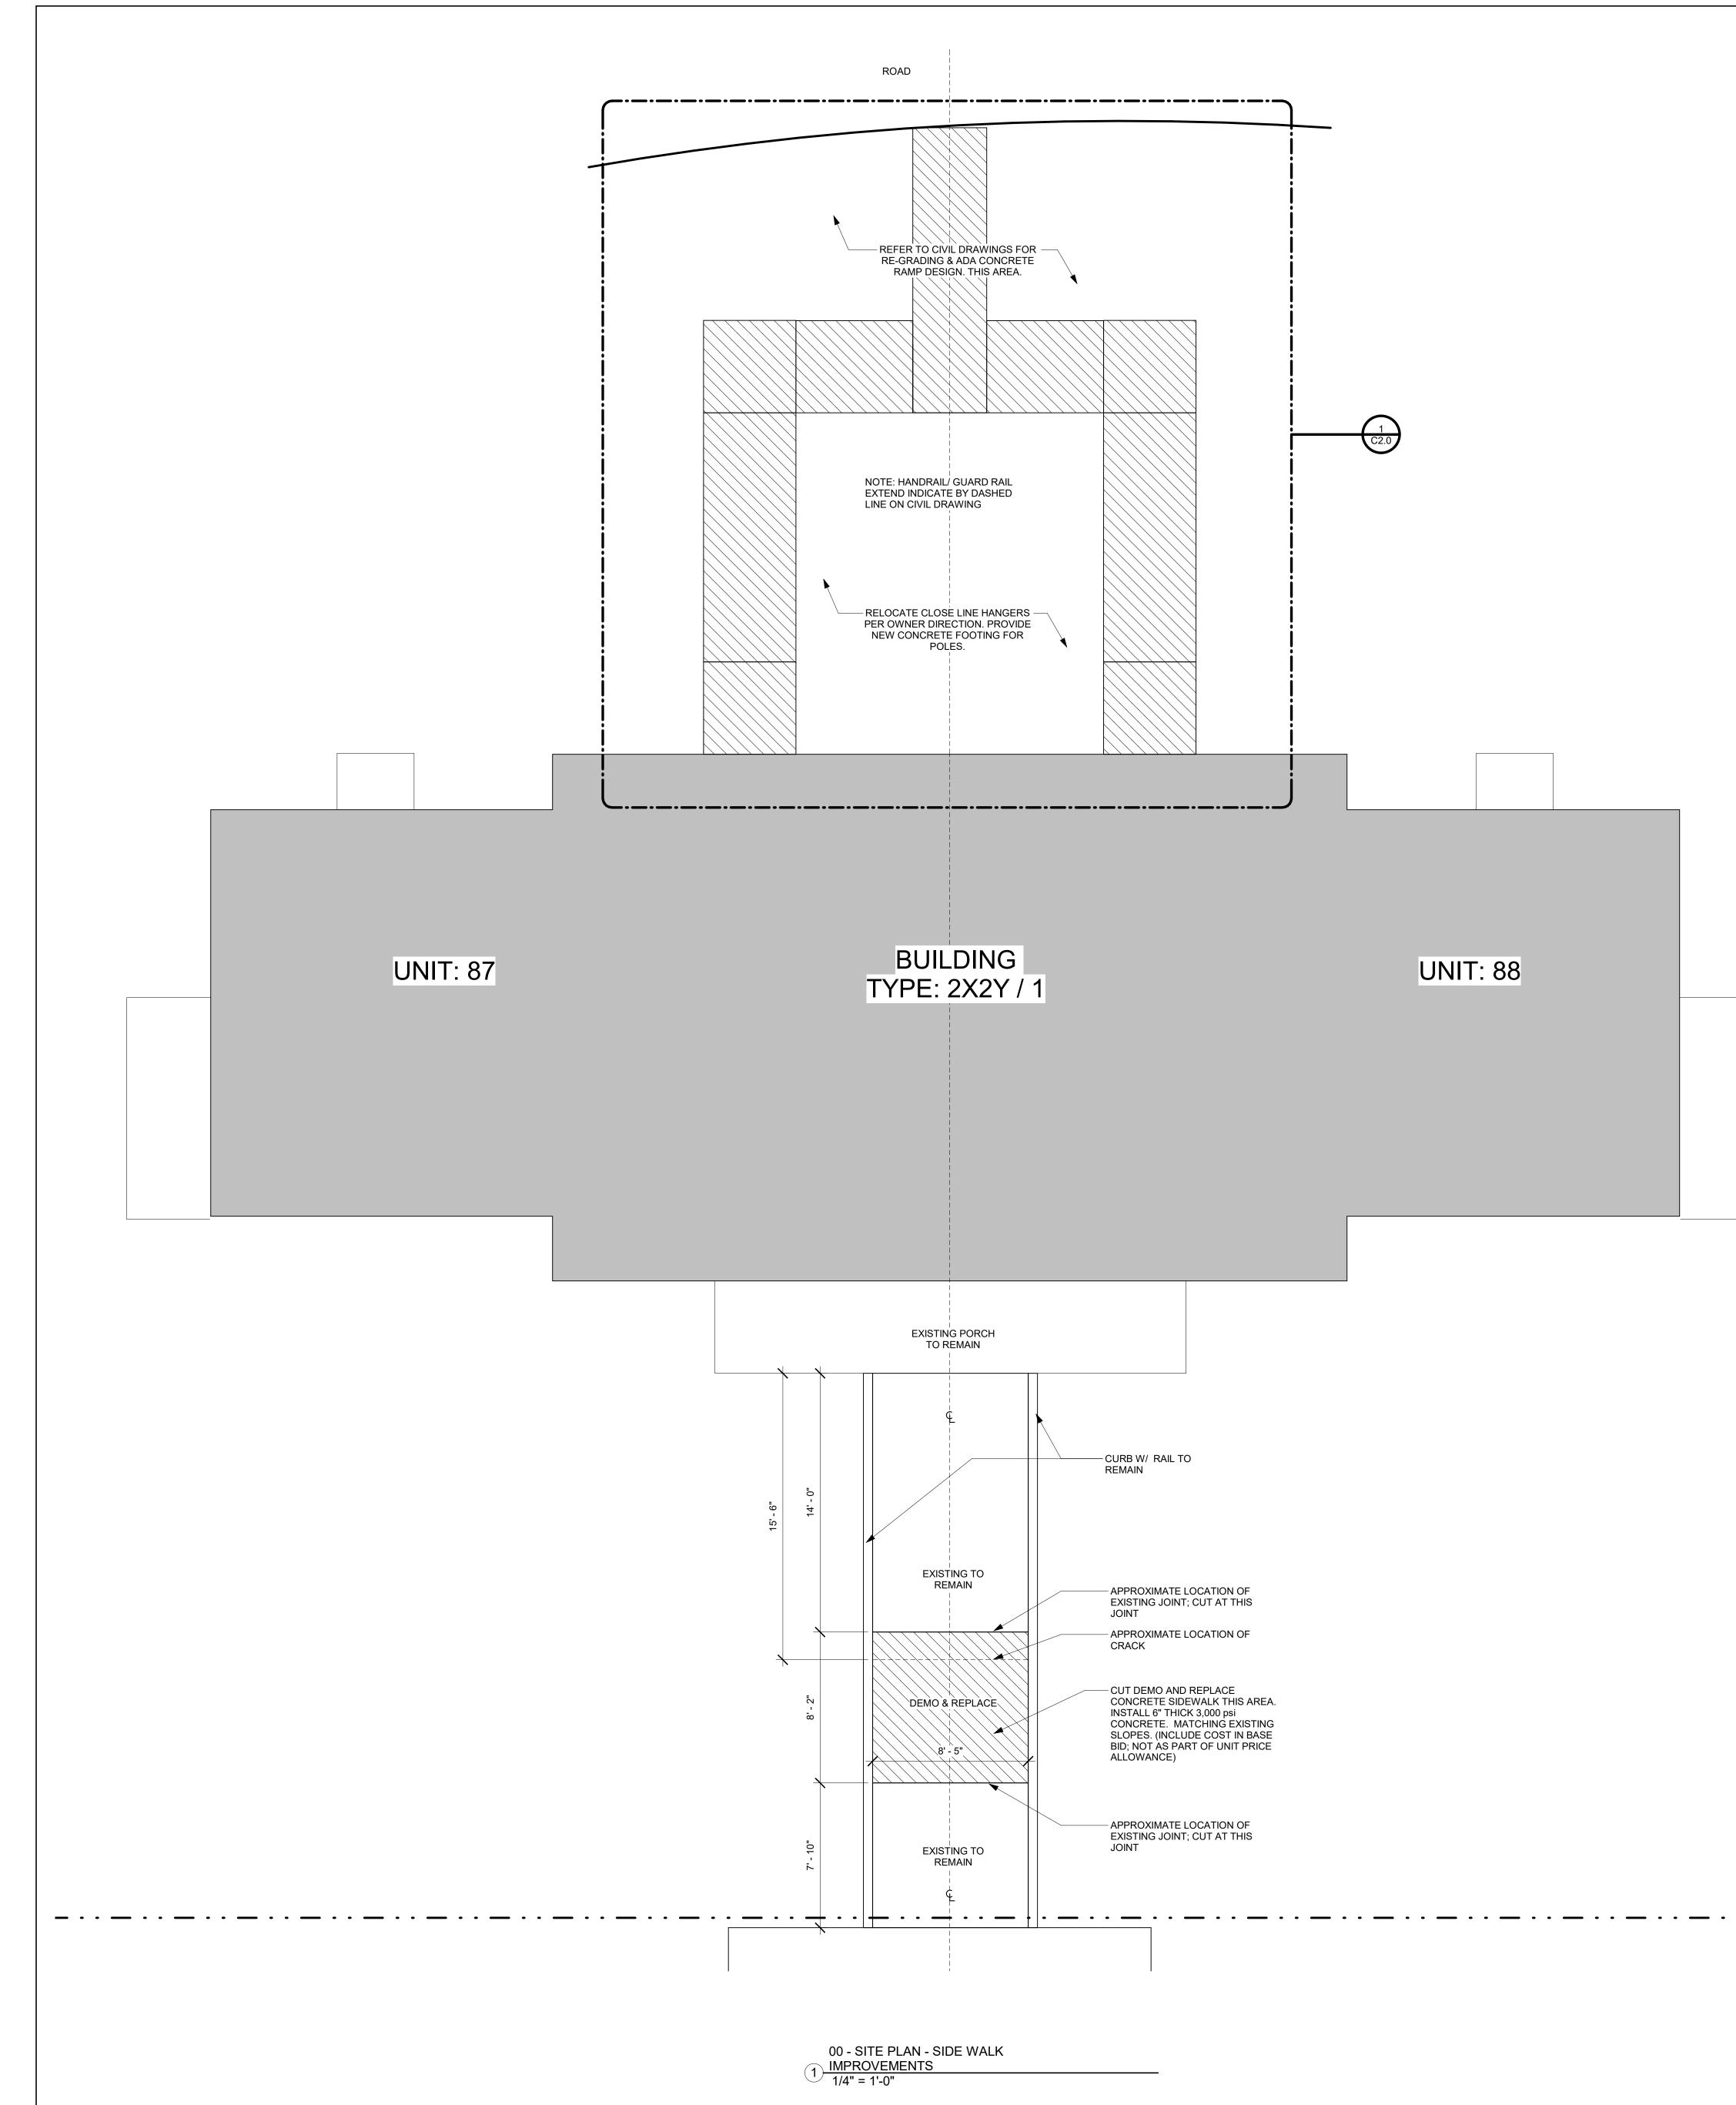

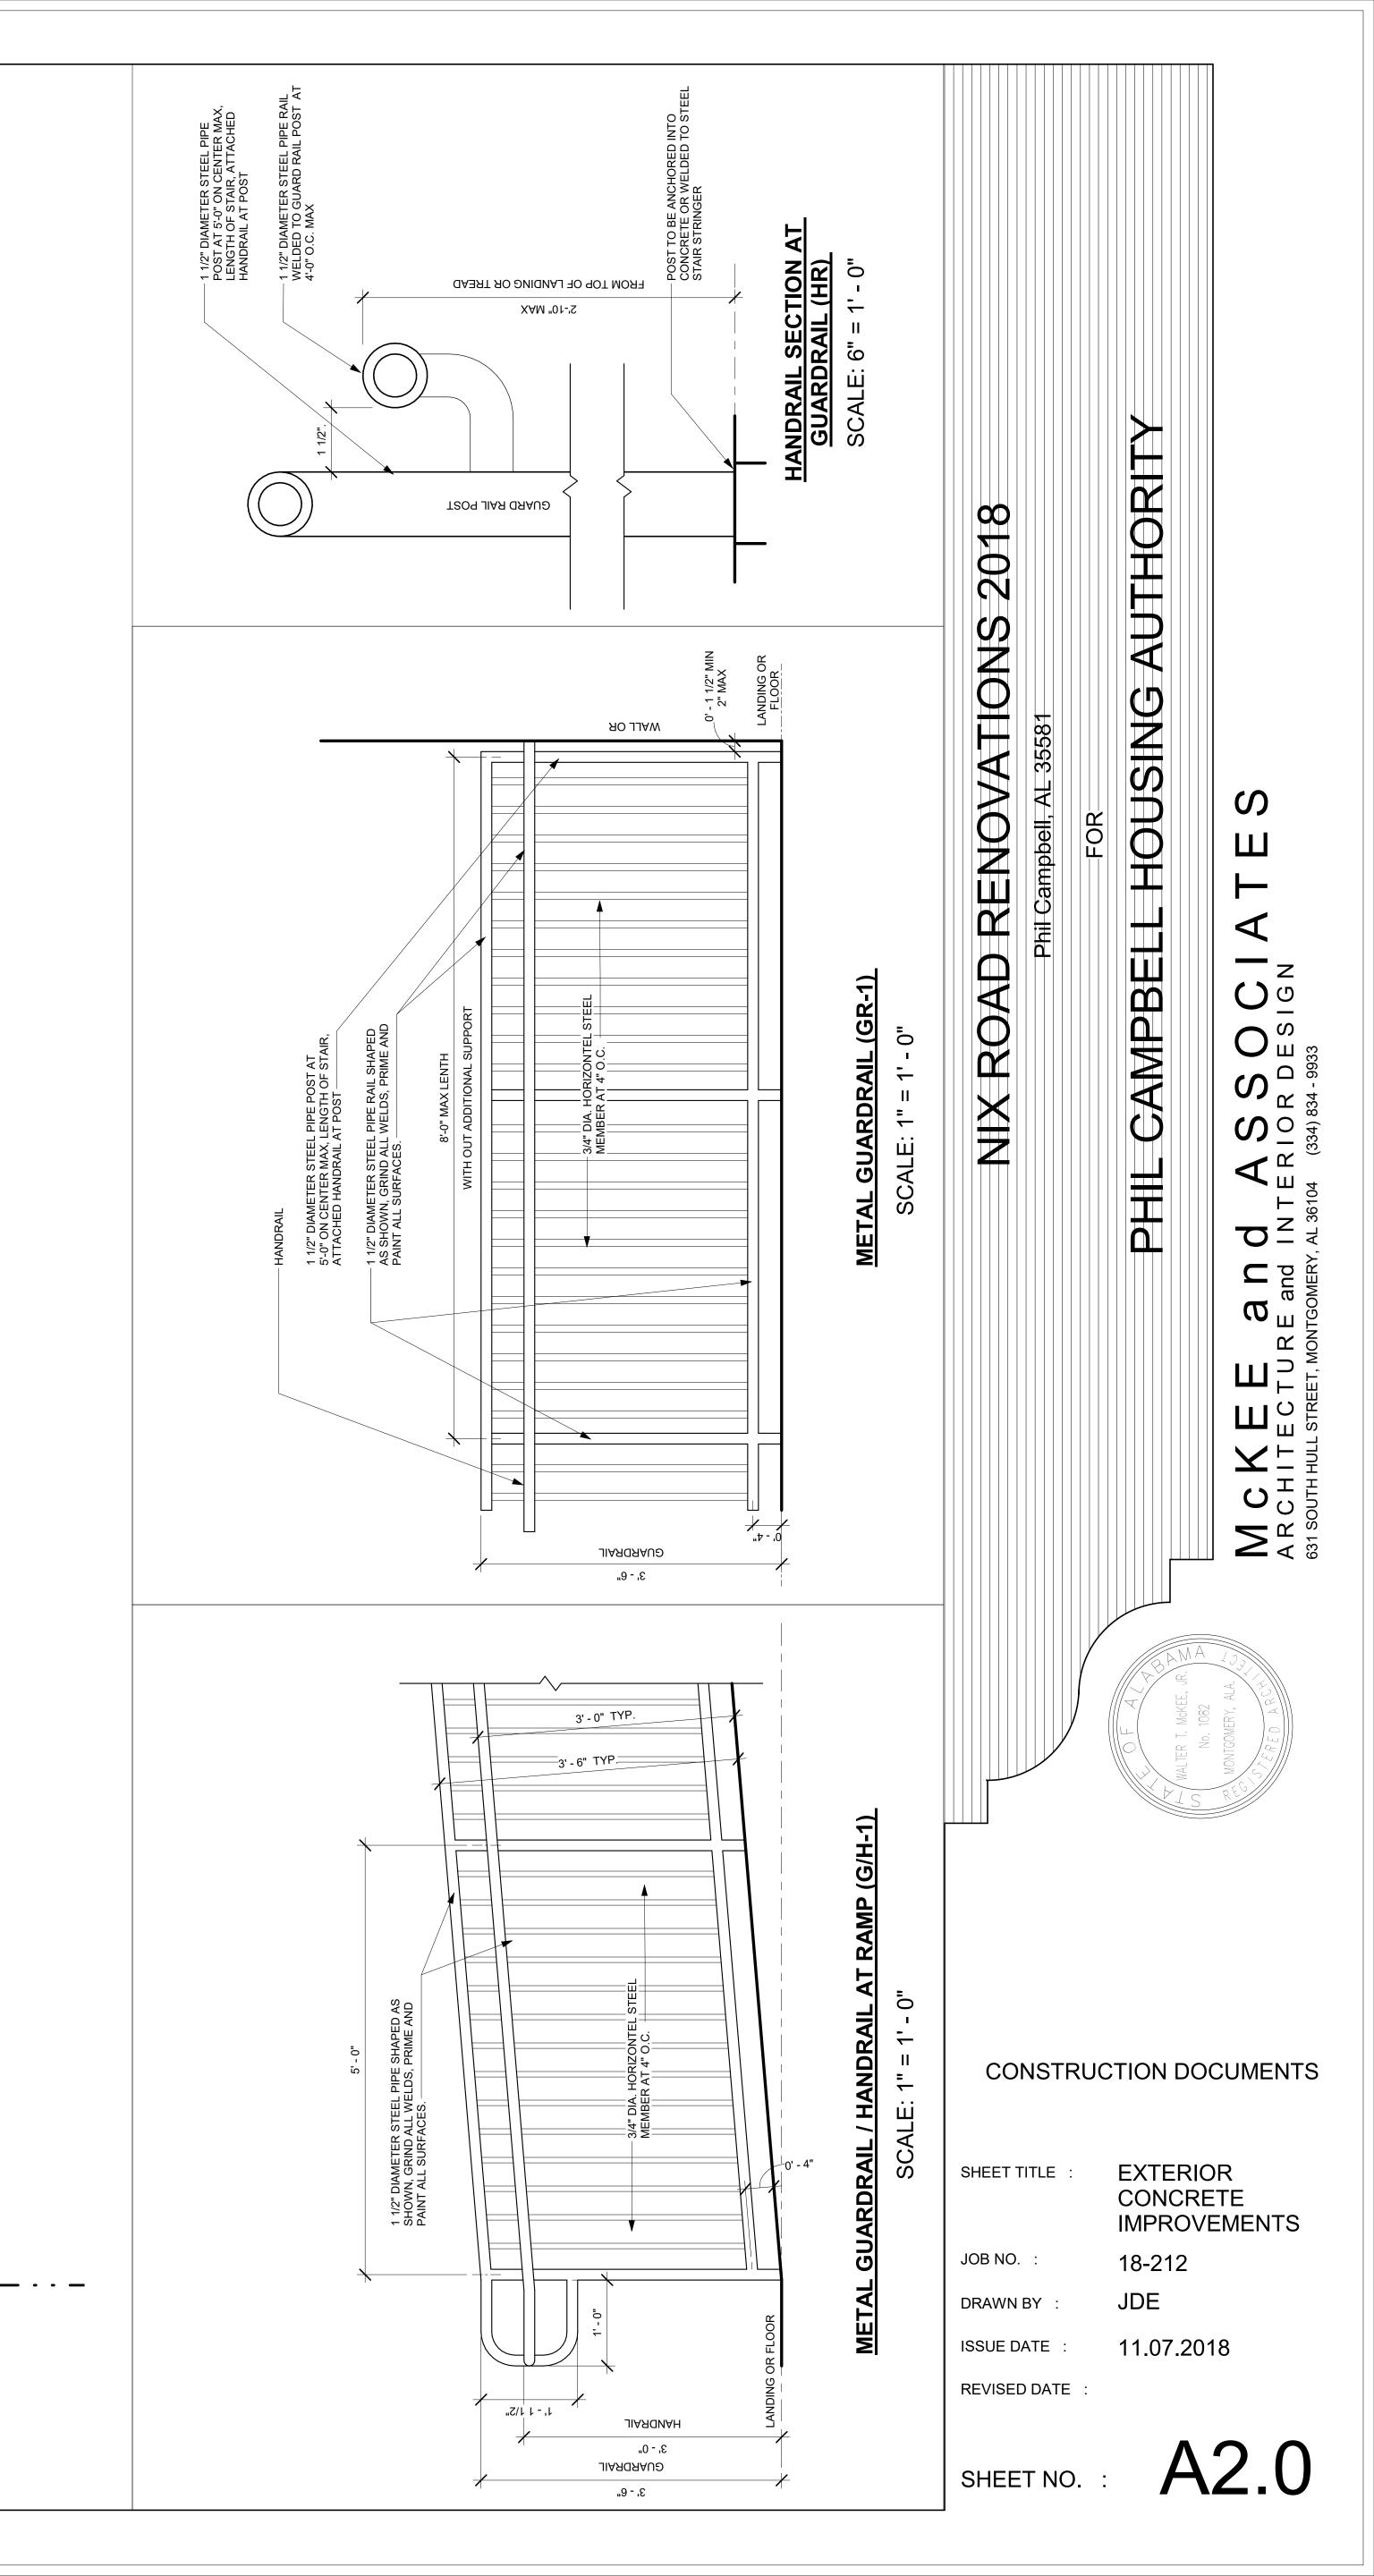

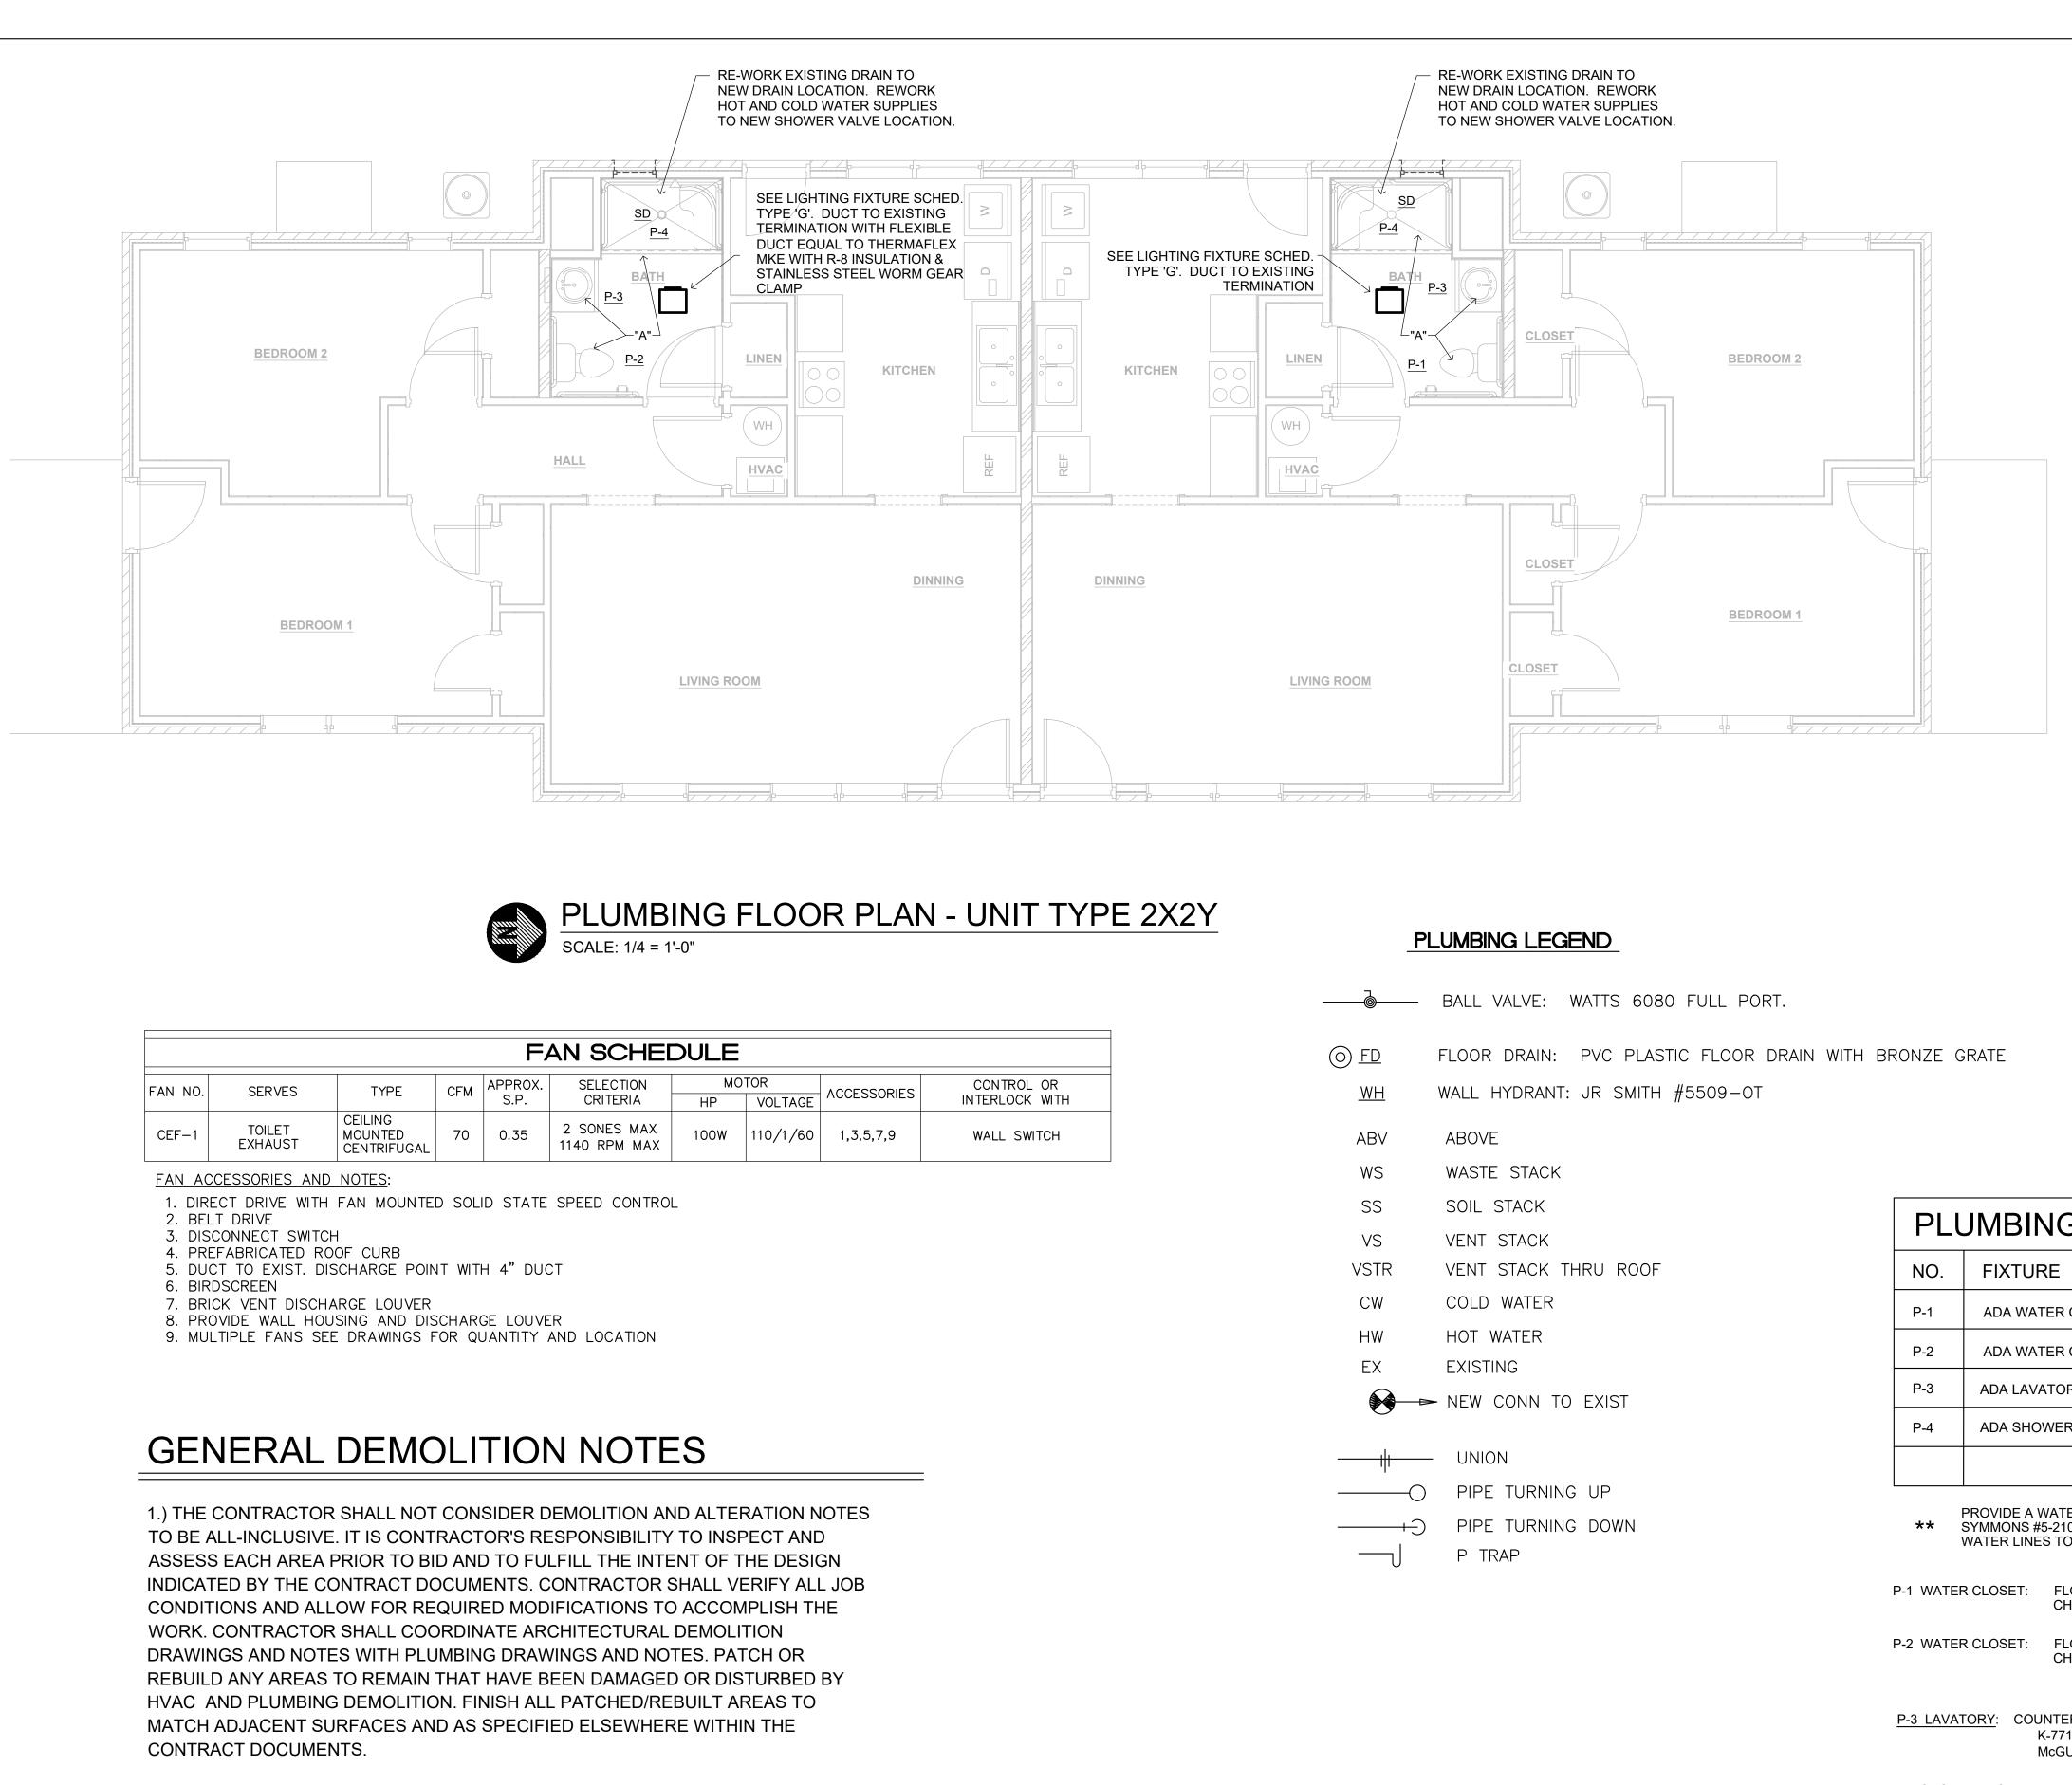

2.) THE CONTRACTOR SHALL VERIFY ALL CONDITIONS AND DIMENSIONS WITHIN THE CONTRACT LIMITS AND NOTIFY THE ARCHITECT IMMEDIATELY, IN WRITING, OF ANY DEVIATION FROM CONTRACT DOCUMENTS NECESSITATED BY FIELD CONDITIONS OR ITEMS NOT COVERED.

3.) ALL DEMOLITION SHALL BE PERFORMED IN A SAFE AND ACCEPTABLE MANNER TO ALL AUTHORITIES HAVING JURISDICTION, THE OWNER AND THE ARCHITECT. COMPLY WITH ALL GOVERNING REGULATIONS PERTAINING TO ENVIRONMENTAL PROTECTION FOR POLLUTION CONTROL. THOROUGHLY CLEAN ADJACENT AREAS AND ALL OTHER AFFECTED AREAS OF DUST, DIRT AND DEBRIS CAUSED BY DEMOLITION WORK. RETURN AREAS TO CONDITION FOUND PRIOR TO START OF DEMOLITION WORK BEFORE NEW WORK BEGINS.

4.) HAZARDOUS MATERIAL NOTE: IT IS ANTICIPATED THAT THERE WILL NOT BE ANY HAZARDOUS MATERIALS ON SITE. SHOULD ANY HAZARDOUS MATERIALS BE FOUND, THE CONTRACTOR SHALL STOP WORK AND INFORM THE ARCHITECT IMMEDIATELY, IN WRITING, OF ANY HAZARDOUS MATERIAL ENCOUNTERED OR THOUGHT TO BE HAZARDOUS MATERIAL. THE ARCHITECT, AFTER RECEIVING WRITTEN NOTICE SHALL INSTRUCT CONTRACTOR ON HOW TO PROCEED.

5.) CONTRACTOR SHALL REVIEW ALL ITEMS TO BE DEMOLISHED WITH ARCHITECT AND IDENTIFY ANY ITEMS TO BE SALVAGED PRIOR TO START OF DEMOLITION. SALVAGED ITEMS SHALL BE TRANSPORTED AND STORED AT A LOCATION DESIGNATED BY THE ARCHITECT. REMAINING ITEMS SHALL BE PROPERLY DISPOSED OF BY THE CONTRACTOR.

6.) REMOVE ALL EXISTING FIXTURES, TUBING, PIPING, HANGERS, FITTINGS, SUPPORTS, ETC., AS REQUIRED TO FACILITATE INSTALLATION OF NEW EQUIPMENT. DO NOT REUSE EXISTING HANGERS, SUPPORTS, ETC. ALL ITEMS SHALL BE NEW. NO ITEMS SHALL BE ABANDONED IN PLACE.

7.) WHERE PIPING IS BEING REMOVED ON OR THROUGH THE ROOF, REMOVE ALL PIPING SUPPORTS. A CERTIFIED ROOFING CONTRACTOR MUST PROVIDE THE ROOF REPAIR AS REQUIRED TO MAINTAIN THE NEW/EXISTING ROOFING WARRANTY.

CONTROL INTERLOCK	

WALL	SWITCH
WALL	SWITCH

PL	UME	BING	LE	GEN	ND

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0 <u>FD</u>	FLOOR DRAIN: PVC PLASTIC FLOOR DRAIN WITH BRONZE GRATE							
<u>WH</u>	WALL HYDRANT: JR SMITH #5509-0T							
ABV	ABOVE							
WS	WASTE STACK							
SS	SOIL STACK			SOUE				
VS	VENT STACK	PLU	JMBING FIXTURE	SUNEL	JULE			
VSTR	VENT STACK THRU ROOF	NO.	FIXTURE	WASTE	C.W.	H.W.	REMARKS	ARCH. SYMBOL
CW	COLD WATER	P-1	ADA WATER CLOSET	3"	1/2"		ADA - LEFT HAND FLUSH	TLT
HW	HOT WATER	P-2	ADA WATER CLOSET	3"	1/2"		ADA - RIGHT HAND FLUSH	TLT
EX	EXISTING	F-2		3	1/2			
\$	➡ NEW CONN TO EXIST	P-3	ADA LAVATORY **	1 1/4"	1/2"	1/2"	DROP-IN TYPE - ADA	SINK-1
O		P-4	ADA SHOWER	SD	1/2"	1/2"	ADA ROLL-IN TYPE	HCSH
	— UNION							
() PIPE TURNING UP							
) PIPE TURNING DOWN	**	PROVIDE A WATER TEMPERATURE LIMITI SYMMONS #5-210-CK (ASSE STD. 1070) WI	NG DEVICE EQU ITH 1/2" CW & 1/2	IAL TO 2" TEMPEREI	C		
	P TRAP		WATER LINES TO FAUCET.					

CAULKLESS DRAIN AND FOLD DOWN BENCH.

PLUMBING NOTES

"A" REPLACE EXISTING PLUMBING FIXTURE WITH NEW FIXTURE AS SHOWN. CONNECT TO EXISTING WASTE AND WATER ROUGHING, ALTER ROUGHING AS REQUIRED TO INSTALL NEW STANDARD AND/OR ADA FIXTURE. SEE ARCHITECTURAL FOR DIMENSIONS.

PRIOR TO BID. VISIT JOB SITE TO VERIFY JOB CONDITIONS AND SCOPE OF WORK. ALLOW FOR REQUIRED MODIFICATIONS TO ACCOMPLISH ALL WORK.

SEE ARCHITECTURAL DEMOLITION PLANS FOR SCOPE OF DEMOLITION WORK REQUIRED. REMOVE EXISTING WASTE, VENT AND WATER PIPING SERVING EXISTING PLUMBING FIXTURES TO BE REMOVED. CAP PIPING ABOVE CEILING, IN WALL AND/OR BELOW FLOOR. MAINTAIN SERVICE TO ALL EXISTING ACTIVE LINES SERVING FIXTURES. DO NOT REMOVE PIPING CONCEALED IN WALLS, IF WALLS ARE NOT REMOVED.


P-1 WATER CLOSET: FLOOR MOUNTED - KOHLER K-3609-0 1.28 GPF, LEFT HAND BRUSHED NICKEL TRIP LEVER, COMPLETE WITH CHURCH "DURA GUARD" MODEL #2155 SSC SEAT AND McGUIRE #166 STOP AND SUPPLY.

P-2 WATER CLOSET: FLOOR MOUNTED - KOHLER K-3609-0 1.28 GPF, RIGHT HAND TRIP LEVER, COMPLETE WITH CHURCH "DURA GUARD" MODEL #2155 SSC SEAT AND McGUIRE #166 STOP AND SUPPLY.


P-3 LAVATORY: COUNTER TOP - KOHLER K-2906-4 ENAMELED CAST IRON COMPLETE, KOHLER K-10272-4A-BN FAUCET W/BRUSHED NICKEL FINISH, K-7715 OUTLET WITH TAILPIECE, McGUIRE #165 STOPS WITH SUPPLIES AND McGUIRE #8872 P-TRAP. PROVIDE ASSE 1070 TEMPERATURE LIMITING DEVICE.


P-4 SHOWER: KOHLER RITE TEMP CONTROL VALVE COMPLETE WITH K-T45106 TRIM AND SHOWERHEAD(INSTALL MIN. 6'8" TO BOTTOM OF SHOWERHEAD), K-8487 HAND HELD SHOWER WITH SLIDE & VACUUM BREAKER AND TWO KOHLER BRUSHED NICKEL GRAB BARS TO PROVIDE ADA COMPLIANCE. PROVIDE KOHLER DIVERTER VALVE WITH K-T45121-4 TRIM. CONTROL VALVE SHALL BE ADJUSTED FOR MAXIMUM 110°F BY FACTORY TRAINED REPRESENTATIVE. PROVIDE WOOD BACKING IN WALL FOR GRAB BARS. ALL TRIM SHALL BE BRUSHED NICKEL. PROVIDE KOHLER (STERLING) 62070125 VIKRELL 63" X 39" BARRIER FREE 4 PIECE SHOWER COMPLETE WITH



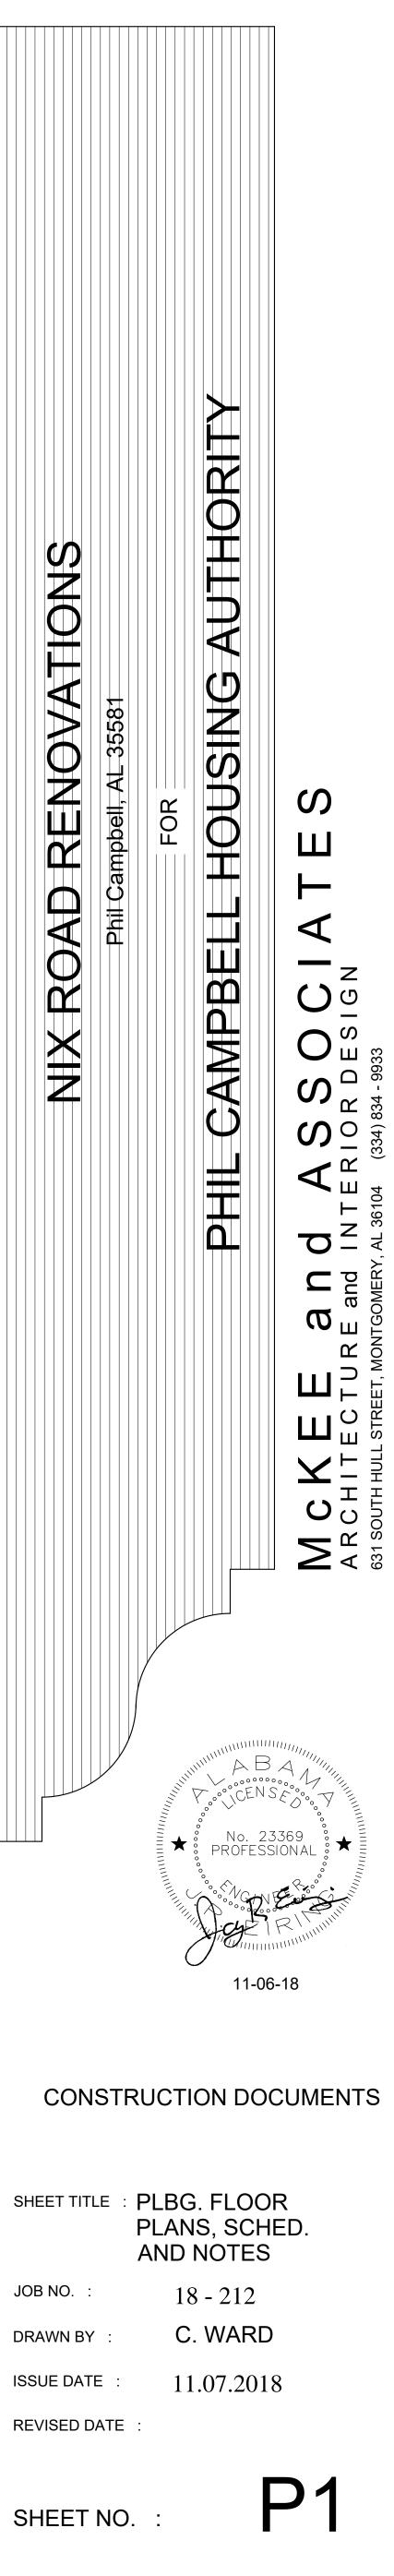

 SURFACE OR PENDANT MOUNTED ROUND FIXTURE JUNCTION BOX EXHAUST FAN WALL OUTLETS G DUPLEX RECEPTACLE - 20 AMP, 125 VOLT, GFI, 2 POLE, 3 WIRE GROUNDED TYPE, NEMA WALL SWITCHES (UNLESS OTHERWISE NOTED, MOUNT 48" A.F.F.) S A.C. TYPE, SINGLE POLE, 20 AMP, 120/277 VOLT DEMOLITION DEVICES TYPICAL DOWNLIGHT TO BE REMOVED TYPICAL WALL MOUNTED DEVICE TO BE REMOVED TYPICAL ELECTRICAL EQUIPMENT TO BE REMOVED 	 CONTRACTOR IS RESI ACCORDINGLY. ELECTRICAL DEVICES SHOWN IN LIGHT PEI ALL DEMOLITION WOR IF EXISTING UTILITIES ORIGINAL CONDITION LEGEND SYMBOLS AR AMOUNT OF DEMOLIT ALL APPLICABLE SYS EXISTING BRANCH WI AND SURVEYS. COO TRENCH, CUT AND R ELECTRICAL PROVISIO CONCEALED CONDUIT ARANDONED CONDUCT
 EXHAUST FAN WALL OUTLETS 	 SHOWN IN LIGHT PEI 3. ALL DEMOLITION WOR IF EXISTING UTILITIES ORIGINAL CONDITION 4. LEGEND SYMBOLS AR AMOUNT OF DEMOLIT ALL APPLICABLE SYS 5. EXISTING BRANCH WI AND SURVEYS. COO 6. TRENCH, CUT AND R ELECTRICAL PROVISIO 7. CONCEALED CONDUIT
 DUPLEX RECEPTACLE - 20 AMP, 125 VOLT, GFI, 2 POLE, 3 WIRE GROUNDED TYPE, NEMA 5-20R. MOUNT 6" ABOVE COUNTER WALL SWITCHES (UNLESS OTHERWISE NOTED, MOUNT 48" A.F.F.) S A.C. TYPE, SINGLE POLE, 20 AMP, 120/277 VOLT DEMOLITION DEVICES TYPICAL DOWNLIGHT TO BE REMOVED TYPICAL WALL MOUNTED DEVICE TO BE REMOVED 	 IF EXISTING UTILITIES ORIGINAL CONDITION 4. LEGEND SYMBOLS AR AMOUNT OF DEMOLIT ALL APPLICABLE SYS 5. EXISTING BRANCH WI AND SURVEYS. COO 6. TRENCH, CUT AND R ELECTRICAL PROVISIO 7. CONCEALED CONDUIT
WALL SWITCHES (UNLESS OTHERWISE NOTED, MOUNT 48" A.F.F.) S A.C. TYPE, SINGLE POLE, 20 AMP, 120/277 VOLT DEMOLITION DEVICES ② TYPICAL DOWNLIGHT TO BE REMOVED ③ TYPICAL WALL MOUNTED DEVICE TO BE REMOVED	AMOUNT OF DEMOLIT ALL APPLICABLE SYS 5. EXISTING BRANCH WI AND SURVEYS. COO 6. TRENCH, CUT AND R ELECTRICAL PROVISIO 7. CONCEALED CONDUIT
S A.C. TYPE, SINGLE POLE, 20 AMP, 120/277 VOLT <u>DEMOLITION DEVICES</u> TYPICAL DOWNLIGHT TO BE REMOVED TYPICAL WALL MOUNTED DEVICE TO BE REMOVED	AND SURVEYS. COO 6. TRENCH, CUT AND R ELECTRICAL PROVISIO 7. CONCEALED CONDUIT
DEMOLITION DEVICES TYPICAL DOWNLIGHT TO BE REMOVED TYPICAL WALL MOUNTED DEVICE TO BE REMOVED	ELECTRICAL PROVISIO 7. CONCEALED CONDUIT
TYPICAL DOWNLIGHT TO BE REMOVED TYPICAL WALL MOUNTED DEVICE TO BE REMOVED	
TYPICAL WALL MOUNTED DEVICE TO BE REMOVED	
•	ABANDONED. CONDU
$\{ \begin{array}{c} & & \\ & & \\ & & \end{array} \}$ TYPICAL ELECTRICAL EQUIPMENT TO BE REMOVED	8. OUTLET BOXES THAT WITH GROUT, PATCH
	9. EXISTING JUNCTION
S TYPICAL SWITCH TO BE REMOVED	MADE WHEN REQUIR
矩列 TYPICAL EXHAUST FAN TO BE REMOVED	10. EXISTING PANELBOAR
EX:RL EXISTING EQUIPMENT TO BE REMOVED AND RELOCATED EX:RD EXISTING EQUIPMENT THAT HAS BEEN RELOCATED EX:RR EXISTING EQUIPMENT TO BE REMOVED AND REPLACED	CIRCUIT BREAKERS S AND TYPE AS EXIST PROPERLY MEET THE
EX:RW EXISTING EQUIPMENT TO BE REWORKED	11. WHEN EXISTING DEV SERVING SUCH ITEM SHALL REROUTE, EX
	OPERATING SYSTEMS
TYPICAL LIGHTS TO REMAIN	BRANCH CIRCUITIN
\circ	
😂= TYPICAL WALL MOUNTED DEVICE TO BE REMAIN	
ETTER TYPICAL ELECTRIACL EQUIPMENT TO BE REMAIN, SEE POWER RISER.	RUN CONCEALED IN HOMERUN TO PANEL

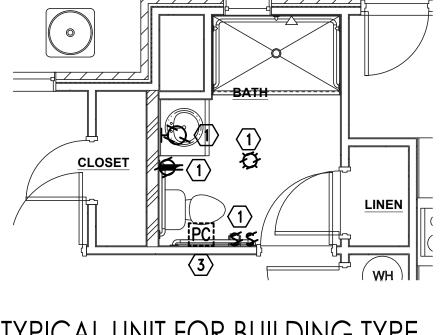

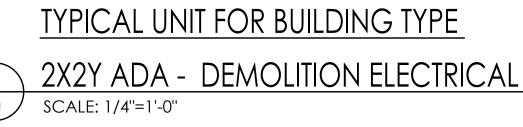

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(4) E-1

LITION NOTES:

PONSIBLE FOR VERIFYING ALL EXISTING CONDITIONS PRIOR TO BID AND BIDDING

SHOWN IN BOLD INDICATES NEW WORK. ELECTRICAL DEVICES THAT ARE IN AND DASHED INDICATE EXISTING DEVICES TO REMAIN.

DRK SHALL BE PERFORMED WITH CARE NOT TO DISTURB THE OTHER EXISTING UTILITIES. ARE DAMAGED BY THE CONTRACTOR, THE EXISTING UTILITIES ARE TO FIXED TO IT'S WITHOUT DELAY, BY AND AT THE EXPENSE OF THE CONTRACTOR.

RE TYPICAL AND LOCATIONS ARE APPROXIMATE AND ARE NOT INTENDED TO LIMIT THE TION WORK. COORDINATE WITH EXISTING CONDITIONS AND THESE NOTES AND REMOVE STEMS AND COMPONENTS CONFLICTING WITH FINISHED DESIGN INTENT.

'IRING AND DEVICES SHOWN IS DIAGRAMMATICAL ONLY BASED ON EXISTING DRAWINGS ORDINATE WITH ACTUAL EXISTING CONDITIONS FOR EXACT LOCATIONS.

REMOVE EXISTING SURFACES AS REQUIRED FOR THE INSTALLATION OF ALL NEW

THAT CANNOT BE REMOVED DUE TO INACCESSIBILITY MAY BE CTORS SHALL BE REMOVED AND CONDUIT CUT FLUSH WITH SURFACE.

CANNOT BE REMOVED DUE TO FLUSH MOUNTING IN PARTITIONS SHALL BE FILLED IED AND FINISHED FLUSH TO MATCH EXISTING WALL SURFACE.

BOXES MAY BE USED AS NOTED IF OF THE PROPER SIZE. MODIFICATIONS SHALL BE RED SUCH AS PROVIDING EXTENSION RINGS, LOCKNUTS, BUSHINGS, ETC.

ARDS SHALL BE UTILIZED TO FACILITATE THE WORK AS SHOWN ON THE DRAWINGS. NEW SHALL BE OF THE SAME MANUFACTURER (WHENEVER POSSIBLE), FRAME SIZE, AIC RATING FING. CONTRACTOR SHALL PROVIDE ALL ADDITIONAL MATERIALS FOR PANELBOARDS TO INTENT OF THE DRAWINGS.

VICES, SWITCHES, EQUIPMENT ETC., ARE NOTED TO BE REMOVED AND THE CIRCUIT(S) S SERVES OTHER ITEMS OR DEVICES WHICH ARE TO BE MAINTAINED, THE CONTRACTOR TEND, MODIFY, ETC., EXISTING CIRCUITS AS REQUIRED TO MAINTAIN COMPLETE AND

SPONSIBLE FOR THE DISPOSAL OF ALL ITEMS TO BE DEMOLISHED.

LA-1

NDER FLOOR OR IN GROUND

CEILING OR WALLS


ANY CIRCUIT WITHOUT FURTHER IDENTIFICATION INDICATES UND - 3/4" C; $- \frac{11}{2}$ GROUND - 3/4" C; 1 #12 GROUND - 3/4" C; ETC. AS PER NEC. LETTERS AND NUMERALS INDÍCATE PÁNEL AND CIRCUIT NUMBER.

HOMERUN TO PANEL. ANY CIRCUIT WITHOUT FURTHER IDENTIFICATION INDICATES NUMERALS INDÏCATE PÄNEL AND CIRCUIT NUMBER.

HOMERUN TO PANEL. ANY CIRCUIT WITHOUT FURTHER IDENTIFICATION INDICATES -8 2 #8, 1 #10 GROUND - 1" C; -8 #4, 1 #10 GROUND - 1" C; -8 + 4 = 4, 1 = 10 GROUND -11/4" C; ETC. AS PER NEC. LETTERS AND NUMERALS INDICATE PANEL AND CIRCUIT NUMBER.

WHERE A NUMBER IS SHOWN NEXT TO OR ON THE CIRCUIT OR HOMERUN, THE NUMBER 6 INDICATES CONDUCTOR SIZE OTHER THAN #12 - NUMBER #6 CONDUCTORS INDICATED. PROVIDE GROUND SIZED PER NEC TABLE 250 FOR MAX AMPACITY OF CONDUCTOR SIZE AS SHOWN. SIZE CONDUIT PER NEC ANNEX C. ∼ LIQUID-TIGHT FLEXIBLE CONDUIT CONNECTION

------- SURFACE MOUNTED CONDUIT: RUN PARALLEL OR PERPENDICULAR TO BUILDING LINES EMPTY CONDUIT WITH PULLWIRE, RUN CONCEALED IN CEILING OR WALLS

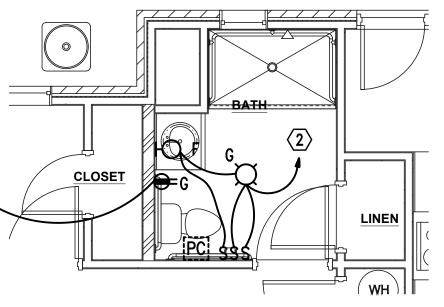

TYPICAL UNIT FOR BUILDING TYPE

2X2Y ADA -	NEW ELECTRICAL
SCALE: 1/4"=1'-0"	

MISCEL	LANEOUS
Α	AMPERE
ÂDA	AMERICANS WITH DISABILITIES ACT
AFF	ABOVE FINISH FLOOR
AIC	AMPERE INTERRUPTING CAPACITY
ATS	AUTOMATIC TRANSFER SWITCH
C	CONDUIT
CL	CENTER LINE
CWP	COLD WATER PIPE
EM	EMERGENCY
EMT	ELECTRIC METALLIC TUBING
GFI	GROUND FAULT INTERRUPTER
	GROUND FAULT INTERROFTER GALVANIZED RIGID METAL CONDUIT
GRC	GROUND
GRD	MAIN CIRCUIT BREAKER
MCB	
MCC	MOTOR CONTROL CENTER MAIN LUGS ONLY
MLO MT	
	MOUNT NEUTRAL
N	NOT IN CONTRACT
NIC	
NEC	NATIONAL ELECTRICAL CODE
NEMA	NATIONAL ELECTRICAL MANUFACTURER'S ASSOC.
NFPA	NATIONAL FIRE PROTECTION ASSOCIATION
NL	NIGHT LIGHT
NTS	NOT TO SCALE
P	POLE
PF	POWER FACTOR
PH	PHASE
PNL	
PVC	PVC (POLYVINYL CHLORIDE) CONDUIT
SLD	SINGLE LINE DIAGRAM
TBB	TELEPHONE BACKBOARD
TVSS	TRANSIENT VOLTAGE SURGE SUPPRESSORS
UL	UNDERWRITER'S LABORATORY
U.N.O.	
V	VOLTAGE
W	WIRE
WP	WEATHERPROOF
#	NUMBER
3R	NEMA 3R WEATHERPROOF ENCLOSURE
4X	NEMA 4X WEATHERPROOF/CORROSION ENCLOSURE

(PE:	MANUFACTURER NUMBER AND EQUALS:	VOLTAGE:	MOUNTING:	LAMP TYPE:	LAMP QUANTITY:	DESCRIPTION:	
G	PROGRESS NO. PV008-09STRWB OR PRIOR APPROVED EQUALS BY HUBBELL, LITHONIA, OR COOPER	120	RECESSED	FLOUR.	(2) - 13WATT	COMBO BATHROOM LIGHT & EXHAUST FAN. WITH BRUSHED NICKEL FINISH. PROVIDE SEPARATE SWITCHING FOR LIGHT AND EXHAUST FAN.	
F	PROGRESS NO. P3110-30 OR PRIOR APPROVED EQUAL BY HUBBELL, LITHONIA, OR COOPER	120	WALL	LED	(4) SCREW IN BULBS	CHANNEL GLASS 4 LIGHT 24 INCH WHITE BATH VANITY WALL LIGHT. PROVIDE WITH FOUR LED SCREW IN LAMPS 2700K TEMPERATURE AND 800 LUMENS.	
	NOTES: 1. ARCHITECT RESERVES THE RIGHT TO SELECT ALL COLORS OR MAKE CUSTOM COLOR DURIN 2. COORDINATE MOUNTING OF ALL LUMINAIRES WITH ARCHITECTURAL ELEVATIONS PRIOR TO I 3. ALL LUMINAIRES SHALL INCLUDE LAMPS. 4. PROVIDE RAPID START TYPE BALLAST. 6. FOR WARRANTY AND LONG TERM SUPPORT FOR OWNER, ALL LIGHTING FIXTURES SHALL BE LOCATED IN THE STATE OF ALABAMA. SUBMITTALS RECEIVED THAT DO NOT COMPLY WITH TH SHALL BE RESPONSIABLE FOR ANY DELAYS CAUSED BY NON COMPLIANCE WITH THIS REQUIF	NSTALLATION PURCHASED THROUGH MANUFACTUR IS REQUIREMENT WILL BE REJECTED	RER REPRESENTAT		AL CONTRACTOR		

LUMINAIRE NOTES:

1. ALL LUMINAIRES AND INSTALLATION SHALL BE IN ACCORDANCE WITH NEC, NFPA 4. ALL FLUORESCENT LUMINARIES SHALL BE PROVIDED WITH 3500K COLOR AND LOCAL CODES. ALL LUMINAIRES SHALL BE UL LISTED AND INSTALLED IN ACCORDANCE TEMPERATURE LAMPS, UNLESS NOTED OTHERWISE. WITH THE UL LISTING. 5. ARCHITECT RESERVES THE RIGHT TO SELECT ALL COLORS FOR LUMINAIRES, POLES, 2. LUMINAIRES SHALL BE FURNISHED COMPLETE WITH THE PROPER LAMP BASE OR MOUNTING ACCESSORIES, ETC. DURING SHOP DRAWING REVIEW. PIN RECEPTORS, WIRING COMPONENTS, LAMPS, SUPPORTING FRAMES AND DEVICES, ETC., FOR A COMPLETE INSTALLATION. 6. COORDINATE LUMINAIRE MOUNTING WITH ARCHITECTURAL ELEVATIONS PRIOR TO INSTALLATION.

3. ALL LUMINAIRE DEVICES, COMPONENTS, FITTINGS, SUPPORTS, ETC., SHALL BE COORDINATED TO PROVIDE A COMPLETE UL LISTED INSTALLATION.

SHEET NOTES:

- $\langle 1 \rangle$ CONTRACTOR SHALL REMOVE EXISTING DEVICE. EXISTING CIRCUIT SHALL REMAIN FOR **RECONNECTION OF NEW DEVICES.**
- $\langle 2 \rangle$ contractor shall connect new device to existing circuit previously serving this AREA. CONTRACTOR SHALL EXTEND EXISTING CIRCUIT AS REQUIRED.
- $\langle 3 \rangle$ EXISTING ADA PULL CORD SHALL REMAIN AND BE RELOCATED AS SHOWN EXTEND EXISTING PULL CORD CABLING AS REQUIRED.


GENERAL ELECTRICAL NOTES:

1. THE SERVICE VOLTAGE TO THE FACILITY IS EXISTING.

- 2. INSTALLATION SHALL COMPLY WITH THE NATIONAL ELECTRICAL CODE, STATE AND LOCAL CODES, AND MANUFACTURER'S RECOMMENDATIONS.
- **3. MAINTAIN ALL CLEARANCES FOR ELECTRICAL EQUIPMENT PER THE NEC.**
- 4. COORDINATE ROUGH-IN OF ALL ELECTRICAL DEVICES WITH ARCHITECTURAL FLOOR PLANS, ELEVATIONS AND MILLWORK SHOP DRAWINGS PRIOR TO ROUGH-IN. AVOID ALL BACKSPLASHES AT COUNTERS.
- 5. ALL DIMENSIONS INDICATED IN THESE DOCUMENTS ARE FOR REFERENCE AND COORDINATION PURPOSES ONLY. THE CONTRACTOR IS RESPONSIBLE FOR VERIFYING ALL DIMENSIONS IN THE FIELD, AND COORDINATING WORK WITH OTHER TRADES TO AVOID CONFLICTS.
- 6. VERIFY ALL DOOR SWINGS WITH ARCHITECTURAL BEFORE ROUGH-IN OF LIGHT SWITCHES TO ENSURE PROPER SWITCH LOCATION.
- 7. THE LOCATION OF OUTLETS, FIXTURES, AND EQUIPMENT SHOWN ON THE DRAWINGS ARE APPROXIMATE, OFFSET AS NEEDED OR AS REQUESTED BY THE OWNER. THE OWNER SHALL HAVE THE RIGHT TO RELOCATE ANY OUTLETS OR FIXTURES BEFORE THEY ARE INSTALLED WITHOUT ANY ADDITIONAL COST.
- 8. ALL CONDUIT SIZE SHALL BE A MINIMUM 3/4" UNLESS NOTED OTHERWISE IN THE DRAWINGS OR SPECIFICATIONS.
- 9. ALL ELECTRICAL RACEWAYS AND CABLING SHALL BE INSTALLED CONCEALED WITHIN THE CONFINES OF THE BUILDING FOUNDATIONS EXCEPT THOSE SPECIFICALLY SERVING LOADS OR EQUIPMENT EXTERIOR OF THE BUILDING. ALL SUCH RACEWAYS SHALL BE A MINIMUM 18" INSIDE FOUNDATIONS AND POWER AND COMMUNICATIONS RACEWAYS SHALL BE SEPARATED BY A MINIMUM 18".
- 10. ALL CONDUITS INSTALLED UNDERFLOOR SHALL BE ROUTED UNDER STRUCTURAL CONCRETE FLOOR SLABS. CONTRACTOR SHALL NOT INSTALL CONDUITS IN CONCRETE FLOORING WITHOUT THE EXPRESS WRITTEN PERMISSION OF THE STRUCTURAL ENGINEER. CONDUITS PENETRATING THRU CONCRETE FLOORS SHALL ADHERE TO THE ELECTRICAL SPECIFICATIONS AND RECOMMENDATIONS OF THE STRUCTURAL ENGINEER.
- 11. ALL RACEWAYS INSTALLED ON EXTERIOR OF THE BUILDING, INCLUDING CONDUIT UNDER CANOPIES, SHALL BE GRC. EMT WILL NOT BE ACCEPTED.
- 12. ALL RACEWAYS SHALL BE SUPPORTED PER NEC AND AT LEAST EVERY 10' AND WITHIN 3' OF EVERY JUNCTION BOX. RACEWAYS SUPPORTED ON BOTTOM OF SECONDARY CEILING SHALL BE SUPPORTED FROM THE STRUCTURE NOT FROM THE GYPBOARD CEILING.
- 13. ALL EMPTY WALL MOUNTED JUNCTION BOXES SHALL BE PROVIDED WITH A WALL BLANK AND ALL EMPTY RACEWAYS SHALL BE PROVIDED WITH A PULL WIRES.
- 14. PROVIDE ALL CONDUIT STUBS WITH A PROTECTIVE COLLAR.
- 15. INSURE THAT ALL PENETRATIONS OF FIRE WALLS AND DECKS ARE PROPERLY SEALED PER INTERNATIONAL BUILDING CODE 712 AND WITH AN UL APPROVED DEVICE OR FIRE CAULK. REFER TO ARCHITECTURAL PLANS FOR THE LOCATIONS OF RATED FIRE WALLS AND UL ASSEMBLY LOCATIONS AND TYPES AND BID ACCORDINGLY.
- 16. PROVIDE A CONDUIT EXPANSION JOINTS WITH BONDING JUMPER IN ALL CONDUITS CROSSING AN EXPANSION JOINT. REFER TO ARCHITECTURAL DRAWINGS FOR EXPANSION JOINT LOCATIONS.
- 17. ALL UNDERGROUND CONDUITS RUNS ENTERING THE BUILDING SHALL BE SEALED TO PREVENT THE ENTRANCE OF MOISTURF 18. ALL FLEXIBLE CONDUITS ON THE EXTERIOR, IN WET LOCATIONS OR ANY MECHANICAL ROOM SHALL BE LIQUID TIGHT
- WITH SUITABLE FITTINGS. 19. THE CONTRACTOR SHALL BE RESPONSIBLE FOR SEALING AROUND DEVICES, PENETRATIONS, OUTLETS, AND CONDUITS
- THAT PENETRATE THE WALLS ABOVE THE CEILING TO MAINTAIN SOUNDPROOFING. CONTRACTOR SHALL VERIFY THAT THE OPENINGS SIZES ARE LESS THAN 1/2" ON ALL SIDES OF THE PENETRATIONS. ALL OPENINGS IN EXCESS OF 1/2" SHALL BE CAULKED/SEALED WITH SHEET ROCK MUD. THE DRYWALL CONTRACTOR SHALL BE RESPONSIBLE FOR SEALING PENETRATIONS IN PLACE WHEN THE SHEETROCK ARE INSTALLED. PENETRATIONS MADE AFTER THE DRYWALL CONTRACTOR HAS FINISHED IN AN AREA SHALL BE SEALED BY THE CONTRACTOR MAKING THE PENETRATION.
- 20. PLANNED INTERRUPTIONS OF UTILITY SERVICE TO ANY EXISTING FACILITY OR AREAS WITHIN ANY FACILITY AFFECTED BY THIS CONTRACT, SHALL BE CAREFULLY PLANNED AND COORDINATED IN ADVANCE OF THE REQUESTED INTERRUPTION. THE CONTRACTOR SHALL NOT INTERRUPT SERVICES UNTIL SPECIFIED APPROVAL HAS BEEN GRANTED. THE REQUEST SHALL INDICATE SERVICES AND AREAS TO BE AFFECTED, DATE AND TIME OF INTERRUPTION AND DURATION OF OUTAGE. REQUEST FOR INTERRUPTION OF SERVICE WILL NOT BE APPROVED UNTIL ALL EQUIPMENT AND MATERIAL REQUIRED FOR THE COMPLETION OF THAT PARTICULAR PHASE OF WORK ARE ON THE JOB SITE. CONTRACTOR IS RESPONSIBLE FOR ALL OVERTIME, HOLIDAY, AND WEEKEND PAY TO THEIR EMPLOYEES TO DO THIS WORK DURING SCHEDULED NON-NORMAL WORK HOURS.
- 21. ALL JUNCTION BOX COVERS ABOVE THE CEILING SHALL BE CLEARLY MARKED WITH WHICH CIRCUITS OR ELECTRICAL SYSTEM THEY CONTAIN.

1/4'' = 1'-08 FT. 0 4 **GRAPHIC SCALE** Gunn & Associates, P.C. Consulting Engineers 500 Southland Drive Suite 250 3102 Highway 14 Millbrook, AL 36054 Hoover, AL 35226 Tel: 334.285.1273 GA#16-134

CONSTRUCTION DOCUMENTS SHEET TITLE : FLOOR PLAN -LIGHTING JOB NO. 18-212 J. TILLERY DRAWN BY 11.07.2018 ISSUE DATE REVISED DATE

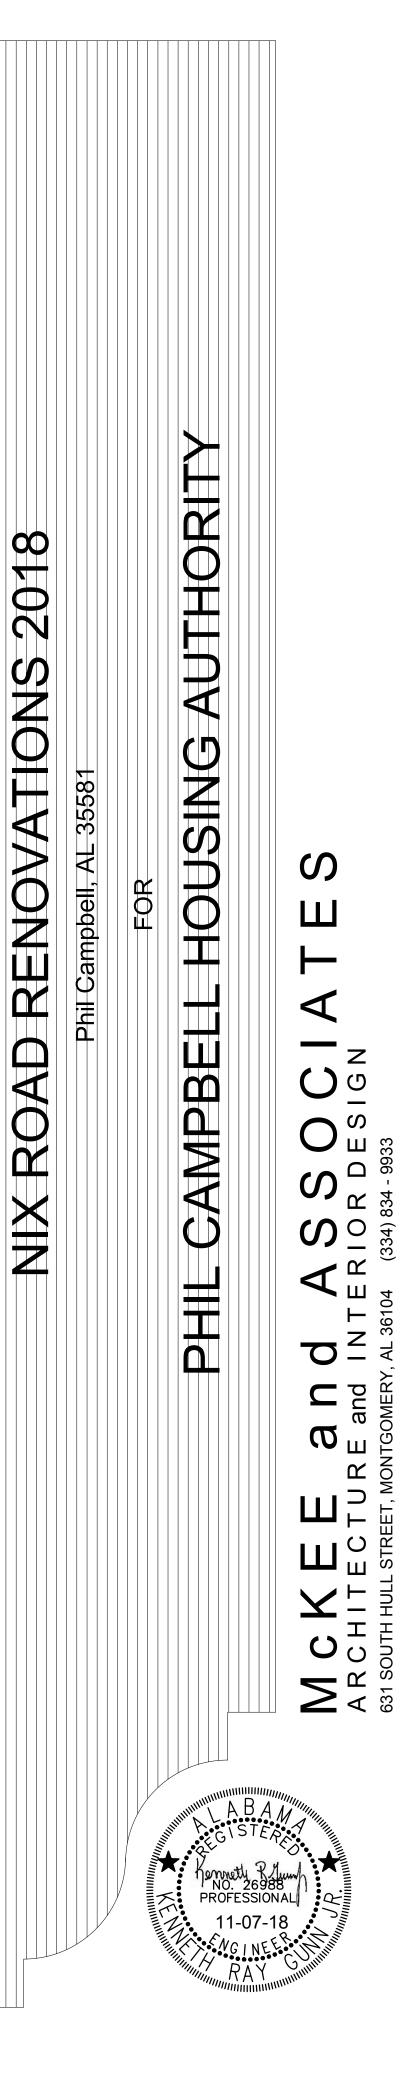

SHEET NO.

