

TLC New Construction SITE PLAN OPTIONS


| Address | Parcel ID | Lot Size (Acre(s)) | Site Plan | Total Units |
|--------------------|---------------|-----------------------|---------------------|----------------|
| 2399 Eddie Road | 111680 E0080 | 0.14 | PLAN A or B | 1 |
| 919 Griffin Street | 212635 A0270 | 0.34 | 1 or 2 Duplexes | 2-4 |
| 317 Ridge Road | 411352 B0010 | 0.34 | 1 Unit, or 1 Duplex | 1-2 |
| 407 Shoreline | 311880 H0120 | 0.27 | 1 Unit, or 1 Duplex | 1-2 |
| Grimes Lane | 2121510342120 | 0.29 | 1 Duplex | 2 |

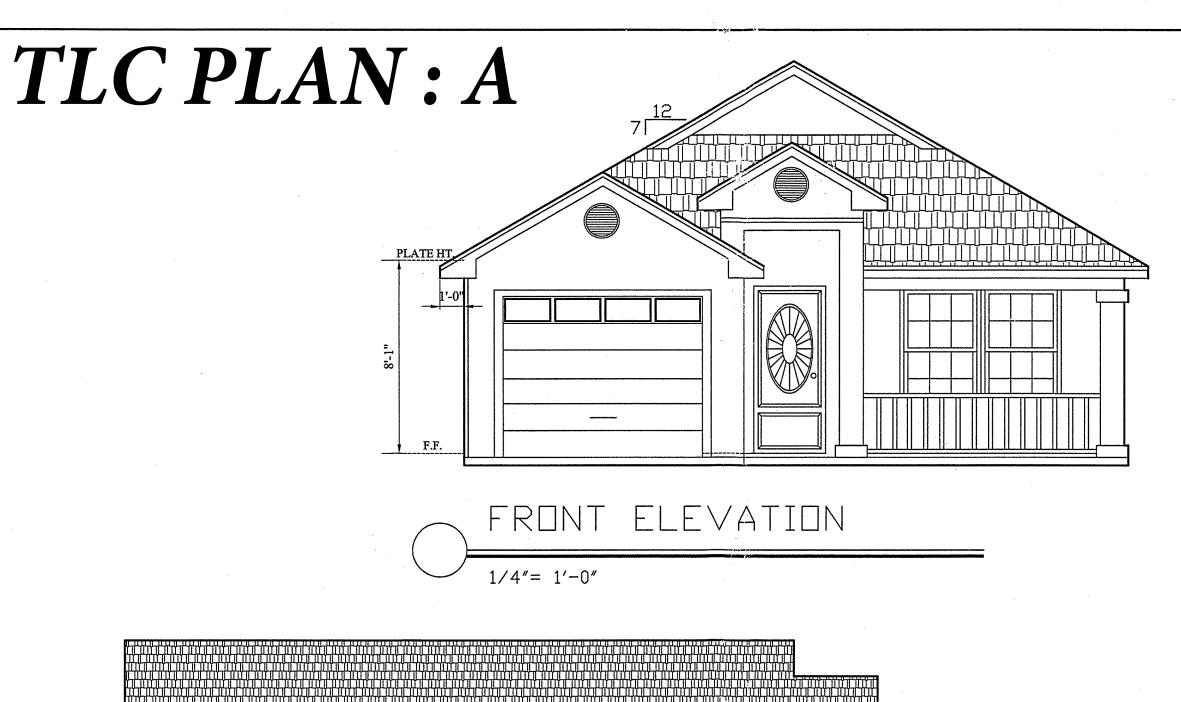

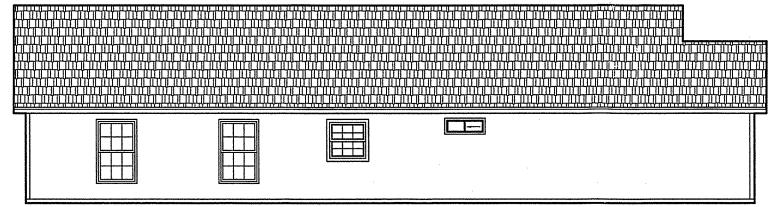

SIDE ELEVATION

1/8"= 1'-0"

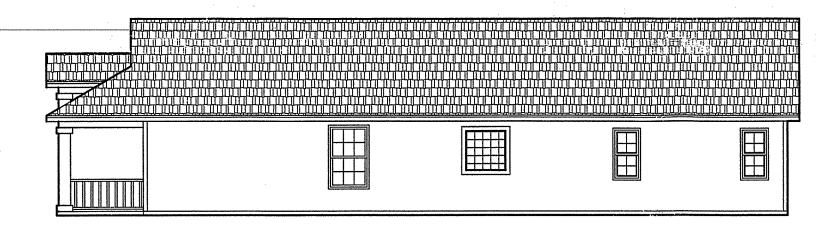

SIDE ELEVATION

1/8"= 1'-0"



REAR ELEVATION

1/8"= 1'-0"

| WINDOW SCHEI 08-23-04 | DULE | ALEX MODEL 2A DRY CREEK RUN | | |
|--------------------------|-----------|--------------------------------|--------------------|--|
| NAME | NOM. SIZE | QTY. | STYLE | |
| 3050 SH | 36" X60" | 7 | SINGLE HUNG | |
| 2040 SH | 24" X 60" | 2 | SINGLE HUNG | |
| 3030 SH | 36" X36" | 1 | SINGLE HUNG | |
| 3010 HS | 36" X 12" | 1 | HORIZONTAL SLIDER | |
| 3434 GLASS BLK | 40" X 40" | 1 | GLASS BLOCK INSERT | |

| DOOR SCHEDULE | | | ALEX MODEL | | |
|---------------|-----------|------|--|--------------|--|
| 08-23-04 | | | 2A DRY CREEK RUN | | |
| NAME | NOM. SIZE | QTY. | STYLE | SWING | |
| 3068 ENTRY | 36" X 80" | 1 | ENTRY DOOR | LH IS | |
| 2868 XT. | 32" X 80" | 1 | EXTERIOR 6 PANEL | RH OS | |
| 6068 15 LITE | 72" X 80" | 1 | EXTERIOR 15 LITE DOUBLE HINGED FRENCH | os | |
| 2068 | 24" X 80" | 1 | INTERIOR DOOR | 1 RH | |
| 2868 | 32" X 80" | 5 | INTERIOR DOOR | 3 RH 2 LH | |
| 4068 BIF. | 48" X 80" | 2 | INTERIOR BIFOLD | NA | |
| 1668 BIF. | 18" X 80" | 1 | INTERIOR BIFOLD | NA | |

DOORS AND WINDOWS

OTY OF TALLAHASSET


REV SON

DRAWN BY: W. RICHARDSON

DATE


09-18-04


Premier Construction Company, Inc.

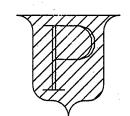


ALEX MODEL

2A DRY CREEK RUN

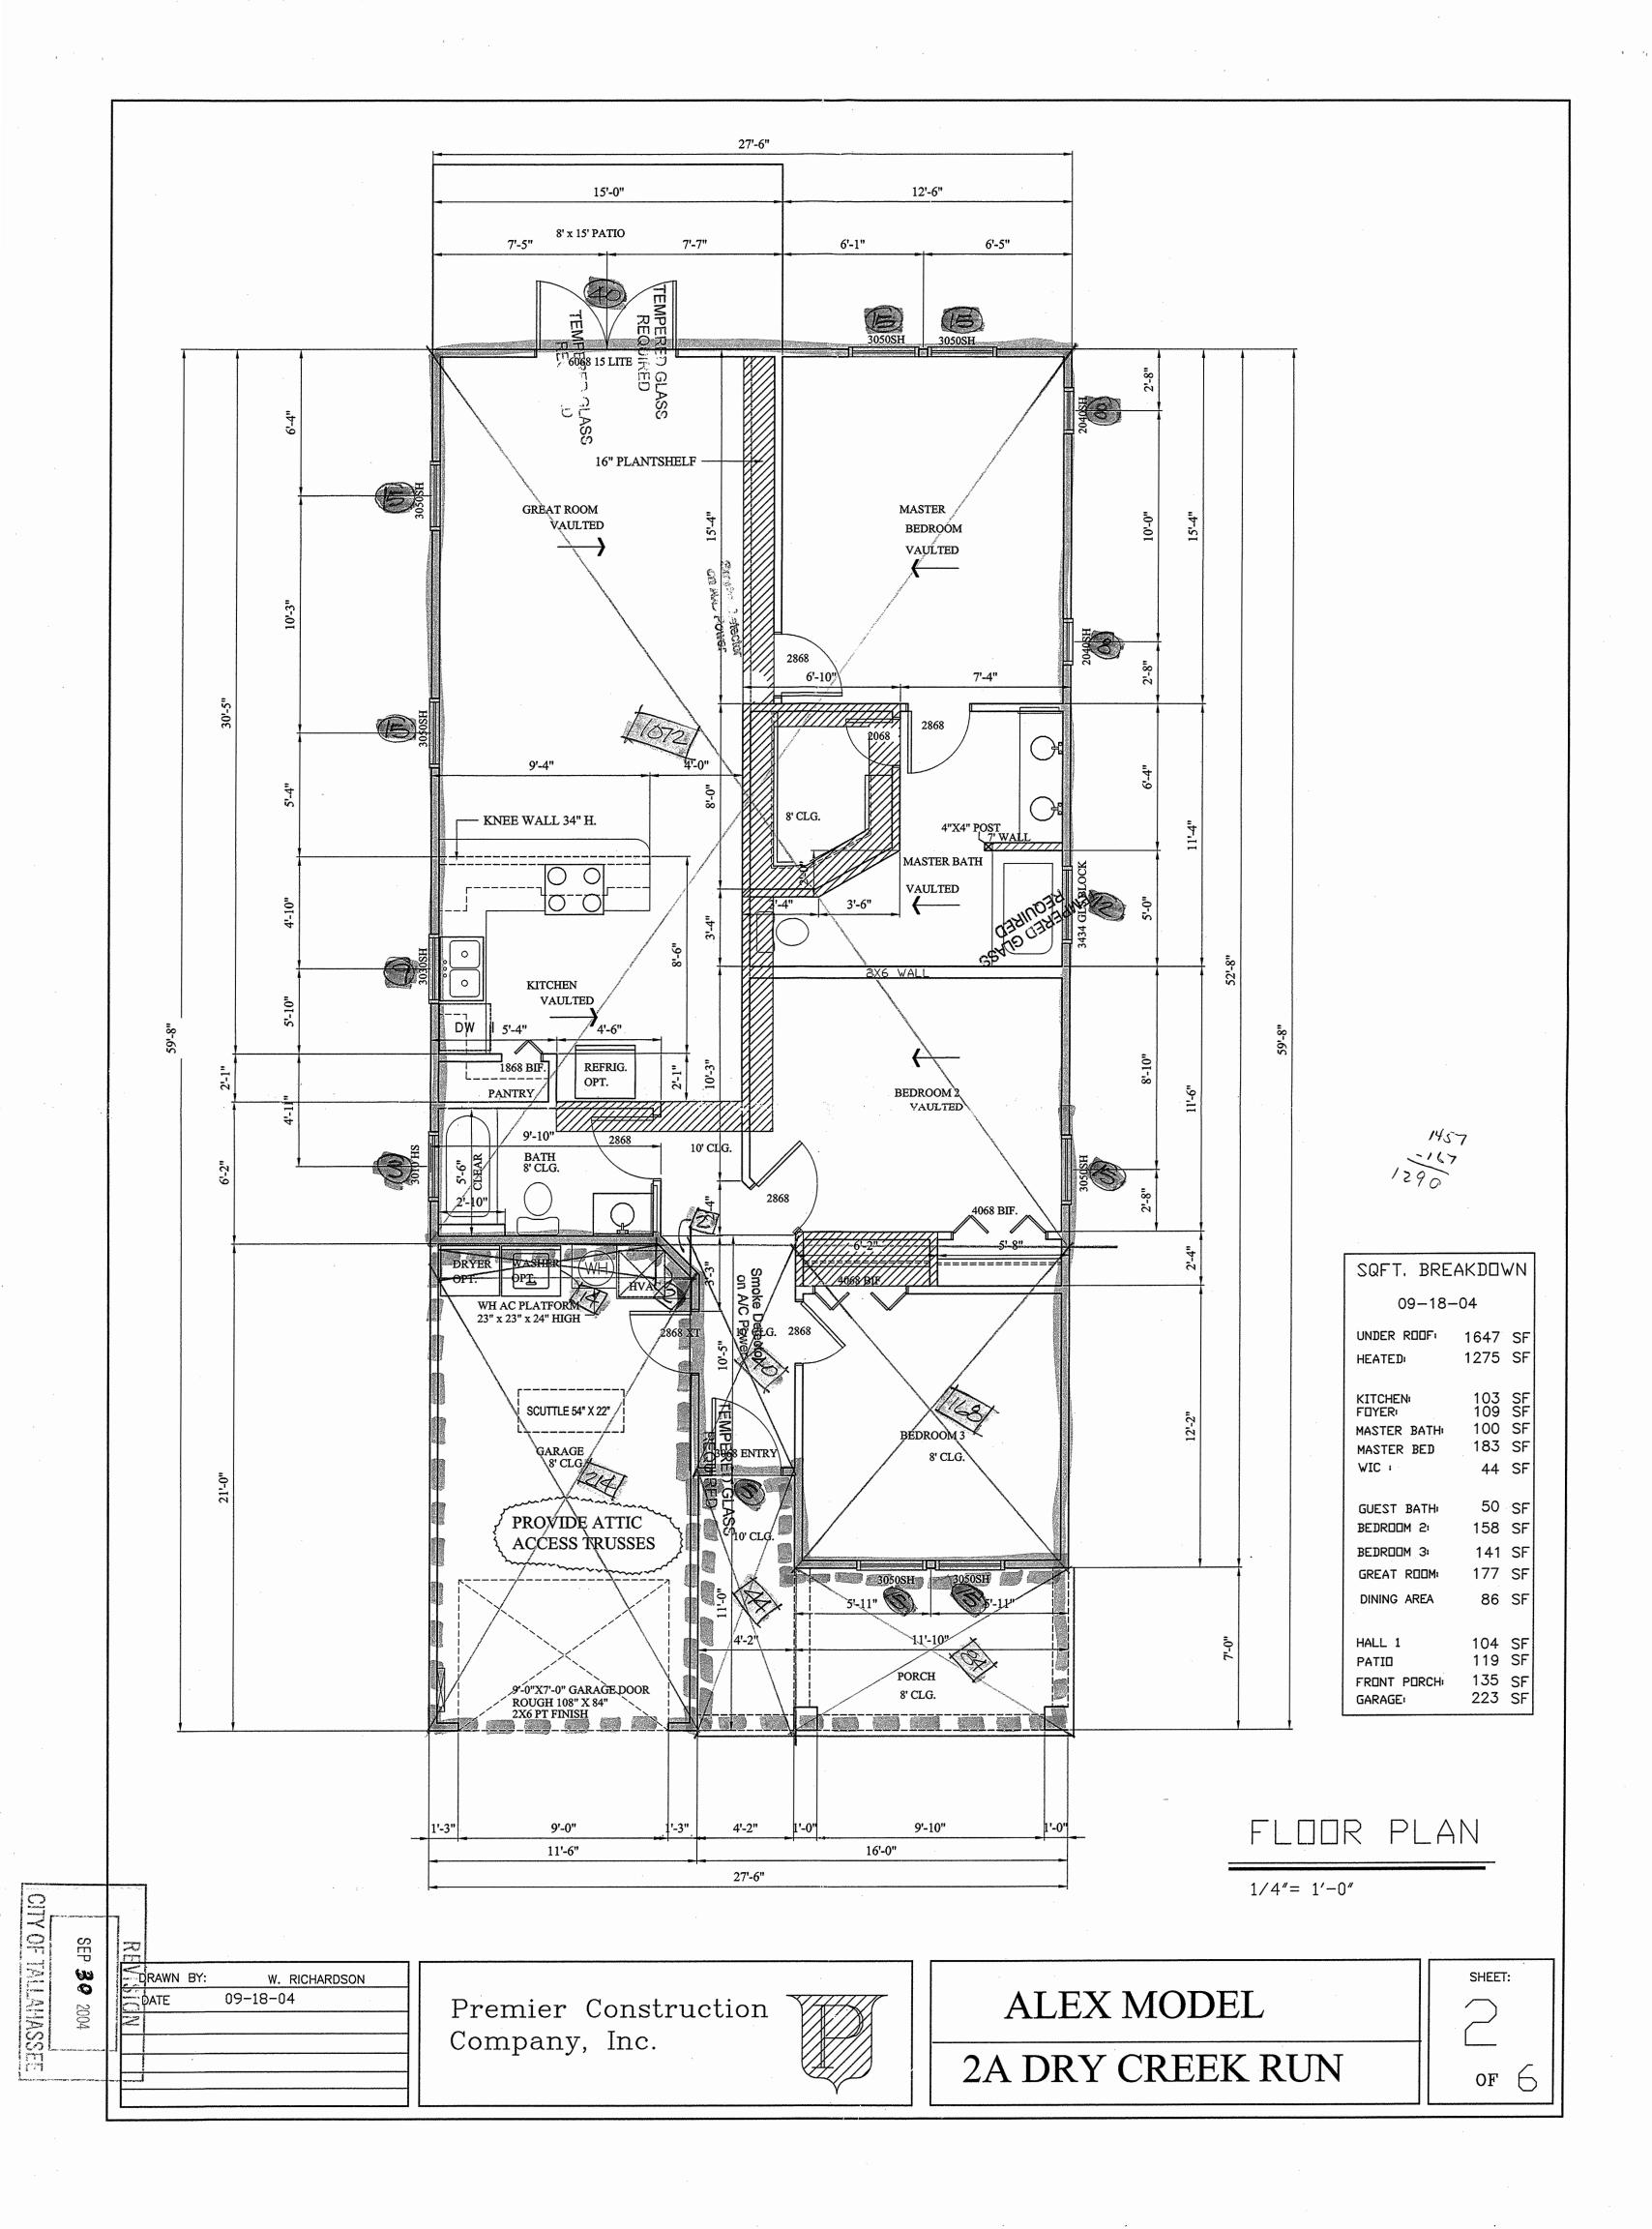

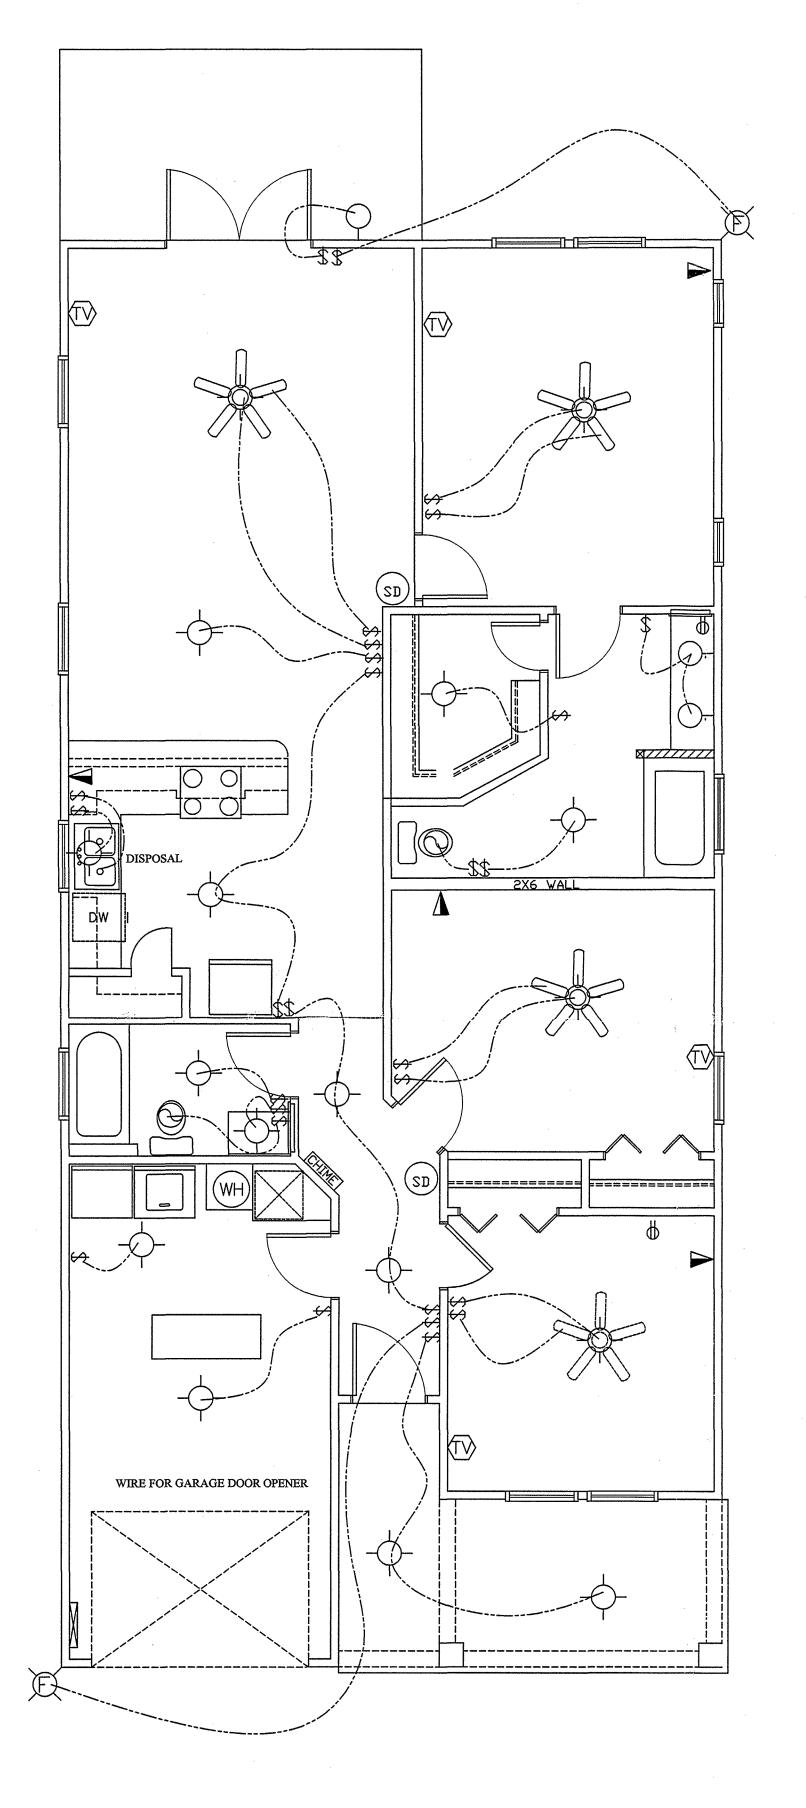

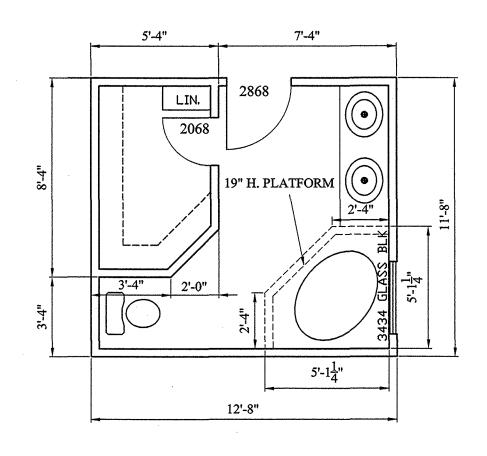

OPTIONAL MASTER BATH

.25″= 1′

CEILING ROD LENGHTHS

9' CEILING = 12"

10' CEILING = 18"

11' CEILING = 24"

12' CEILING = 36"

NOTE: RECEPTACLES TO BE PLACE PER LOCAL BLDG. CODES. SEE PLAN FOR HOMEOWNER PLACED RECLOCATIONS.

| LIGHTING SCHEDULE 08-25-04 | ALEX MODEL 2A DRY CREEK RUN |
|-------------------------------|--|
| ROOM | DESCRIPTION |
| GREAT ROOM: | CEILING FAN/ LIGHT COMBO (18" DROP ROD) |
| KITCHEN: | (2) CEILING MOUNT |
| FOYER: | (1) CEILING LIGHT |
| MASTER BATH: | (1) CEILING MOUNT (2) VANITY LIGHT |
| WIC | (1) CEILING MOUNT |
| MASTER BEDROOM: | CEILING FAN/ LIGHT COMBO (18" DROP ROD) |
| GUEST BATH | (2) CEILING MOUNT (1) VANITY LIGHT |
| BEDROOM 2: | CEILING FAN/ LIGHT COMBO (18" DROP ROD) |
| BEDROOM3: | CEILING FAN/ LIGHT COMBO (NO DROP ROD) |
| DINING AREA | (1) CEILING MOUNT |
| HALLWAY: | (2) CEILING MOUNT |
| GARAGE: | (1) CEILING MOUNT |
| FRONT PORCH: | (2) CEILING MOUNT |
| EXTERIOR | (1) FLOOD LIGHTS (DOUBLE) (1) CEILING MOUNT ENTRY LIGHT (1) WALL LITE (REAR ENTRY) |

ELECTRICAL PLAN

1/4"= 1'-0"

DRAWN BY: W. RICHARDSON

DATE

09-18-04


SEP 200

OCT | SEP 200

O


1 , 1


Premier Construction Company, Inc.

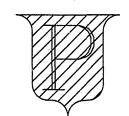

ALEX MODEL


2A DRY CREEK RUN

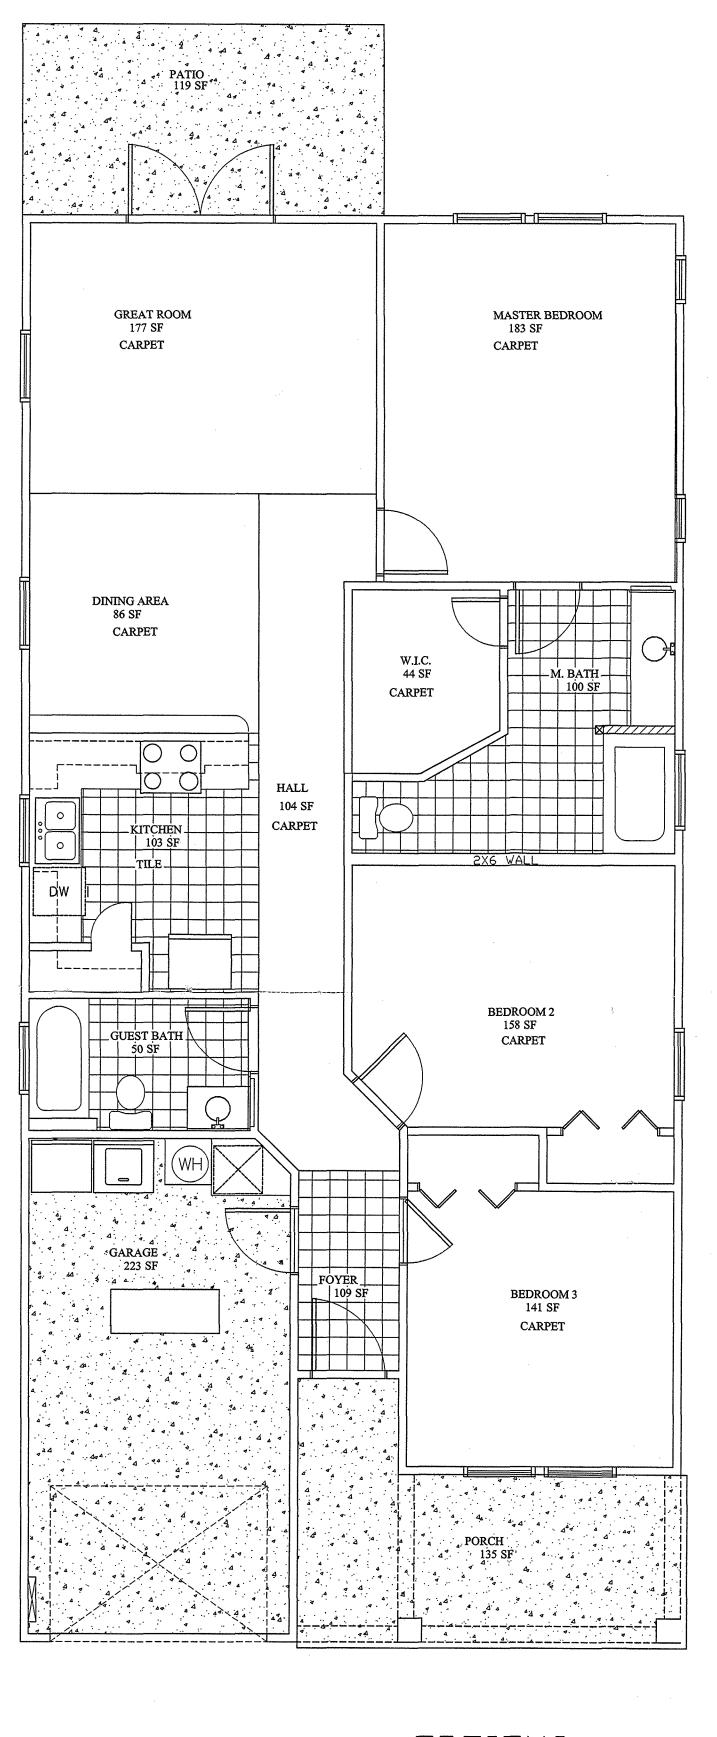

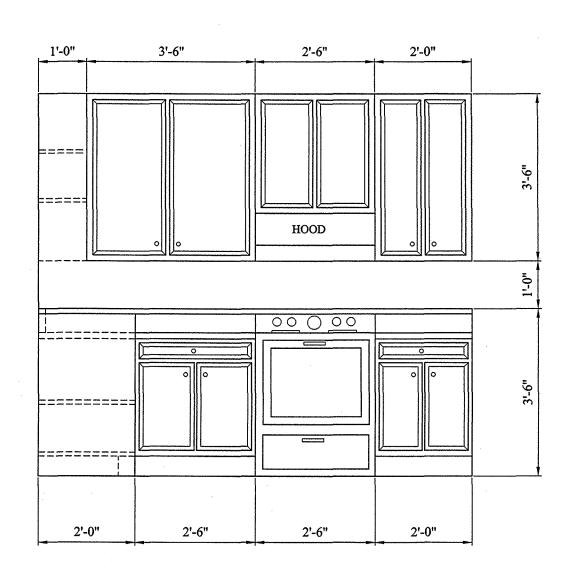

CABINET ELEVATION


1/2"= 1'-0"

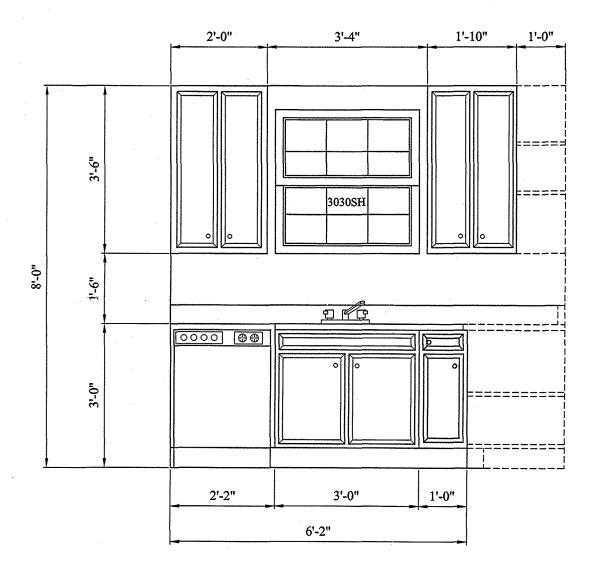

CABINET ELEVATION

1/2"= 1'-0"

OPTIONS

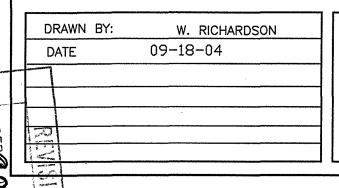



Premier Construction Company, Inc.




ALEX MODEL

2A DRY CREEK RUN

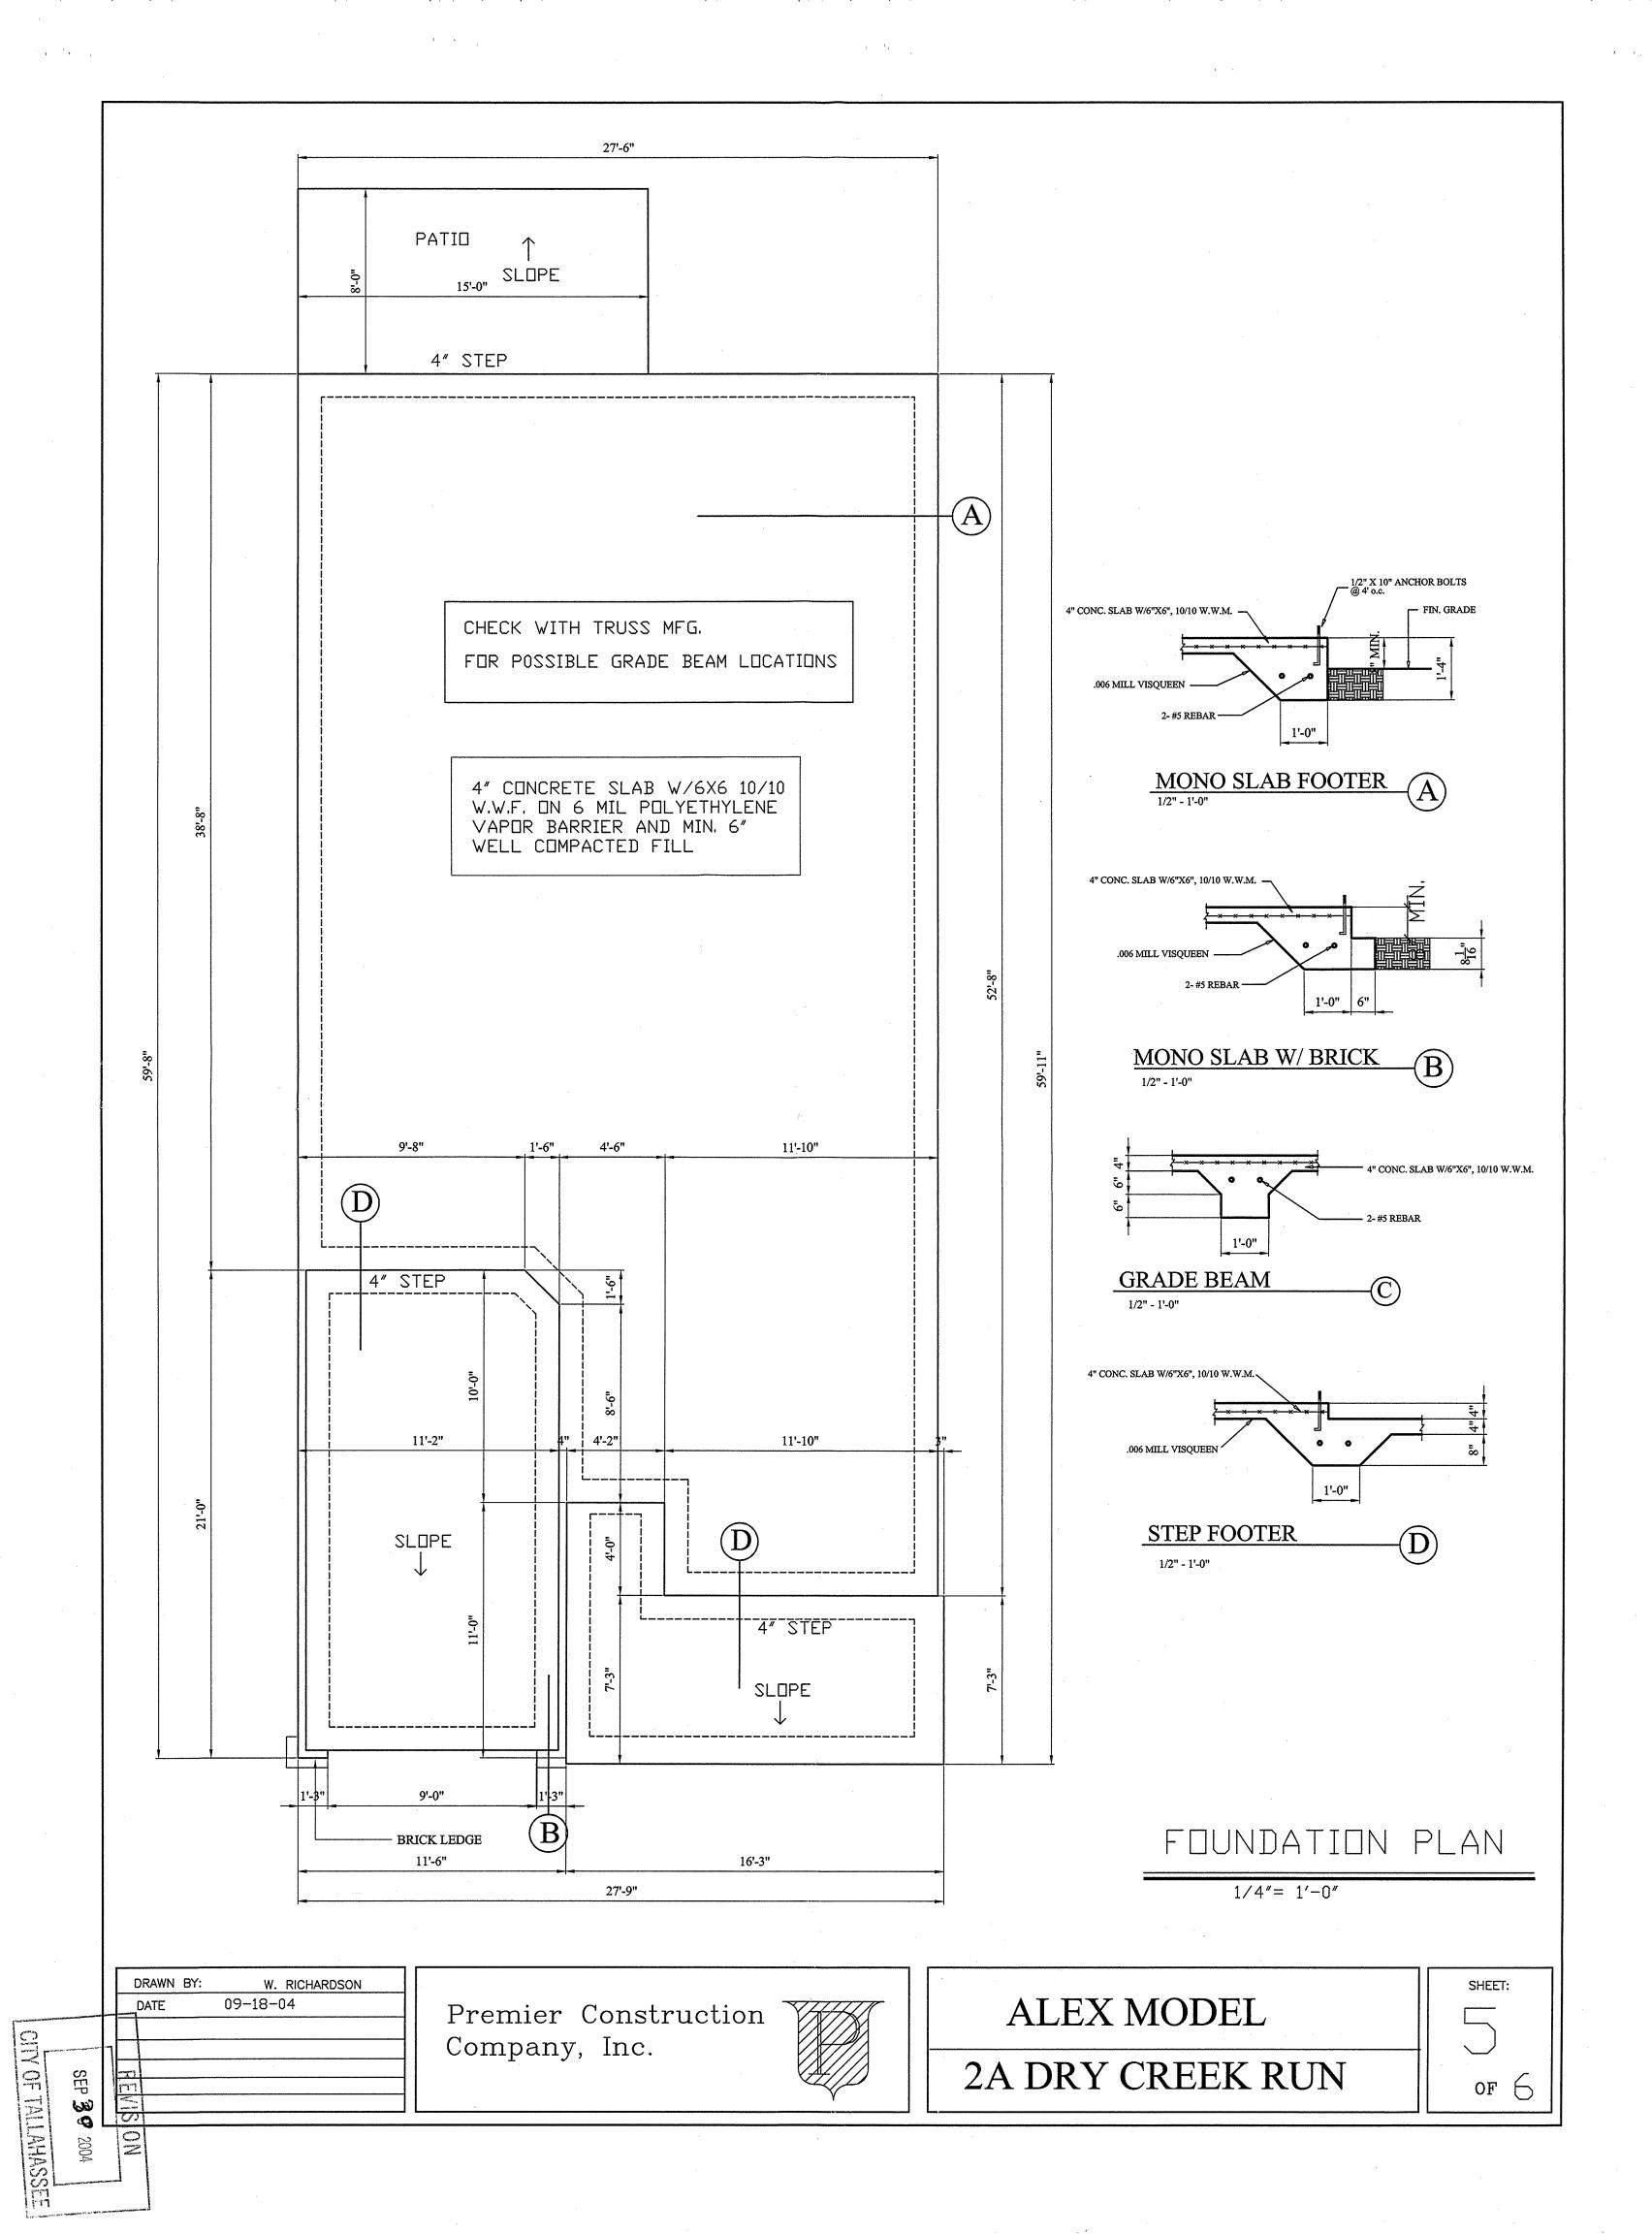

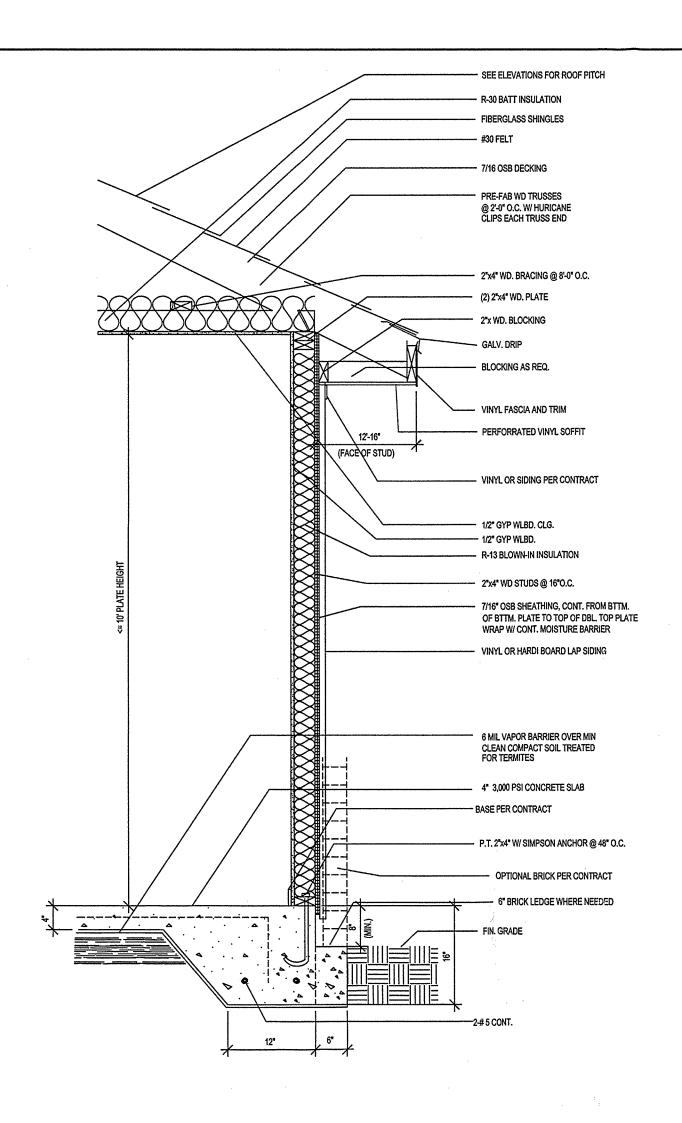

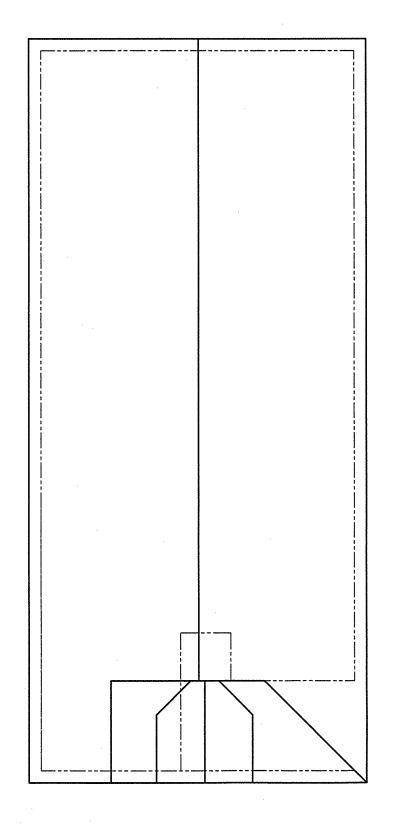

WALL SECTION

3/4"= 1',-0"

VERTICAL BARPLACEMENT FOR

BLOCK WALL WITH CONCRETE FLOOR SLAB OR JOIST DESIGN

FOR FLOOR JOIST DESIGN USE BOND BEAM WITH 1 #5 REINFORCED BAR CONTINUOUS
FOR SLAB FLOOR, POUR INTO BLOCK WITH WELDED WIRE MESH. (SEE CHART BELOW)

**IN ALL CASES VERTICAL BARS SHALL BE PLACED AT EITHER SIDE OF OPENINGS IN WALL


AND AT EACH CORNER. VERTICAL BARS SHALL BE BENT 24* INTO SLAB

EACH REINFORCED CELL SHALL BE FILLED WITH CONCRETE**

| | | 0* | * |
|--|--|-------------------|--|
| 1 . | HEIGHT F WALL | WIDTH OF BLOCK | VERTICAL BAR SPACING |
| V H ₄ | < 32 | 8" | NO. 5 @ 72" O.C. |
| 32 | 2 <h<56< td=""><td>8"</td><td>NO. 5 @ 48" O.C.</td></h<56<> | 8" | NO. 5 @ 48" O.C. |
| 56 | 6 <h<72< td=""><td>8*</td><td>NP. 5 @ 32* O.C.</td></h<72<> | 8* | NP. 5 @ 32* O.C. |
| 72 | 2 <h<88< td=""><td>12"</td><td>NO. 5 @ 32" O.C. W/ BOND BEAM W/ 1 #5 @ MID-HEIGHT</td></h<88<> | 12" | NO. 5 @ 32" O.C. W/ BOND BEAM W/ 1 #5 @ MID-HEIGHT |
| one of the state o | | 8* | NO. 5 @ 32* O.C. *(8* BLOCK MAY BE USED ONLY IF NEITHER SIDE OF WALL HAS SOIL BEARING PRESSURE. A BOND BEAM WITH 1-#5 SHALL BE PROVIDED @ MID-HEIGHT) |
| 88 | 3 <h<96< td=""><td>12"</td><td>NO. 5 @ 24" O.C. W/ BOND BEAM W/ 1 #5 @ MID-HEIGHT</td></h<96<> | 12" | NO. 5 @ 24" O.C. W/ BOND BEAM W/ 1 #5 @ MID-HEIGHT |
| • | | 8" | NO. 5 @ 24" O.C. *(8" BLOCK MAY BE USED ONLY IF NEITHER SIDE OF WALL HAS SOIL BEARING PRESSURE. A BOND BEAM WITH 1.#5 SHALL BE PROVIDED @ MID-HEIGHT) |

ROOF PLAN

1/8"= 1'-0"

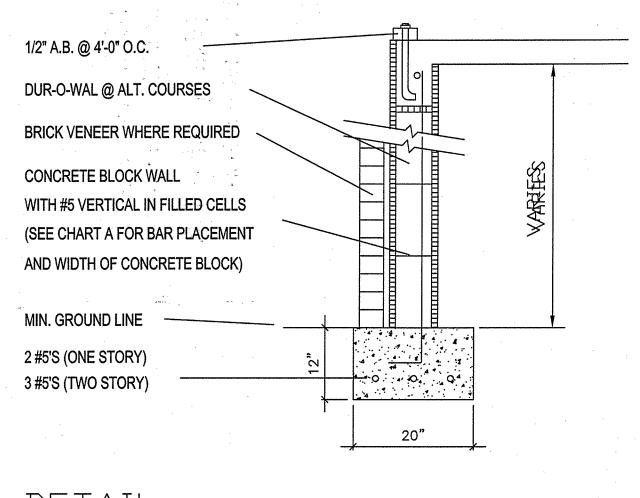

DETAIL


NOT TO SCALE

| | DRAWN BY: | | BY: | W. RICHARDSON | | | | |
|---|-----------|-----|-----|---------------|------|----|----|---|
| | D | ATE | · | 09-1 | 8-04 | | | |
| | | | 4 . | | *, | | 44 | |
| 1 | | | | | | ۸. | - | , |
| | messes. | , | | | | | | · |
| 1 | 1 berhad | 1 | | | | | | |

CHTY OF TALLAHASSEE


SEP 30

Premier Construction Company, Inc.

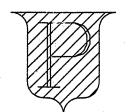

ALEX MODEL

2A DRY CREEK RUN

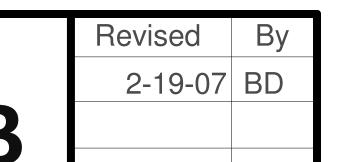



Tallahassee 32314 Box 6646,

Copyright 2007

CRC1327443

Dean -8703 -William | (850) 656-8

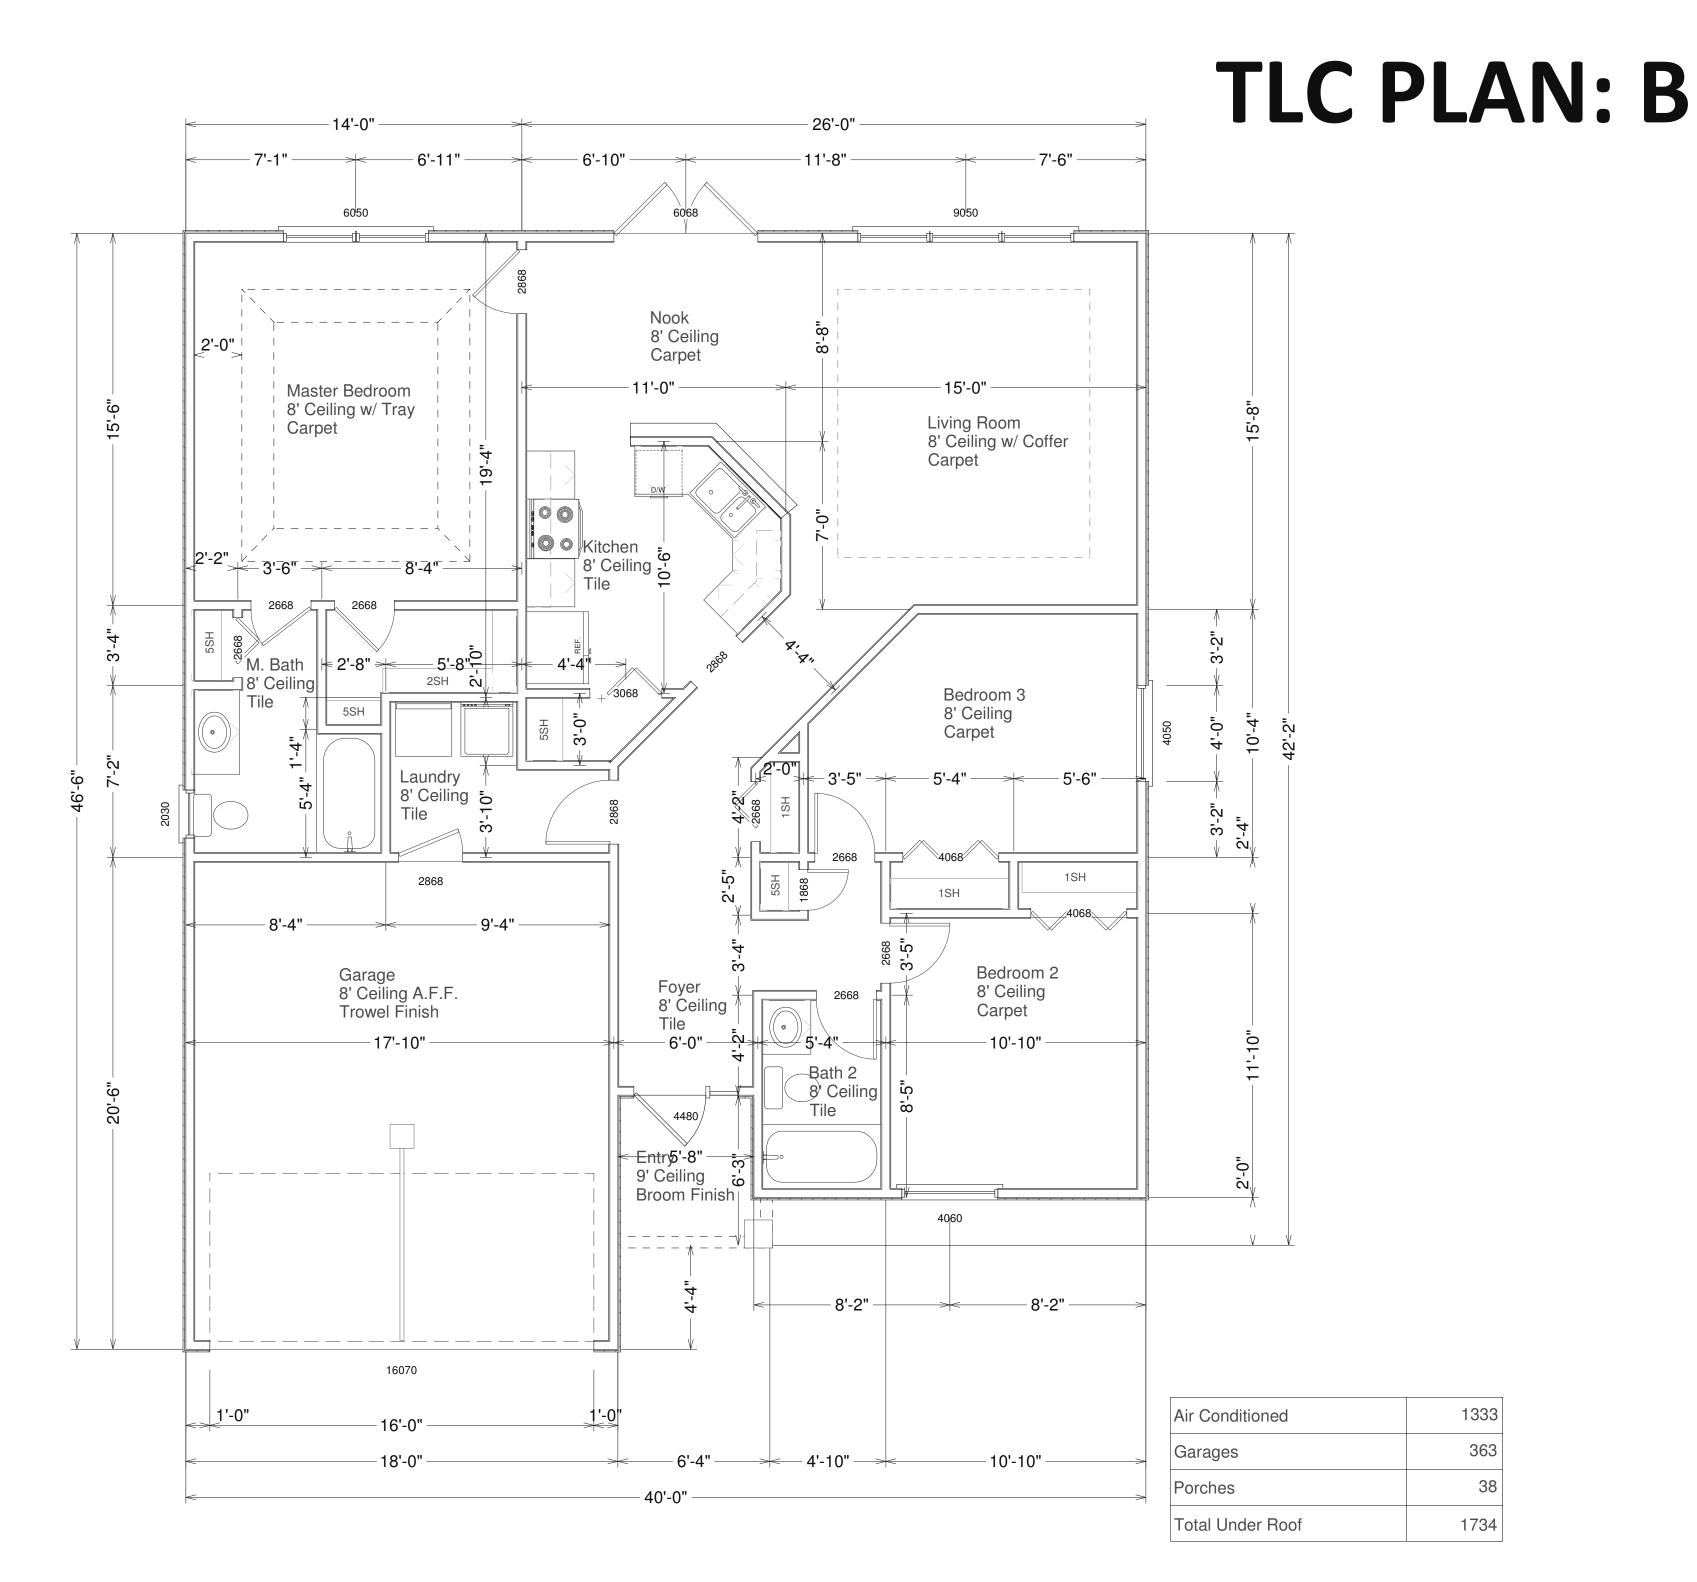


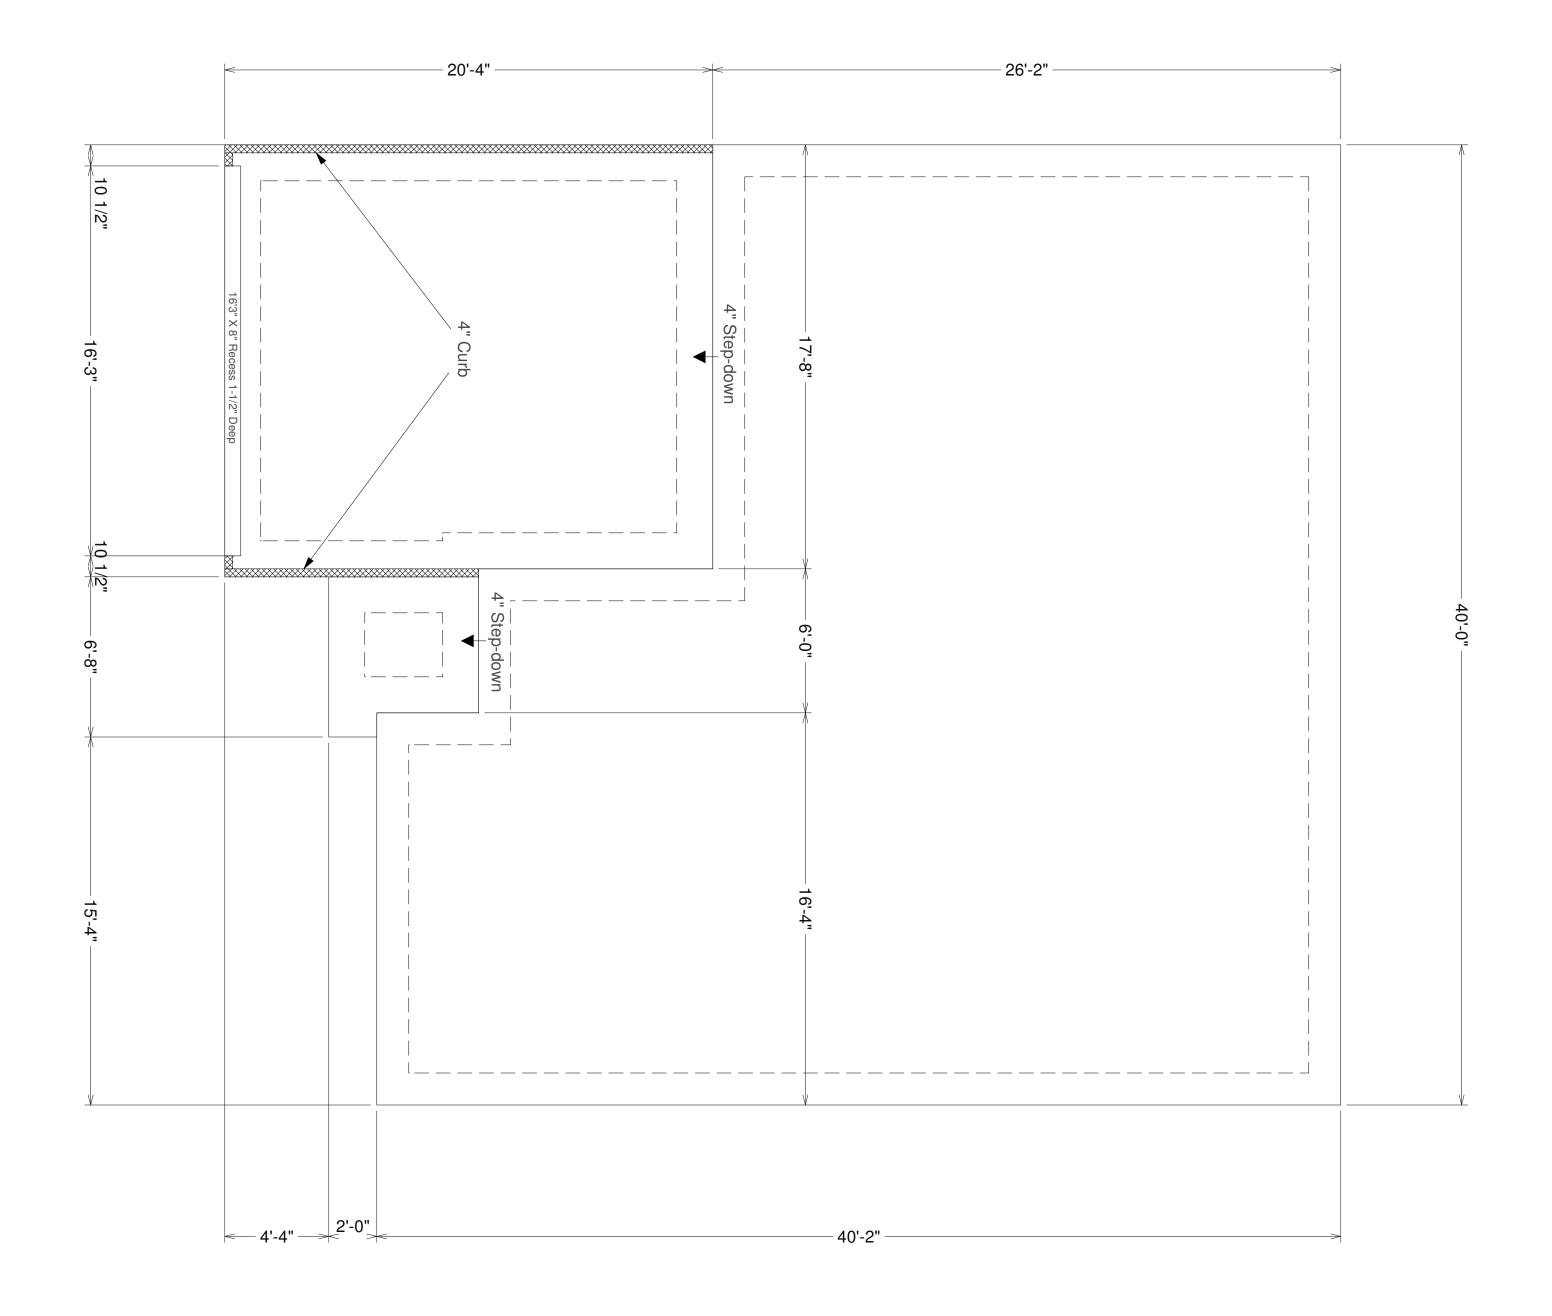

N

William Dean Homes North, Inc. (850) 656-8703 - P.O. Box 6646, Tallahassee 32314


Orion's Point Laurel Model Revised By 2-19-07 BD

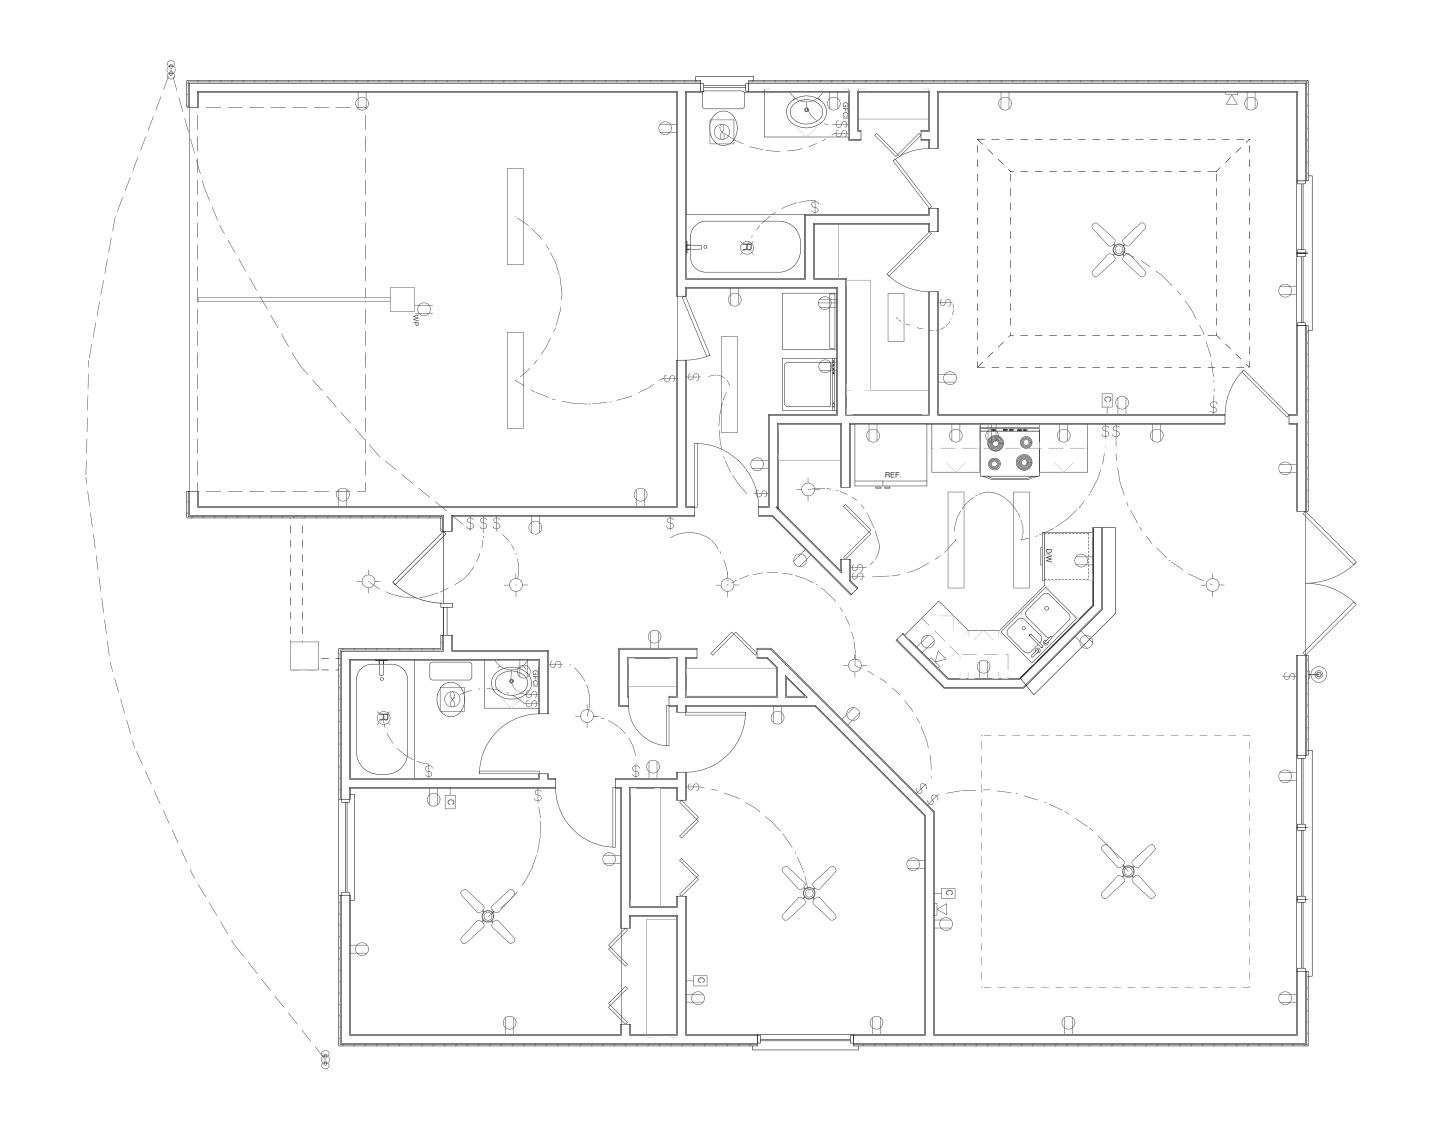

 ω

William Dean Homes North, Inc. (850) 656-8703 - P.O. Box 6646, Tallahassee 32314

Orion's Point Laurel Model Revised B 2-19-07 BI

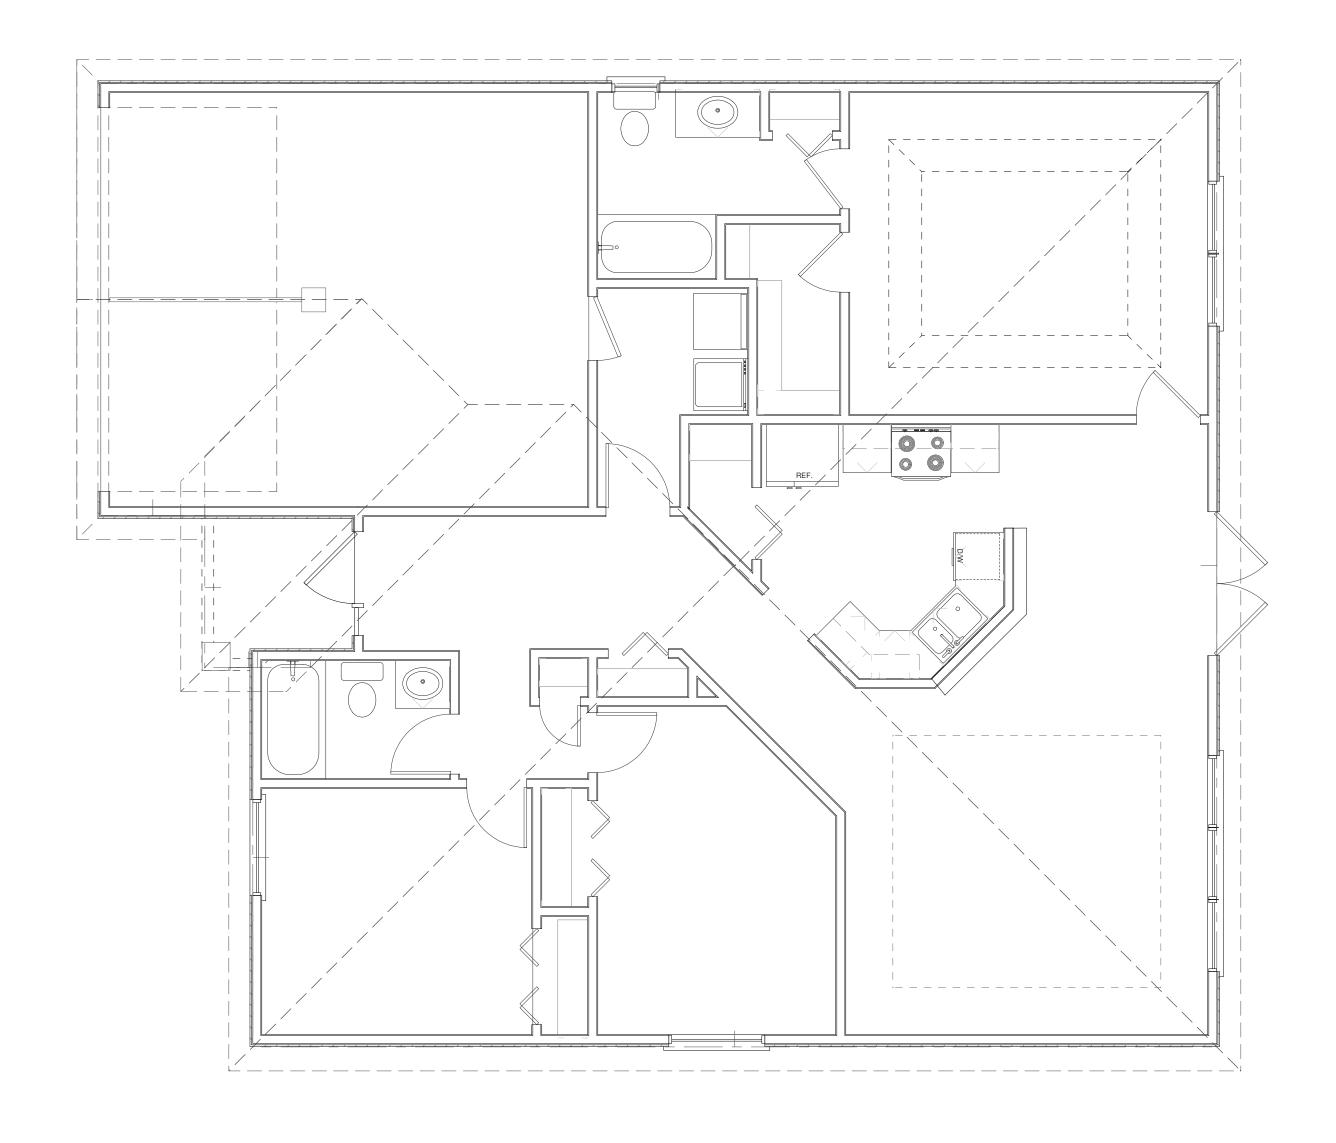


William Dean Homes North, Inc.


(850) 656-8703 - P.O. Box 6646, Tallahassee 32314


Orion's Point Laurel Model


2-19-07 BE

4

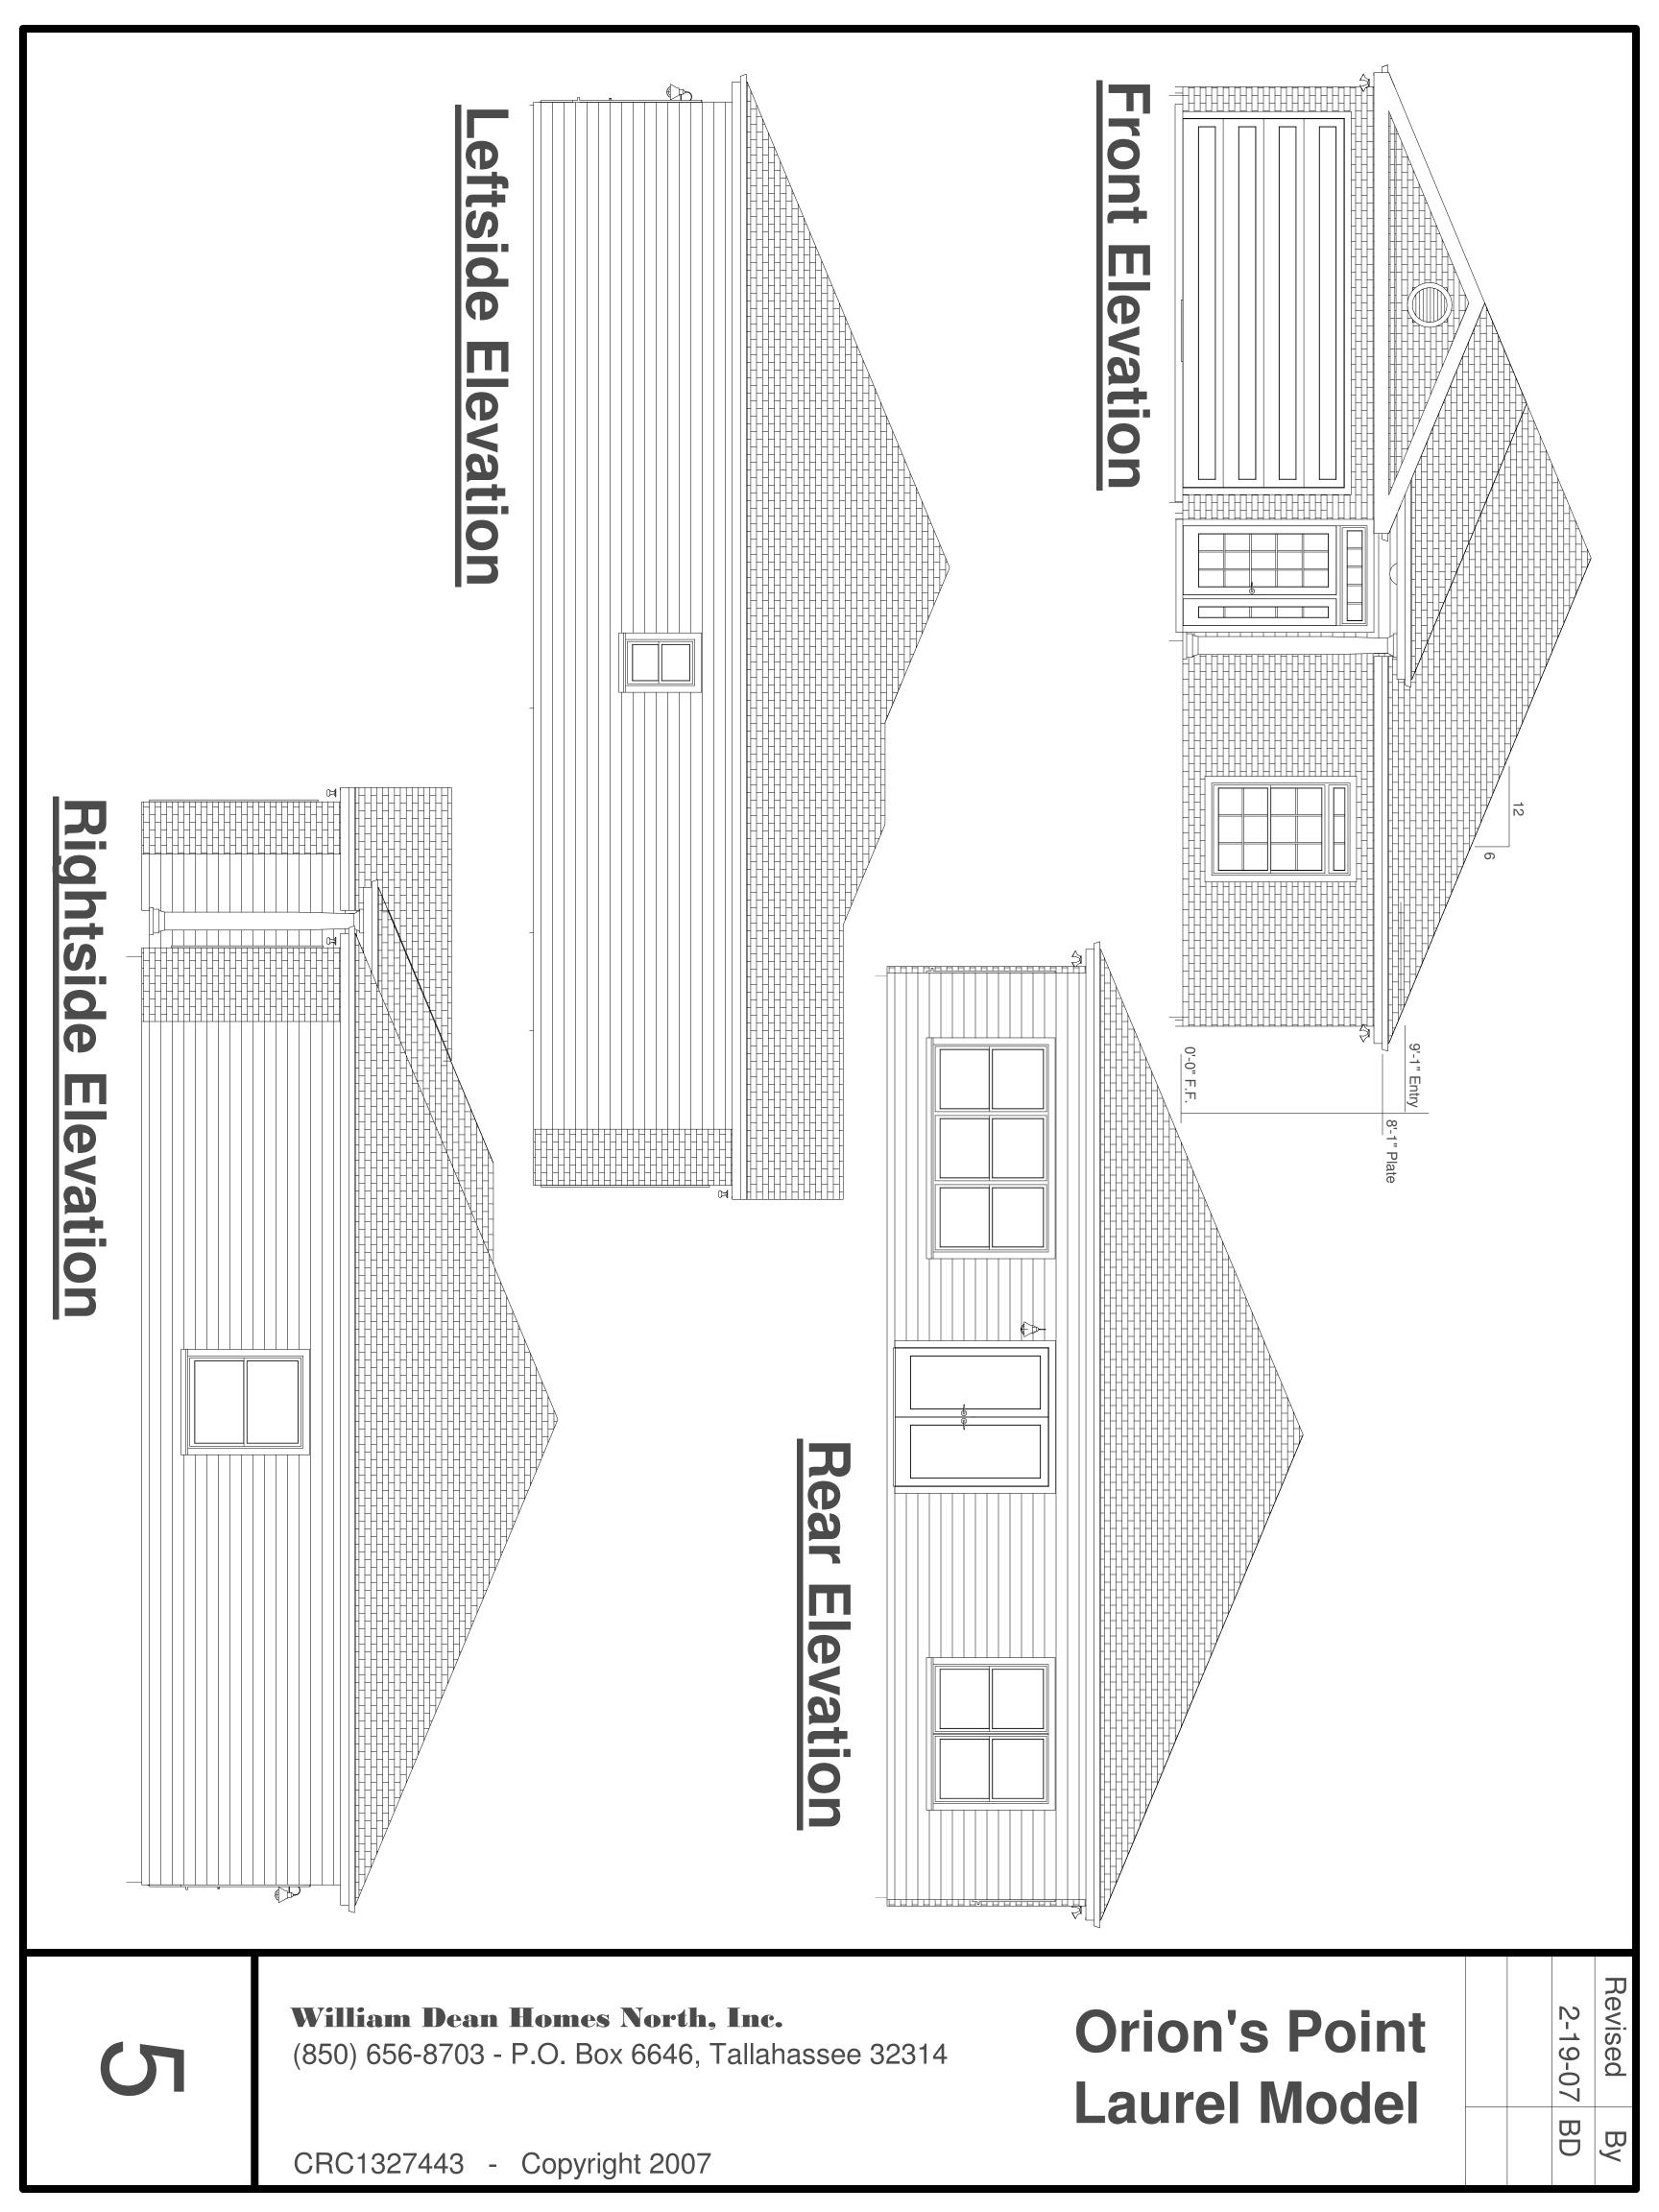

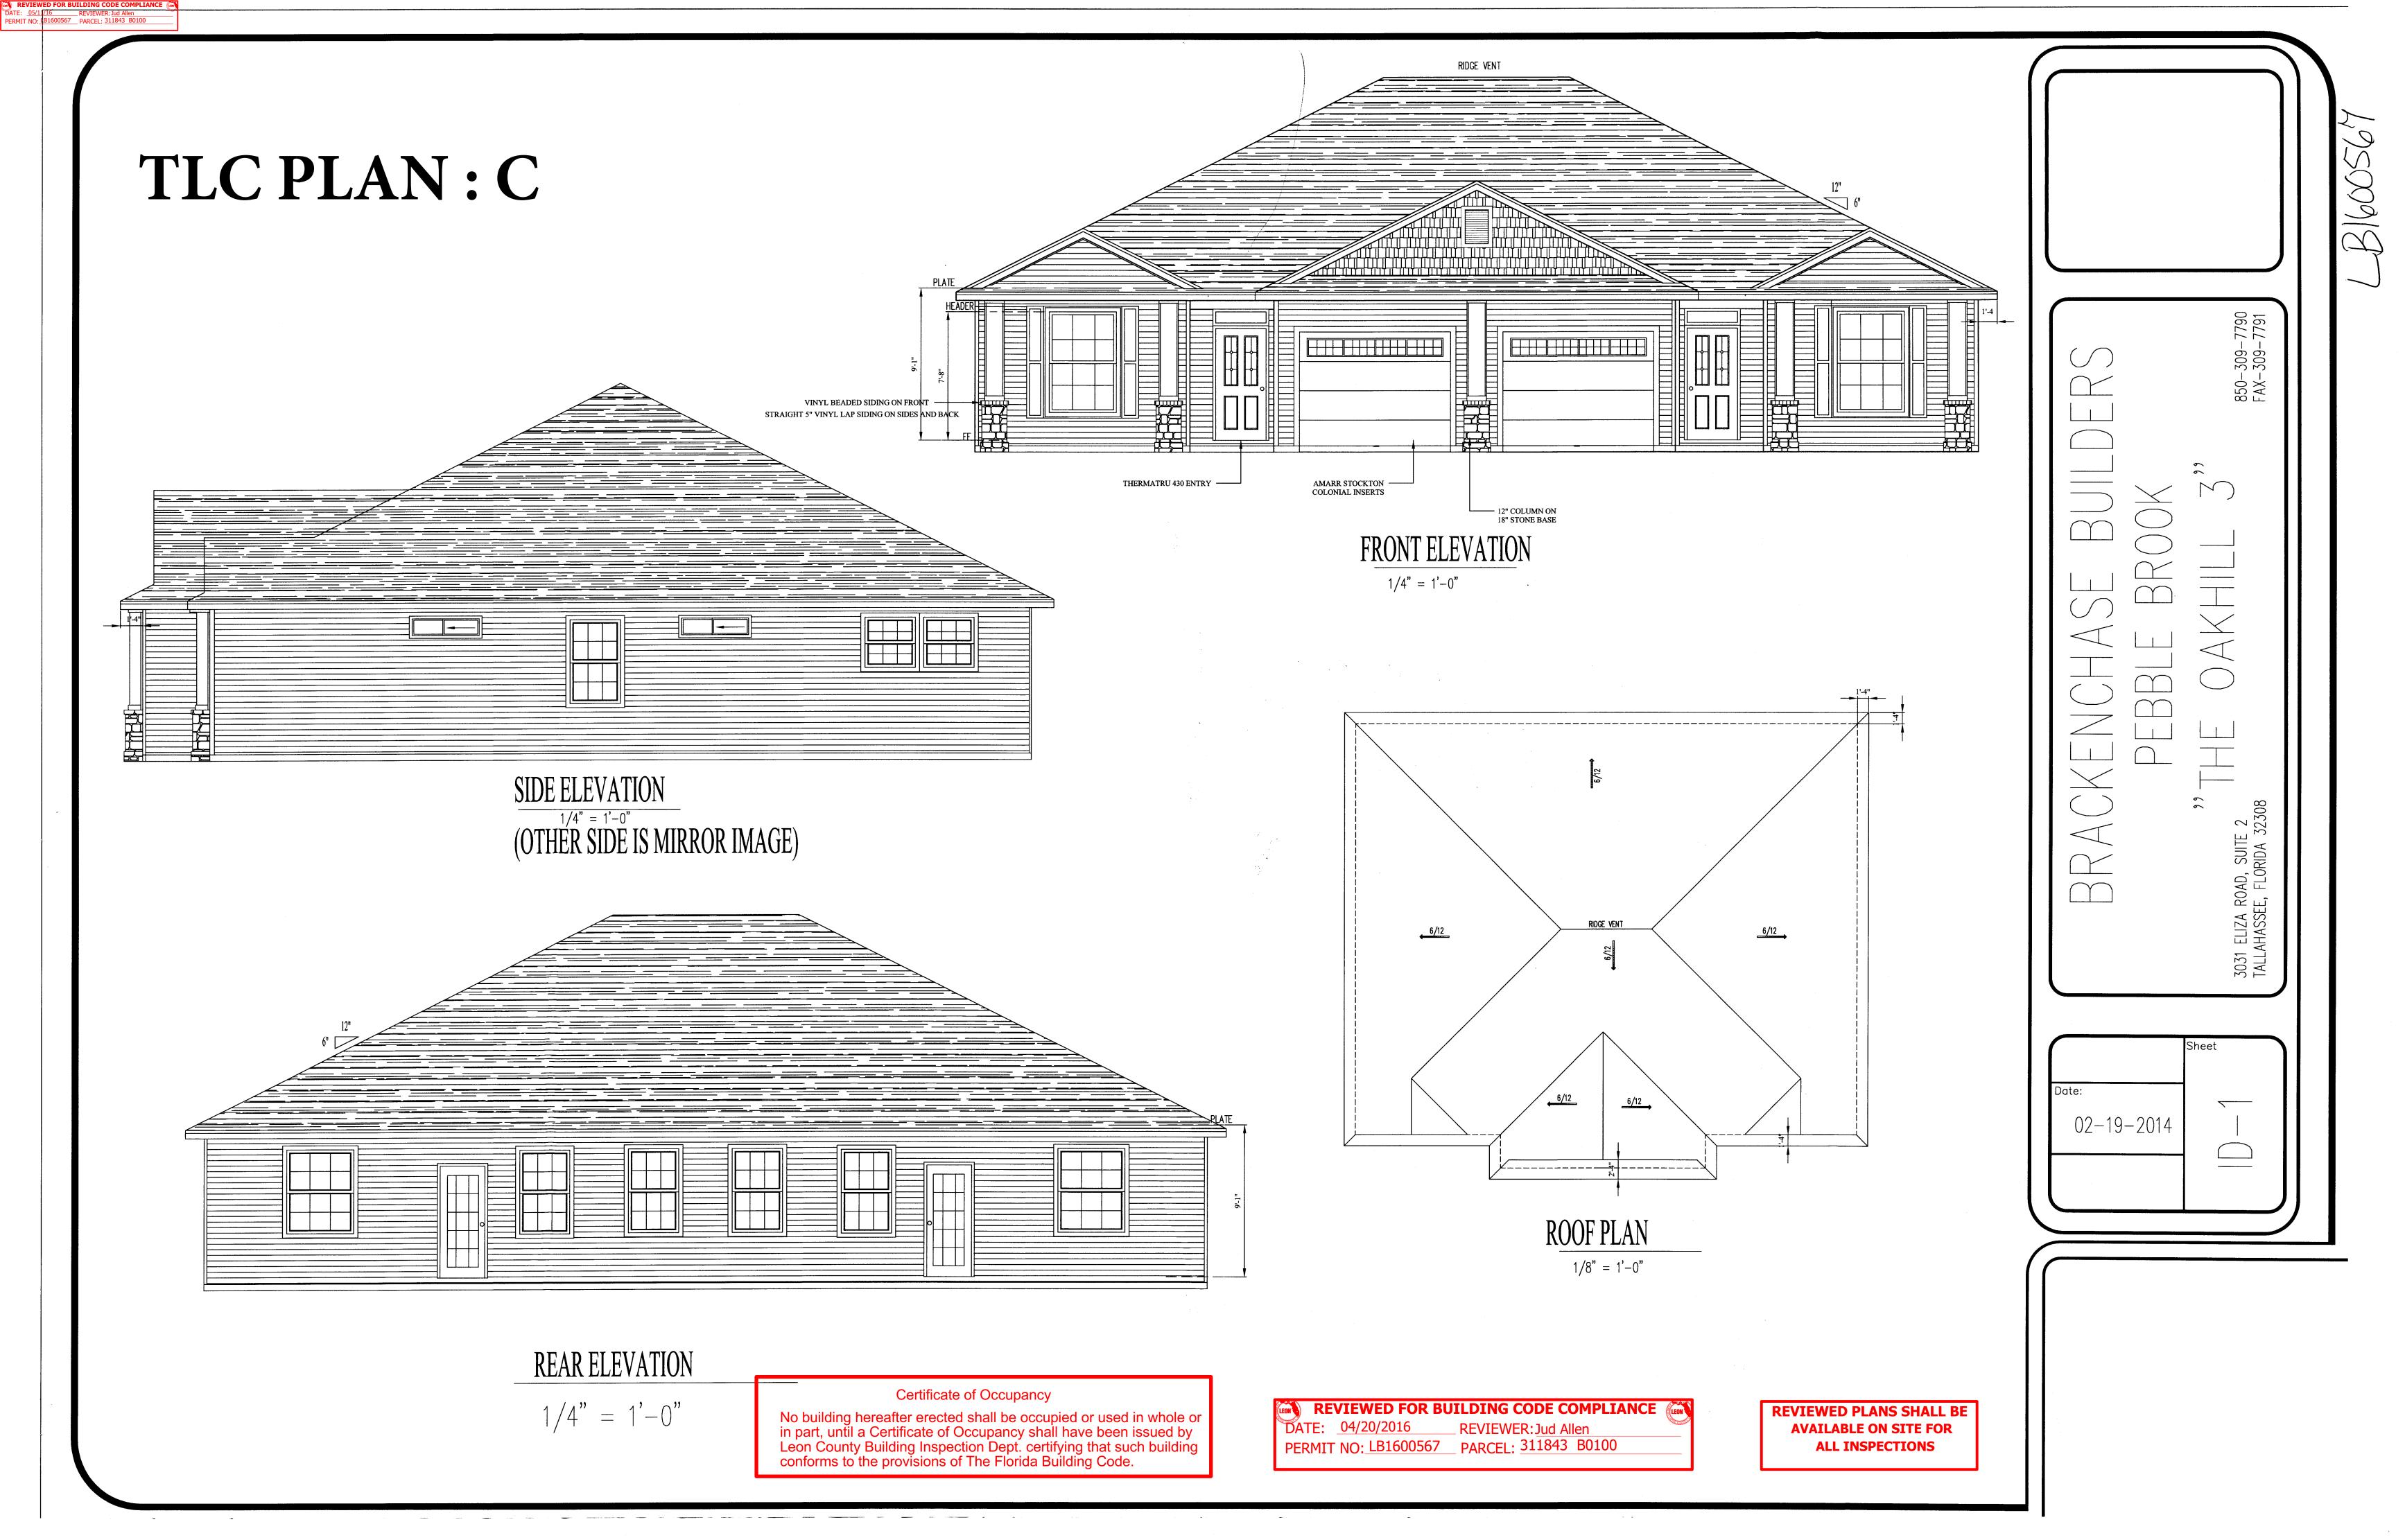

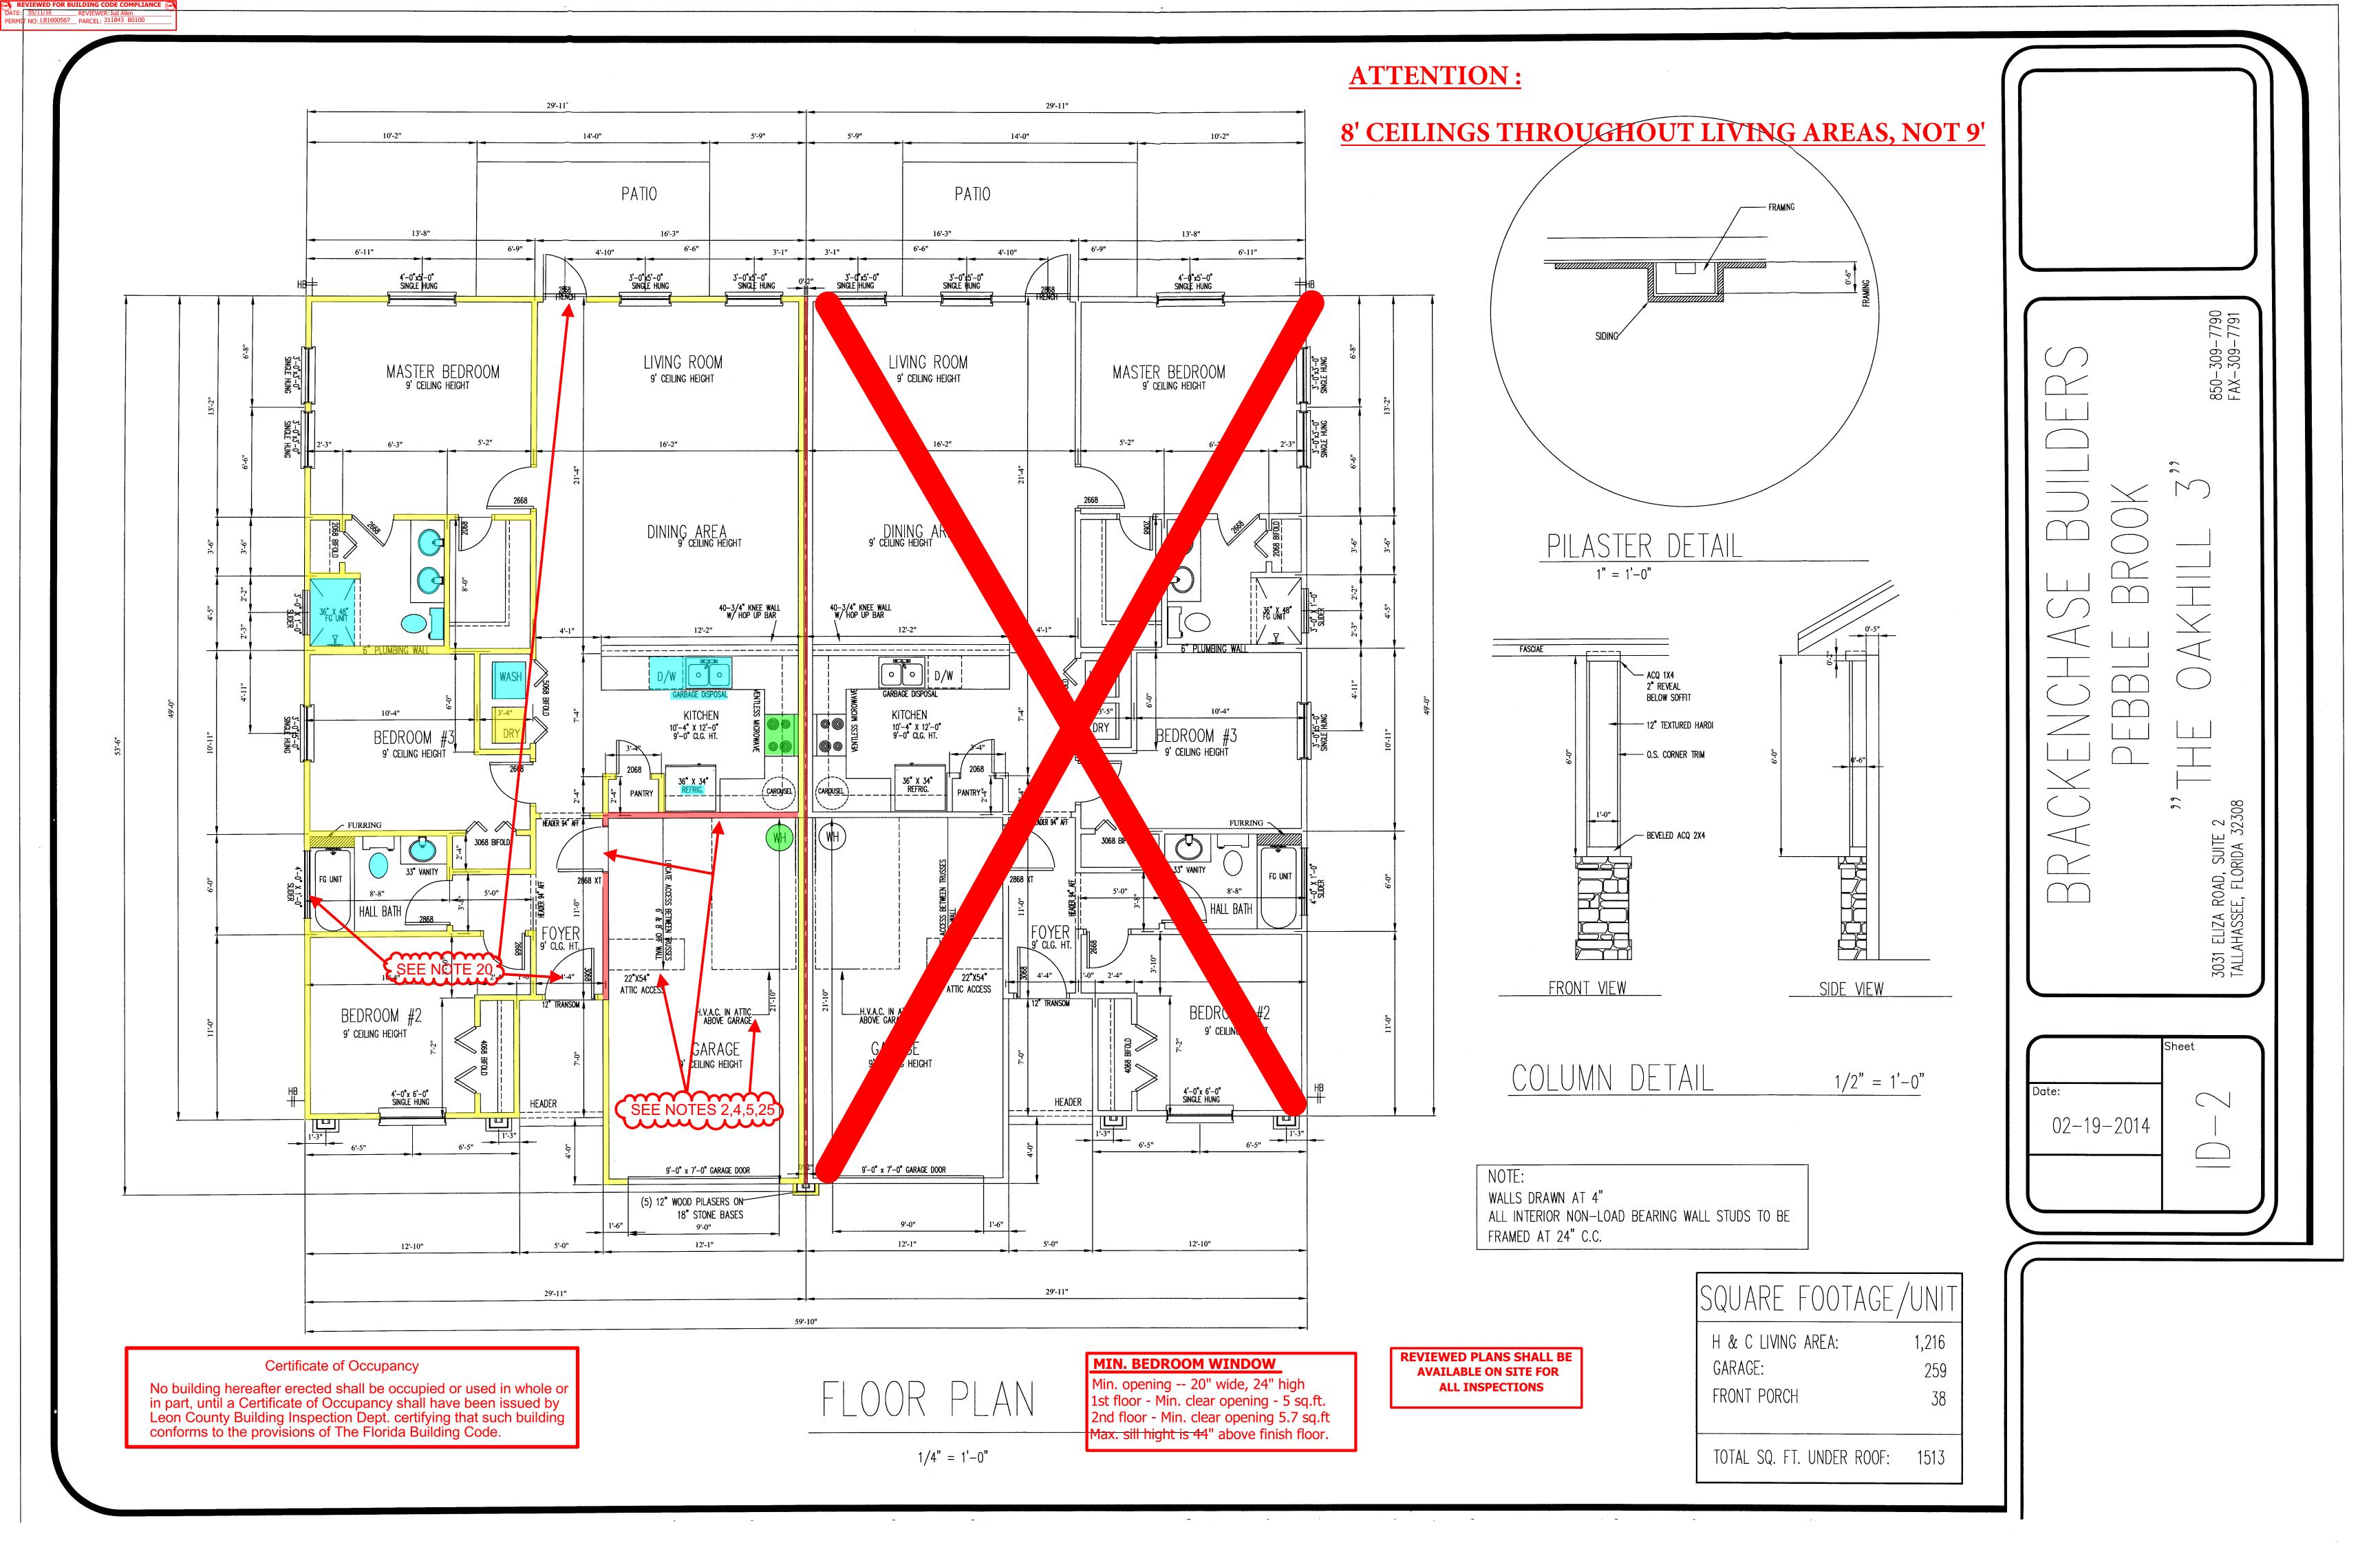


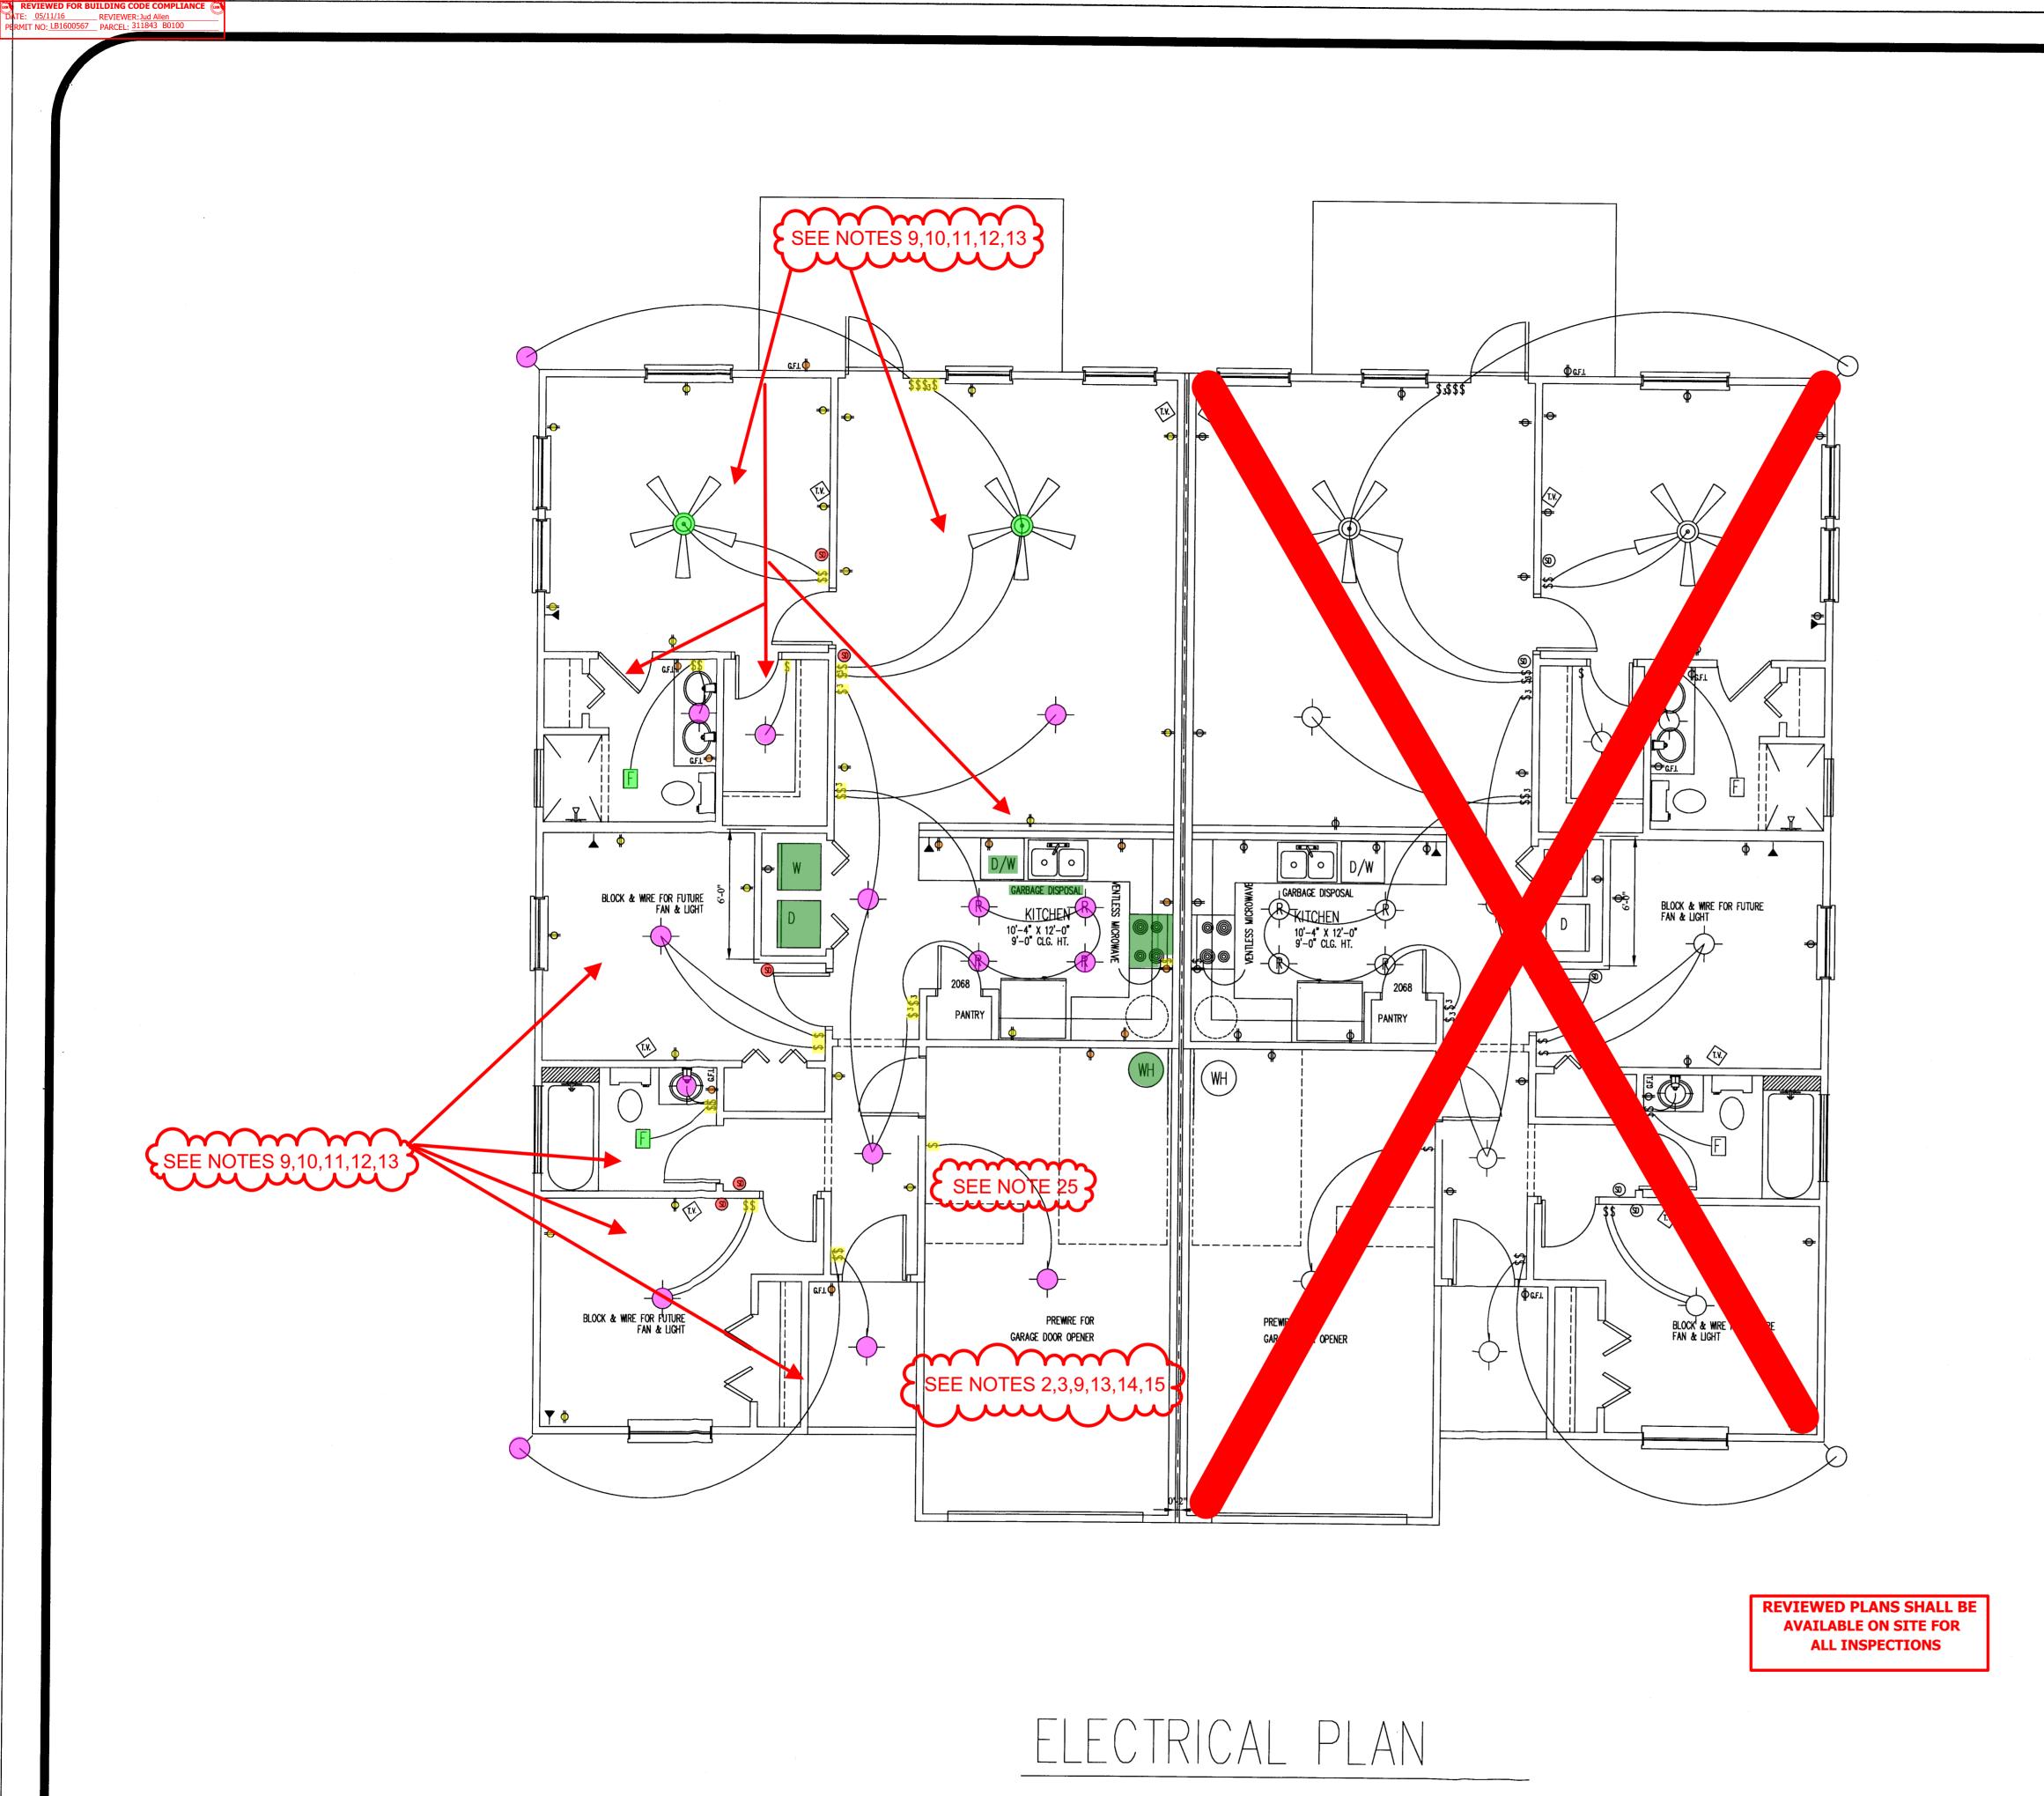



Sozi Eliza Road, Suite 2
TALLAHASSEE, FLORIDA 32308


02-19-2014

1/4" = 1'-0"

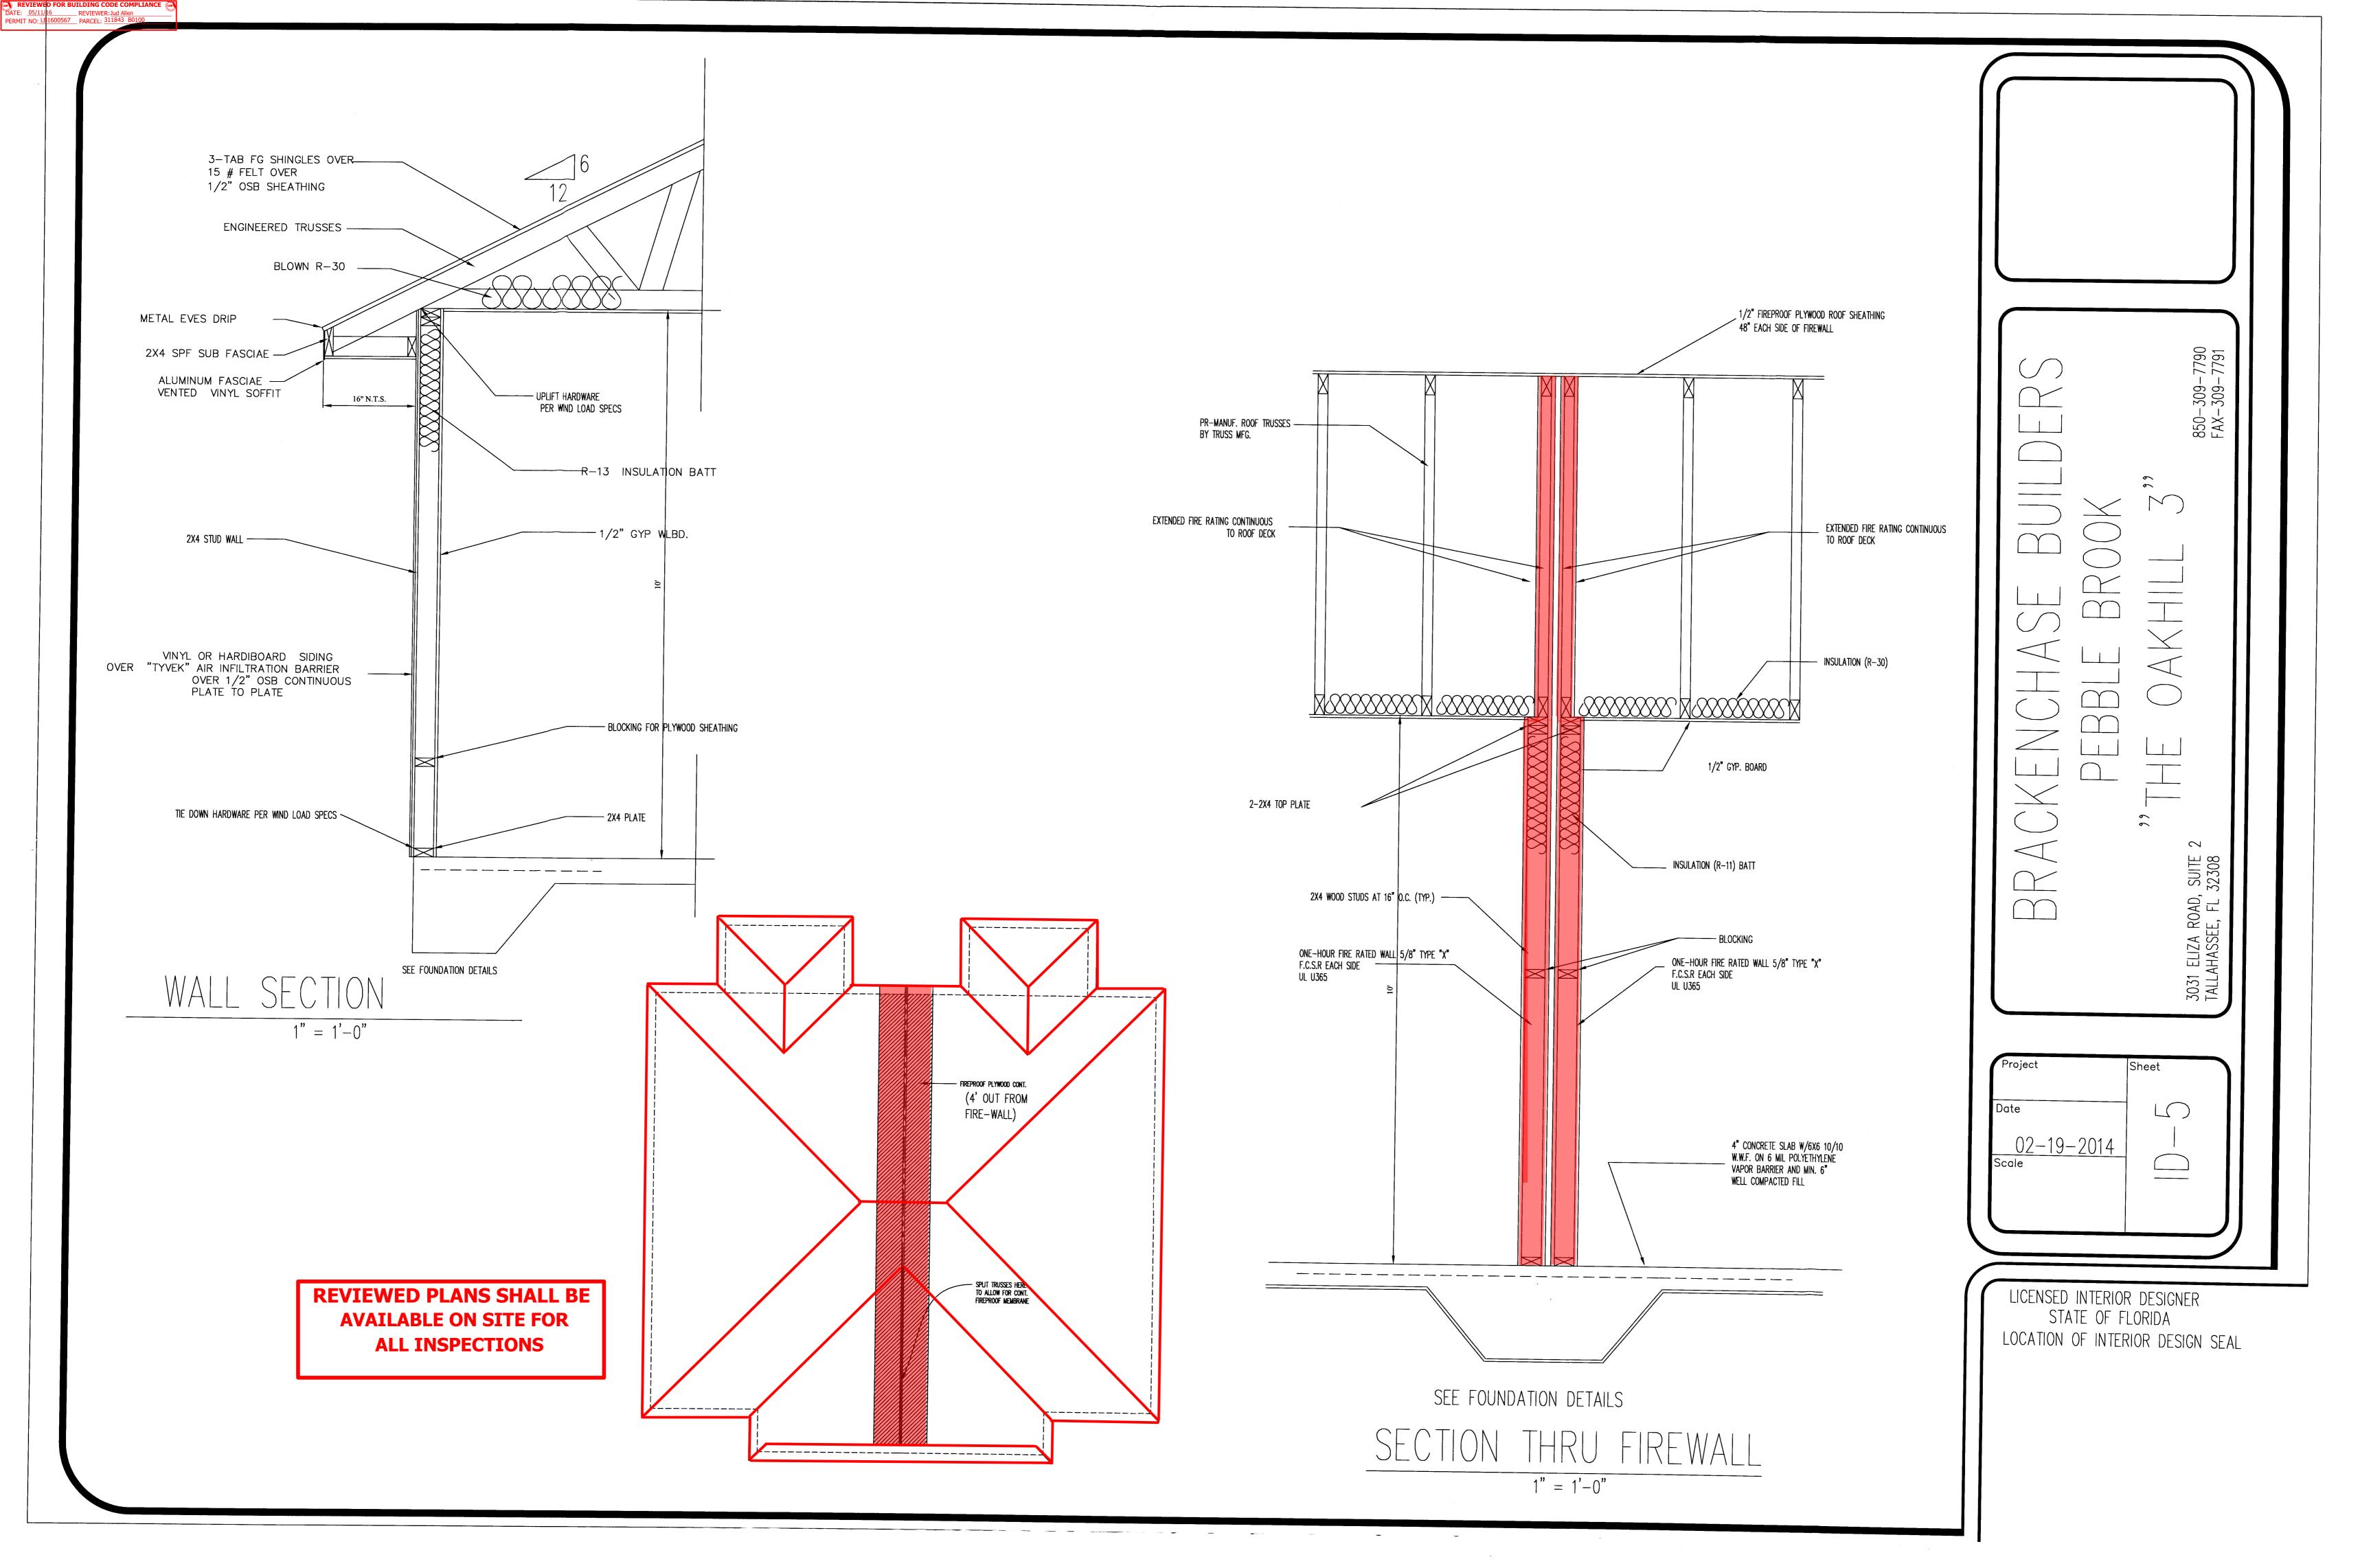

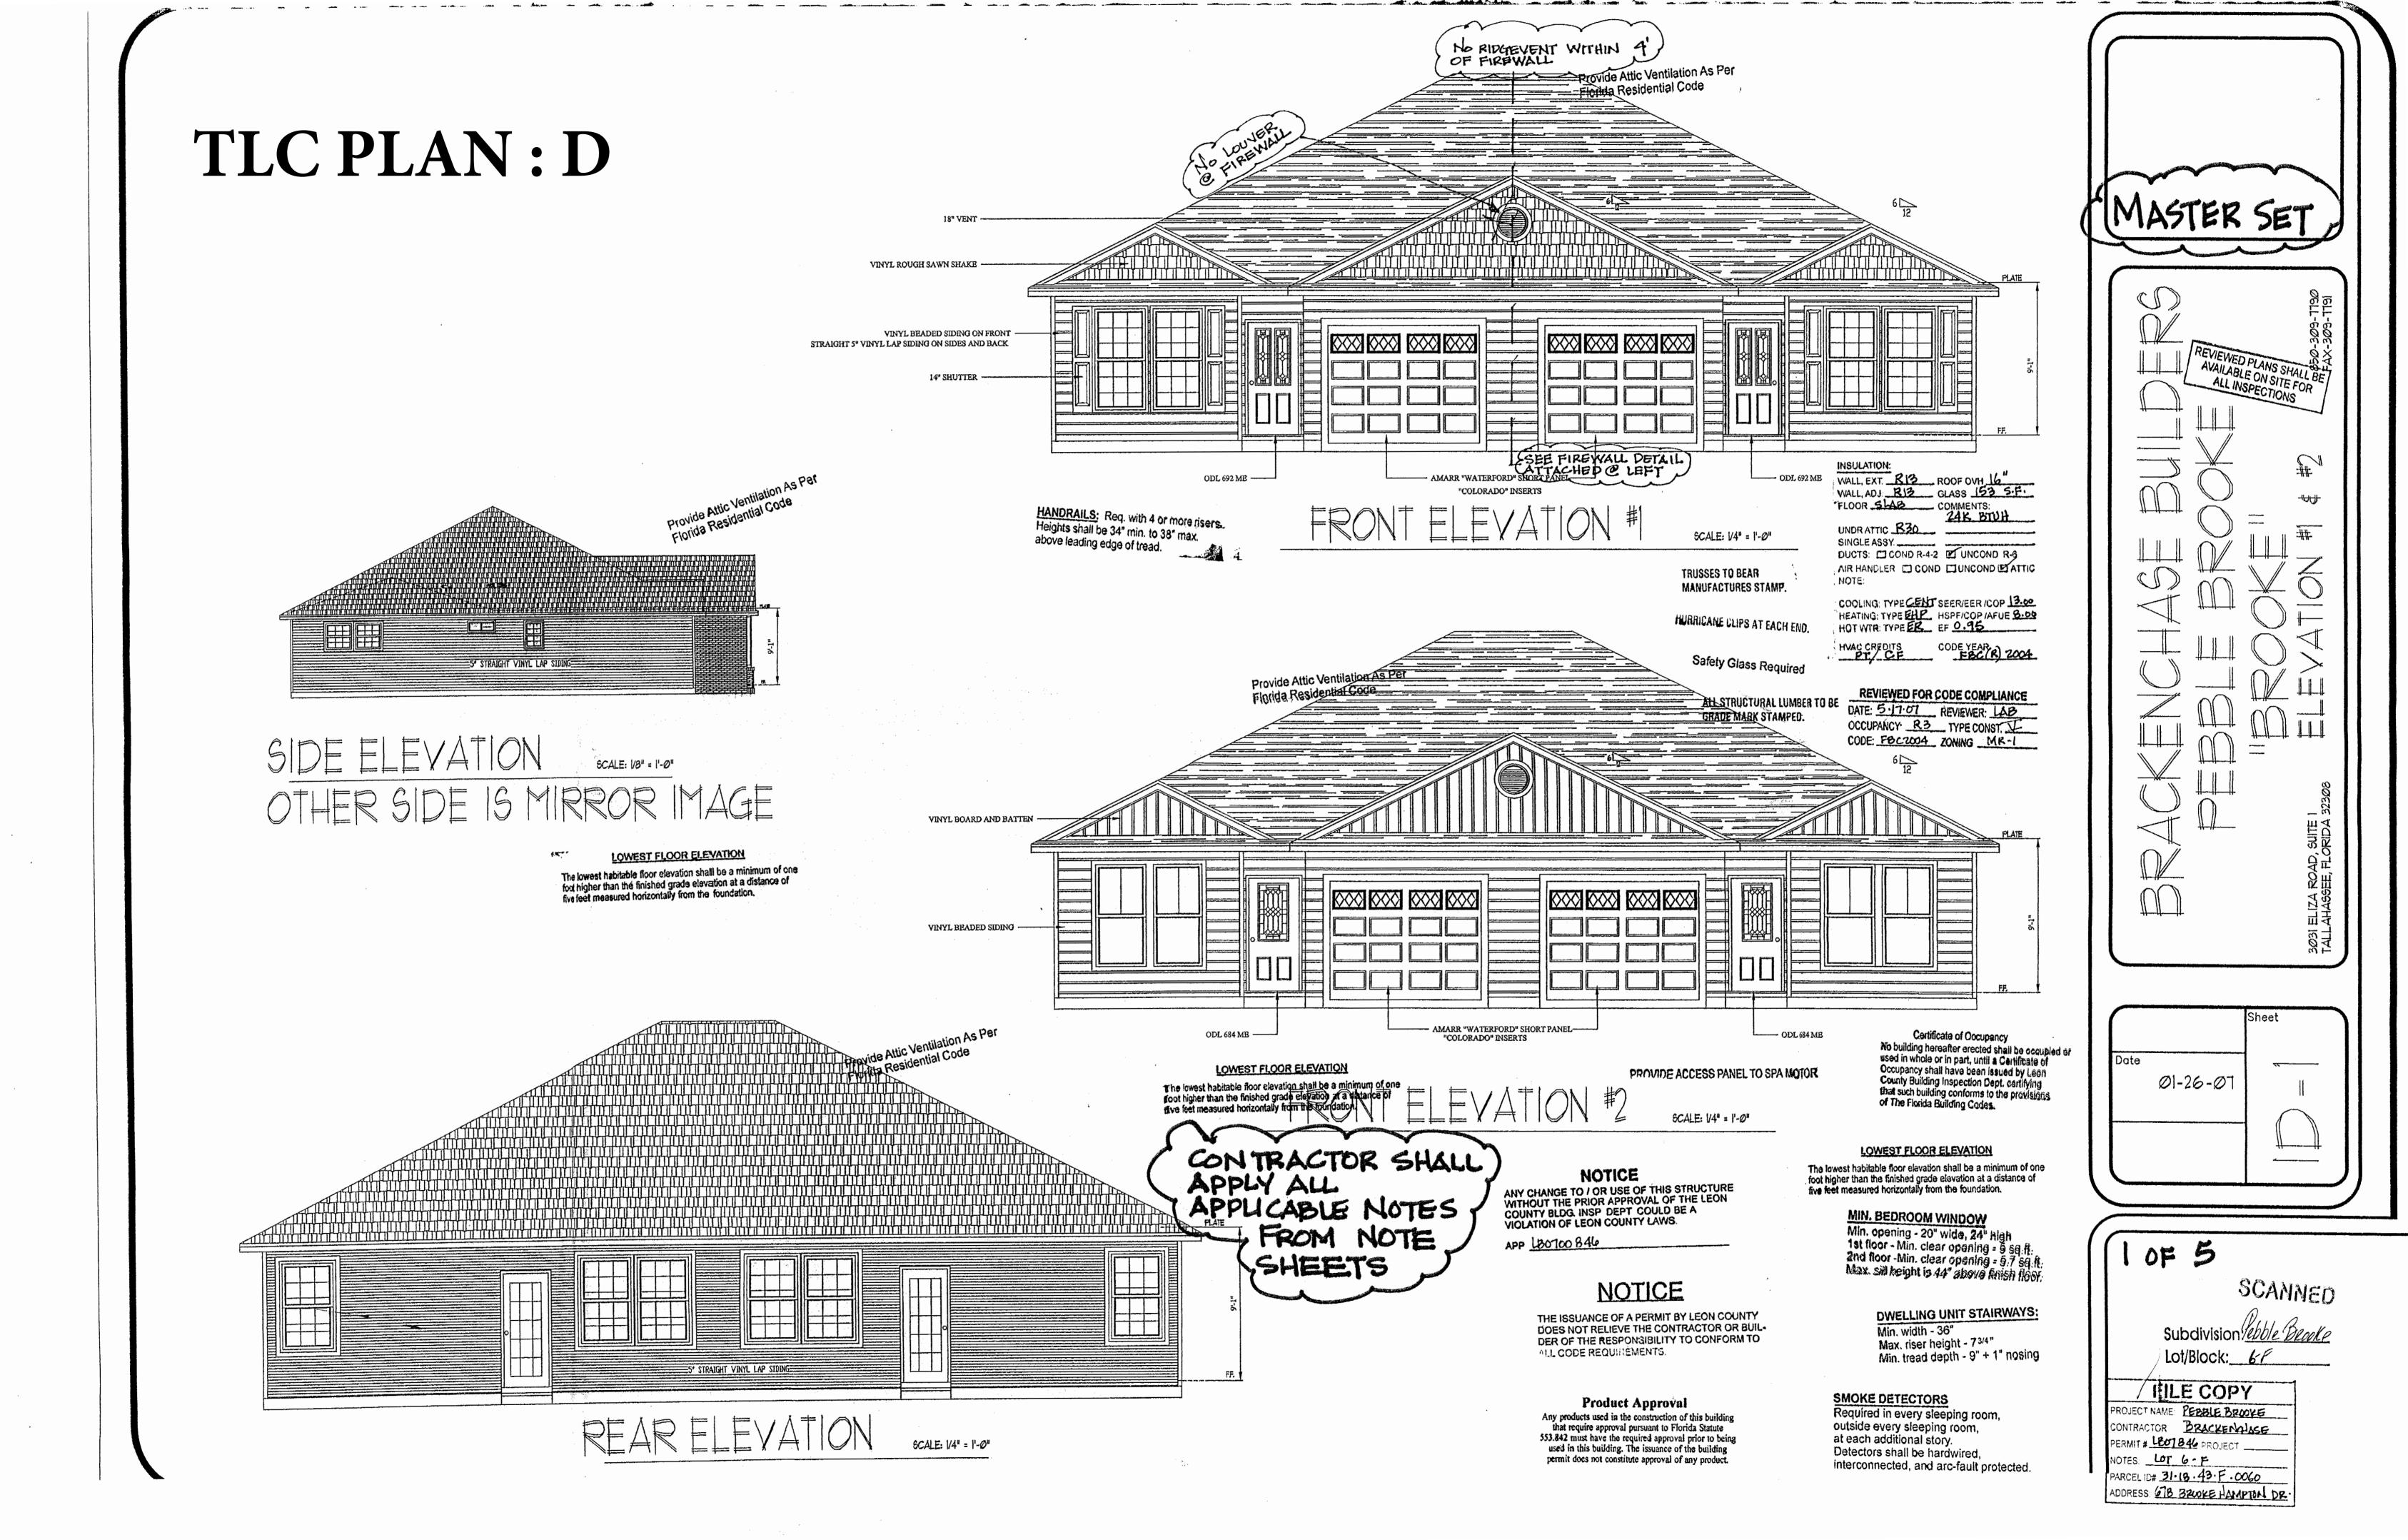

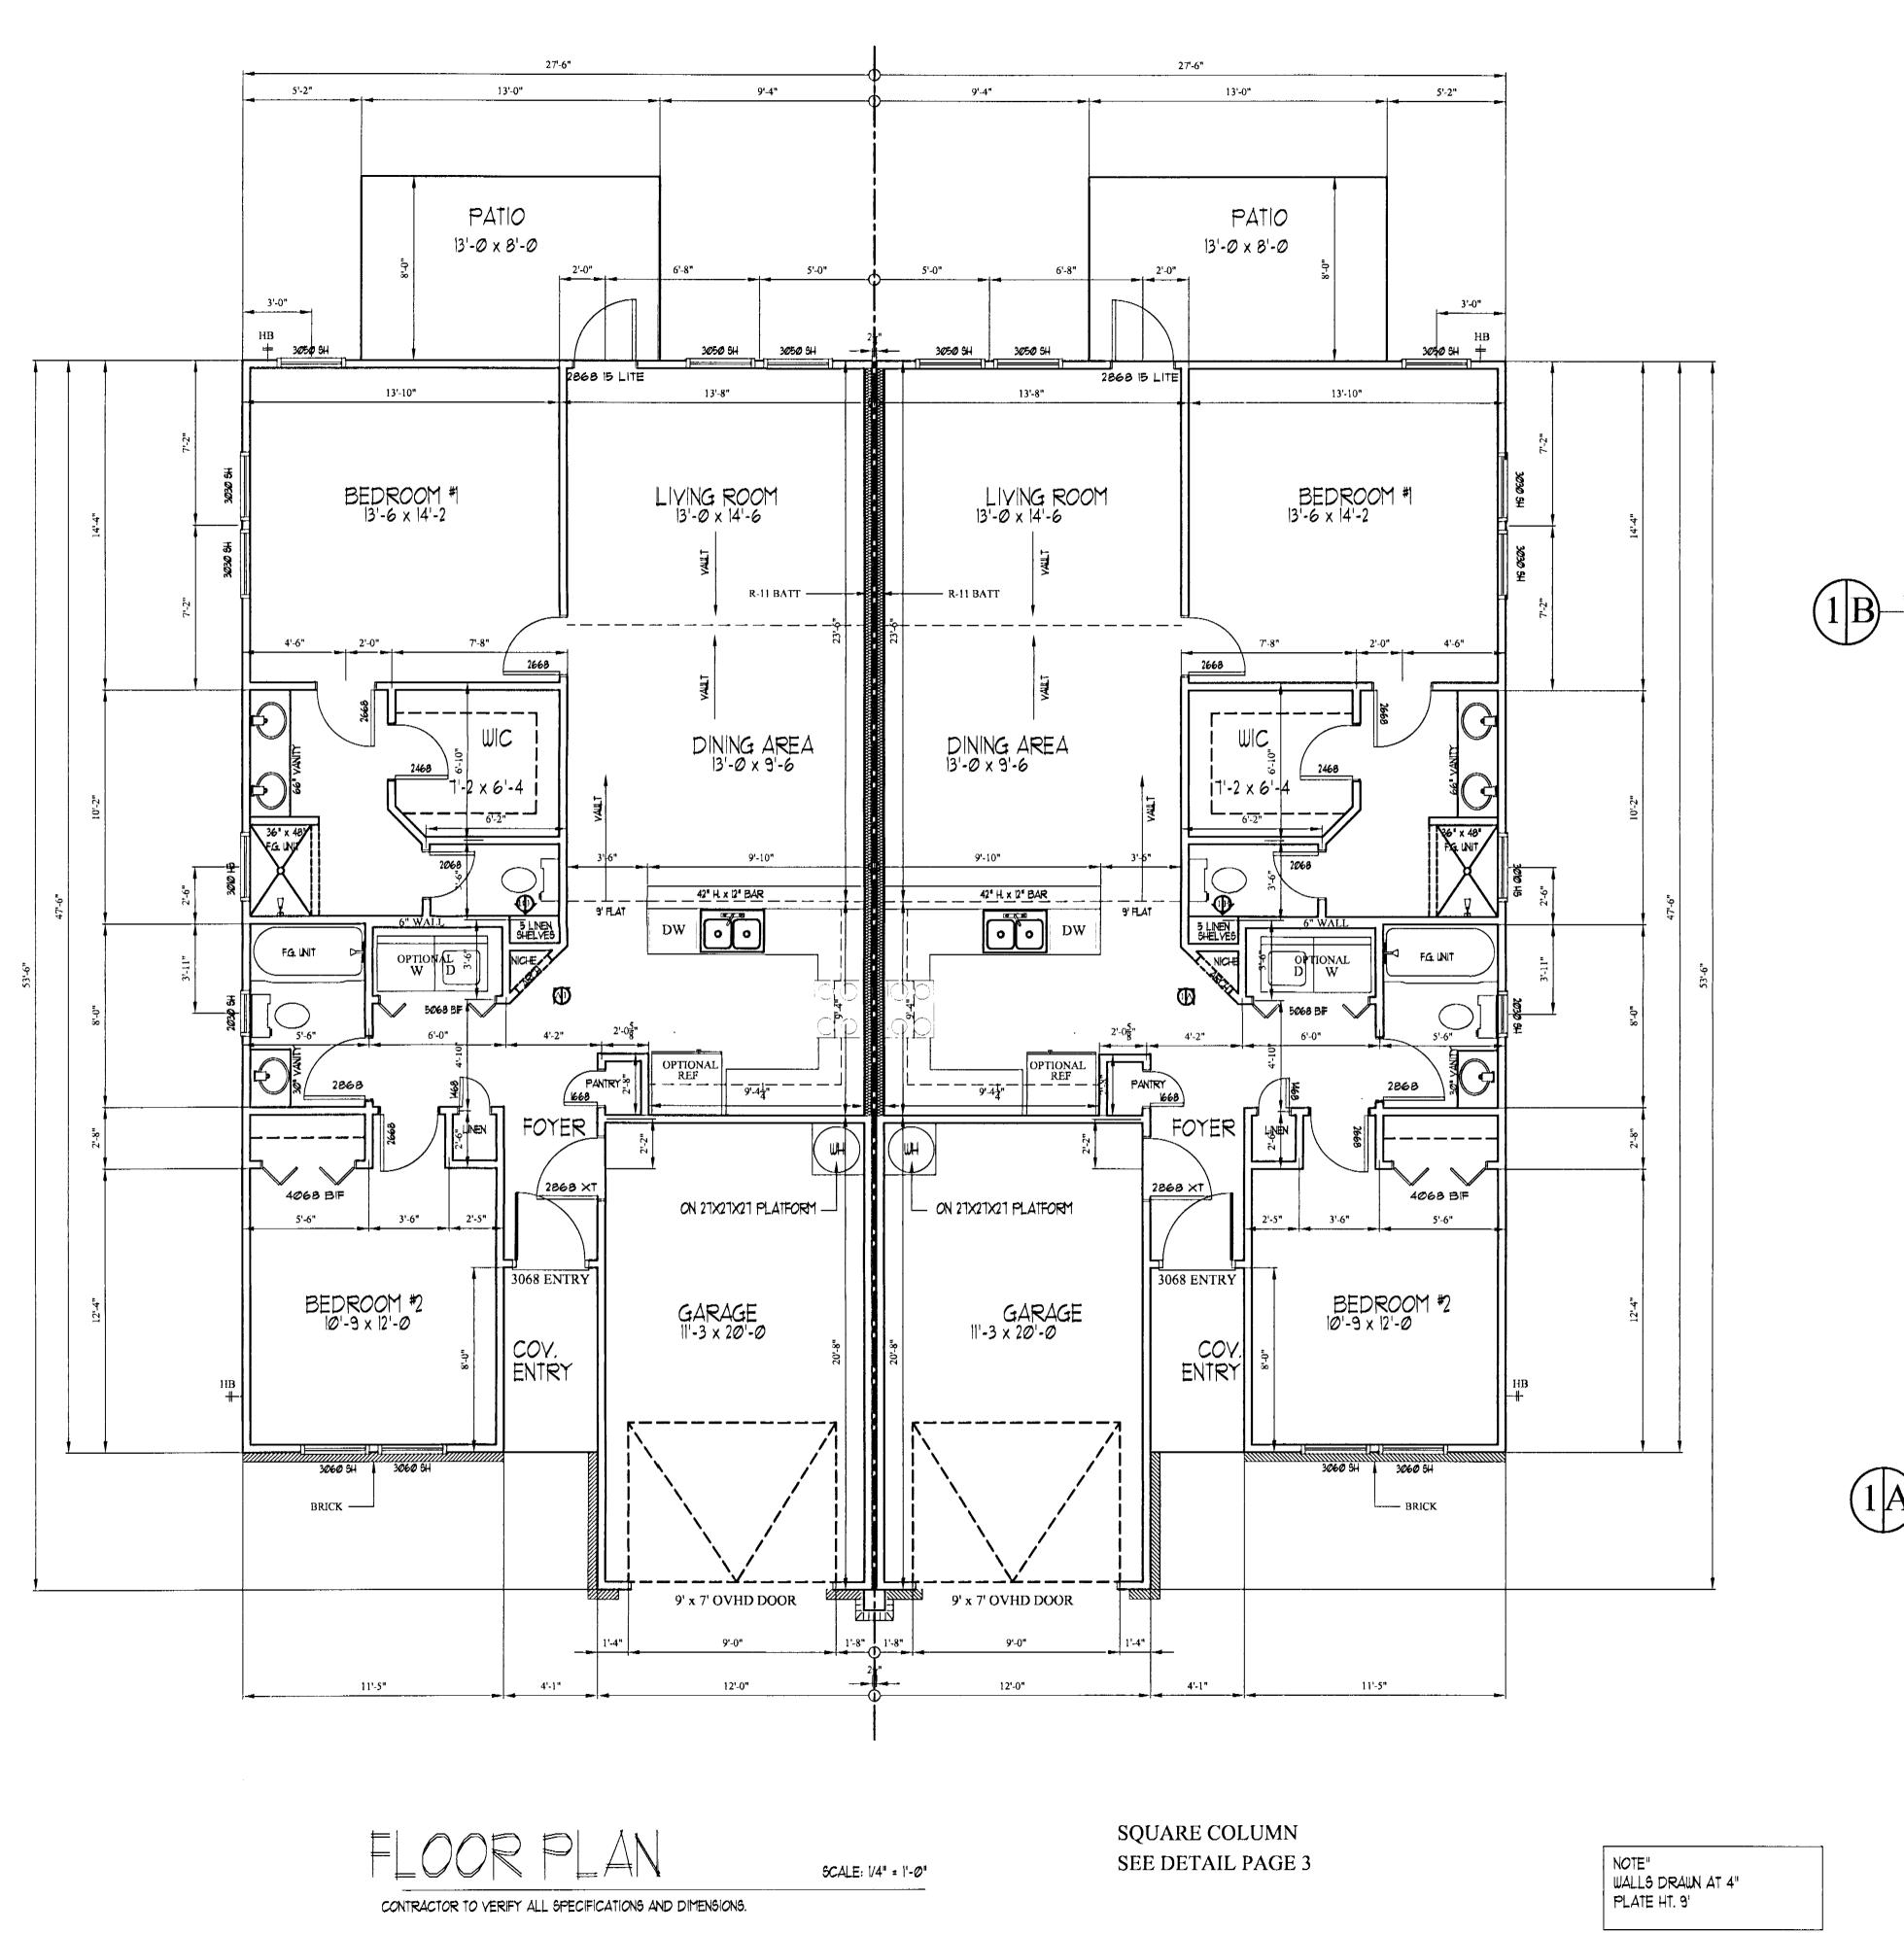


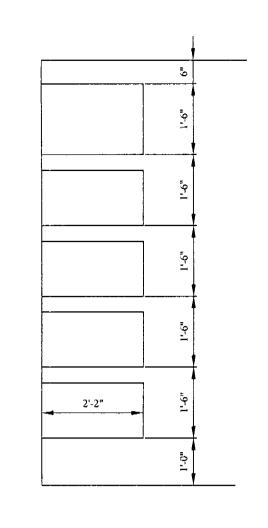


Sheet

01-26-07



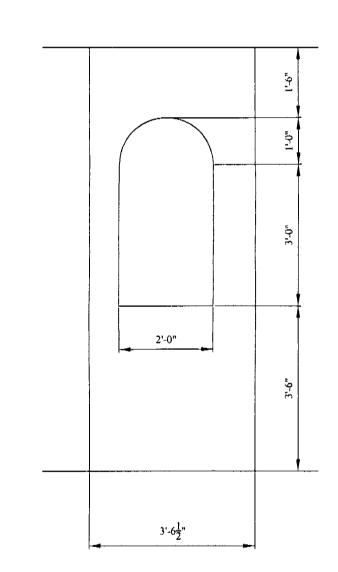


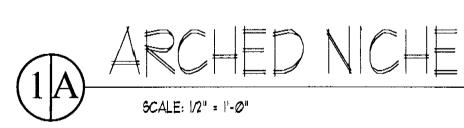



| SQUARE FOOTA PER UNIT | AGE |
|--------------------------|-------|
| H & C LIVING AREA: | 1,100 |
| FRONT PORCH | ス |

FRONT PORCH GARAGE: 241

TOTAL SQ. FT. UNDER ROOF:

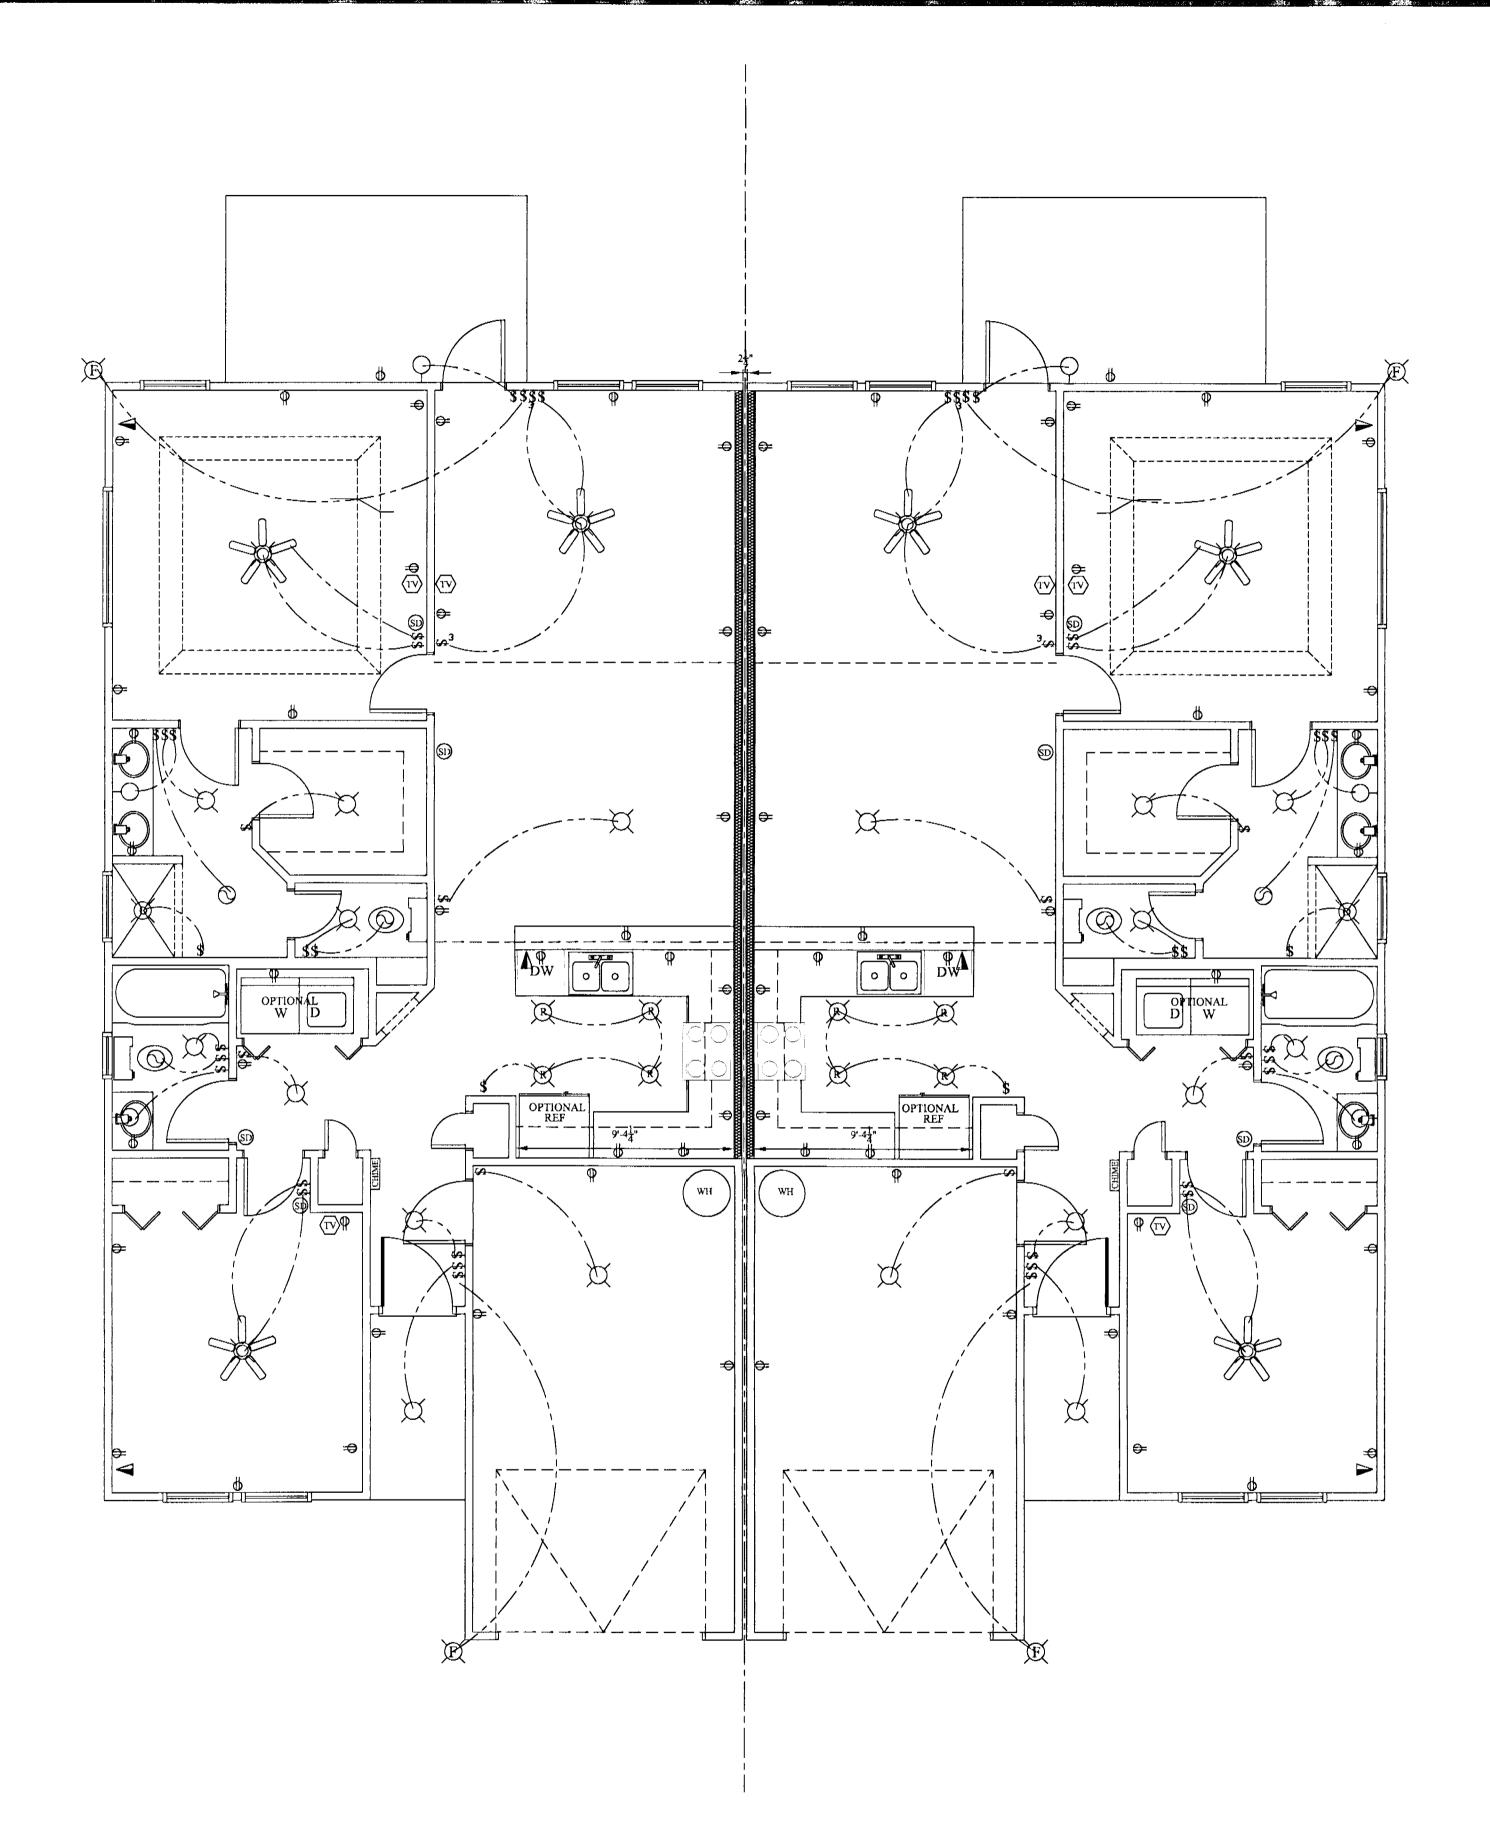

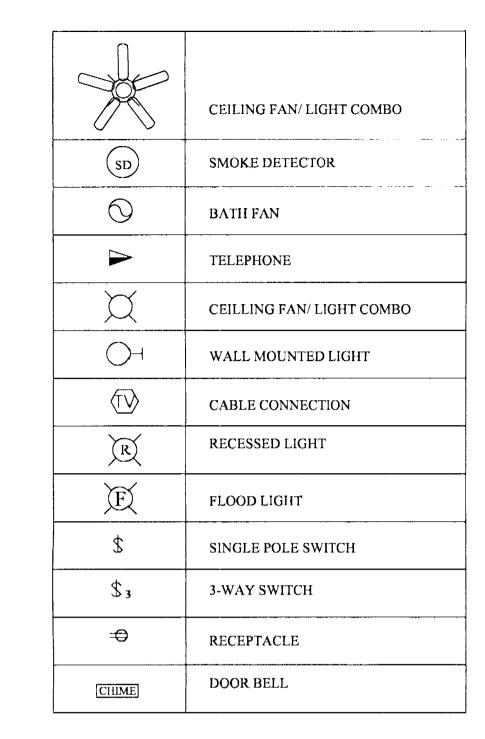


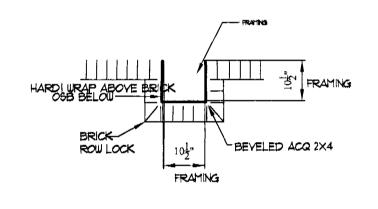


BRACKENCHASE BUILDERS BRACKEN FOR LOTS 4 45 A "BROOKE" FOR LOTS 4 45 A


01-26-07


E E C T R | C A | P | A | SCALE: 1/4" = 1'-0"

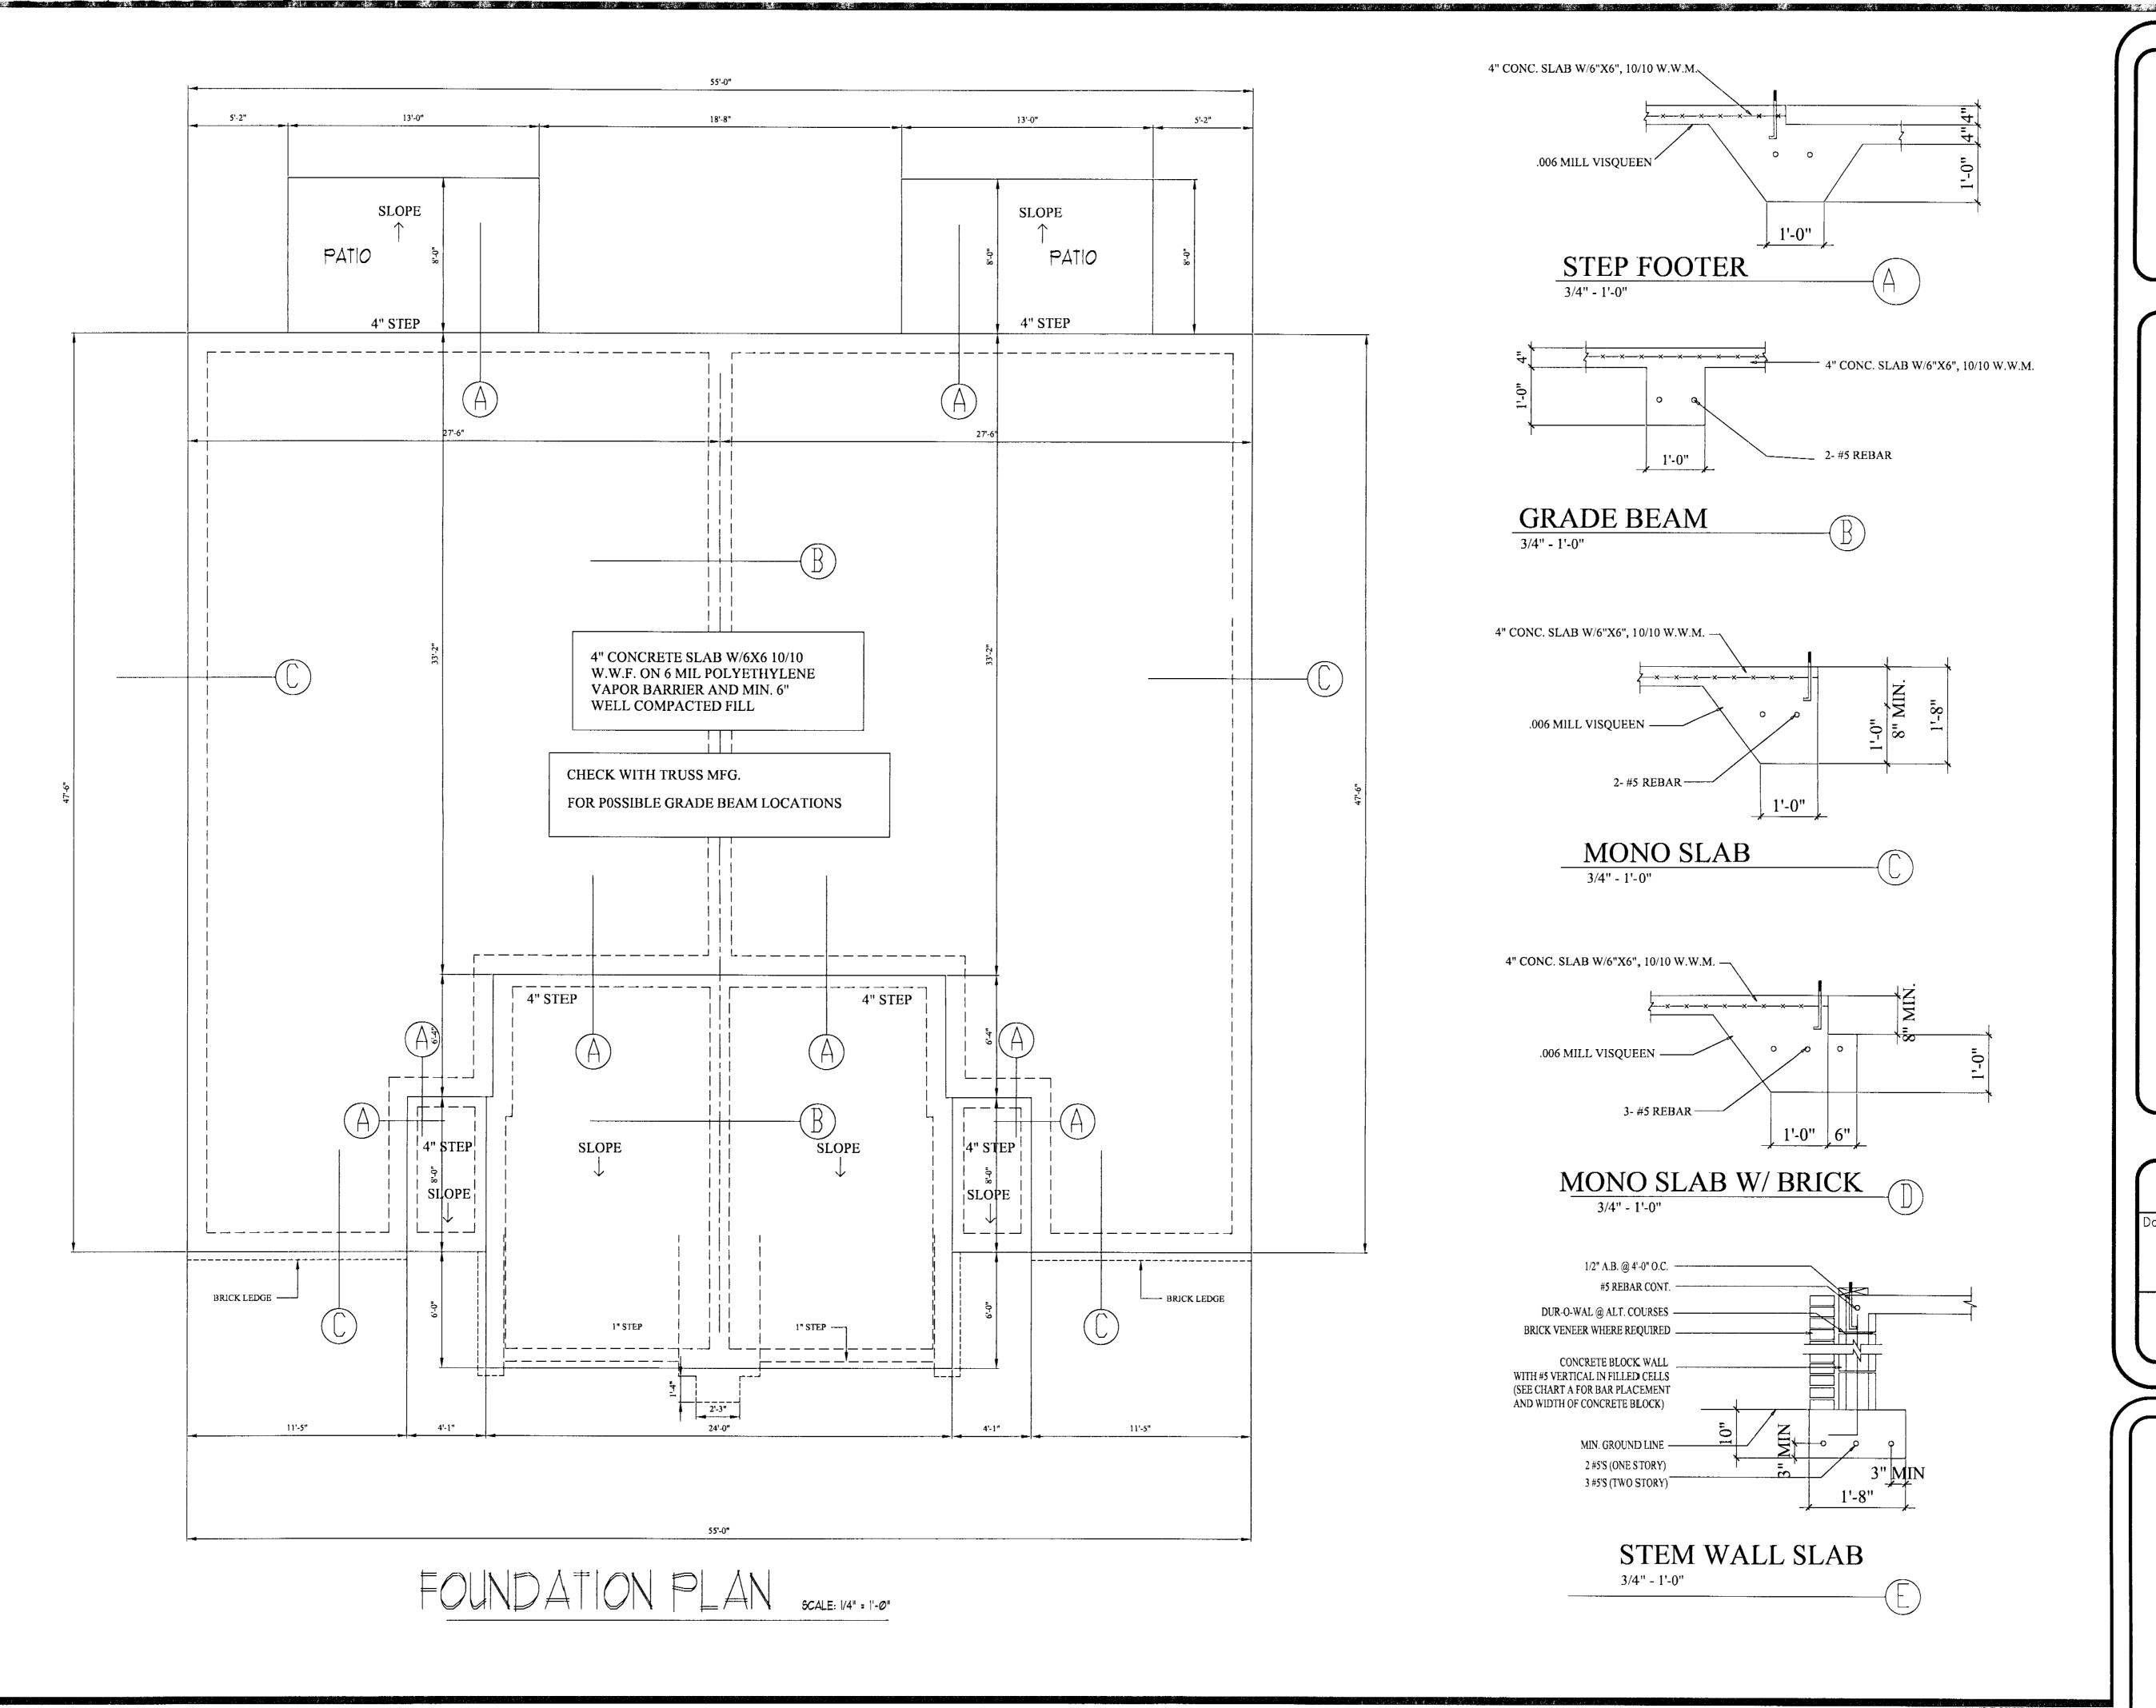



01-26-07

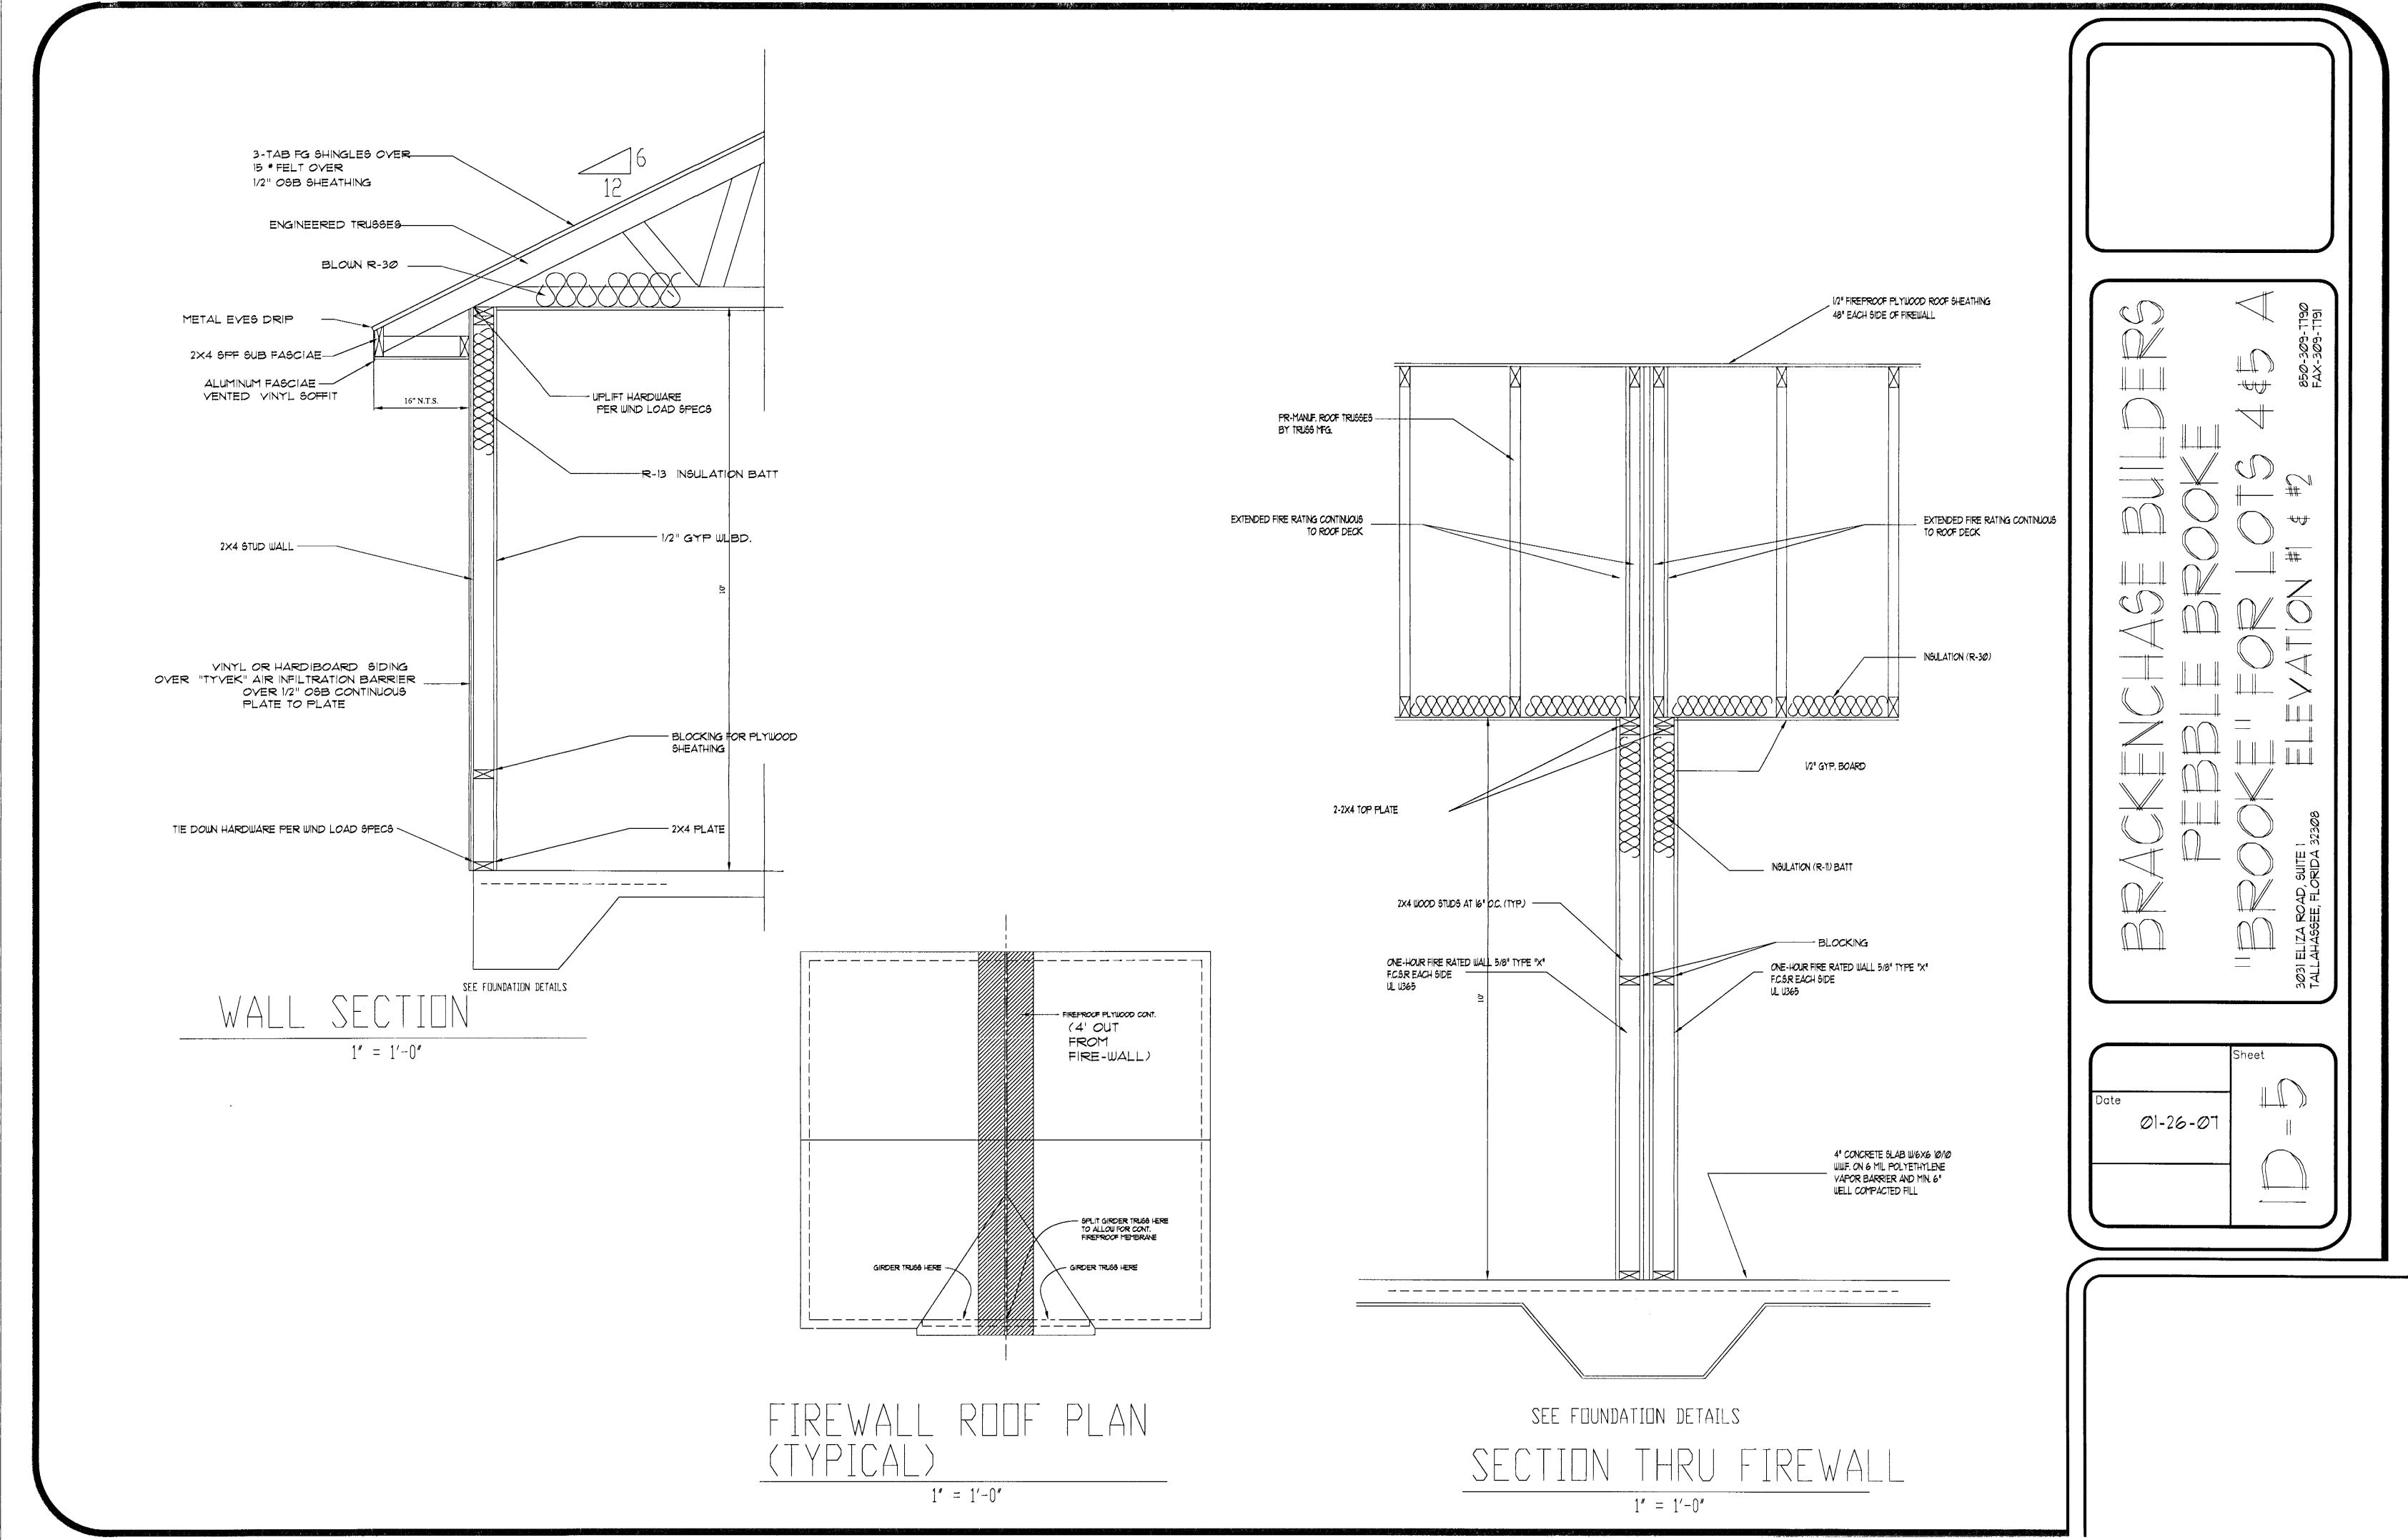


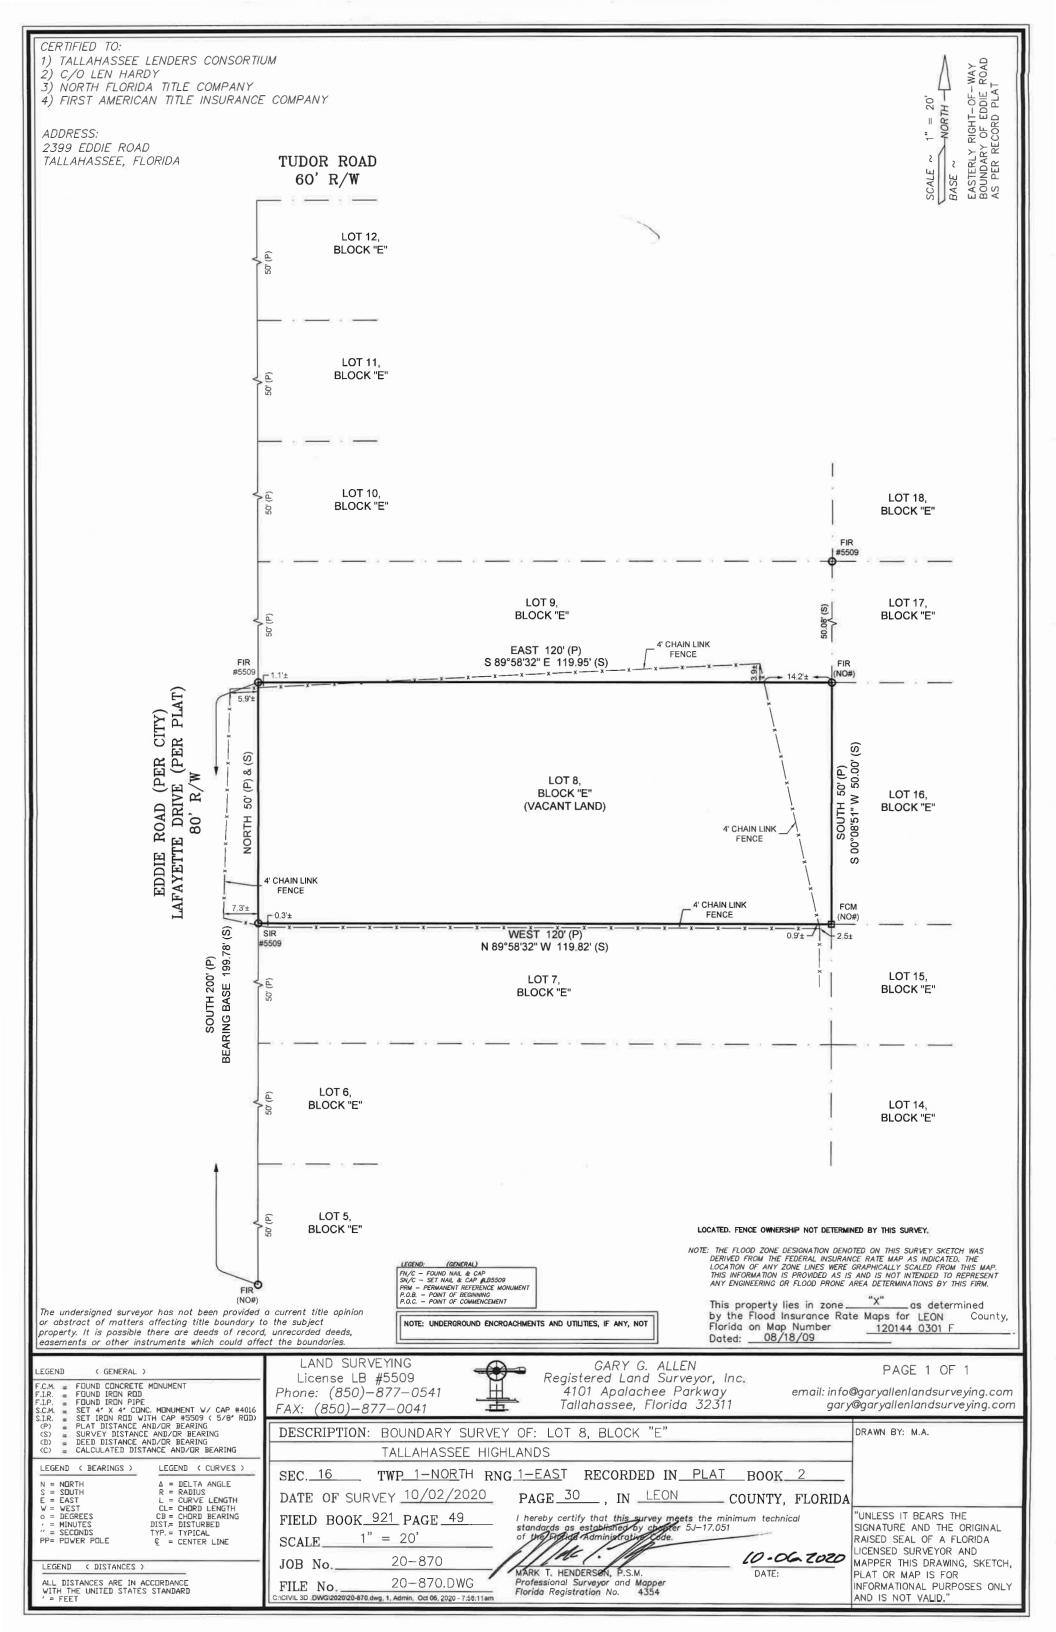

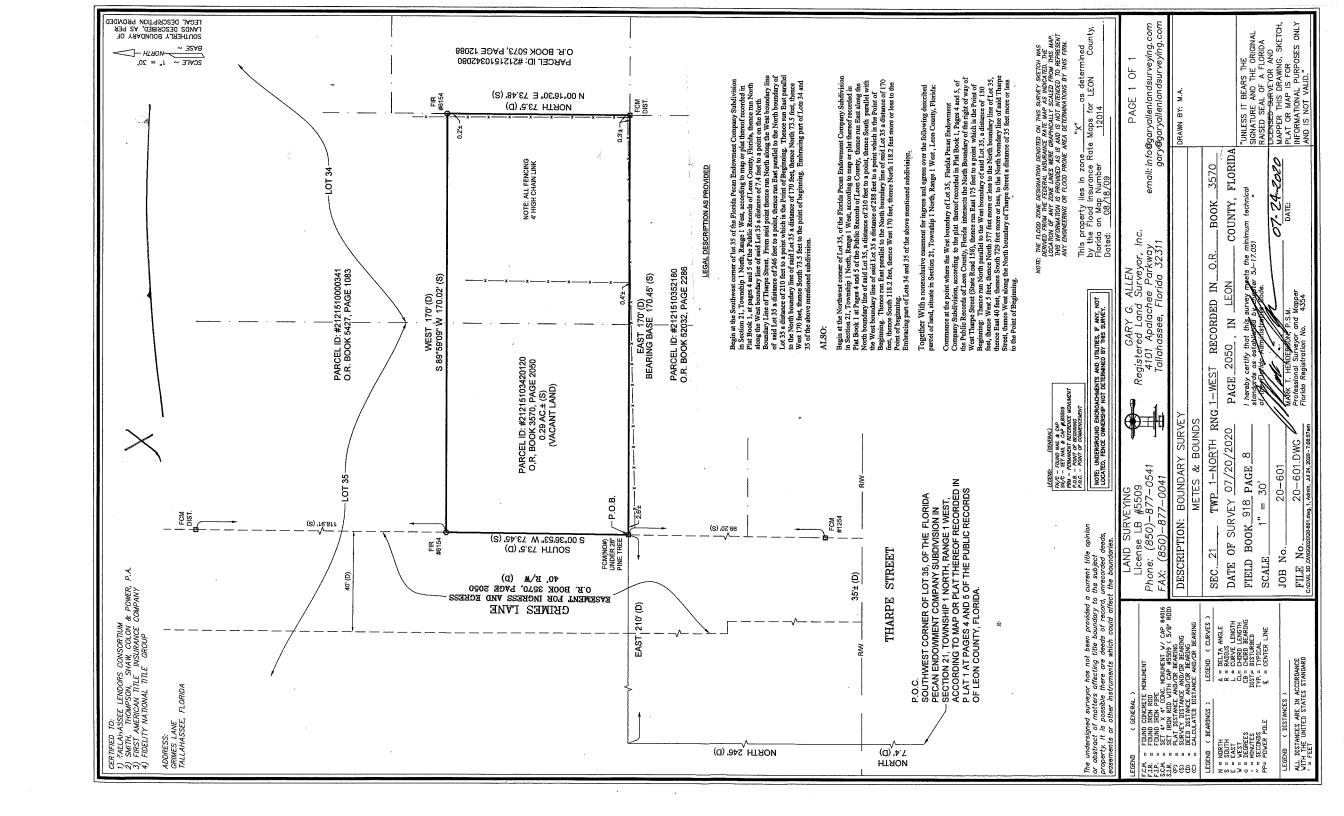

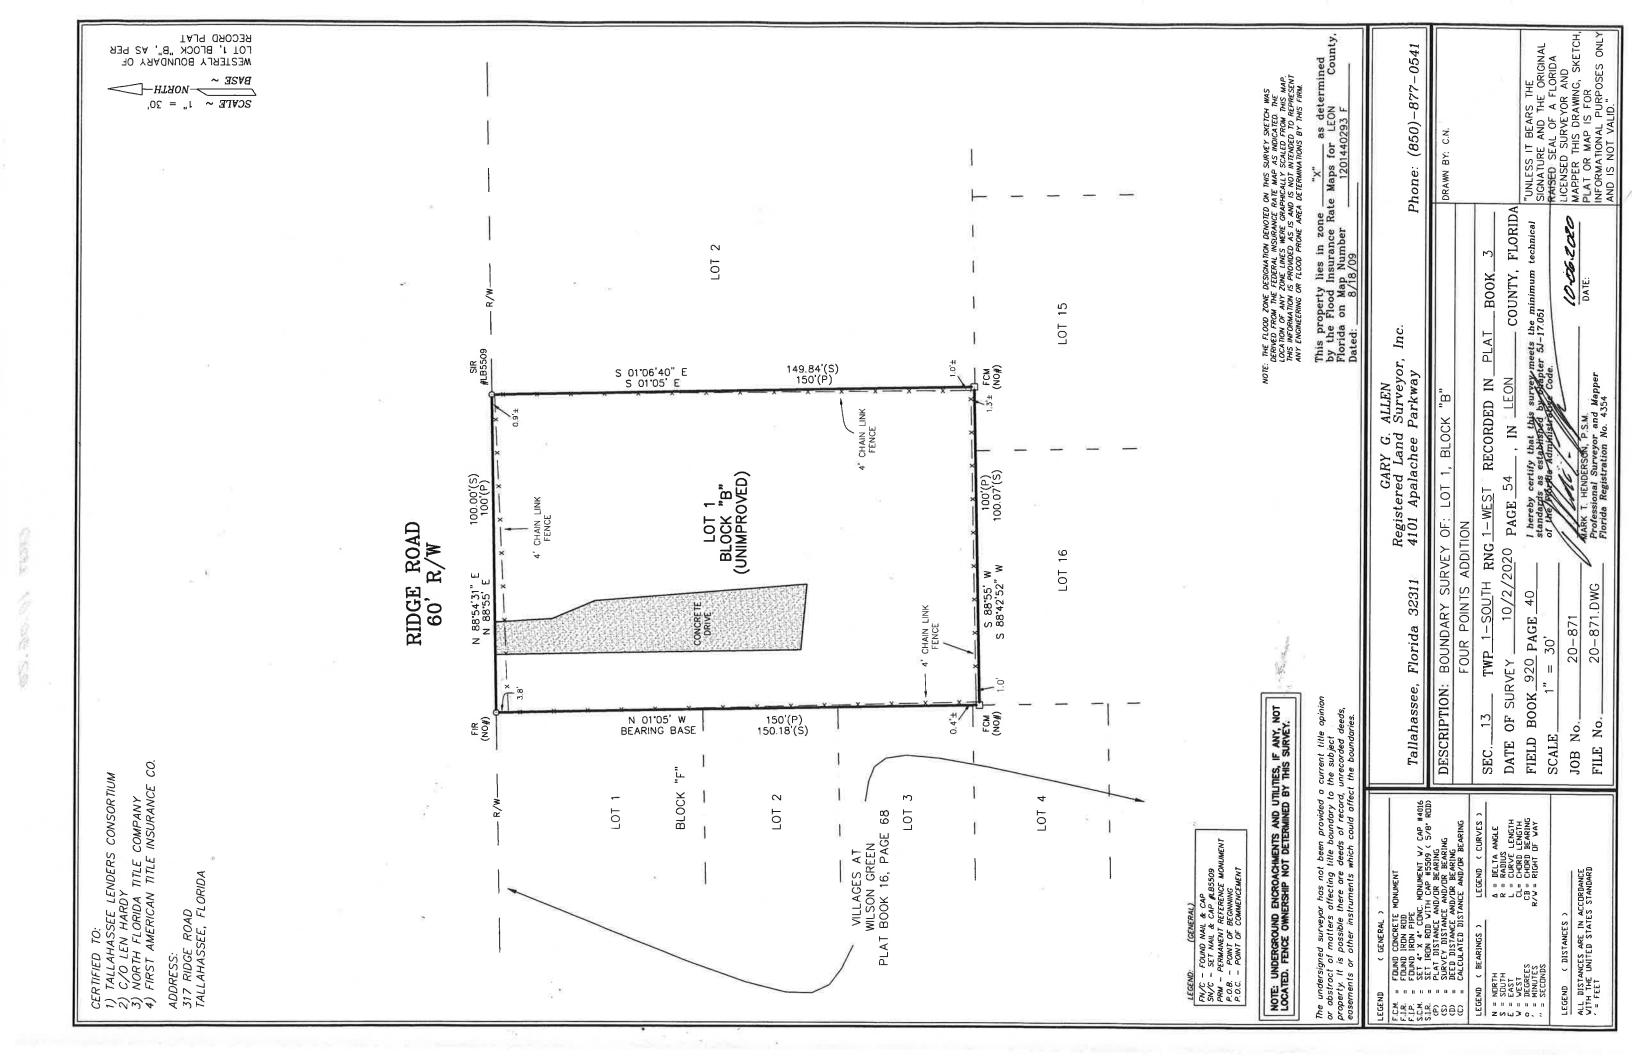

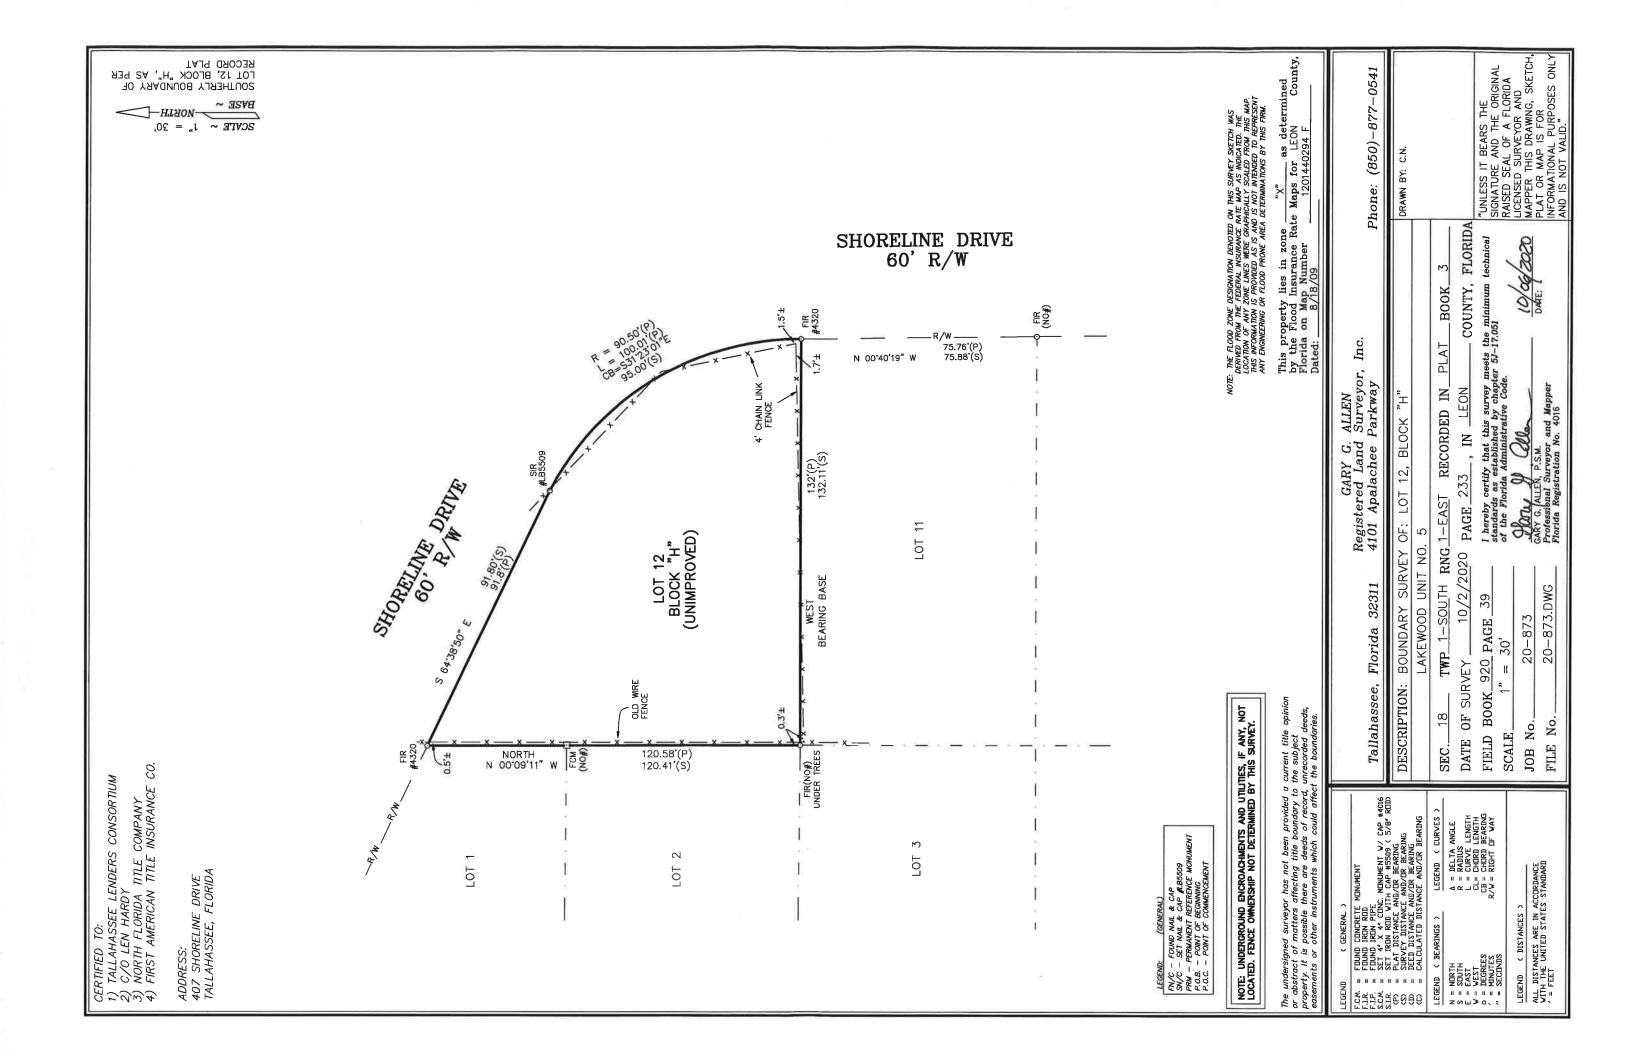

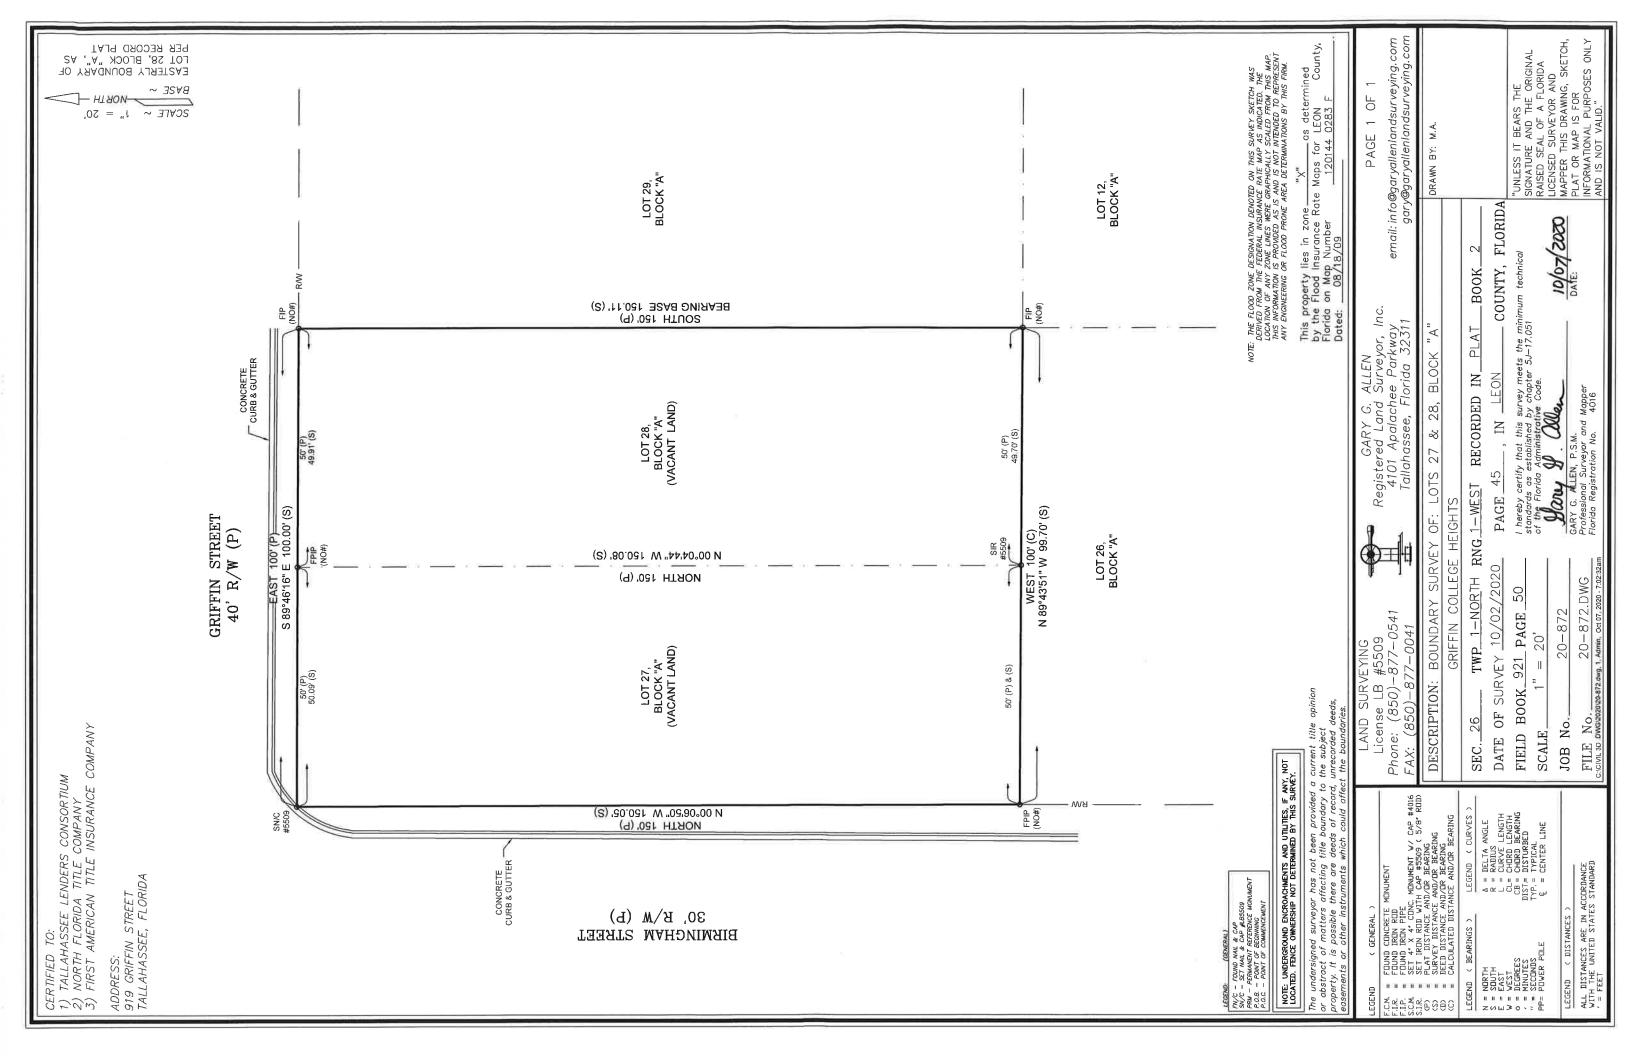

TLC Specifications / Instructions Document A1

Roof: 30 YR. ARCH. Shingle (GAF Timberline HDZ, or equivalent)

Siding: Vinyl Dutch Lap (Ply Gem Performance Collection, or equivalent)

Cornice/Fascia/Soffit: Vinyl

Windows: Pella Therma Star Single Hung (or equivalent)

Exterior Doors: Therma-Tru Fiberglass with Lite (or equivalent)

Overhead Garage Door: Pella Traditional with Auto Opener (or equivalent)

HVAC: Heat Pump Split System

Concrete Driveway: 10' x 20'

Concrete Patio: 15' x 15'

Dry Wall Finish: Veneer Plaster, Light Texture

Allowance sums are for material only. Installations, labor, and incidentals costs are included in Total Bid Sum.

- 1. Electrical lighting fixtures and/or ceiling fans: \$1,500
- 2. Plumbing fixtures and trim for the two bathrooms and kitchen: \$3,000 (Ceramic tile shower/tub hop-ups cost to be included in total bid sum)
- 3. Kitchen cabinets, counter tops, bath vanity's, medicine cabinets: \$5,500
- 4. Flooring (baths and kitchen porcelain tile, balance of house or luxury vinyl plank click lock): \$4,000
- 5. Appliances: \$3,000
- 6. Window coverings: \$500
- 7. Site preparation (clear, grade, fill) for placement of monolithic slab foundation: \$1,000