


WATER TANK X-SECTION

EROSION CONTROL NOTES

MEASURES.

- ROOF TO DRAIN INTO DOWNSPOUTS ONTO SPLASH BLOCKS. -GRADE LOT TO PROVIDE FOR RUNOFF TO STREET. -HOSES TO BE EQUIPPED WITH SHUT OFF NOZZLES. -SITE RUNOFF TO BE CONTROLLED DURING CONSTRUCTION BY THE INSTALLATION OF WATTLES OR EQUIVALENT

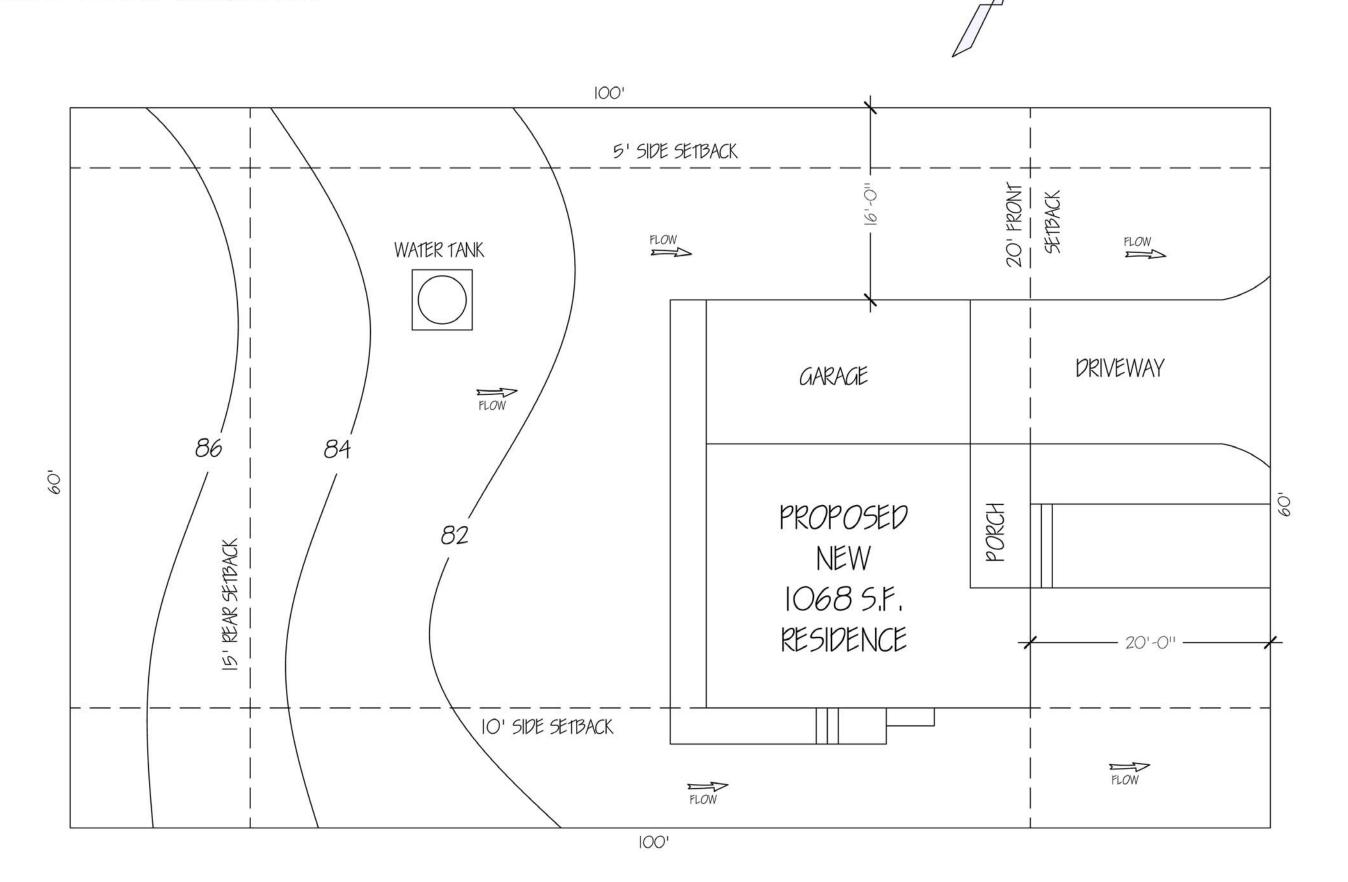

PLOT PLAN

SCALE/8" = 1'

SCOPE OF PROJECT

BUILD 1008 S.F. RESIDENCE WITH 264 S.F. GARAGE ON CURRENTLY VACANT 100' X 60' LOT.

PROJECT INCLUDES ONE FULL AND ONE HALF BATHROOM, WASHER AND KITCHEN SINK.

DESIGNER:

DESIGNER'S NAME

PHONE NUMBER

CITY, STATE, ZIP CODE

TOTAL GROUND COVERAGE = 858 S.F.

TOTAL PAVED AREA = 604 S.F.

TOTAL IMPERMEABLE SURFACE = 1462

EXPRESSED AS PERCENTAGE = 24% OF LOT.

PROJECT TO BE FIRE SPRINKLERED

000-000-00

CONTACT INFO

OWNER:

WINNIE AND BOB OWNER STREET ADDRESS

CITY, STATE ZIP CODE

PHONE NUMBER

ENGINEER: ENGINEER'S NAME

CITY, STATE, ZIP CODE PHONE NUMBER

TABLE OF CONTENTS

PAGE I: PLOT PLAN/ EROSION CONTROL/ VICINTY MAP

PAGE 2: FLOOR PLANS AND ELECTRICAL PLAN

PAGE 3: ELEVATIONS

PAGE 4: FOUNDATION PLAN AND DETAILS

PAGE 5: FLOOR FRAME, ROOF FRAME PLANS

PAGE 6: CROSS SECTION AND DETAILS

PAGE 7: DETAILS AND WINDOW SCHEDULE

PAGE 8: SHEER PLAN AND ENGINEERING DETAILS


PAGE 9: NOTES AND ENERGY CALCS

REVISION

PLOTPLAN SCOPE AND CONTENTS

DRAWN BY JAMES BEEBE PROJECT 1000001 20AUG25 SEE VIEW

PAGE NO.

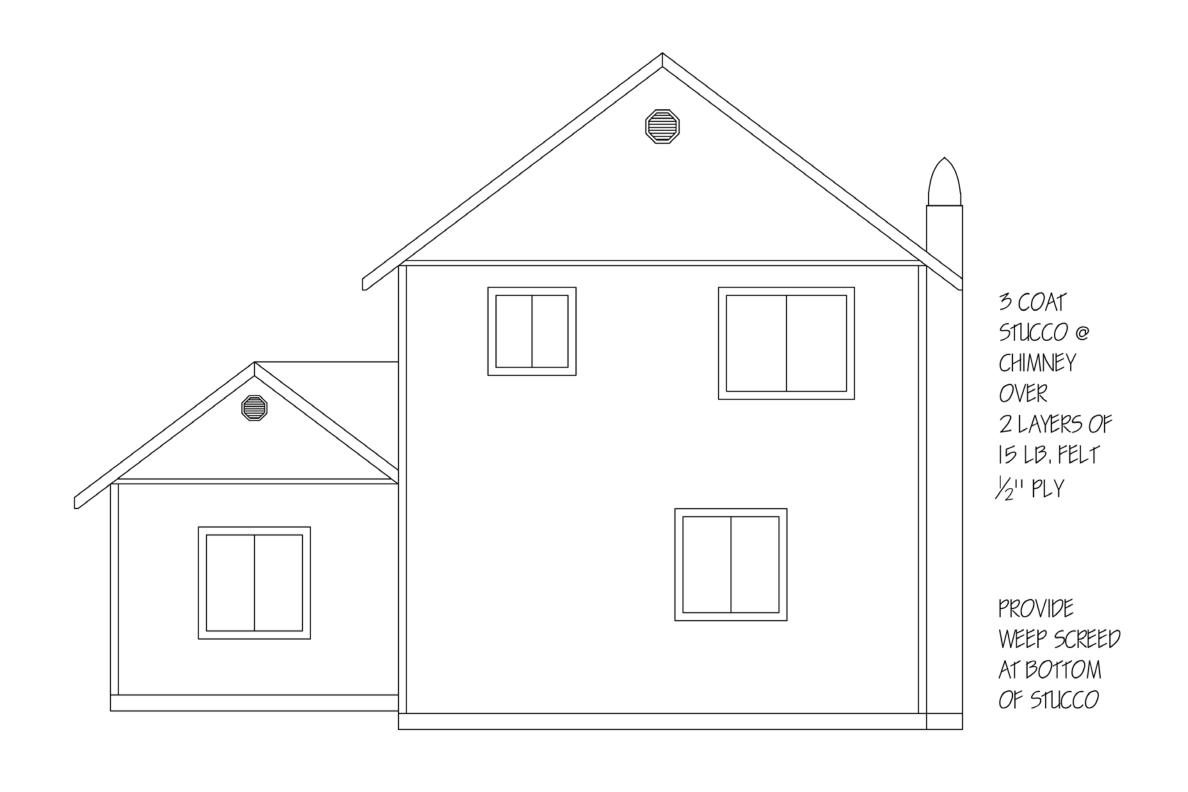

STUCCO CHIMNEY CHASE THREE TAB COMPOSITION ROOFING IX8CEDAR DROP SIDING

EAST ELEVATION

SCALE 1/4" = 1"

WEST ELEVATION

SCALE 1/4" = 1'

SOUTH ELEVATION

SCALE 1/4" = 1"

NORTH ELEVATION

SCALE 1/4" = 1'

REVISION DATE

ELEVATIONS


PRAWN BY JAMES BEEBE

PROJECT 1000001

PATE 20AUG25

SCALE $\frac{1}{4}$ | = | 1


PAGE NO.

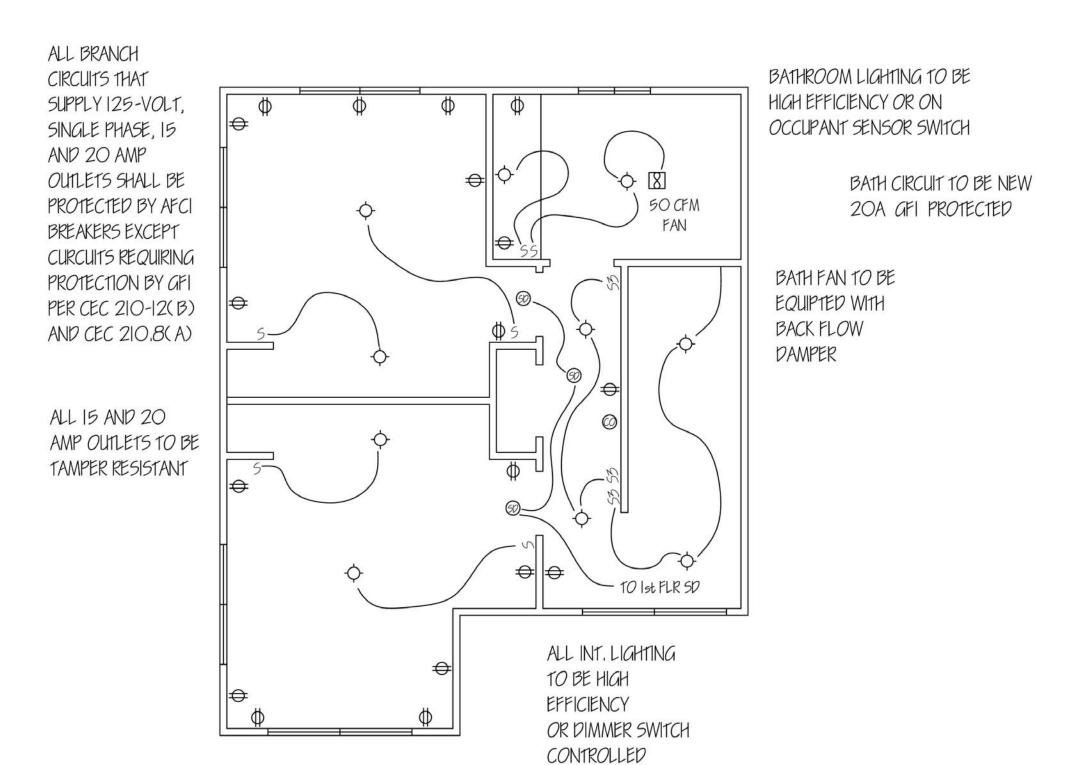

2ND STORY ELECTRICAL PLAN

SCALE 1/4" = 1'

SCALE 1/4" = 1'

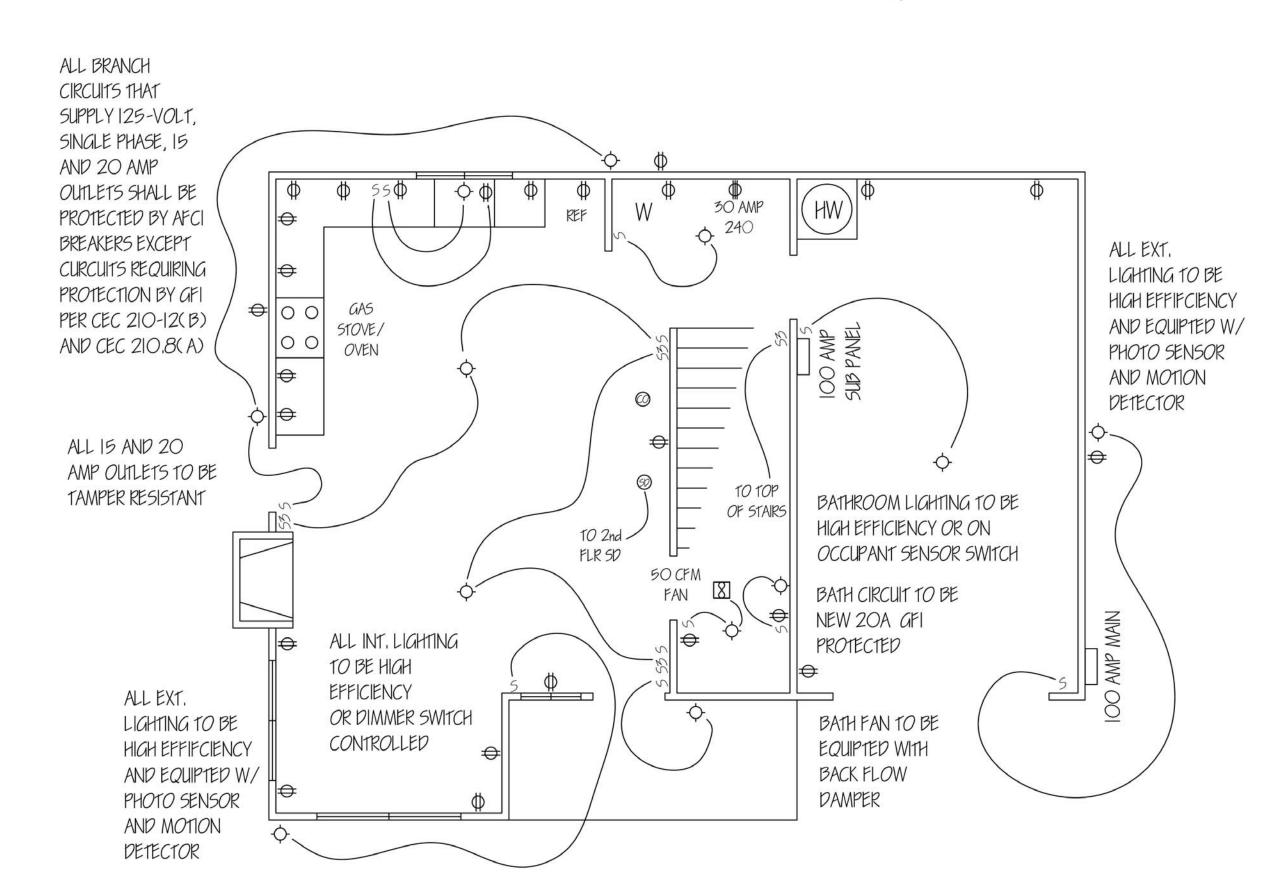

FIRST STORY ELECTRICAL PLAN

FIRST STORY FLOOR PLAN

SCALE 1/4" = 1'


5-0 X 4-0 SLD

5-0 X 5-0 SLD

5-0 X

2ND STORY FLOOR PLAN

SCALE 1/4" = 1'

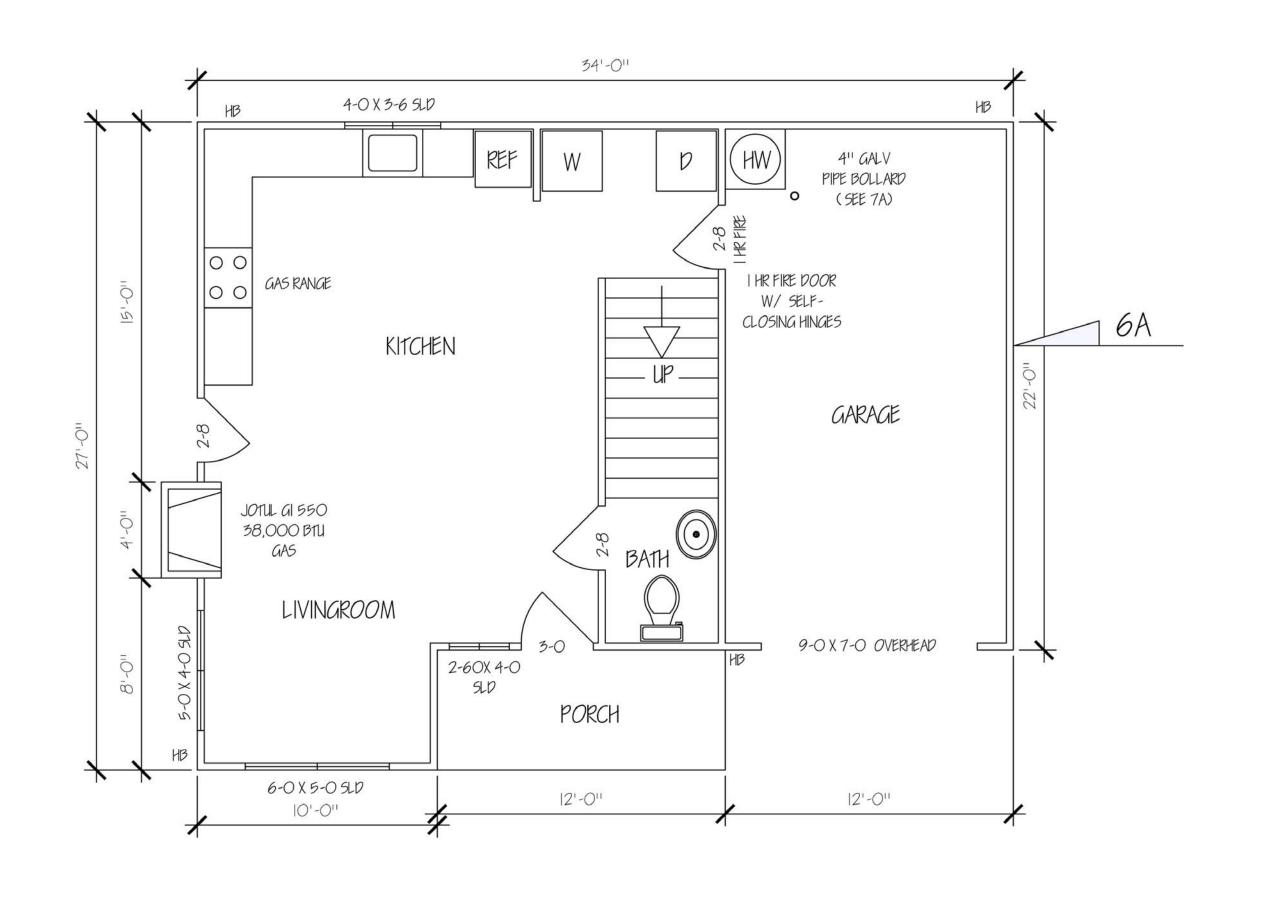

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WINNIE AND BOB ANYONE
IOOO PARADISE AVE
ANYOMI CA 99999

IO. REVISION DATE


FLOOR PLANS AND ELECTRICAL PLAN

DRAWN BY JAMES BEEBE PROJECT 1000001

DATE 20AUG25


SCALE $\frac{1}{4}$ = 1'
PAGE NO.

= | '

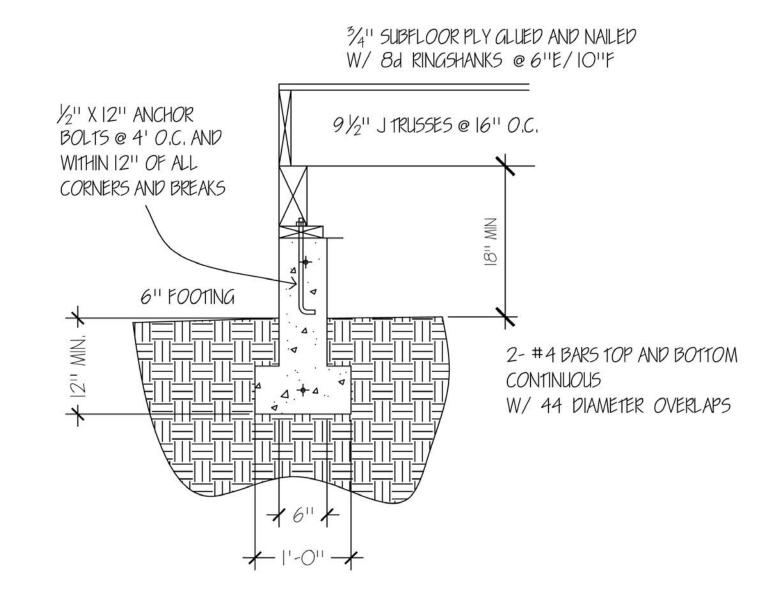

DETAIL 4B


SCALE I'' =

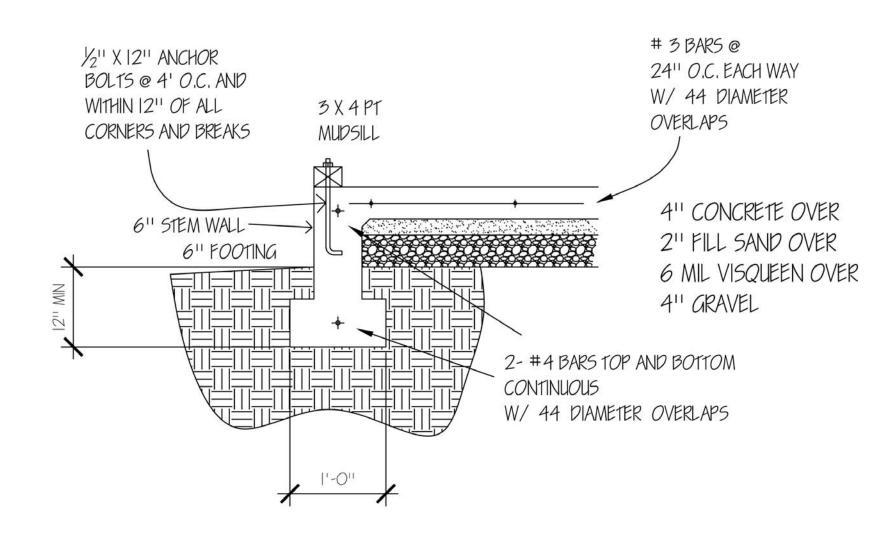

SCALE | | = |

DETAIL 4C


3/4" SUBFLOOR PLY GLUED AND NAILED W/ 8d RINGSHANKS @ 6"E/10"F

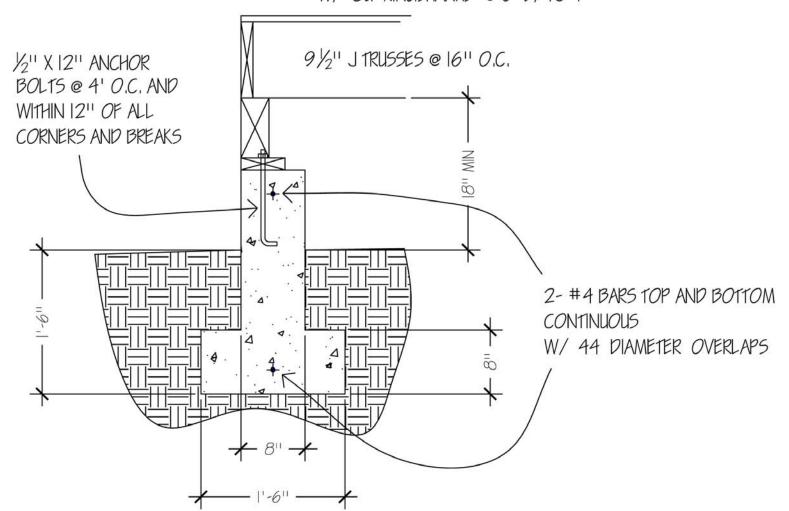

DETAIL 4A

SCALE | " = |

PROVIDE FINISHED GRADE OF 2% FOR 5 FT SLOPED AWAY FROM FOUNDATION

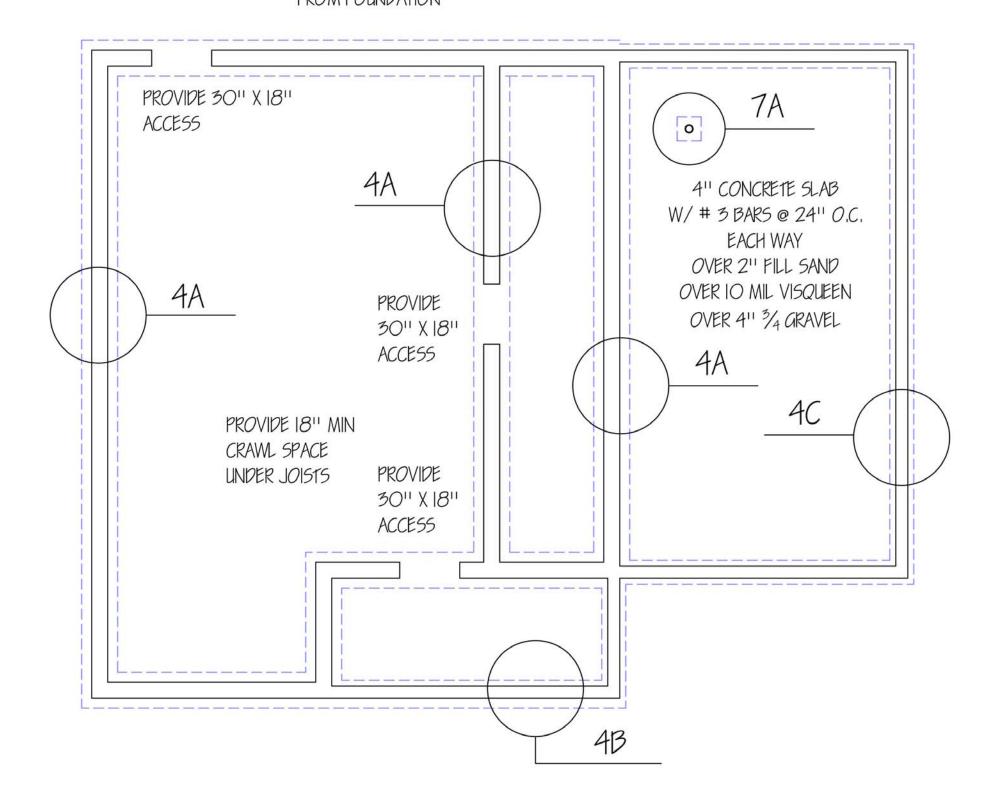

FOUNDATION PLAN

SCALE 1/4" = 1'

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O, REVISION DATE

FOUNDATION PLAN &


DETAILS


PROJECT 1000001

PATE 20AUG25

SCALE 1/411 = 11


PAGE NO.

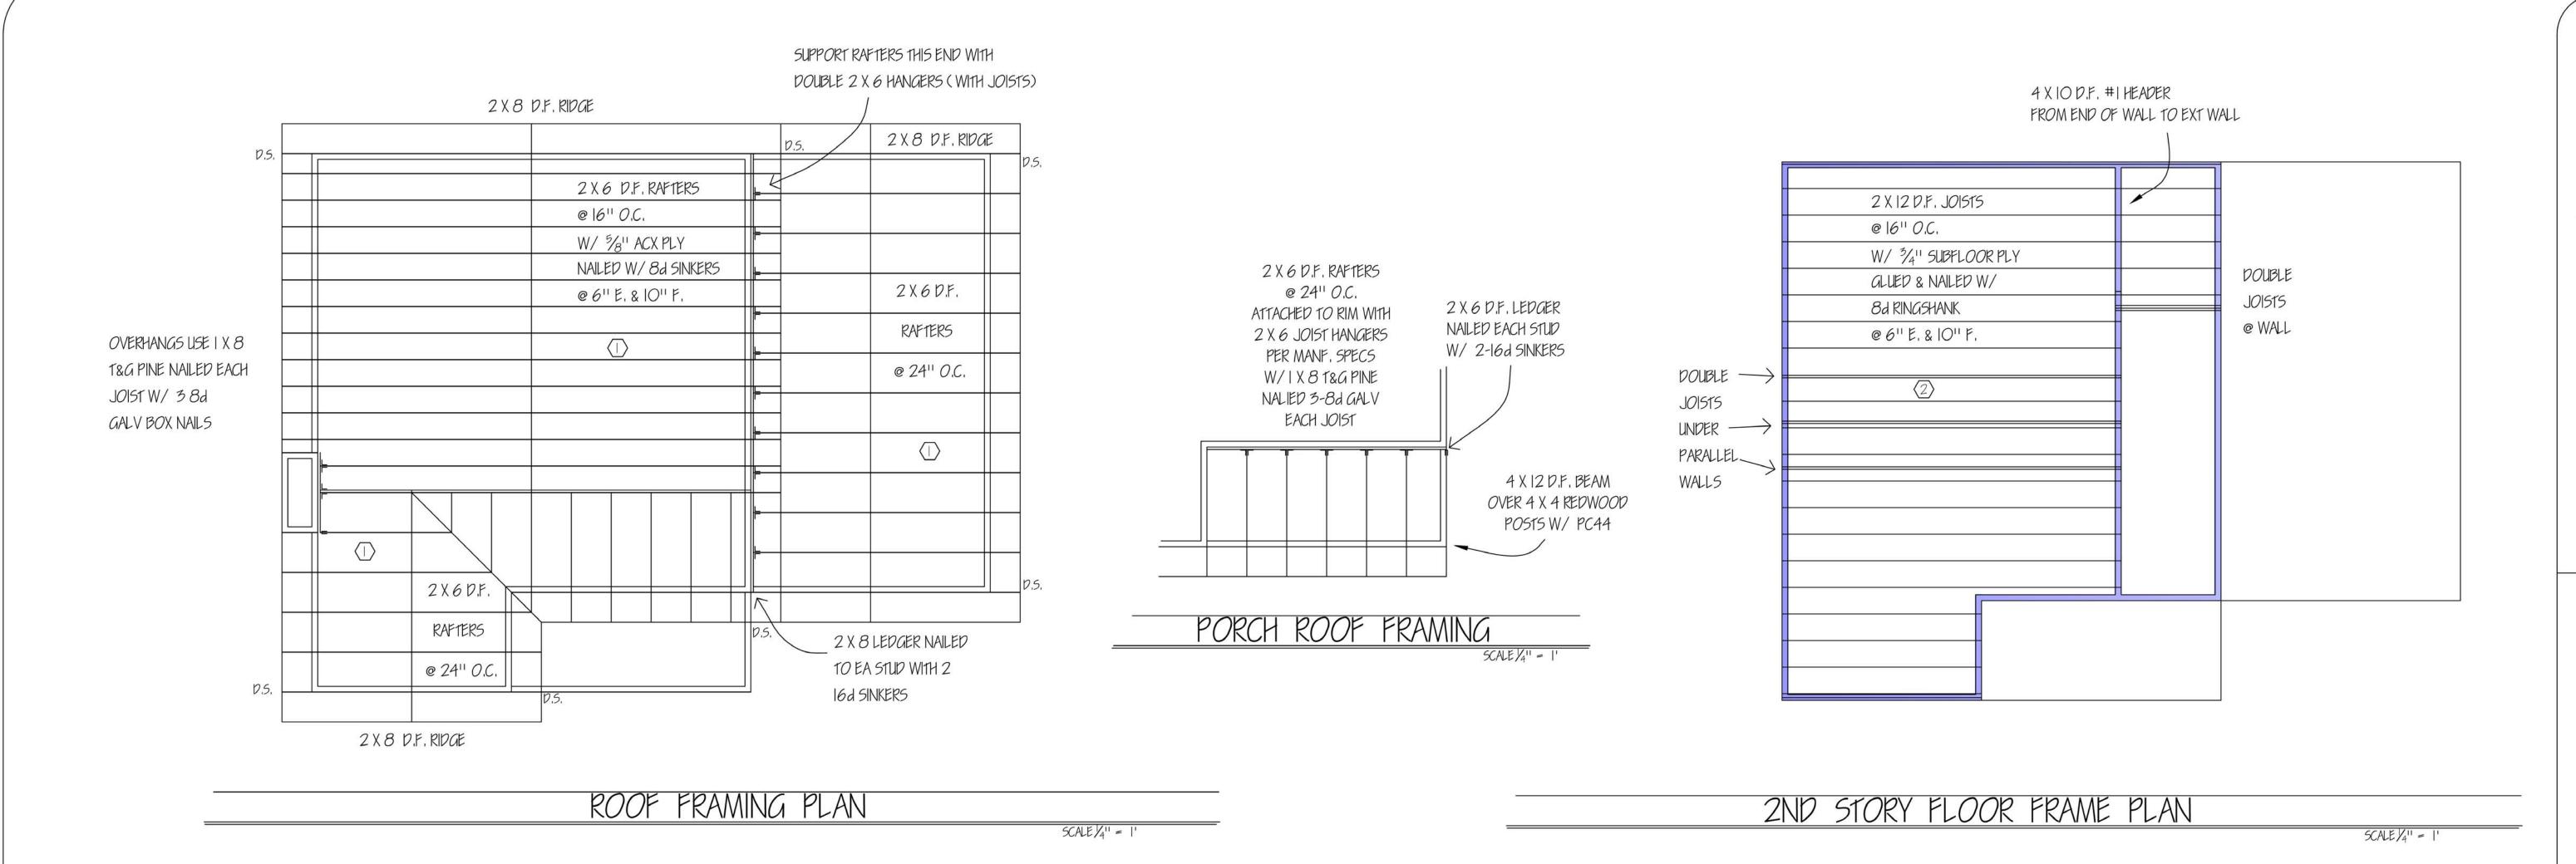


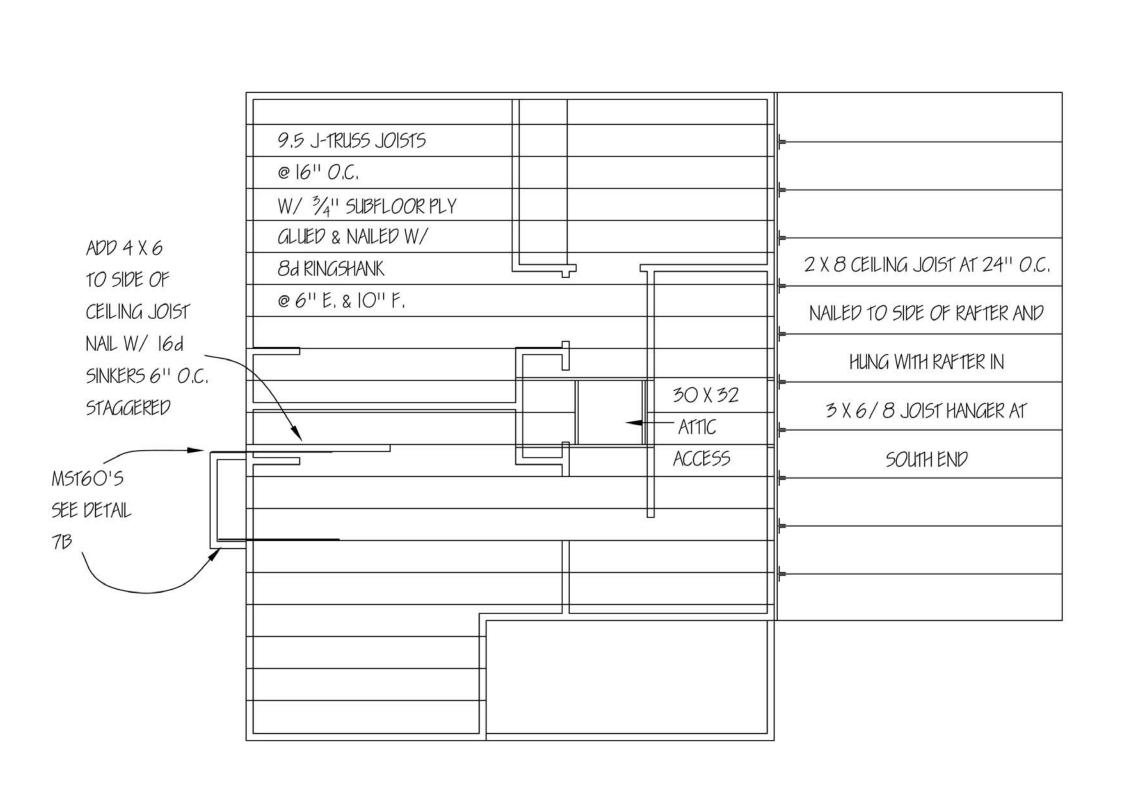

CEILING FRAMING PLAN

SCALE 1/4" = 1'

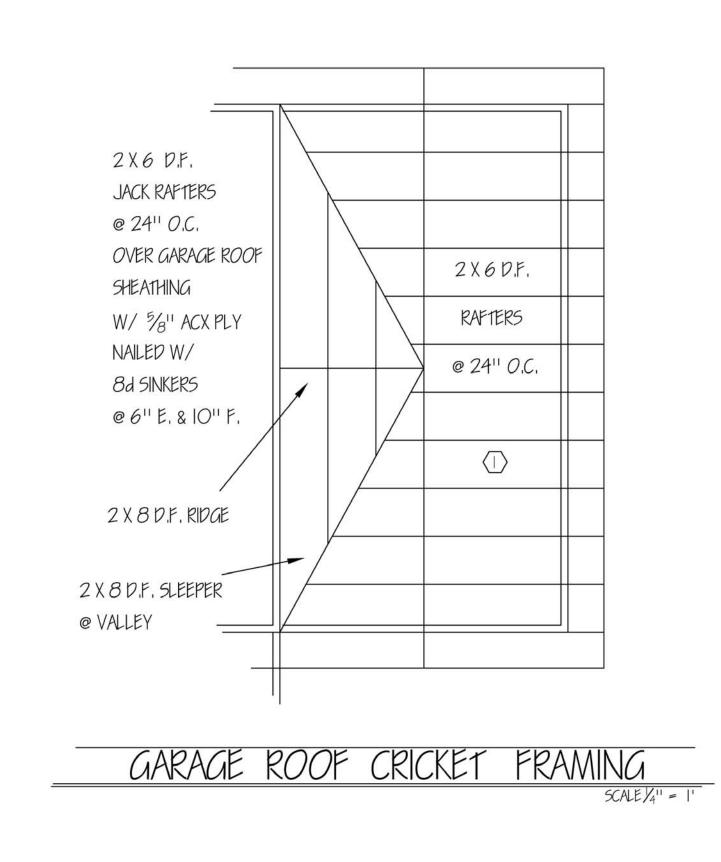

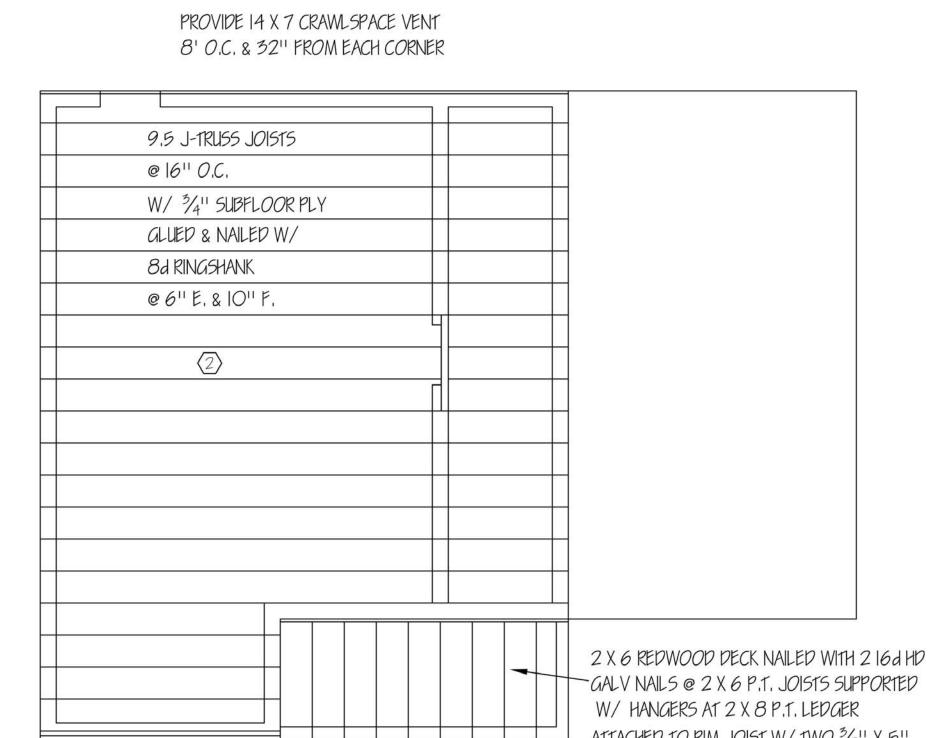

GALV NAILS @ 2 X 6 P.T. JOISTS SUPPORTED ATTACHED TO RIM JOIST W/ TWO 3/8" X 5" GALV. LAG BOLTS @ 16" O.C.

FIRST STORY FLOOR FRAME PLAN


SCALE 1/4" = 1'

DATE REVISION FLOOR / CEILING

ROOF FRAMING

DRAWN BY JAMES BEEBE PROJECT 1000001 DATE 20AUG25

SCALE 1/411 = 11 PAGE NO.

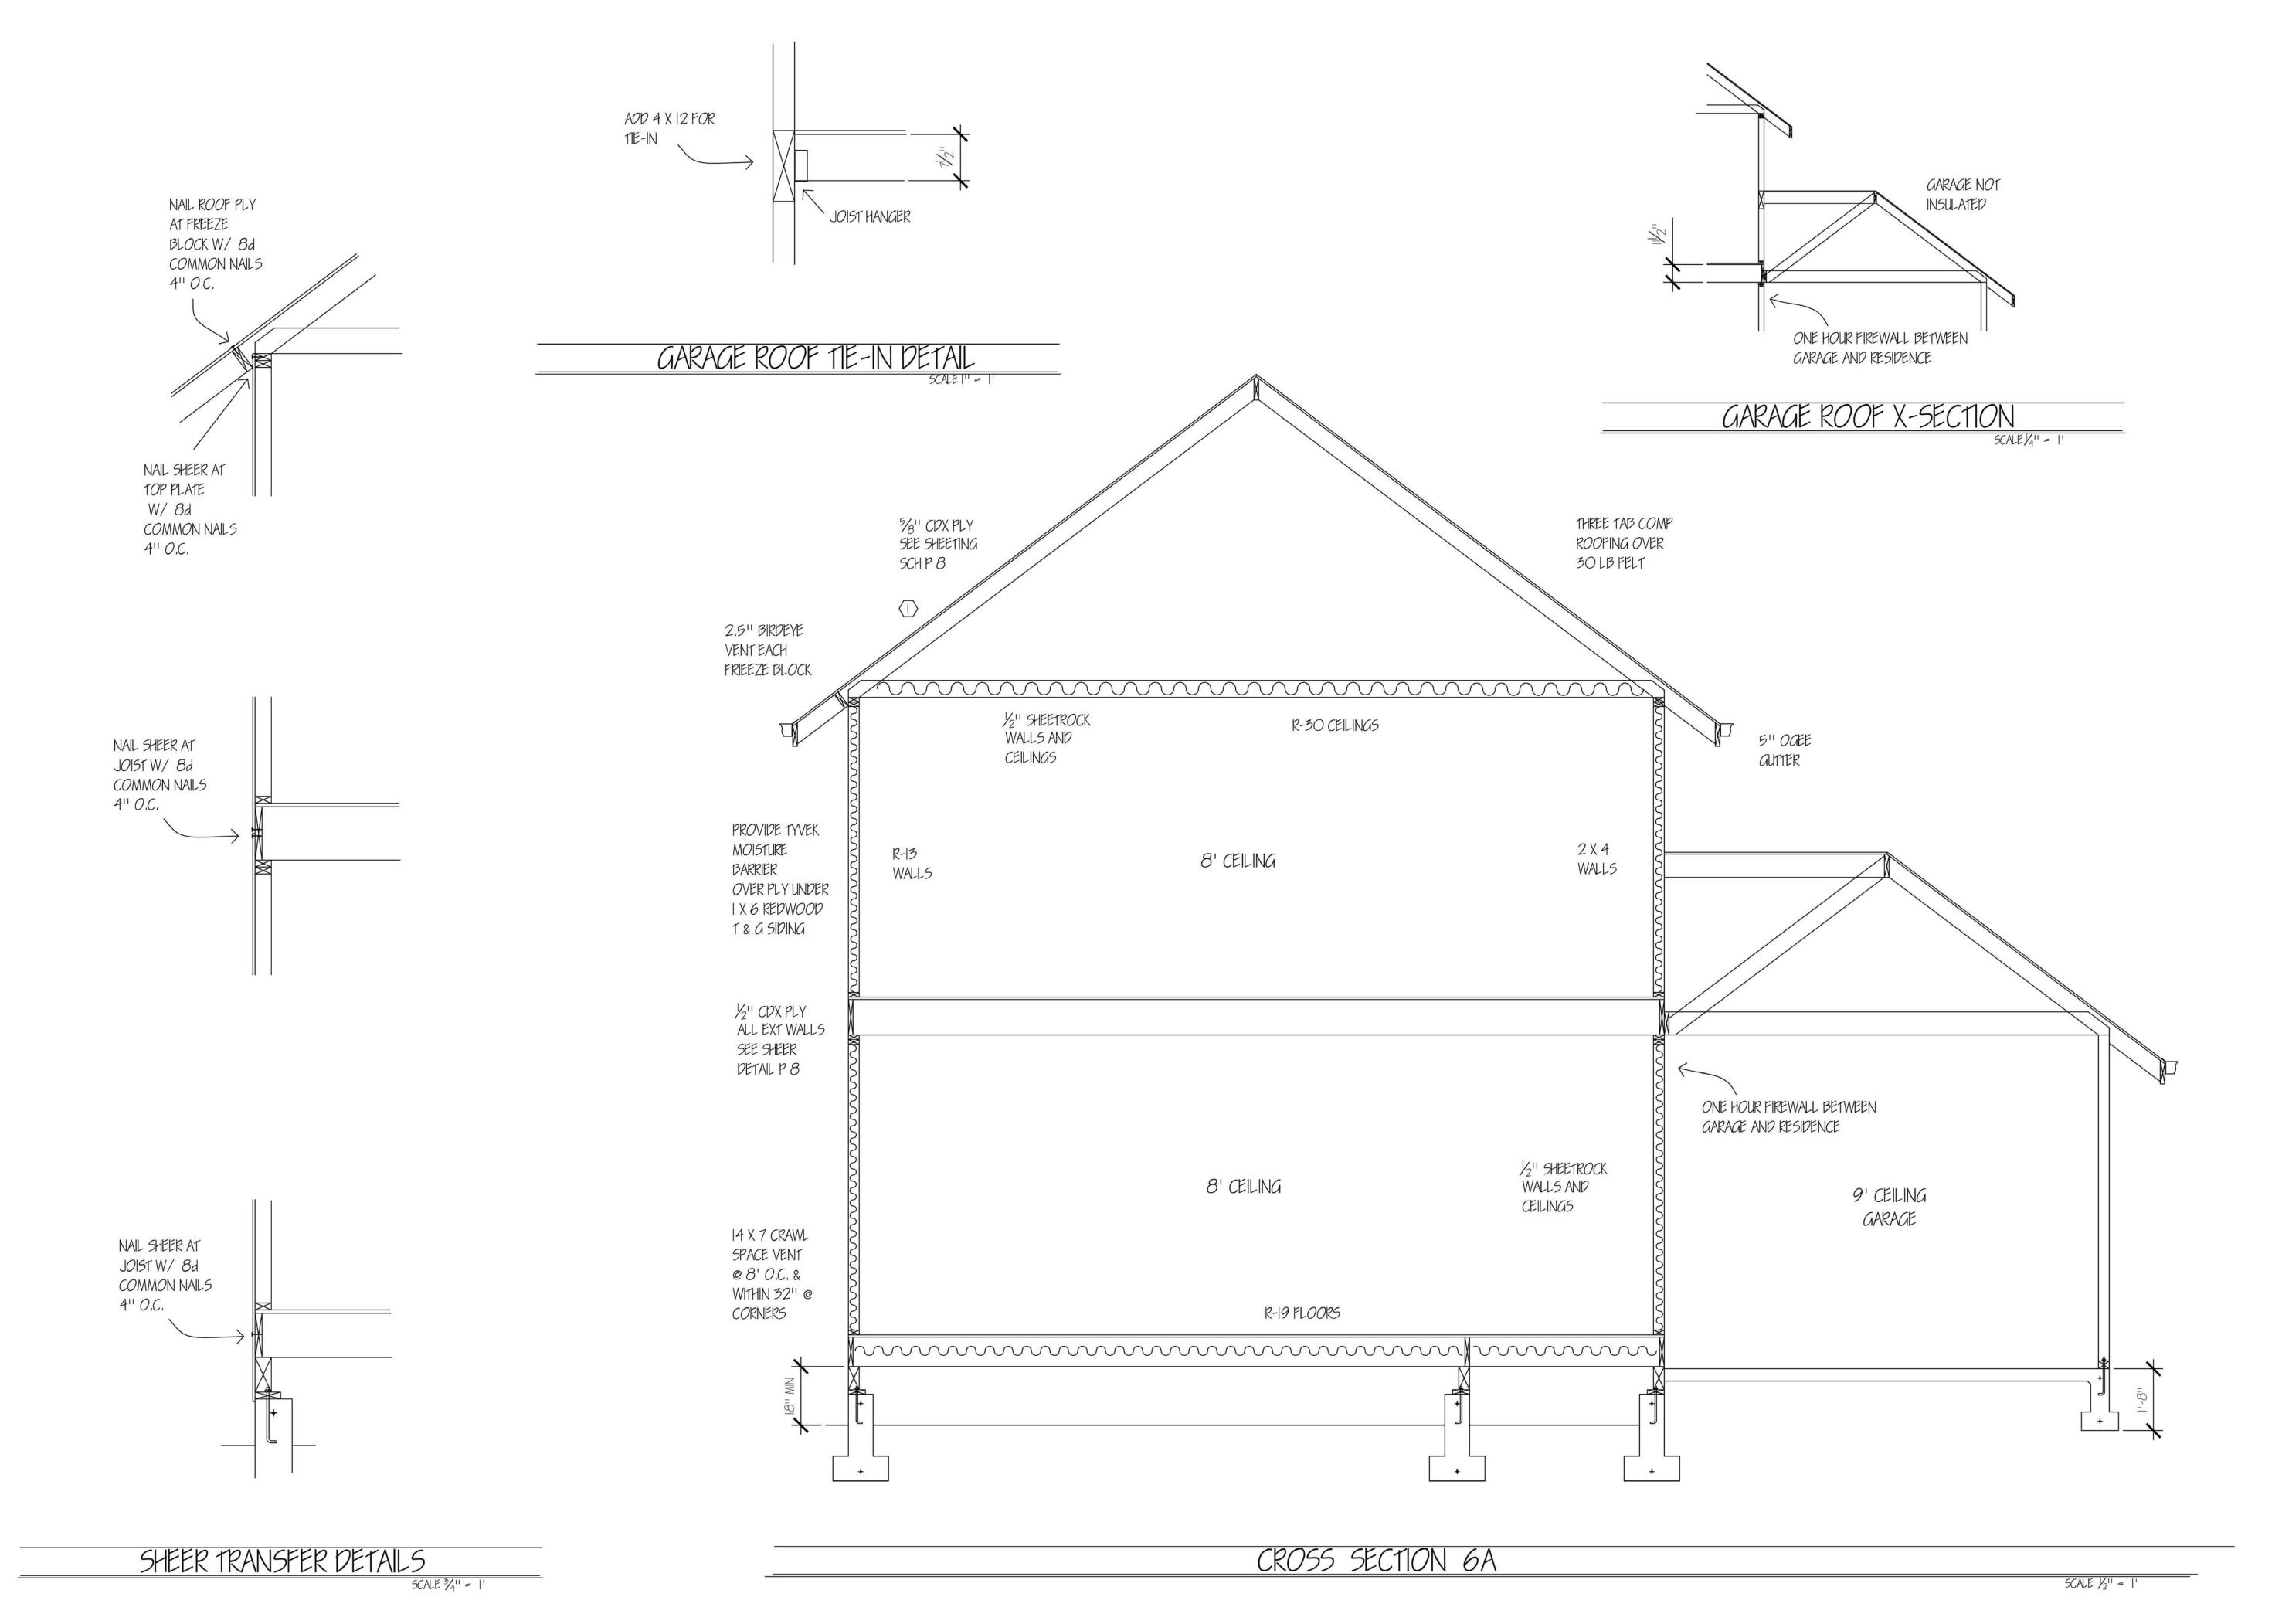

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NO, REVISION DATE


X SECTION
SHEER TRANSFER
ROOF TIE-IN
&
GARAGE ROOF
X-SECTION

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PROJECT 1000001


DATE 20AUG25

SCALE 1/4" = 1'

PAGE NO.

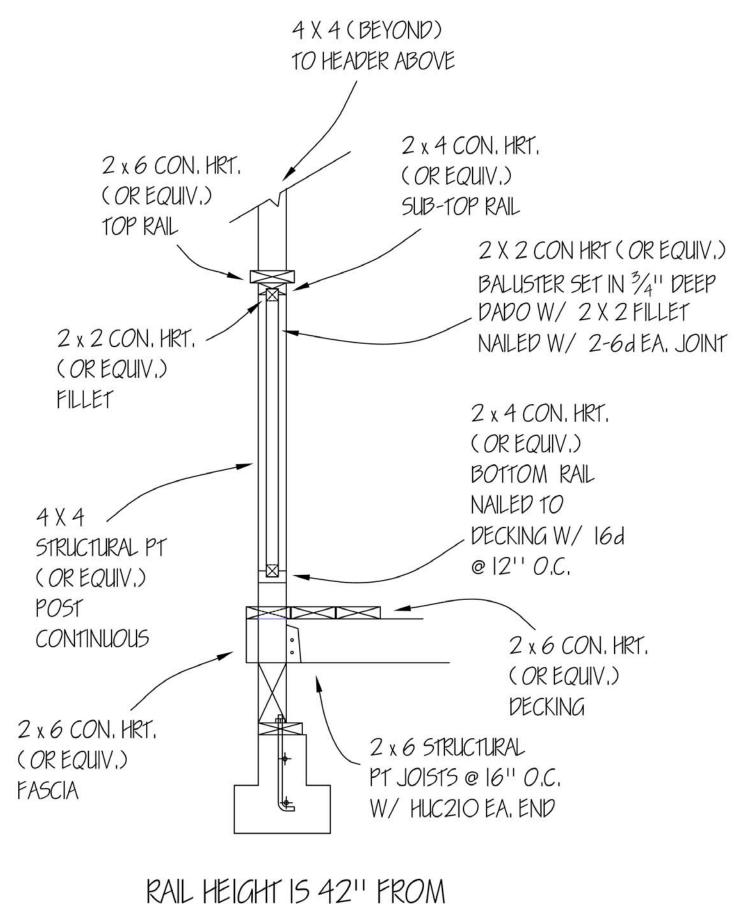

FINISHED DECK SURFACE

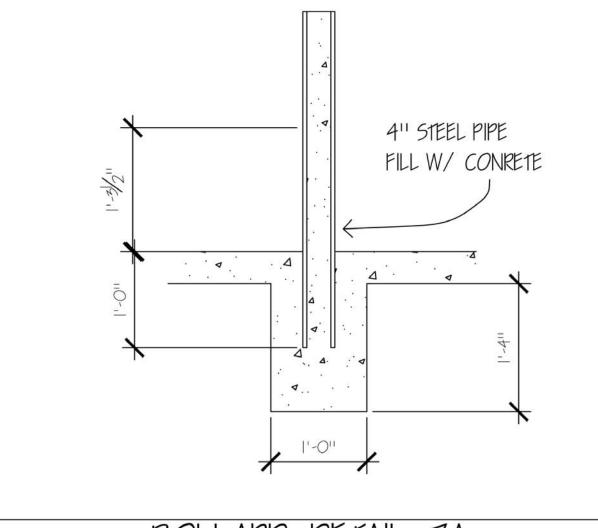


BOLLARD DETAIL 7A


SCALE |" = |'

		VVIINDOVV	SCHEDULE		
ROOM	SIZE	5.F.	TYPE	MATERIAL	GLAZING
LIVINGROOM	2-6 X 4-0	10	SLD	VYNYL	DUAL
	6-0 X 5-0	30	SLD	VYNYL	DUAL
	5-0 X 4-0	20	SLD	VYNYL	DUAL
KITCHEN	4-0 X 3-6	14	SLD	VYNYL	DUAL
IPSTAIRS HALL	6-0 X 3-0	18	SLD	VYNYL	DUAL
BEDROOM I	6-0 X 4-0	24	SLD	VYNYL	DUAL
	5-0 X 4-0	20	SLD	VYNYL	DUAL
BEDROOM 2	5-0 X 4-0	20	SLD	VYNYL	DUAL
	5-0 X 4-0	20	SLD	VYNYL	DUAL
IPSTAIRS BATH	3-0 X 3-0	9	SLD	VYNYL	DUAL
GARAGE	4-0 X 4-0	16	SLP	VYNYL	SINGLE

RAIL DETAIL 7C

SCALE |" = |'

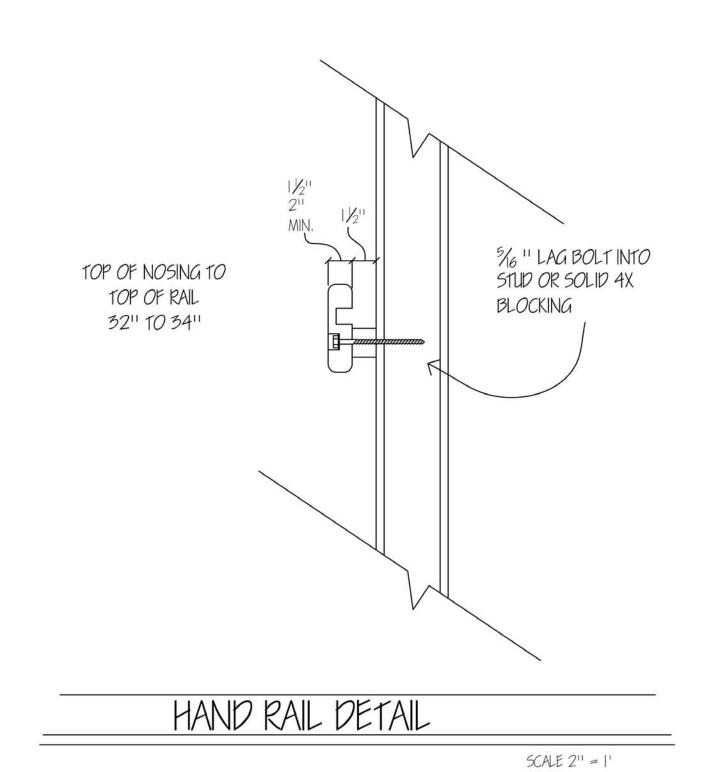

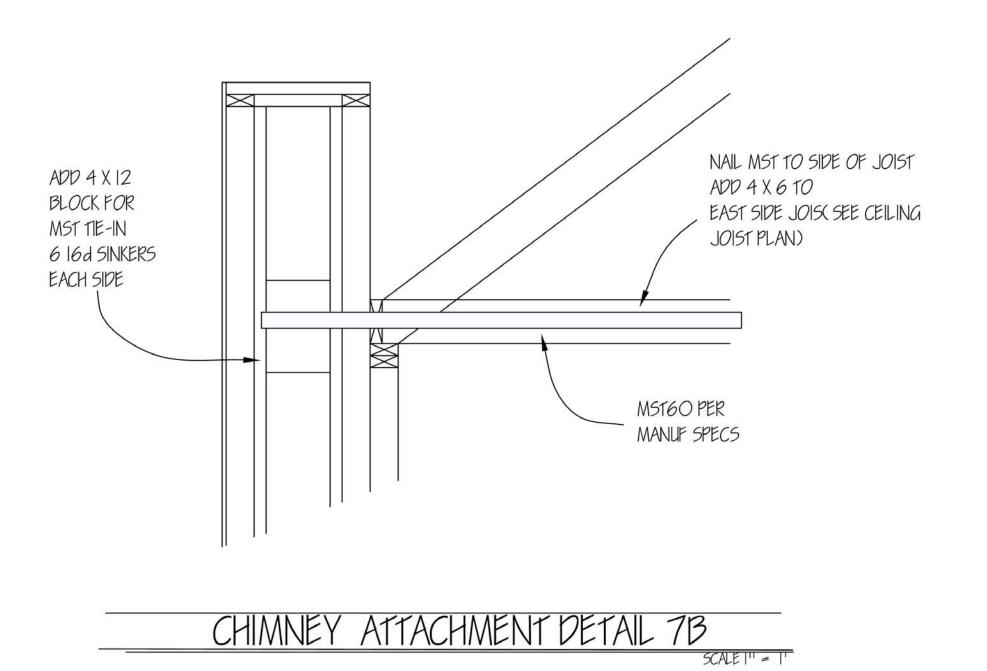


WINDOW
SCHEDULE
&
DETAILS

PROPOSED NEW
WINNIE AND
IOOO PA
ANYTOWN,
PH. N

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DATE 20AUG25SCALE 1/4" = 1'

PAGE NO.

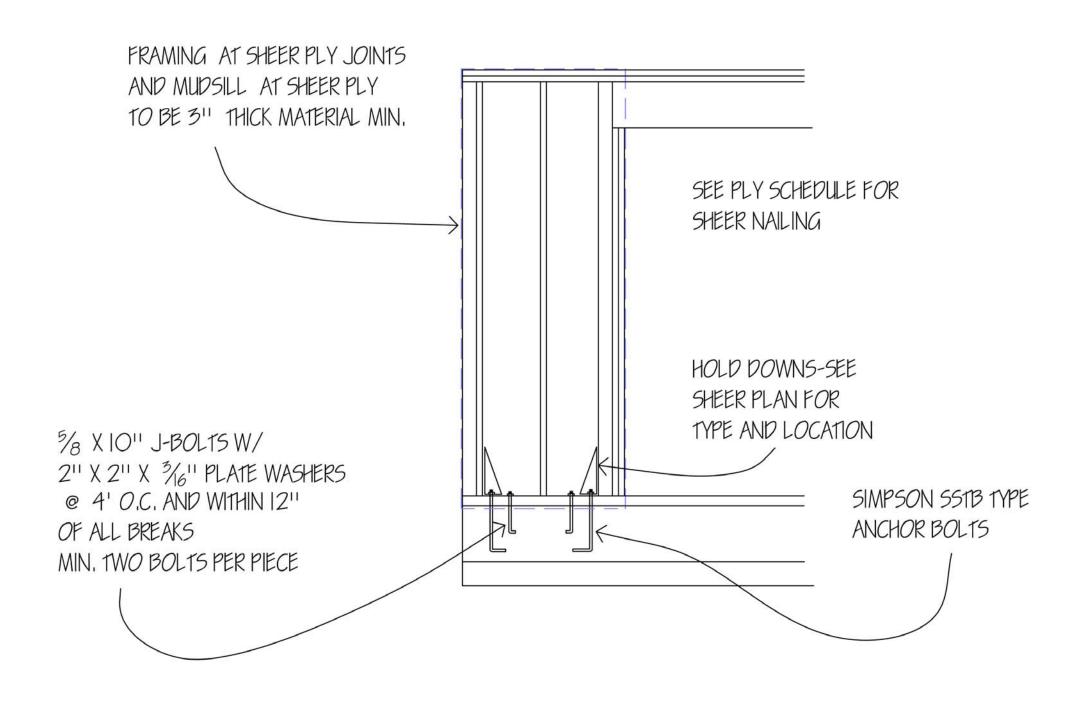

SHEER DETAIL 8A


SHEER PANEL @ GARAGE SLAB

5CALE: 1/2" = 1'

PLY SCHEDULE								
PLYWD KEY	PLY THICHNESS	PLYWOOD RATING	COMMON NAIL SIZE	PANEL EDGE NAIL SPACING	FIELD NAIL SPACING	PENOTED EDGE BLOCKING REQD		
	5/811	APA RATED CDX	8d	6	12			
2	3/411	APA RATED UL	8d	6	10	T & G		
3	1/2"	APA RATED CDX	8d	6*	12	В		
4	1/2"	APA RATED CDX	8d	4*	12	В		
(5)	1/2"	APA RATED CDX	8d	2*	12	В		
6	3/811	APA RATED CDX	8d	2*	12	В		


- EDGE FRAMING AND SILL PLATE AT ADJOINING PANEL EDGES TO BE 3X FRAMING MINIMUM WITH NAILS STAGGERED I'' MINIMUM
- DOUBLE TOP PLATES AT WALLS TO BE LAPPED 4' MIN.

 HOLD DOWNS: USE SSTB16 ANCHORS

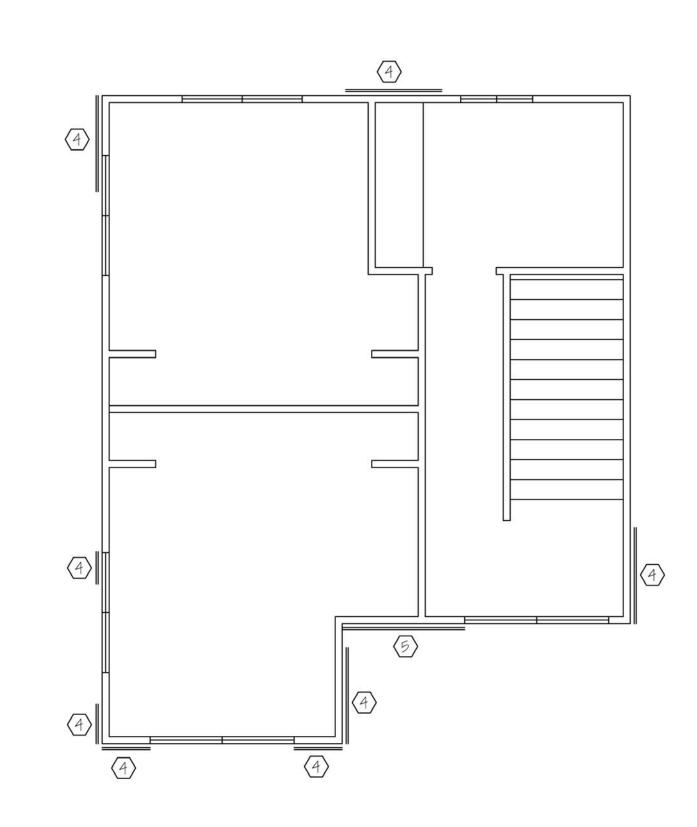

2ND STORY SHEER PLAN


SCALE 1/4" = 1'

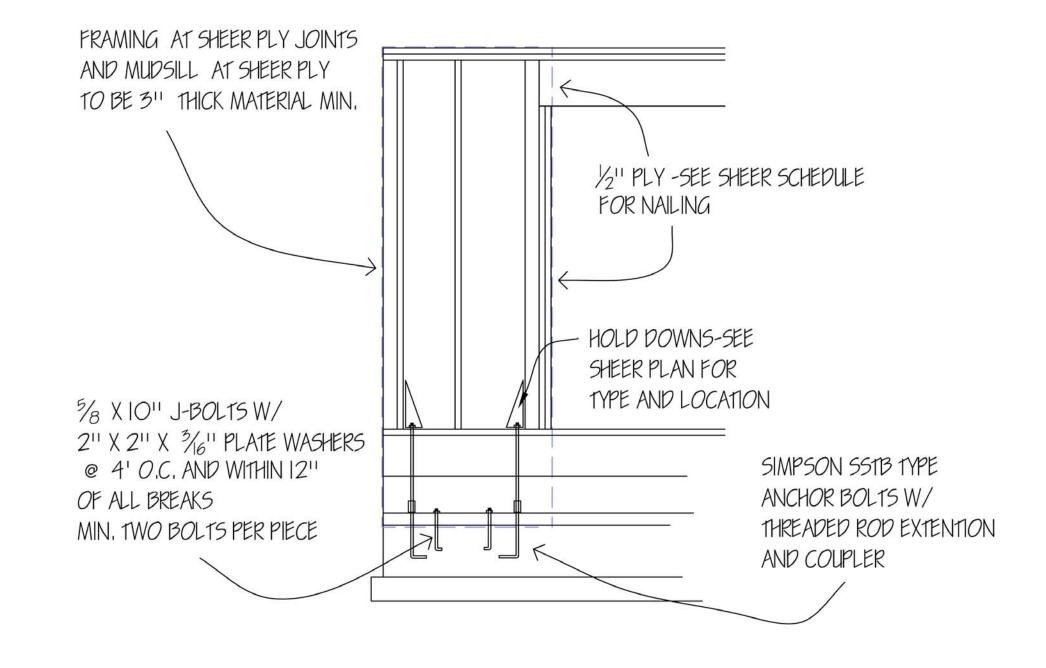

SHEER DETAIL 8B

SHEER PANEL @ FRAMED FLOORS

SCALE: 1/2" = 1'

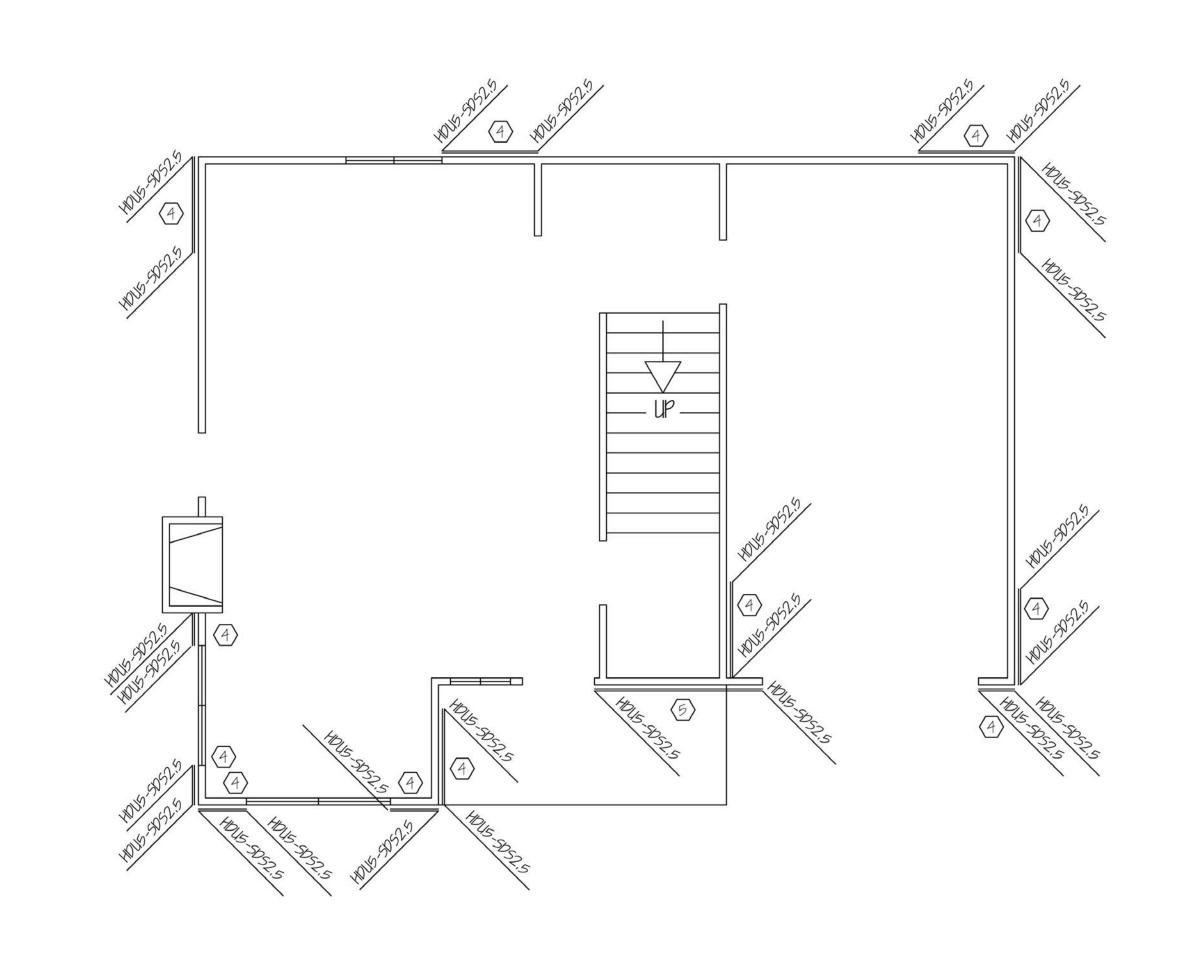

FIRST STORY SHEER PLAN

SCALE 1/4" = 1'

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SHEER
PLAN

&
ENGINEERING

PRAWN BY IAMES BEEBE

PROJECT 1000001

DATE 20AUG25

SCALE 1/4" = 1"
PAGE NO.

GENERAL CONSTRUCTION NOTES

- I-CURRENT APPLICABLE CODES: 2010 CBC, 2010 MECH, PLUMB & ELECT CODES.
- 2-PLUMBING FIXTURES SHALL COMPLY WITH THE FOLLOWING STANDARDS
 - -TOILETS TO BE HIGH EFFICIENCY = 1.6 GALS/FLUSH MAX
 - $-SHOWER\ HEAD = 2.5\ GALS./MIN\ MAX.$
 - -LAVATORY FAUCET = 2,2 GALS,/ MIN. MAX.
- 3-ALL DOORS AND WINDOWS TO BE CAULKED FOR SEAL FOR DRAFT BARRIER,
- 4-ALL EXT DOORS TO BE WEATHER STRIPPED.
- 5-CHAULK ALL VENTS AND PIPES AT PERFORATION OF EXT. MEMBRANE.
- 6-PROVIDE TYVEK TYPE MOISTURE BARRIER AT EXT. WALLS UNDER SIDING.
- 7-ALL EXT FASTENERS TO BE OF CORROSION RESISTANCE EX: GALV, ANODIZED, STAINLESS OR ALUMINUM.
- 8-ALL CONSTRUCTION LUMBER TO BE #2 & BTR DF UNLESS SPECIFIED.
- 9-ALL WOOD EXPOSED TO THE WEATHER TO BE PT OR APPROVED NATURALLY DECAY RESISTANT SPECIES.
- -PROVIDE 7" SEPARATION BETWEEN NON-DECAY RESISTANT WOOD AND EARTH.
- IO-ALL FASTENERS INTO PT LUMBER TO BE HOT DIPPED ZINC COATED GALVANIZED, ANODIZED, OR STAINLESS STEEL.
- II-ALL MEASUREMENTS TO BE FIELD VERIFIED.
- 12-PROVIDE 12" X 12" REMOVABLE ACCESS PANEL FOR ALL PLUMBING FIXTURES W/CONCEALED SLIP JOINT CONNECTORS.
- 13-SHOWER ENCLOSURE TO BE TEMPERED GLASS.
- 14-PROVIDE NON-REMOVABLE BACK FLOW DEVICES AT ALL HOSE BIBS.
- 15-PROVIDE WEEP SCREED AT BOTTOM OF ALL STUCCO SECTIONS.

YOUR NAME IPENTIAL DESIGN

POSED NEW RESIDENCE FOR WINNIE AND BOB ANYONE IOOO PARADISE AVE

NO.	REVISION	DATE

NOTES

PROJECT 1000001

DATE 20AUG25

